CITY OF BUCKEYE **GENERAL PERMITTING NOTES**

- ALL CONSTRUCTION IN THE PUBLIC RIGHTS-OF-WAY OR IN EASEMENTS GRANTED FOR PUBLIC USE MUST CONFORM TO THE LATEST MARICOPA ASSOCIATION OF GOVERNMENTS (MAG) UNIFORM STANDARD SPECIFICATIONS AND UNIFORM STANDARD DETAILS FOR PUBLIC WORKS CONSTRUCTION AS AMENDED BY THE LATEST VERSION OF THE CITY OF BUCKEYE DESIGN STANDARDS. IF THERE IS A CONFLICT, THE CITY OF BUCKEYE STANDARDS WILL GOVERN.
- 2. THE APPROVAL OF THE PLANS IS VALID FOR ONE (1) YEAR FROM THE DATE OF THE CITY ENGINEER'S SIGNATURE. IF AN ENCROACHMENT PERMIT FOR THE CONSTRUCTION HAS NOT BEEN ISSUED WITHIN ONE (1) YEAR, THE PLANS MUST BE RESUBMITTED TO THE CITY FOR REAPPROVAL.
- 3. A CITY OF BUCKEYE INSPECTOR WILL INSPECT ALL WORKS WITHIN THE CITY OF BUCKEYE RIGHTS-OF-WAY AND IN EASEMENTS. NOTIFY THE CITY 24 HOURS PRIOR TO THE INSPECTION BY CALLING (623) 349-6248.
- 4. CITY PERMITS ARE REQUIRED FOR ALL WORK IN PUBLIC RIGHTS-OF-WAY AND EASEMENTS GRANTED FOR PUBLIC PURPOSES. A CITY PERMIT WILL BE ISSUED BY THE CITY ONLY AFTER ALL FEES HAVE BEEN PAID AND THE PERMIT HAS AN APPROVED MARICOPA COUNTY ENVIRONMENTAL SERVICES DUST PERMIT AND AN APPROVED STORM WATER POLLUTION PREVENTION PLAN ATTACHED. THE SWPPP SHALL COMPLY WITH ALL FEDERAL, STATE, AND LOCAL REQUIREMENTS.
- 5. COPIES OF ALL PERMITS AND MOST RECENT APPROVED PLANS MUST BE RETAINED ON-SITE AND BE AVAILABLE FOR INSPECTION AT ALL TIMES. FAILURE TO PRODUCE THE REQUIRED PERMITS AND PLANS WILL RESULT IN IMMEDIATE SUSPENSION OF ALL WORK UNTIL PROPER PERMIT DOCUMENTATION AND/OR PLANS ARE OBTAINED. ALL OF THESE REQUIREMENTS APPLY TO ONSITE GRADING AND IMPROVEMENT PLANS.


UTI	LITY COMPANIES	DATE SUBMITTED
ELECTRIC	ARIZONA PUBLIC SERVICE	8/26/21
TELEPHONE	CENTURY LINK	8/26/21
CATV	COX COMMUNICATIONS	8/26/21
WATER	CITY OF BUCKEYE	8/26/21
SEWER	CITY OF BUCKEYE	8/26/21
GAS	SOUTHWEST GAS	8/26/21

FLOREO AT TERAVALIS

COLLECTORS - PHASE 1 PAVING PLAN

BUCKEYE, ARIZONA

A PORTION OF SECTION 18, TOWNSHIP 3 NORTH, RANGE 4 WEST OF THE GILA AND SALT RIVER BASE AND MERIDIAN, MARICOPA COUNTY, ARIZONA

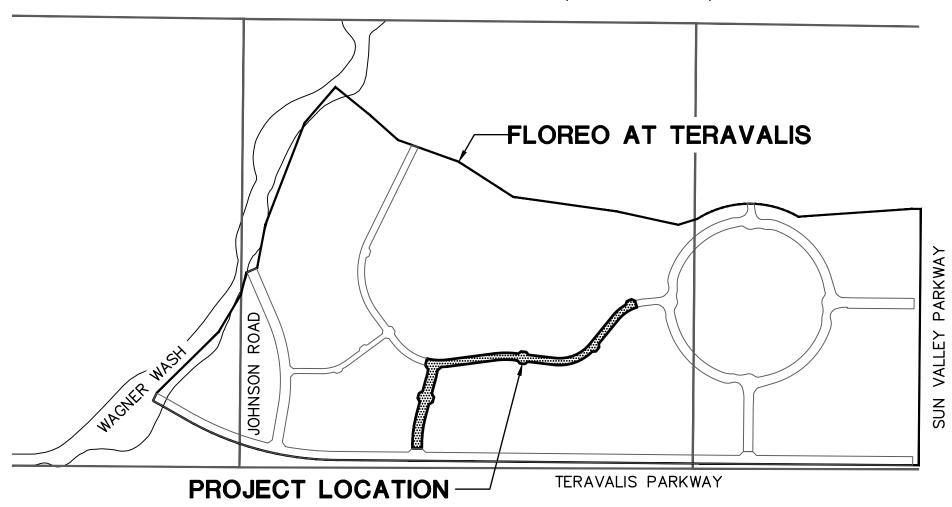

OVERALL DEVELOPMENT

ENGINEERS ESTIMATED PUBLIC QUANTITIES

NOTE: ENGINEERS ESTIMATED QUANTITIES ARE NOT FOR BIDDING PROPOSES. CONTRACTOR SHALL BASE THEIR BID ON THEIR OWN QUANTITY TAKEOFFS.

PAVING CONSTR	RUCTION	
2) INSTALL SU TYPE 'B'.	RVEY MONUMENT; MAG STD DTL 120 27	EA
5 INSTALL PA SEE TYPICA	VEMENT 3" AC OVER 8" ABC; 5293 L STREET SECTION ON DT03.	SY
6 INSTALL PA RESIDENTIAL SUPERPAVE SECTION ON	VEMENT 6" AC (2" OF A 12.5MM 11980 OVER 4" OF A 19.0MM ARTERIAL OVER 10" ABC; SEE TYPICAL SHEET DT03	SY
7 INSTALL PA ARTERIAL S ARTERIAL S SEE TYP. S	VEMENT 6" AC (2" OF A 12.5MM 14243 SUPERPAVE OVER 4" OF A 19.0MM SUPERPAVE) OVER 12" ABC; ECTION ON SHEET DT03.	SY
9 CONSTRUCT MAG STD D	6" VERTICAL CURB & GUTTER, PER 10581 TL 220-1, TYPE A.	LF
(12) CONSTRUCT	5' SIDEWALK; MAG STD DTL 230. 60863	SF
CONSTRUCT DTL 235-2	SIDEWALK CURB RAMP; MAG STD 4, TYPE 'B', SEE DT01 FOR DETAIL.	ΕA
(16) CONSTRUCT MAG STD D		EA
	6' CONCRETE VALLEY GUTTER & 6191 G STD DTL 240 WITH FIBER MESH.	SF
19 ADJUST WA DTL 391-2.	TER VALVE BOX & COVER PER MAG 54	ΕA
	NHOLE FRAME & COVER PER MAG STD 19 ND COB DTL 41260.	ΕA
21) INSTALL FIR COB DTL 3		ΕA

	COB DIL 31440.	
2 5	INSTALL BARRICADE; MAG STD DTL 130 TYPE "A".	35 LF
27	CONSTRUCT 6" VERTICAL CURB & GUTTER, PER MAG STD DTL 220-1, TYPE A, WITH DEPRESSED LIP.	7465 LF
3 7	CONSTRUCT 80 MM INTERLOCKING CONCRETE PAVERS PER COB DTL 632206; 10' MIN. LENGTH PER COB STD. DTL. 63220.	14 EA
38	INSTALL STREET SIGN POST; PER COB DTL 65120.	35 EA
41)	INSTALL 6" DIP SLEEVE NOT WITHIN THE STRUCTURAL SECTION OF THE STREET. SEE LANDSCAPE PLANS FOR DETAILS & PLAN VIEW FOR INVERTS.	499 LF
6 2	CONSTRUCT 6" MOUNTABLE CURB & GUTTER, PER MAG STD DTL 220-2, TYPE E.	35 LF
63	CONSTRUCT 2' CURB TRANSITION TYPE "E" TO TYPE "A" PER MAG STD DTL 220-2.	2 EA
64	INSTALL CONCRETE PAVEMENT, CLASS A, 9" THICK FOR ACCESS RAMP LANDING.	210 SF

65 CONSTRUCT DIRECTIONAL SIDEWALK RAMPS PER COB STD DTL 63240.	12 EA
66 CONSTRUCT DIRECTIONAL SIDEWALK RAMPS PER COB STD DTL 63240, MODIFIED FOR A SINGLE RAMP.	6 EA
67 INSTALL 8" DIP SLEEVE NOT WITHIN THE STRUCTURAL SECTION OF THE STREET. SEE LANDSCAPE PLANS FOR DETAILS & PLAN VIEW FOR INVERTS.	254 LF
STORM DRAIN CONSTRUCTION	
PLACE LOOSE RIP-RAP D50=3", THICKNESS 8" ON FILTER FABRIC, MIRAFI EROSION PROTECTION GEO-TEXTILE OR APPROVED EQUIVALENT. COLOR PER DEVELOPER'S REPRESENTATIVE. SEE RIP RAP DETAIL ON DT03	16 SY
CONSTRUCT STORM DRAIN MANHOLE; MAG STD DTLS 424-2, 520 & 522. ADJUST RIM TO GRADE PER MAG DTL 422, COB DTL 41260.	2 EA
(13) INSTALL 18" RGRCP STORM DRAIN, CLASS IV	280 LF
15 INSTALL 24" RGRCP STORM DRAIN, CLASS IV	279 LF
$\overline{21}$ INSTALL 36" RGRCP STORM DRAIN, CLASS IV	141 LF
22 INSTALL 36" RGRCP STORM DRAIN, CLASS V	336 LF
CONSTRUCT CATCH BASIN; PER COB DTL B-510A & B-510B; SIZE PER PLAN	7 EA
PLACE LOOSE RIP-RAP D50=6", THICKNESS 15" ON FILTER FABRIC, MIRAFI EROSION PROTECTION GEO-TEXTILE OR APPROVED EQUIVALENT. COLOR PER DEVELOPER'S REPRESENTATIVE. SEE RIP RAP DETAIL ON DT03	13 SY
CONSTRUCT CONCRETE OUTLET HEADWALL PER COB STD DTLS 51200 WITH TRASH RACK PER COB STD DTL B-508 AND HANDRAIL PER COB STD B-110	3 EA
PLACE LOOSE RIP-RAP D50=6", THICKNESS 24" ON FILTER FABRIC, MIRAFI EROSION PROTECTION GEO-TEXTILE OR APPROVED EQUIVALENT. COLOR PER DEVELOPER'S REPRESENTATIVE. SEE PV04 FOR HEADWALL RIP-RAP DETAIL.	52 SY

(83) INSTALL ANGULAR LOOSE RIP-RAP PER MAG

ARIZONA (HYDRAULICS).

OF 0.425MM, PERMITTIVITY OF 50 gal/min/ft AND WOVEN. GRADATION PER TABLE 6.4 OF 2013

SPEC SECTION 220 D50=6" 15" THICK ON MIRAFI EROSION PROTECTION GEO-TEXTILE OR APPROVED EQUAL. FABRIC TO HAVE APPARENT OPENING SIZE

DRAINAGE DESIGN MANUAL FOR MARICOPA COUNTY,

6.08 (6:1 SLOPE ON WING WALLS). SEE DETAIL ON SHEET SD03 AND SD04, SAFETY RAIL PER

HILGARTWILSON, LLC 2141 E. HIGHLAND AVENUE SUITE 250 PHOENIX, AZ 85016 PHONE: (602) 490-0535 FAX: (602) 368-2436 CONTACT: JOSHUA ROBINSON EMAIL: JROBINSON@HILGARTWILSON.COM

LANDSCAPE ARCH.

ENGINEER

310 EAST RIO SALADO PARKWAY TEMPE, ARIZONA 85281 CONTACT: BRIAN ROGERS PHONE: (480)-530-0387 EMAIL: BRIAN.ROGERS@ABLASTUDIO.COM

BASIS OF BEARING

THE NORTH LINE OF NORTHEAST QUARTER OF SECTION SD01-02 17, TOWNSHIP 1 SOUTH, RANGE 2 WEST OF THE GILA SD03 AND SALT RIVER BASE AND MERIDIAN, MARICOPA COUNTY, ARIZONA, BEARING SOUTH 89°55'49" EAST

APPROVALS

DISCLAIMER:

THE CITY APPROVES THESE PLANS FOR CONCEPT ONLY AND ACCEPTS NO LIABILITY FOR ERRORS & OMISSIONS.

CITY OF BUCKEYE ENGINEER

AS-BUILT CERTIFICATION

I HEREBY CERTIFY THAT THE "AS - BUILT" INFORMATION SHOWN HEREON WAS OBTAINED UNDER MY DIRECT SUPERVISION AND IS CORRECT AND COMPLETE TO THE BEST OF MY KNOWLEDGE AND BELIEF.

ARIZONA REGISTERED LAND SURVEYOR / P.E.

ARIZONA REGISTRATION NUMBER

TELEPHONE NUMBER

(84) CONSTRUCT FIVE BARREL 10'X 4' BOX CULVERT SEE DETAIL ON SHEET SD03 AND SD04, SPECS AND ADOT STD DTL SD 6.05. 85 CONSTRUCT INLET WING PER ADOT STD DTL SD 2 EA

MAG STD DTL 145. (86) CONSTRUCT OUTLET WING PER ADOT STD DTL SD 2 EA 6.08 (6:1 SLOPE ON WING WALLS). SEE DETAIL ON SHEET SD03 AND SD04, SAFETY RAIL PER

MAG STD DTL 145. (87) CONSTRUCT CONCRETE HEADWALL MODIFIED FOR 3 EA PIPES PER COB STD DTL 51200 TYPE AS NOTED WITH TRASH RACK PER COB DTL B-508

AND HAND RAIL PER COB STD DTL B-110. (92) CONSTRUCT DROP INLET PER MAG STD DTL 1 EA 501-5. WITH TRASH RACK PER MAG STD DTL

502-2, SAFETY RAIL PER MAG STD DTL 145. (93) CONSTRUCT THREE BARREL 10'X 4' BOX CULVERT 136 LF SEE DETAIL ON SHEET SD07, SPECS AND ADOT STD DTL SD 6.03.

OWNER/DEVELOPER

TRILLIUM LAND COMPANY, LLC 4150 N. DRINKWATER BLVD, SUITE 100 SCOTTSDALE, AZ 85251 CONTACT: HEATH MELTON PHONE: (602) 834-9115 EMAIL: HEATH.MELTON@HOWARDHUGHES.COM CONTACT: BRAD HINTON PHONE: (602) 955-2424

EMAIL: BHINTON@ELDORADOHOLDINGS.NET SHEET INDEX

COVER SHEET KEY MAP & LEGEND NOTES NOTES & DETAILS

PV01-06 PAVING PLAN & PROFILE SHEETS PV07-10 PAVING PLAN MEDIAN DETAILS STORM DRAIN PROFILES BOX CULVET PLAN & PROFILE SD04-06 BOX CULVET NOTES & DETAILS

BENCHMARK

MDOT POINT NO. 30527-1, BEING A 3" BRASS CAI IN HANDHOLE, LOCATED AT THE INTERSECTION OF ELLIOT ROAD & RAINBOW VALLEY ROAD HAVING AN ELEVATION OF 919.785" (NAVD88)


⊢ o REVISIONS: COB PERMITTING COB ENGINEERING APPROVED SEAL APPROVED SEAL

FEMA FLOOD ZONE DESIGNATION

COMMUNITY NUMBER	PANEL # PANEL DATE	SUFFIX	DATE OF FIRM (INDEX DATE)	FIRM ZONE
040070	1605	_	10/16/2013	AE, A,
040039	10/16/2013	L	10/16/2013	X



	AS-BUILT SEAL	DESIGN SEAL 10	SUBMITTAL:	3RD SUBMITTA
ng days ation.		69427 JOSHUA ROBINSON ARIZONA U.S.A.	COB PLAN TRACKING # S ENG-21-0288	r# ENG-21-0288
n	ORIGINAL PLAN DATE Aug-21	LATEST REVISION DATE Feb-23	AN TR	PERMIT #
(782-5348) 263-1100	PROJECT NUMBER 1175	SHEET NUMBER SHT. CVO1 1 OF 20	COB PL	COB PE
75\ENGR\^0	Collectors\PLANS\PAVING\PHASE	1\1175-COL-CV01.dwg 2/28,	/2023 .	3: 45 PM

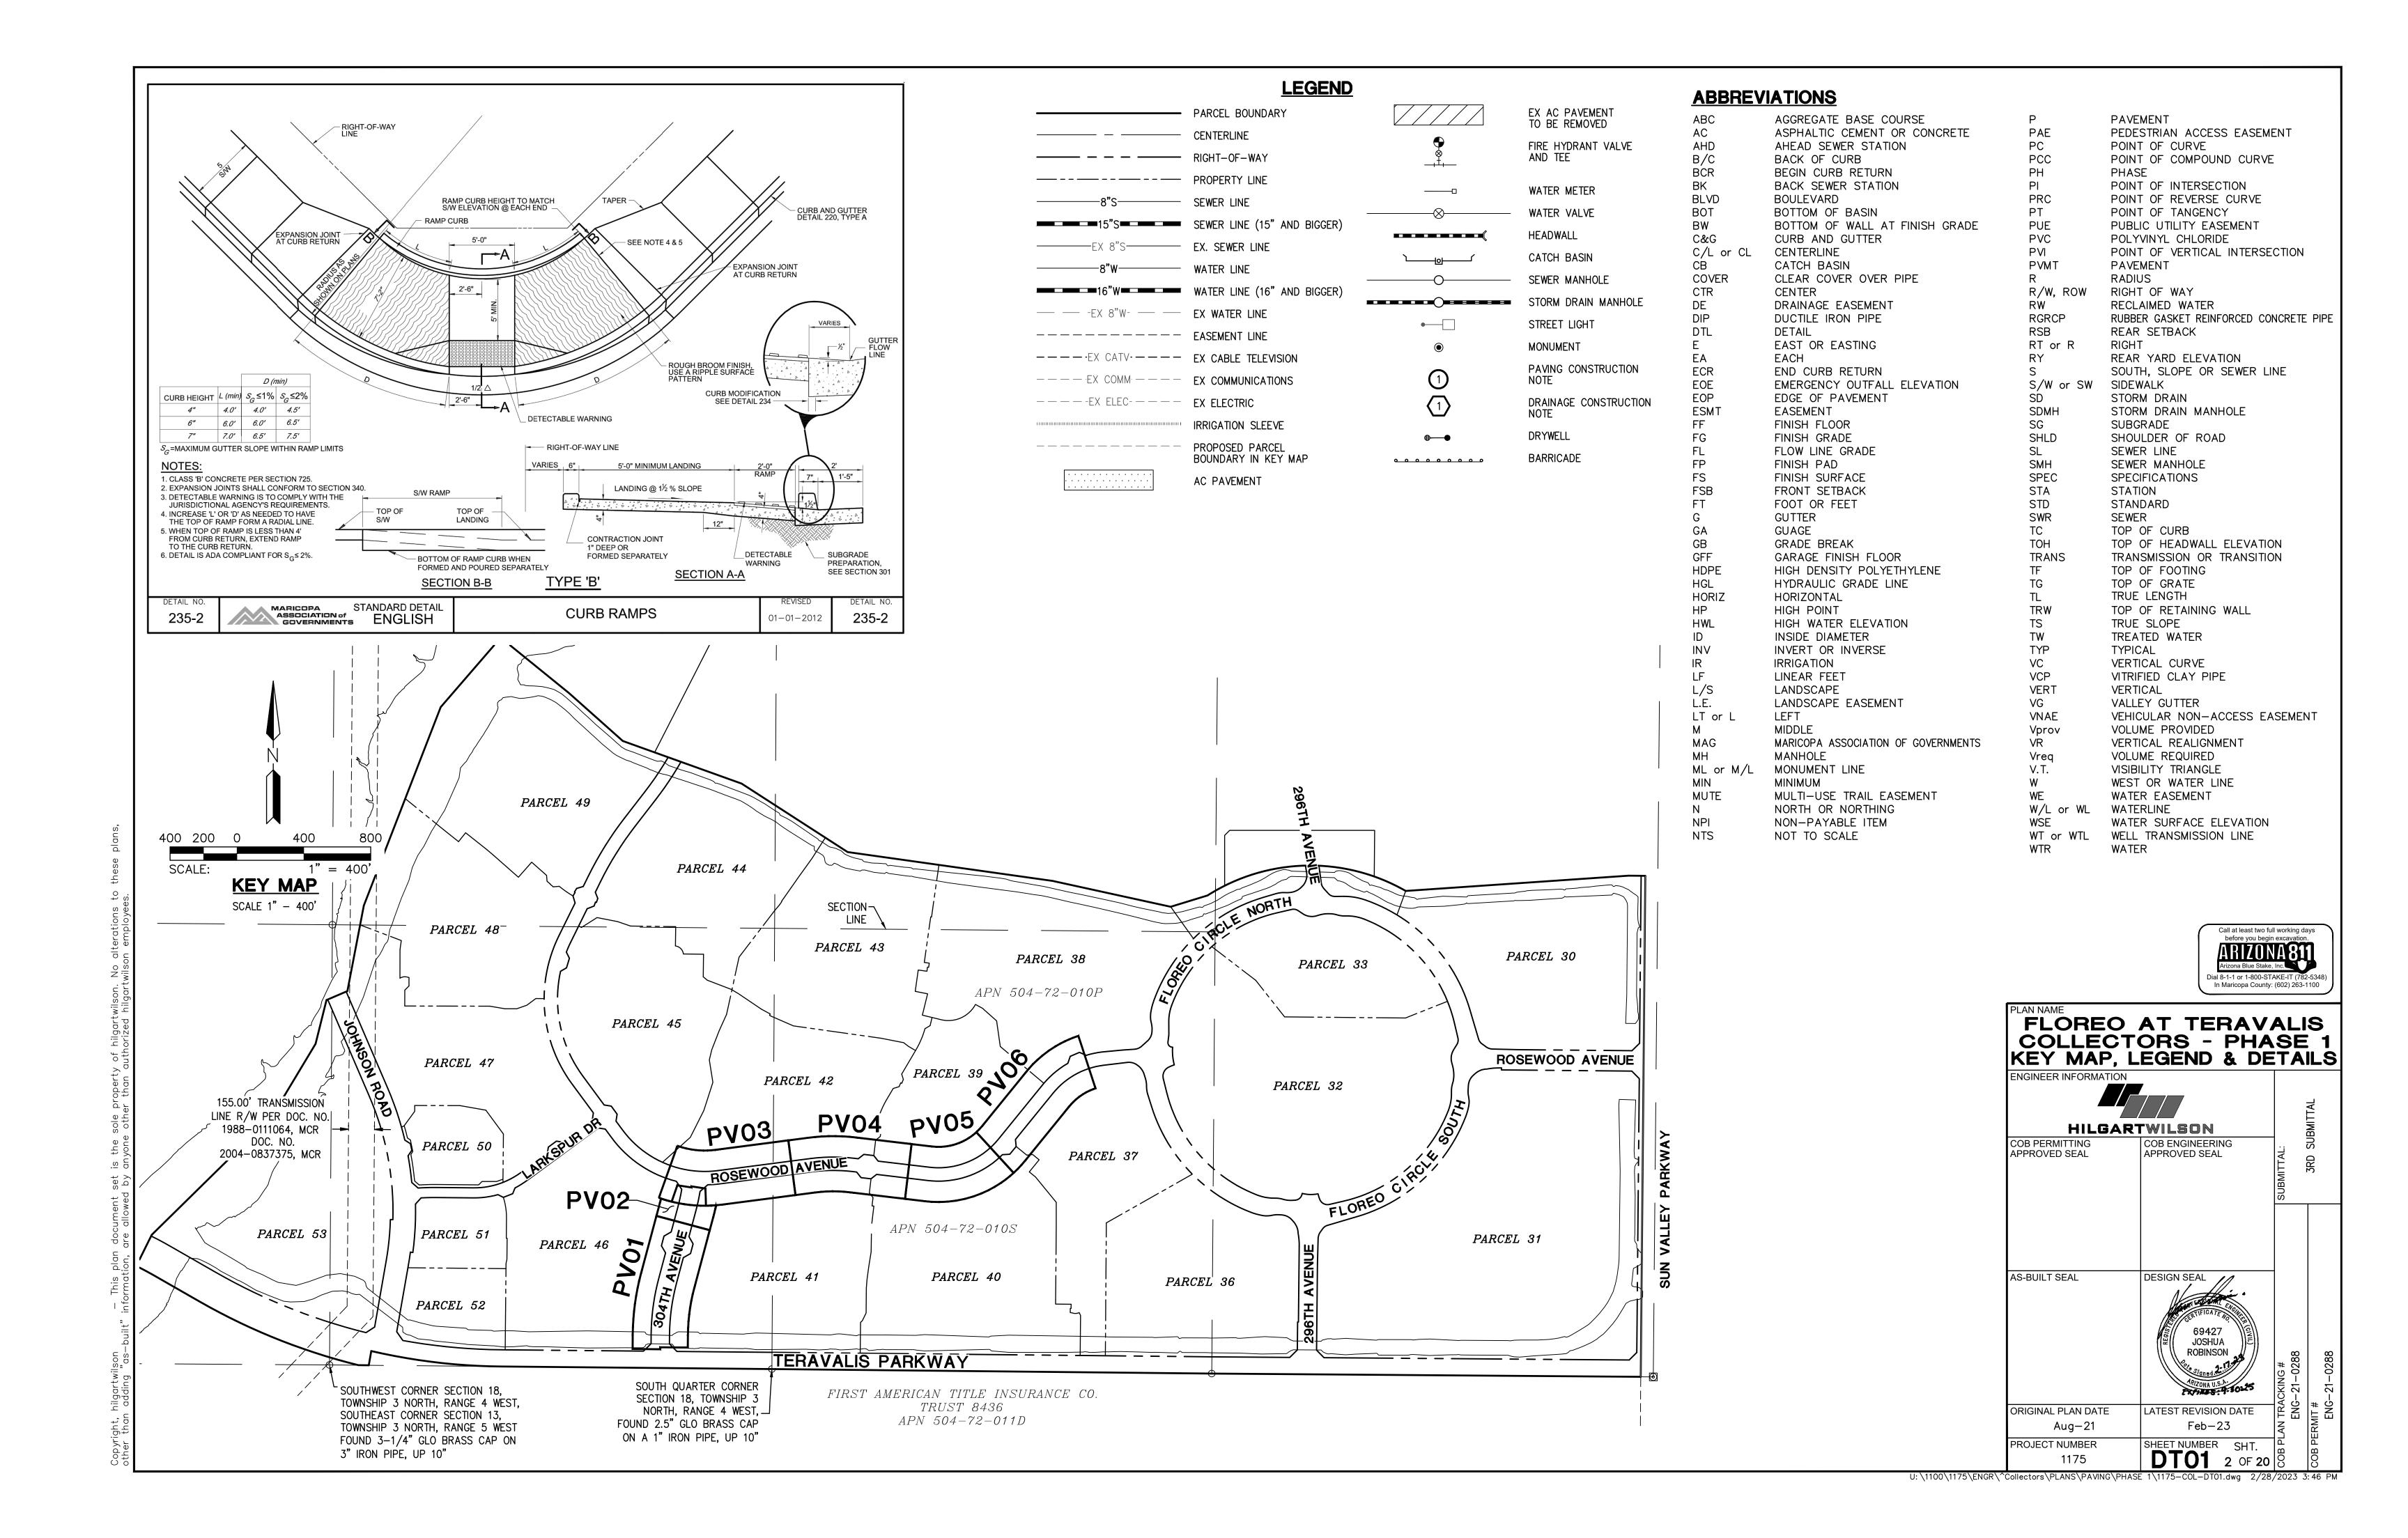

CITY OF BUCKEYE GENERAL CONSTRUCTION NOTES:

- CITY OF BUCKEYE BUILDING DEPARTMENT SHALL BE NOTIFIED 24 HOURS IN ADVANCE OF ANY ON-SITE OR OFF-SITE CONSTRUCTION. PHONE 623-349-6248 FOR THE HOTLINE. ALL OTHERS FAX THE INSPECTION REQUEST FORM TO 623-349-6221, OR USE THE WEB BASED PERMIT PORTHOLE ACCESS TO SCHEDULE AN INSPECTION (WWW.BUCKEYEAZ.GOV).
- ALL WORK AND MATERIALS MUST CONFORM WITH THESE SPECIFICATIONS, THE CURRENT UNIFORM STANDARD SPECIFICATIONS AND DETAILS FOR PUBLIC WORKS CONSTRUCTION AS SPONSORED AND DISTRIBUTED BY THE MARICOPA ASSOCIATION OF GOVERNMENTS (M.A.G.) AND AS AMENDED BY THE CITY OF BUCKEYE (COB).
- 3. A PERMIT IS REQUIRED FROM THE COB FOR ALL CONSTRUCTION WITHIN THE RIGHTS-OF-WAY (ROW).
- 4. THE CONTRACTOR WILL EXPOSE ALL EXISTING UTILITY LINES BEING TIED IN TO VERIFY THEIR LOCATION.
- THE CONTRACTOR WILL LOCATE, OR HAVE LOCATED, ALL EXISTING UNDERGROUND UTILITIES (ELECTRIC TELEPHONE, PIPELINE, ETC.) AND STRUCTURES IN ADVANCE OF CONSTRUCTION AND WILL ELIMINATE ALL CONFLICTS PRIOR TO START OF CONSTRUCTION.
- THE CONTRACTOR IS RESPONSIBLE TO CALL BLUE STAKE PRIOR TO STARTING ANY CONSTRUCTION. NO WORK SHALL BEGIN UNTIL BLUE STAKE IS COMPLETED. BLUE STAKE TELEPHONE NUMBER 602-263-1100
- A PRE-CONSTRUCTION MEETING IS REQUIRED PRIOR TO STARTING ANY WORK OR NEW PHASE OF WORK. THE CONTRACTOR, KEY SUB-CONTRACTORS. COB INSPECTOR AND REPRESENTATIVE OF THE CITY ENGINEER SHALL ATTEND THIS MEETING.
- ANY WORK PERFORMED WITHOUT THE APPROVAL OF THE COB AND/OR ALL WORK AND MATERIAL NOT IN CONFORMANCE WITH THE SPECIFICATIONS IS SUBJECT TO REMOVAL AND REPLACEMENT AT THE CONTRACTOR'S EXPENSE.
- DISPOSAL OF EXCESS MATERIAL WITHOUT A PERMIT WITHIN THE COB LIMITS IS PROHIBITED. A USE PERMIT IS REQUIRED FOR DISPOSAL OR STOCKPILING OF MATERIALS WITHIN A RESIDENTIAL AREA. STOCKPILING OF EXCAVATED MATERIAL SHALL NOT EXCEED A HEIGHT OF 6 FEET ABOVE THE NATURAL GROUND ELEVATION. THE SLOPES ON ALL SIDES OF THE STOCKPILED EXCAVATED MATERIAL SHALL NOT EXCEED A 4:1 RATIO OF LENGTH TO HEIGHT.
- 10. EXCAVATION CONTRACTORS MUST IDENTIFY LOCATION FOR DISPOSING OF EXCESS EXCAVATION MATERIAL ALONG WITH A LETTER FROM THE LAND OWNER, GIVING PERMISSION FOR DUMPING PRIOR TO STARTING
- TRAFFIC CONTROL SHALL BE PROVIDED AND MAINTAINED IN ACCORDANCE WITH THE LATEST EDITION OF THE MANUAL OF UNIFORM TRAFFIC CONTROL DEVICES AND THE CITY OF PHOENIX BARRICADING MANUAL, MARICOPA COUNTY DEPARTMENT OF TRANSPORTATION, M.AG.UNIFORM STANDARD DETAIL401, AND COB REQUIREMENTS. THE CONTRACTOR IS REQUIRED TO SUBMIT A TRAFFIC CONTROL PLAN AND BARRICADE PLAN TO THE COB FOR APPROVAL WHERE THE CONSTRUCTION OF THE NEW IMPROVEMENTS ARE ADJACENT TO OR CONNECTING TO ANY EXISTING ROADWAY OR PEDESTRIAN FACILITIES. THE TRAFFIC CONTROL PLAN AND BARRICADE PLAN SHALL BE APPROVED BEFORE A PERMIT FOR THE WORK WILL BE ISSUED THE CONTRACTOR SHALL INSTALL APPROVED BARRICADING AND TRAFFIC CONTROL, AS APPROVED BY THE COB, BEFORE WORK CAN TAKE PLACE. ALL OVERNIGHT BARRICADES SHALL BE LIT AND FUNCTIONING.
- A HAUL PLAN FOR MATERIAL IMPORT OR EXPORT SHALL BE REQUIRED FOR COB REVIEW AND APPROVAL PRIOR TO THE START OF HAULING. THE CONTRACTOR SHALL BE RESPONSIBLE FOR DAILY AND FINAL CLEAN—UP OPERATION OF ADJACENT, EXISTING PAVED STREETS USED BY CONSTRUCTION TRAFFIC. THIS WORK INCLUDES STREET SWEEPING, POWER BROOM AND WATER AS NEEDED OR DIRECTED BY THE COB.
- 13. ENVIRONMENTAL REQUIREMENTS
- THE CONTRACTOR SHALL BE RESPONSIBLE FOR DUST CONTROL RELATED TO THE PROJECT CONSTRUCTION AND SHALL TAKE WHATEVER MEANS NECESSARY TO CONTROL ANY ABNORMAL CONDITIONS.
- THE CONTRACTOR SHALL PROVIDE ADEQUATE MEANS FOR CLEANING TRUCKS AND/OR OTHER EQUIPMENT OF MUD PRIOR TO ENTERING PUBLIC STREETS. AND TAKE WHATEVER MEASURES ARE NECESSARY TO INSURE THAT ALL ROADS ARE MAINTAINED IN A CLEAN, MUD AND DUST FREE CONDITION AT ALL TIMES.
- THE CONTRACTOR SHALL BE RESPONSIBLE FOR DAILY AND FINAL CLEAN—UP OPERATIONS OF ADJACENT, EXISTING PAVED STREETS USED BY CONSTRUCTION TRAFFIC.
- TEMPORARY DRAINAGE CONTROL MEASURES MAY BE REQUIRED DURING AND AFTER CONSTRUCTION UNTIL FINAL PROJECT BUILD—OUT IN ACCORDANCE WITH THE APPROVED PLANS AND IN ACCORDANCE WITH ANY ESTABLISHED OR REQUIRED BEST MANAGEMENT PRACTICES (BMP) AS PART OF THE NATIONAL POLLUTION DISCHARGE ELIMINATION SYSTEM (NPDES) PERMIT REQUIREMENTS. IT IS THE CONTRACTOR'S RESPONSIBILITY TO MEET ALL REQUIREMENTS. THE CONTRACTOR IS RESPONSIBLE TO OBTAIN ALL AIR QUALITY PERMITS.
- THE CONTRACTOR SHALL SUBMIT TO THE COB A COPY OF THEIR APPROVED COUNTY (AIR QUALITY) DUST CONTROL PLAN, EROSION CONTROL PLAN (SWPPP), AND PERMIT PRIOR TO THE START OF WORK.
- STREET CUTS: APPLICATIONS FOR STREET CUT PERMITS MUST BE APPROVED BY THE CITY ENGINEER PRIOR TO APPROVAL OF IMPROVEMENT PLANS. THE PAVEMENT REPLACEMENT SECTION FOR ALL LONGITUDINAL AND TRANSVERSE TRENCHES LOCATED IN AN EXISTING PAVED STREET SHALL BE LONGITUDINAL AND TRANSVERSE TRENCHES LOCATED IN AN EXISTING PAVED STREET SHALL BE CONSTRUCTED IN ACCORDANCE M.A.G. UNIFORM. STANDARD DETAIL NO.200 "T"—TOP, BACKFILL, PAVEMENT SURFACE REPLACEMENT, MODIFIED AS FOLLOWS: THE WIDTH OF THE REPLACED PAVEMENT SECTION EXTEND 1 FOOT BEYOND THE TRENCH SIDE EDGE LINE, ON EITHER SIDE OF THE TRENCH. THE DEPTH OF THE PERMANENT SURFACE REPLACEMENT SHALL BE A MINIMUM OF 3 INCHES OR MATCH THE EXISTING THICKNESS OF THE PAVEMENT, WHICHEVER IS GREATER. SAWCUT OR CONSTRUCTION JOINTS SHALL BE ADEQUATELY TACK. OILED WITH A MINIMUM OF 95% COVERAGE. ASPHALT MATERIAL SHALL BE A COB APPROVED MIX DESIGN WITH COMPACTED LIFTS NO GREATER THAN 3 INCHES. SLURRY BACKFILLED OR OPEN TRENCHES EXISTING ROADWAYS MUST BE PROPERLY STEEL PLATED AND BARRICADED OVER NIGHT. STEEL PLATES TO BE MILLED FILISH WITH ROADWAY SUPPACE DED NOTE 24 "COLD MIX" NIGHT. STEEL PLATES TO BE MILLED: FLUSH WITH ROADWAY SURFACE PER NOTE 24. "COLD MIX" TEMPORARY ASPHALT PATCHES MUST BE REPLACED AS SOON AS POSSIBLE AND CANNOT REMAIN FOR MORE THAN 5 DAYS TIME OR AS REQUIRED BY THE COB. DURING THE 5 DAY PERIOD THE CONTRACTOR IS REQUIRED TO MAINTAIN THE PATCH TO WITHIN MAG STD SPEC 321.5.3. ASPHALT IN PLACE FOR LESS THAN 5 YEARS SHALL BE MILLED AND OVERLAYED A MINIMUM OF 20 FEET PAST TRENCH WALLS, AND IN THE CASE OF MULTIPLE STREET CUTS, THE CONTINUOUS MILL AND OVERLAY SHALL EXTEND A MINIMUM OF 2 FEET PAST END OF THE FURTHEST TRENCH WALLS.
- 15. POTHOLING: NO POTHOLING SHALL BE DONE ON ANY STREET NEWER THAN 2 YEARS OLD ALL POTHOLING IN EXISTING STREETS SHALL BE DONE USING WATER/AIR/VACUUM TYPE METHOD. POTHOLE SIZE SHALL BE LIMITED TO A 12 INCH BY 12 INCH SQUARE HOLE. REMOVAL MATERIAL CANNOT BE USED FOR BACK FILL THE CONTRACTOR SHALL USE SLURRY PER MAG SEC.728. PAVEMENT REPLACEMENT SHALL BE BY APPROVED HOT MIX ASPHALT ONLY. A 3 FOOT BY 3 FOOT PAVEMENT SLURRY SEAL SHALL BE APPLIED AFTER THE ASPHALT IS PLACED
- 16. AN APPROVED, UP-TO-DATE SET OF PLANS AND A RIGHT-OF-WAY PERMIT SHALL BE MAINTAINED ON THE JOB SITE AT ALL TIMES WHILE WORK IS IN PROGRESS. H THE PLANS AND PERMITS ARE NOT ON SITE, THE WORK SHALL BE STOPPED UNTIL THE APPROVED PLANS ARE PROVIDED. DEVIATION FROM THE PLANS SHALL NOT BE ALLOWED WITHOUT THE COB'S APPROVAL
- 17. DAMAGE TO ANY AND ALL ITEMS CAUSED BY CONSTRUCTION OR CONSTRUCTION RELATED WORK SHALL BE REPLACED OR REPAIRED TO THE SAME OR BETTER CONDITION AT THE CONTRACTOR'S EXPENSE.
- 18. ALL PARCEL CONSTRUCTION ACCESS LOCATIONS ARE SUBJECT TO THE CITY ENGINEER'S APPROVAL. THE CONTRACTOR SHALL BE RESPONSIBLE FOR MAINTAINING PROPER AND ADEQUATE ACCESS ROADS INSIDE AND THROUGHOUT THE PARCEL ALLOWING FOR INSPECTION ACCESSIBILITY. THIS INCLUDES GRADING, GRAVEL FILL AND/OR TRENCH PLATES AS REQUIRED.
- . THE CONTRACTOR AGREES TO ASSUME SOLE AND COMPLETE RESPONSIBILITY FOR JOB SITE CONDITIONS DURING THE COURSE OF CONSTRUCTION OF THIS PROJECT INCLUDING SAFETY OF ALL PERSONS AND PROPERTY. THIS REQUIREMENT SHALL APPLY CONTINUOUSLY NOT BE LIMITED TO NORMAL WORKING HOURS. THE CONTRACTOR SHALL DEFEND, INDEMNITY AND HOLD THE COB AND THE COB CONSULTANT & HARMLESS FROM ANY AND ALL LIABILITY, REAL OR ALLEGED, IN CONNECTION WITH THE PERFORMANCE OF WORK ON THIS PROJECT, EXCEPTING FOR LIABILITY ARISING FROM THE SOLE NEGLIGENCE OF THE
- THE COB SHALL NOT BE RESPONSIBLE FOR CONSTRUCTION MEANS, METHODS, TECHNIQUES, SEQUENCES OR PROCEDURES UTILIZED IN CONNECTION WITH THE WORK. THE COB WILL NOT BE RESPONSIBLE FOR THE CONTRACTOR'S FAILURE TO CARRY OUT THE WORK IN ACCORDANCE WITH THE CONTRACT DOCUMENTS COMPLYING WITH MAG OR COB REQUIREMENTS.
- 21. THE CONTRACTOR SHALL BE RESPONSIBLE FOR SUBMITTING CERTIFIED AS-BUILT RECORD DOCUMENT& TO THE COB FOR REVIEW AND APPROVAL. NO FINAL ACCEPTANCE SHALL BE ISSUED UNTIL"AS-BUILT" PLANS

CITY OF BUCKEYE GENERAL CONSTRUCTION NOTES (CONTINUED).

- CERTIFIED BY THE PROJECT ENGINEER/LAND SURVEYOR HAVE BEEN SUBMITTED AND ACCEPTED BY THE COB. FINAL CONSTRUCTION ACCEPTANCE OR THE RELEASE OF CERTIFICATE OF OCCUPANCIES SHALL NOT BE ISSUED UNTIL ALL AS-BUILT DRAWINGS AND OTHER REQUIRED DOCUMENTS PER THE COB'S FINAL PROJECT SUBMITTAL CHECKLIST HAVE BEEN REVIEWED AND APPROVED BY THE CITY ENGINEER.
- 22. ARRANGEMENTS FOR CONSTRUCTION WATER CAN BE MADE BY CALLING THE WATER RESOURCE DEPARTMENT AT (623) 349-6800.
- 23. THE COB IS NOT RESPONSIBLE FOR LIABILITY ACCRUED DUE TO DELAYS AND/OR DAMAGES TO UTILITIES IN CONJUNCTION WITH THIS CONSTRUCTION.ALSO, THE CITY WILL NOT PARTICIPATE IN THE COST OF CONSTRUCTION OR RELOCATION OF UTILITIES.
- 24. ALL CONTRACTORS SHALL CONTRACT FOR TRASH PICKUP THROUGH A LICENSED CITY OF BUCKEYE SOLID WASTE HAULER (602-237-2078) AND DISPOSED OF AT THE SOUTHWEST REGIONAL LANDFILL IN BUCKEYE.
- 25. OPEN TRENCHES ACROSS DRIVEWAYS, STREETS AND CROSS—STREETS SHALL BE PLATED FOR OVERNIGHT, WEEKEND OR EXTENDED PERIODS, PER M.A.G. UNIFORM STANDARD DETAIL 211.
- 26. ALL ABC SHALL BE FROM AN ARIZONA DEPARTMENT OF TRANSPORTATION (ADOT) APPROVED SOURCE
- 27. LONGITUDINAL TRENCH BACKFILL IN EXISTING ARTERIAL, COLLECTOR, OR LOCAL ROADWAYS OR ADJACENT TO EXISTING ROADWAY (WHEN THE TRENCH EXCAVATION FALLS WITHIN 2 FEET OF EDGE OF PAVEMENT) SHALL REQUIRE % SACK CLSM PER MAG SPEC 728 FULL DEPTH OR ABC FULL DEPTH AS DIRECTED BY THE COB. ABC BACKFILL COMPACTION SHALL BE BY AN APPROVED MECHANICAL METHOD (NO WATER SETTLING) WITH BACKFILL MATERIAL LIST AS FOLLOWS:
- 12 INCH LIFTS (LOOSE) TO BE USED IN THE TOP 4 FEET OF THE TRENCH
- 24 INCH LIFTS (LOOSE) TO BE USED FROM 1 FOOT OVER THE PIPE TO 4 FEET FROM THE TOP OF THE TRENCH PER MAG SEC.601.4.
- 28. ALL BACKFILL WITHIN OR ADJACENT TO EXISTING ROADWAYS SHALL BE MECHANICALLY COMPACTED.
- 29. TRANSVERSE TRENCH BACKFILL IN ALL EXISTING ROADWAYS SHALL REQUIRE 100% FULL DEPTH HALF SACK CLSM PER MAG SPEC 728.
- 30. ALL MATERIAL SUBMITTALS INCORPORATED IN THE PROJECT SHALL BE SUBMITTED AT OR BEFORE THE PRE-CONSTRUCTION MEETING FOR REVIEW AND APPROVAL BY THE CITY ENGINEER.

HILGARTWILSON STANDARD ENGINEERING NOTES

- 1. THESE PLANS ARE SUBJECT TO THE INTERPRETATION OF INTENT BY THE ENGINEER. ALL QUESTIONS REGARDING THESE PLANS SHALL BE PRESENTED TO THE ENGINEER. ANYONE WHO TAKES IT UPON THEMSELVES THE INTERPRETATION OF THE DRAWINGS OR MAKES REVISIONS TO THE SAME WITHOUT CONFERRING WITH THE DESIGN ENGINEER SHALL BE RESPONSIBLE FOR THE CONSEQUENCES THEREOF.
- 2. THE ESTIMATED QUANTITIES SHOWN ARE FOR INFORMATION PURPOSES ONLY. THE CONTRACTOR SHALL BE RESPONSIBLE FOR THE COMPLETENESS AND ACCURACY OF A DETAILED ESTIMATE BASED ON THESE PLANS, CURRENT CODES, AND SITE VISITATION.
- 3. ALL EARTHWORK CONSTRUCTION SHALL CONFORM TO THE LATEST MARICOPA ASSOCIATION OF GOVERNMENTS STANDARD DETAILS AND/OR SPECIFICATIONS INCLUDING ANY SUPPLEMENTS THERETO, AND ALL ADDENDA. THE CONTRACTOR IS TO FOLLOW THE RECOMMENDATION OF THE SOIL INVESTIGATION REPORT AND LETTER, AS PREPARED BY (ALPHA GEOTECHNICAL & MATERIALS, INC.), PHONE NO. (602) 453-3265, PROJECT NO. 20-G-11044, DATED FEB. 9,
- 4. PRIOR TO BIDDING THE WORK, THE CONTRACTOR SHALL THOROUGHLY SATISFY HIMSELF AS TO THE ACTUAL CONDITIONS, REQUIREMENTS OF THE WORK AND EXCESS OR DEFICIENCY IN QUANTITIES. NO CLAIMS SHALL BE MADE AGAINST THE OWNER/DEVELOPER OR ENGINEER FOR ANY EXCESS OR DEFICIENCY THEREIN, ACTUAL OR RELATIVE.
- 5. THE ENGINEER SHALL NOT BE RESPONSIBLE FOR CONSTRUCTION MEANS, METHODS, TECHNIQUES, SEQUENCES, PROCEDURES OR SAFETY PRECAUTIONS OR PROGRAMS UTILIZED IN CONNECTION WITH THE WORK, AND WILL NOT BE RESPONSIBLE FOR THE CONTRACTOR'S FAILURE TO CARRY OUT THE WORK IN ACCORDANCE WITH THE CONTRACT DOCUMENTS.
- 6. THE ENGINEER SHALL NOT BE RESPONSIBLE FOR COORDINATING THE RELOCATION OF UTILITIES. POWER POLES, ETC.
- 7. THE CONTRACTOR SHALL MAKE NO CLAIM AGAINST THE OWNER OR THE SURVEYOR REGARDING ALLEGED INACCURACY OF CONSTRUCTION STAKES SET BY THE SURVEYOR UNLESS ALL SURVEY STAKES SET BY THE ENGINEER ARE MAINTAINED INTACT AND CAN BE VERIFIED AS TO THEIR ORIGIN. IF, IN THE OPINION OF THE SURVEYOR, THE STAKES ARE NOT MAINTAINED INTACT AND CANNOT BE VERIFIED AS TO THEIR ORIGIN, ANY REMEDIAL WORK REQUIRED TO CORRECT ANY ITEM OF IMPROPER CONSTRUCTION WORK SHALL BE PERFORMED AT THE SOLE EXPENSE OF THE RESPONSIBLE CONTRACTOR OR SUBCONTRACTOR.
- 8. THE SURVEYOR WILL MAKE FIELD AS-BUILT MEASUREMENTS OF THE WORK UPON NOTIFICATION BY THE CLIENT OR HIS REPRESENTATIVE THAT THE WORK IS COMPLETE AND READY FOR AS-BUILT SURVEY. FOR PIPE WORK, THE CONTRACTOR IS RESPONSIBLE FOR LEAVING TRENCHES OPEN SO THAT AS-BUILTS CAN BE PERFORMED TO COMPLY WITH THE AGENCY'S REQUIREMENTS. (IF THE TRENCHES ARE BACKFILLED AND OBSCURED TO THE POINT THAT AS-BUILT MEASUREMENTS CANNOT BE PERFORMED, IT WILL BE THE RESPONSIBILITY OF THE CONTRACTOR TO POTHOLE UTILITY TRENCHES AS NECESSARY TO COMPLETE AN AS-BUILT SURVEY.)
- 9. EXISTING UTILITIES SHOWN ON THESE PLANS HAVE BEEN LOCATED ACCORDING TO INFORMATION PROVIDED BY THE AGENCY OPERATING EACH UTILITY. LOCATIONS SHOWN ARE APPROXIMATE ONLY, AND ARE NOT RELIABLE FOR CONSTRUCTION PURPOSES. CALL BLUE STAKE FOR FIELD LOCATION AT (602) 263-1100. THE CONTRACTOR SHALL PROTECT AND MAINTAIN ALL EXISTING UTILITIES ON THE SITE. ANY DAMAGE TO EXISTING UTILITIES, WHETHER SHOWN OR NOT ON THE DRAWING, SHALL BE REPAIRED/REPLACED AT THE CONTRACTOR'S EXPENSE. EXISTING SURFACE FEATURES AND FENCING SHALL BE REPLACED IN LIKE KIND.
- 10. PRIOR TO CONSTRUCTION, THE ENGINEER AND APPLICABLE AGENCY MUST APPROVE ANY ALTERATION, OR VARIANCE FROM THESE PLANS. ANY VARIATIONS FROM THESE PLANS SHALL BE PROPOSED ON CONSTRUCTION FIELD PRINTS AND TRANSMITTED TO THE ENGINEER.
- 11. ANY INSPECTION BY THE CITY, COUNTY, ENGINEER, OR OTHER JURISDICTIONAL AGENCY, SHALL NOT, IN ANY WAY, RELIEVE THE CONTRACTOR FROM ANY OBLIGATION TO PERFORM THE WORK IN STRICT COMPLIANCE WITH APPLICABLE CODES AND AGENCY REQUIREMENTS.
- 12. CONTRACTOR IS RESPONSIBLE FOR PROTECTING ALL STORM DRAIN PIPES, STORM WATER RETENTION PIPES AND DRAINAGE FACILITIES FROM DAMAGE DURING ALL STAGES OF CONSTRUCTION. THE DEPTH OF COVER ON THE STORM DRAIN PIPE IS DESIGNED FOR FINAL GRADE. THEREFORE, EXTRA CARE SUCH AS BERMING OVER PIPES, FLAGGING OR SIGNAGE SHOULD BE USED DURING CONSTRUCTION TO MAINTAIN COVER OR PROTECT THE PIPES.
- 13. UNDERGROUND UTILITIES SHALL BE MARKED IN ACCORDANCE WITH SECTION 40-360 OF THE ARIZONA REVISED STATUTES AND LOCAL MUNICIPALITY REQUIREMENTS.

CITY OF BUCKEYE PAVING NOTES

- 1. LOCATION OF ALL VALVES AND MANHOLES MUST BE REFERENCED AT ALL TIMES BY THE CON1RACTOR DURING CONSTRUCTION.
- SUBGRADE AND PAVING OPERATIONS SHALL NOT BEGIN UNTIL ALL UTILITY FRAME AND COVER LOCATIONS HAVE BEEN PROPERLY REFERENCED TO FACILITATE ADJUSTMENTS.
- 3. BASE COURSE SHALL NOT BE PLACED ON SUBGRADE UNTIL ALL SUBGRADE REQWREM.ENTS HAVE BEEN COMPLETED AND APPROVED BY THE CITY INSPECTOR.
- 4. NO PAVING CONSTRUCTION SHALL COMMENCE UNTIL ALL UNDERGROUND UTILITIES WITHIN THE ROADWAY ARE COMPLETED, TESTED, APPROVED AND THE "TO PAVE" AS BUILT DRAWINGS ARE REVIEWED AND APPROVED BY THE CITY.
- 5. BASE COURSE SHALL NOT BE PLACED ON SUBGRADE UNTIL BASE REQUIREMENTS HAVE BEEN COMPLETED TESTED AND APPROVED BY THE CITY.
- ALL RETURN TYPE DRIVEWAYS WITH CONCRETE PAVEMENT SHALL UTILIZE MAG CLASS A CONCRETE FUR ALL CONSTRUCTION WITHIN1HE RIGHT-OF-WAY.
- ASPHALT AND GUTTERS SHALL BE WATER TESTED IN THE PRESENCE OF THE CITY'S AUTHORIZED REPRESENTATIVE TO ENSURE PROPER DRAINAGE, PRIOR TO FINAL APPROVAL BY THE CITY. WATER SHALL NOT POND MORE THAT 7'4 OF AN INCH. ANY PANELING THAT EXCEED THIS WILL BE REMOVED AND REPLACED AT THE CONTRACTOR'S EXPENSE.
- 8. THE EXACT POINT OF MATCHING, TERMINATION AND OVERLAY WILL BE DETERMINED IN1HE FIELD BY THE CITY OF BUCKEYE ENGINEERING DEPARTMENT
- 9. NO JOB WILL BE CONSIDERED COMPLETE UNTIL ALL CURBS, PAVEMENT, AND SIDEWALKS HAVE BEEN SWEPT CLEAN OF ALL DIRT AND DEBRIS. ALL WATER SERVICE METER BOXES SHALL BE SET TO HAVE THE TOP OF THE BOX ELEVATION MATCH TOP OF SIDEWALK ELEVATION.
- 10. ALL SLEEVING INSTALLED UNDER NEW STREETS SHALL BE DONE WITH SCH 80 PVC SLEEVING CONDUIT UNLESS OTHERWISE SPECIFIED.
- 11. NO GRINDING OF CONCRETE IS ALLOWED IN THE CITY OF BUCKEYE. REVERSE FLOW IN CURB GUTTER, AND VALLEY GUTTER WILL BE REMOVED AND REPLACED AT THE CONTRACTOR'S EXPENSE.
- 12. ALL JOINTS SHALL BE TACK COATED WITH A MINIMUM OF95% COVERAGE OF THE JOINT.
- 13. CONCRETE REPAIR WILL NOT BE ALLOWED IN THE CITY OF BUCKEYE. ALL DAMAGED CONCRETE SHALL BE REMOVED AND REPLACED TO THE NEAREST JOINT
- 14. ALL ASPHALT JOINTS SHALL BE SEALED PRIOR TO THE FINAL WALK THROUGH.
- 15. FIBER MESH IS REQUIRED IN ALL CONCRETE APRONS AND VALLEY GUTTERS
- 16. ALL MILLINGS FROM PUBLIC PROJECTS SHALL BE GIVEN TO THE CITY OF BUCKEYE PUBLIC WORKS DEPARTMENT
- 17. HIGH SPOTS IN ASPHALT SHALL BE REMOVED AND REPLACED. REHEATING OR BURNING OF ASPHALT IS NOT ALLOWED IN BUCKEYE.
- 18. ALL ASPHALT SHALL BE SAW CUT TO A CLEAN TRUE EDGE FUR THE FULL FACE OF THE SECTION PRIOR TO TYING IN. MILLED EDGES WILL BE EVALUATED BY THE CITY INSPECTOR FOR POSSIBLE
- 19. AN RLS CERTIFIED AS BUILT PLAN OF ALL NEW CONCRETE CURB AND GUTTER, VALLEY GUTTER, DRAINAGE CONTROL STRUCTURES, SURVEY MONUMENT LOCATIONS AND ALL SIGNING AND STRIPING SHALL BE SUBMITTED PRIOR TO ACCEPTANCE OF THE COMPLETED RIGHT OF WAY IMPROVEMENTS .
- 20. ALL IMPROVEMENT WORK SHALL BE APPROVED BY THE CITY INSPECTOR INCLUDING UTILITY ADJUSTMENTS, SURVEY MONUMENTS, SIGN BASES, PARKWAY GRADING, AND ANY REPAIR OR

PLAN NAME

- 21. DURING ALL PAVING OPERATIONS AN ADDITIONAL LAB TECHNICIAN SHALL BE LOCATED AT THE ASPHALT PRODUCTION PLANT TO ENSURE APPROVED MATERIAL IS BEING USED IN THE ASPHALT MIX.
- 22. NO NEWLY PAVED STREET CAN BE OPENED TO TRAFFIC WITHOUT APPROVAL OF THE CITY INSPECTOR.
- 23. MATERIAL USED IN THE ASPHALT PROVIDED TO THE CITY SHALL BE 100% VIRGIN FROM AN APPROVED PIT. NO RECYCLED ASPHALT IS ALLOWED IN THE CITY OF BUCKEYE.



FLOREO AT TERAVALIS COLLECTORS - PHASE 1 NOTES						
HILGA COB PERMITTING APPROVED SEAL	SUBMITTAL: 3RD SUBMITTAL					
AS-BUILT SEAL	DESIGN SEAL 69427 JOSHUA ROBINSON ARIZONA U.S.A. ARIZONA U.S.A.	PLAN TRACKING # ENG-21-0288 ENG-21-0288 ENG-21-0288				
ORIGINAL PLAN DATE Aug-21	LATEST REVISION DATE Feb – 23	PLAN TRAC ENG- PERMIT # ENG-				
PROJECT NUMBER	SHEET NUMBER SHT	PER PER				

CITY OF BUCKEYE NOTES

ALL CURRENT CITY OF BUCKEYE GENERAL NOTES & UTILITY NOTES ARE ACCESSIBLE ON THE CITY'S WEBSITE AT www.buckeyeaz.gov, UNLESS OTHERWISE ATTACHED.



THE PREFERRED LOCATION OF WATER. SEWER AND RECLAIMED WATER LINES ARE SHOWN ON THE TYPICAL STREET SECTIONS. THE LOCATION OF THESE LINES MAY BE MODIFIED AT THE TIME OF FINAL DESIGN, SUBJECT TO THE APPROVAL OF THE CITY OF BUCKEYE. WHERE PRACTICAL THE LINES SHALL BE CENTERED WITHIN A TRAFFIC LANE, IT IS UNDERSTOOD THAT SANITARY SEWER LINES WILL BE INSTALLED WITH STRAIGHT RUNS BETWEEN MANHOLES AND AS A RESULT WILL NOT BE AT A CONSISTENT OFFSET ON STREET CURVES. THE SANITARY SEWER LINES SHALL BE DESIGNED SUCH THAT MANHOLES ARE LOCATED OUTSIDE OF VEHICULAR WHEEL PATHS.

PAVEMENT SECTION NOTE

FINISH SURFACE -

LOOSE RIP RAP

SIZE PER PLAN

OF RIP RAP

SECTION A

DEPTH PER —

FILTER FABRIC, MIRAFI EROSION

PROTECTION GEO-TEXTILE OR APPROVED


220. FILTER FABRIC SHALL ENCLOSE ALL

EQUIVALENT PER MAG SPEC SECTION

SIDES OF RIP RAP ADJACENT TO SOIL.

PLAN

PAVEMENT SECTION SHALL BE THE GREATER OF THE APPLICABLE CITY OF BUCKEYE REQUIREMENTS PER CITY OF BUCKEYE EDS SECTION 6-3 OR THE APPROVED GEOTECHNICAL REPORT.

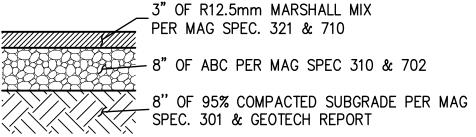

RESIDENTIAL ENTRANCE & MAJOR LOCAL STREET

PAVEMENT SECTION (PER C.O.B. STD DTL 63190)

CONCRETE HEADWALL PER COB

∕- EL=100.50

∠ EL=100.00

STD DTL 51200, TYPE PER PLAN

LOOSE RIP RAP, SIZE AS NOTED ON PLAN

DIMENSION

PER PLAN

EL=99.83 **B**

EL=99.83

- RADIUS IS EQUAL TO

DEPTH OF RIP RAP

- FINISH SURFACE OF

BASIN SUBGRADE

2" TURN DOWN (MIN)

TOE OF SLOPE -

EL=100.50 -

<u>PLAN</u>

TOE OF SLOPE

EL=100.00

DIMENSION

PER PLAN

EL=100.00 -

PER PLAN

-FINISH SURFACE

r EL=99.83

-FINISH SURFACE

(EL=100.00 ASSUMED

OF BASIN

OF RIP RAP

2" FINISH LANDSCAPE

TREATMENT

- FINISH SURFACE OF BASIN

(EL=100.00 ASSUMED)

STORM DRAIN PIPE, -

SIZE PER PLAN


FILTER FABRIC -

FILTER FABRIC

TERMINATION


EL=100.50

A A A A

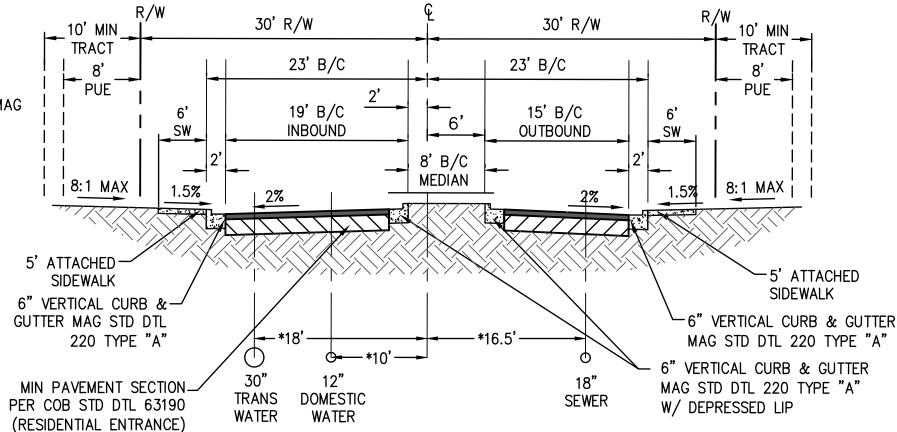

TYPICAL RESIDENTIAL ENTRANCE SECTION

PER COB STD DTL 63190 LARKSPUR DRIVE - AT INTERSECTIONS ONLY FROM STA: 11+71.13 TO STA: 12+71.13 FROM STA: 22+91.06 TO STA: 23+91.06 (LOOKING EAST) SCALE: N.T.S. * WATER IF ON NORTH OR EAST SIDE OF STREET. TRANSITION WATER IF ON NORTH OR EAST SIDE OF STREET SEWER IF ON SOUTH OR WEST SIDE OF STREET.

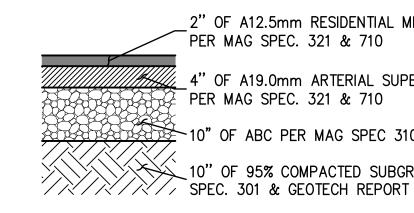


2" OF A12.5mm RESIDENTIAL MIX PER MAG SPEC. 321 & 710

4" OF A19.0mm ARTERIAL SUPERPAVE PER MAG SPEC. 321 & 710

10" OF ABC PER MAG SPEC 310 & 702 _10" OF 95% COMPACTED SUBGRADE PER MAG

COLLECTOR

PAVEMENT SECTION (PER C.O.B. STD DTL 63150) NTS

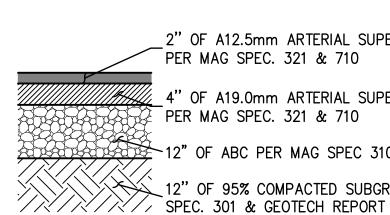

2" OF A12.5mm ARTERIAL SUPERPAVE PER MAG SPEC. 321 & 710

4" OF A19.0mm ARTERIAL SUPERPAVE PER MAG SPEC. 321 & 710

12" OF ABC PER MAG SPEC 310 & 702 12" OF 95% COMPACTED SUBGRADE PER MAG

PUE

-26' B/C — ├── 8' PUE 8' PUE --TRAVEL TRAVEL 4' BIKE 4' BIKE LANE LANE - 6' S/W | 8:1 MAX 1.5% 1.5% 8:1 MAX -6" VERTICAL CURB & GUTTER 6' DETACHED _ MAG STD DTL 220 TYPE "A" SIDEWALK - MIN PAVEMENT SECTION 6" VERTICAL CURB & GUTTER SEWER DOMESTIC TRANS PER COB STD DTL 63150 MAG STD DTL 220 TYPE "A" WATER WATER (COLLECTOR)

- OPTIONAL RAISED MEDIAN

(WHERE NOTED ON PLANS)

ENGINEER INFORMATION

TYPICAL COLLECTOR SECTION


PER COB STD DTL 63150 ROSEWOOD AVE (WEST OF FLOREO CIRCLE) (LOOKING NORTH & WEST) SCALE: NTS



PUE

MAJOR COLLECTOR

PAVEMENT SECTION (PER C.O.B. STD DTL 63140)

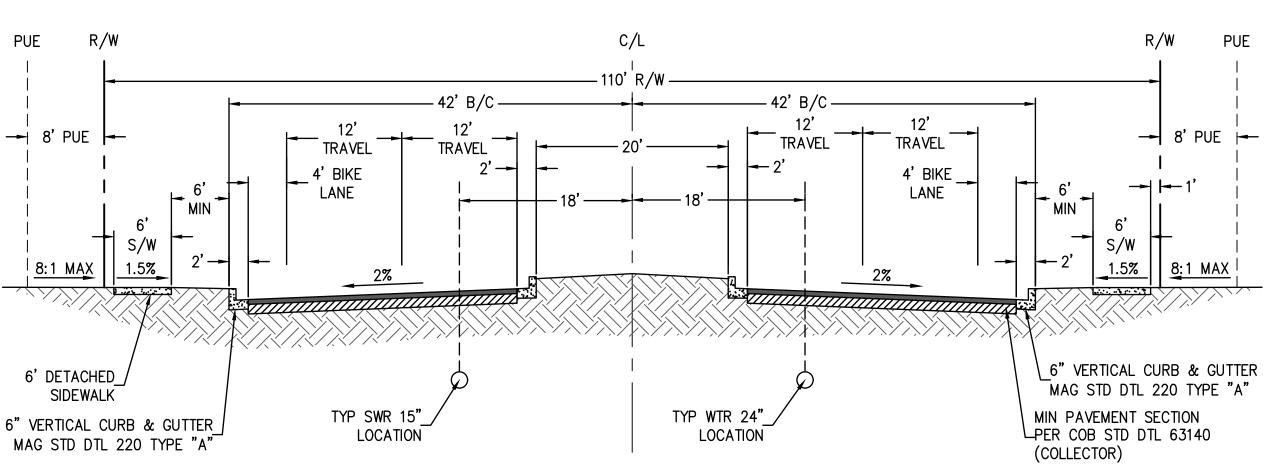

HILGARTWILSON COB PERMITTING APPROVED SEAL **COB ENGINEERING** APPROVED SEAL AS-BUILT SEAL 69427 JOSHUA ROBINSON LATEST REVISION DATE ORIGINAL PLAN DATE Feb-23 Aug-21

FLOREO AT TERAVALIS

COLLECTORS - PHASE 1 NOTES & DETAILS

TYPICAL MAJOR COLLECTOR SECTION

PER COB STD DTL 63140 304TH AVENUE (LOOKING NORTH & WEST) SCALE: NTS


RIP RAP DETAIL - HEADWALL


SECTION B-B


SHEET NUMBER SHT.


DTO3 4 OF 20 1175 U: \1100\1175\ENGR\^Collectors\PLANS\PAVING\PHASE 1\1175-COL-DT03.dwg 2/28/2023 3:46 PM


PROJECT NUMBER

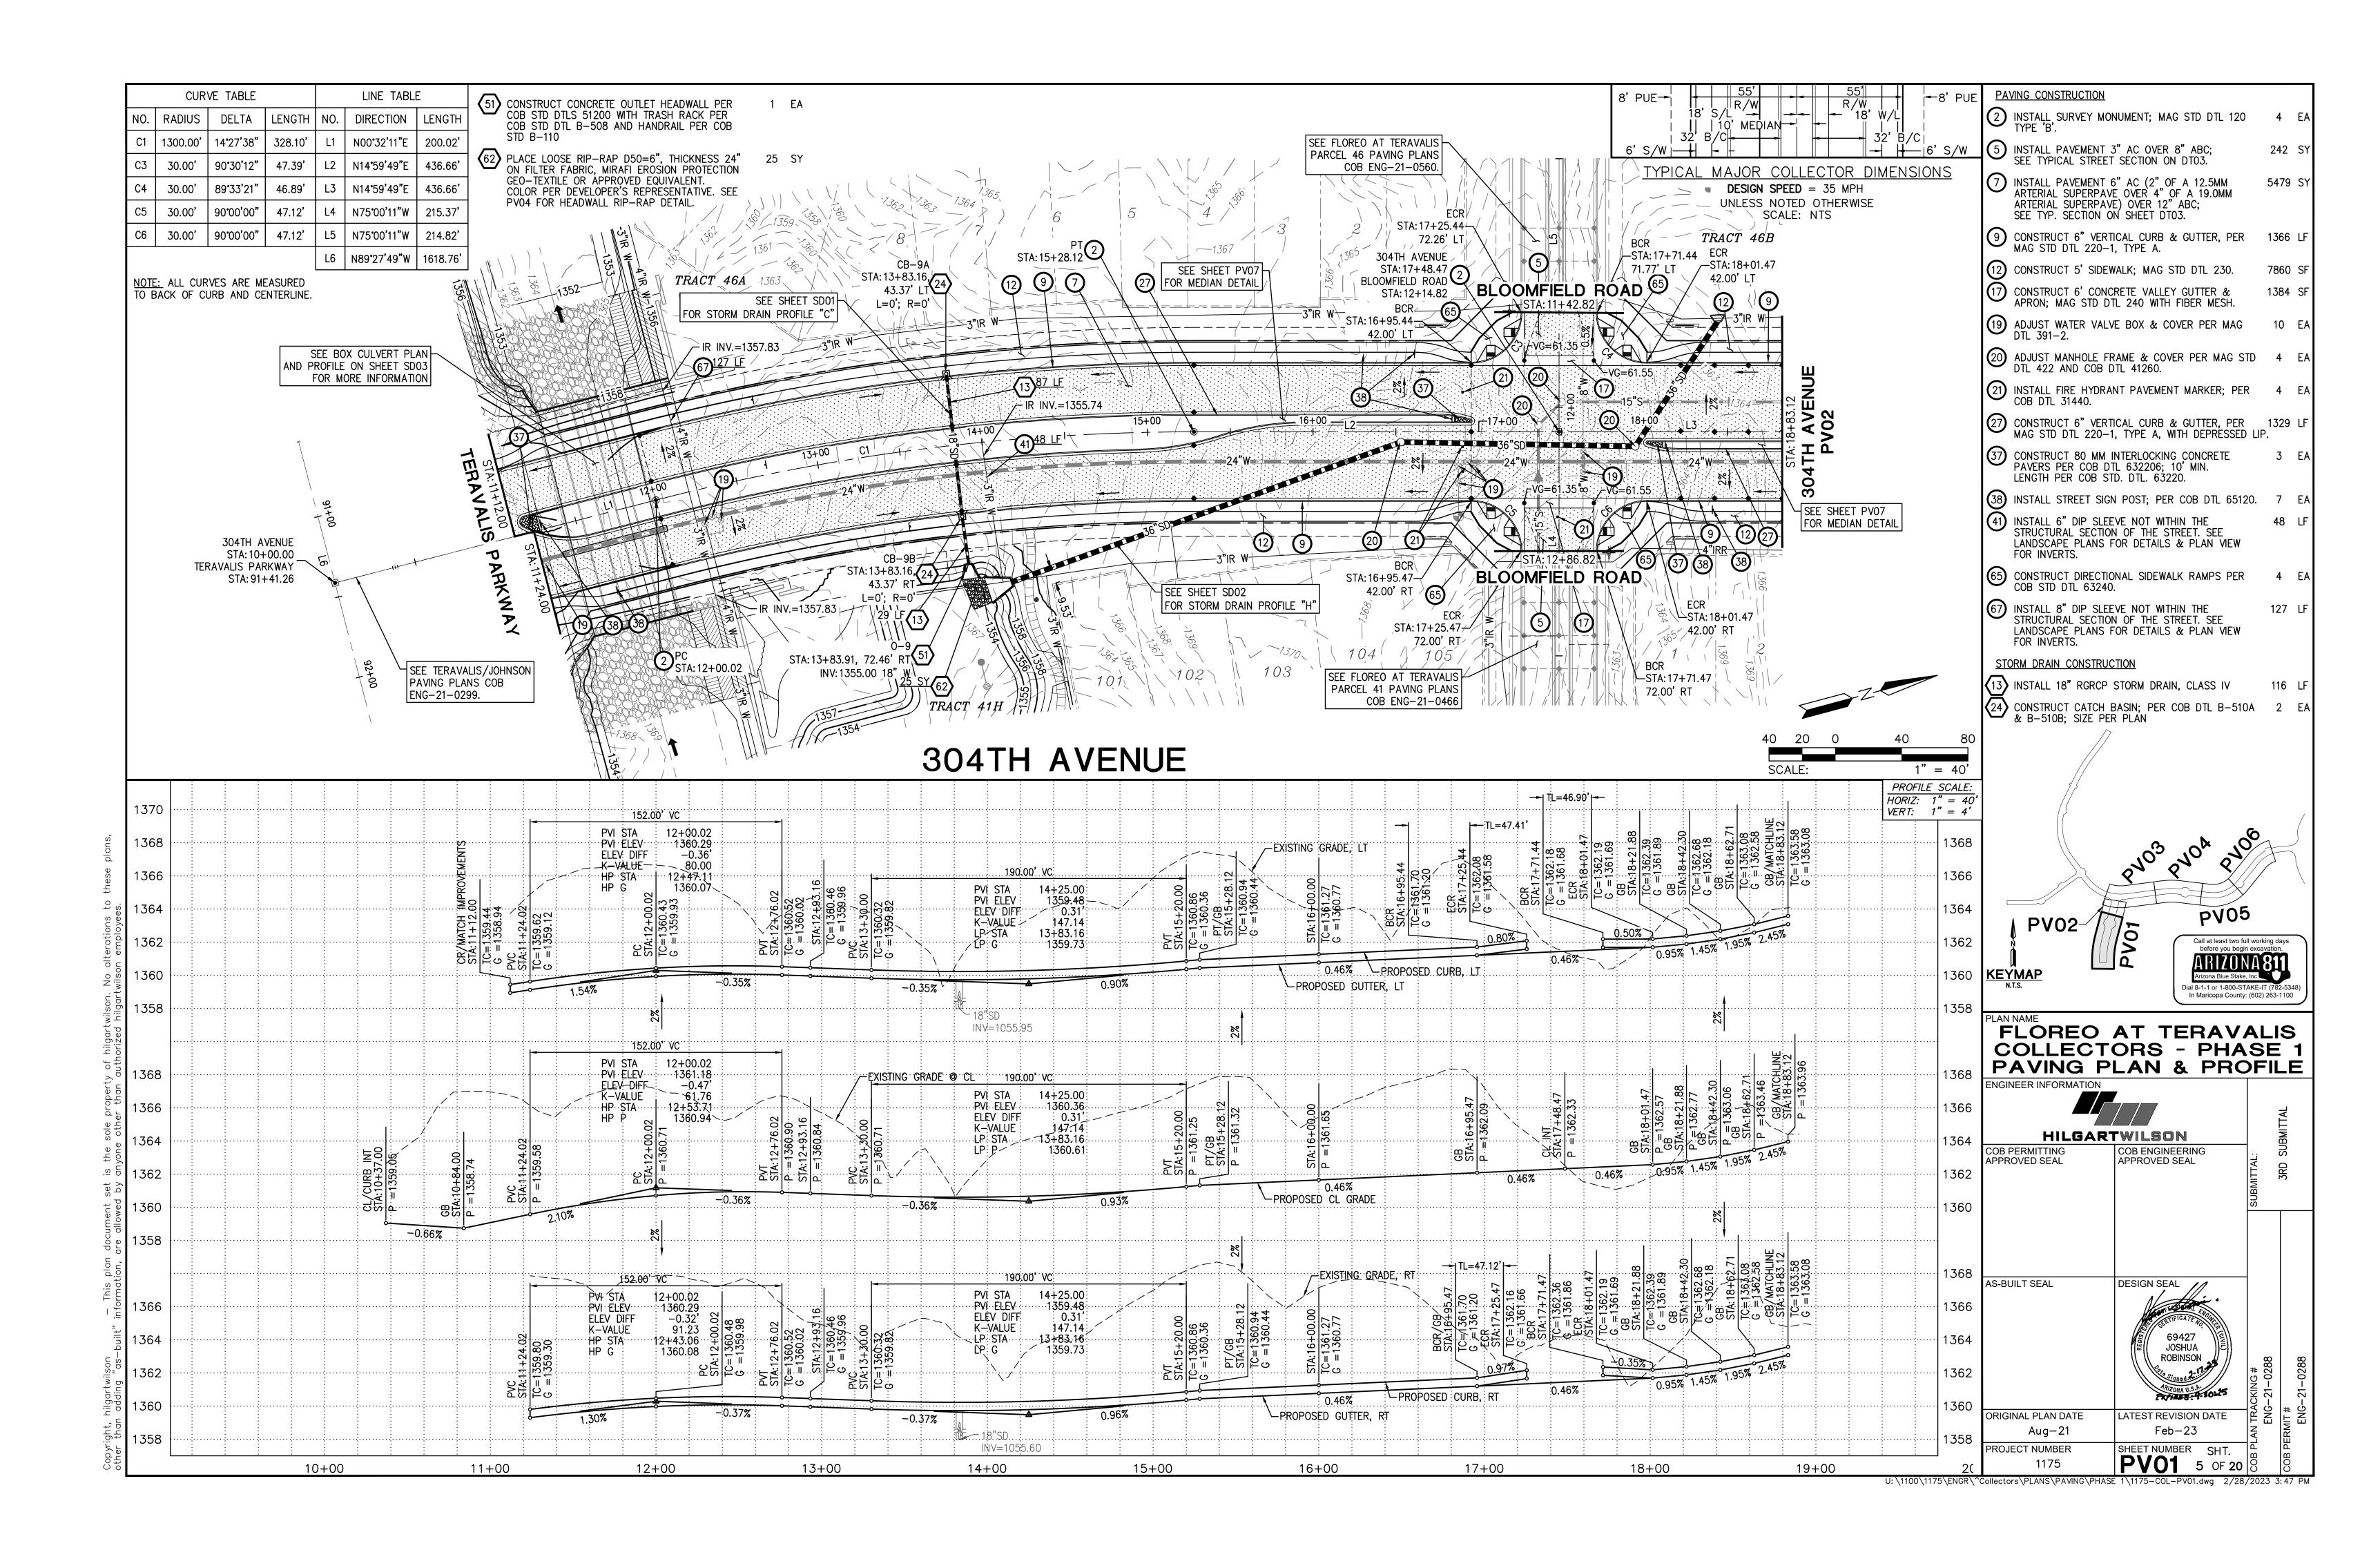


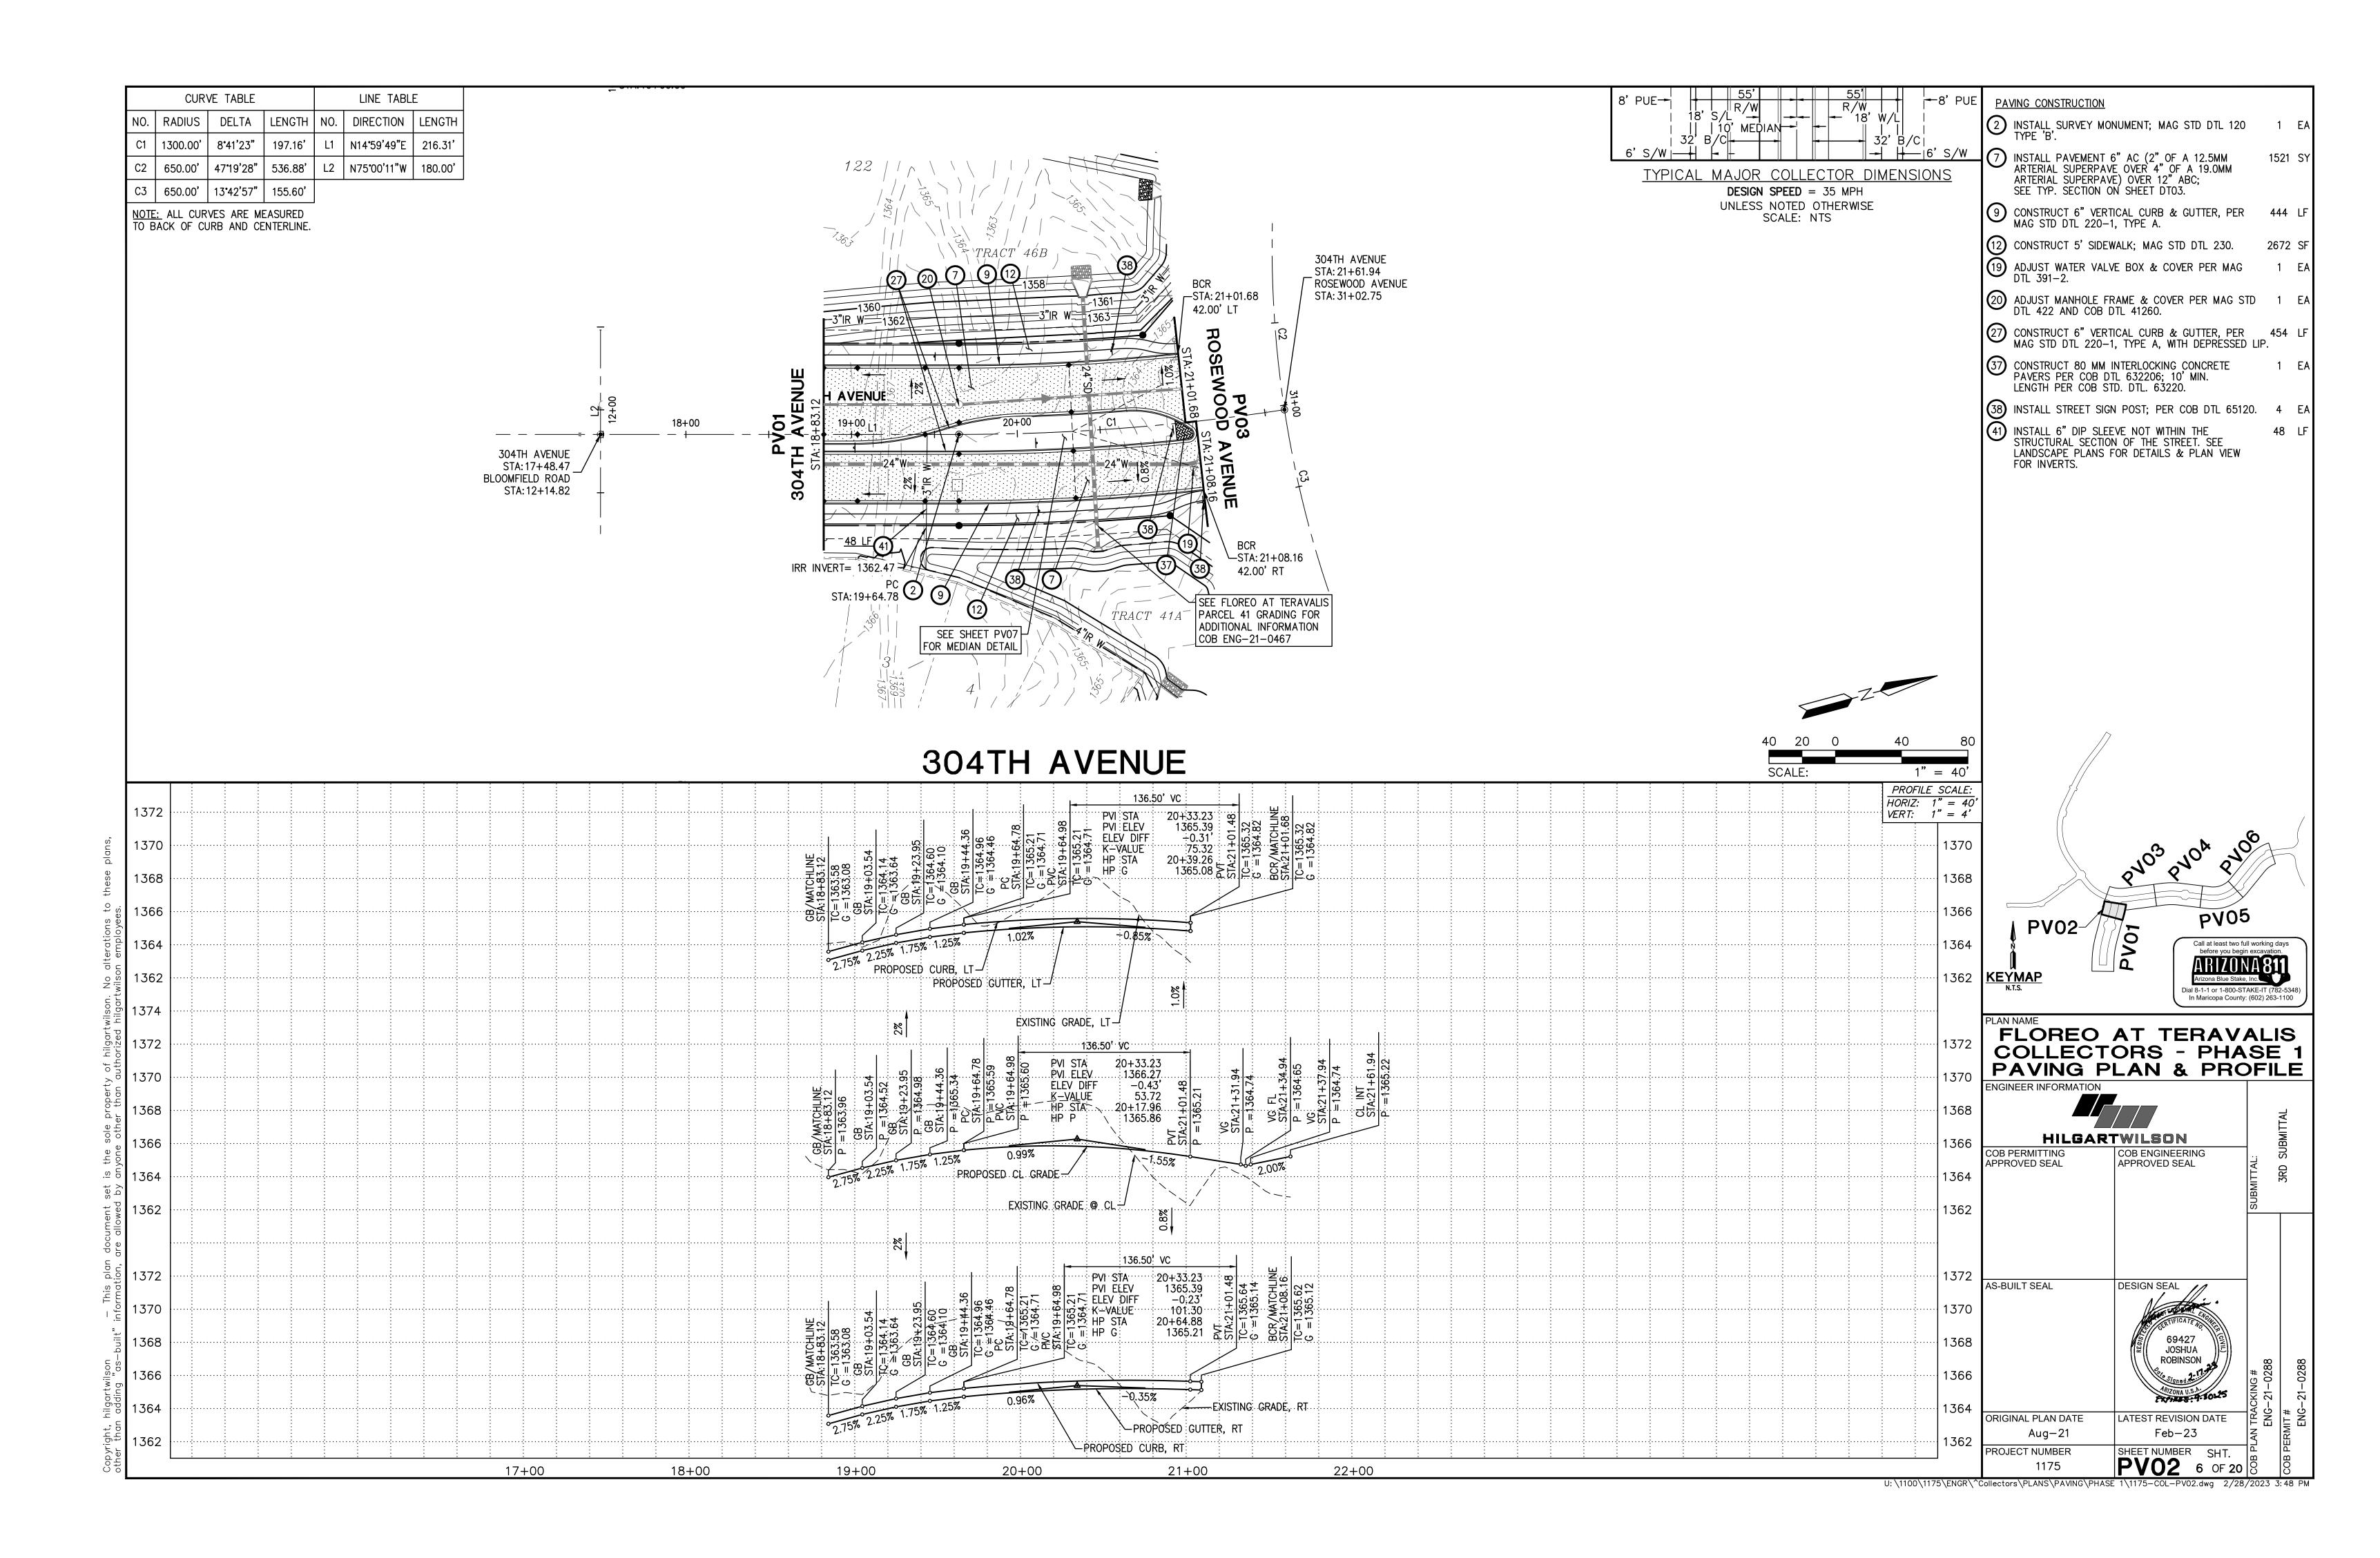


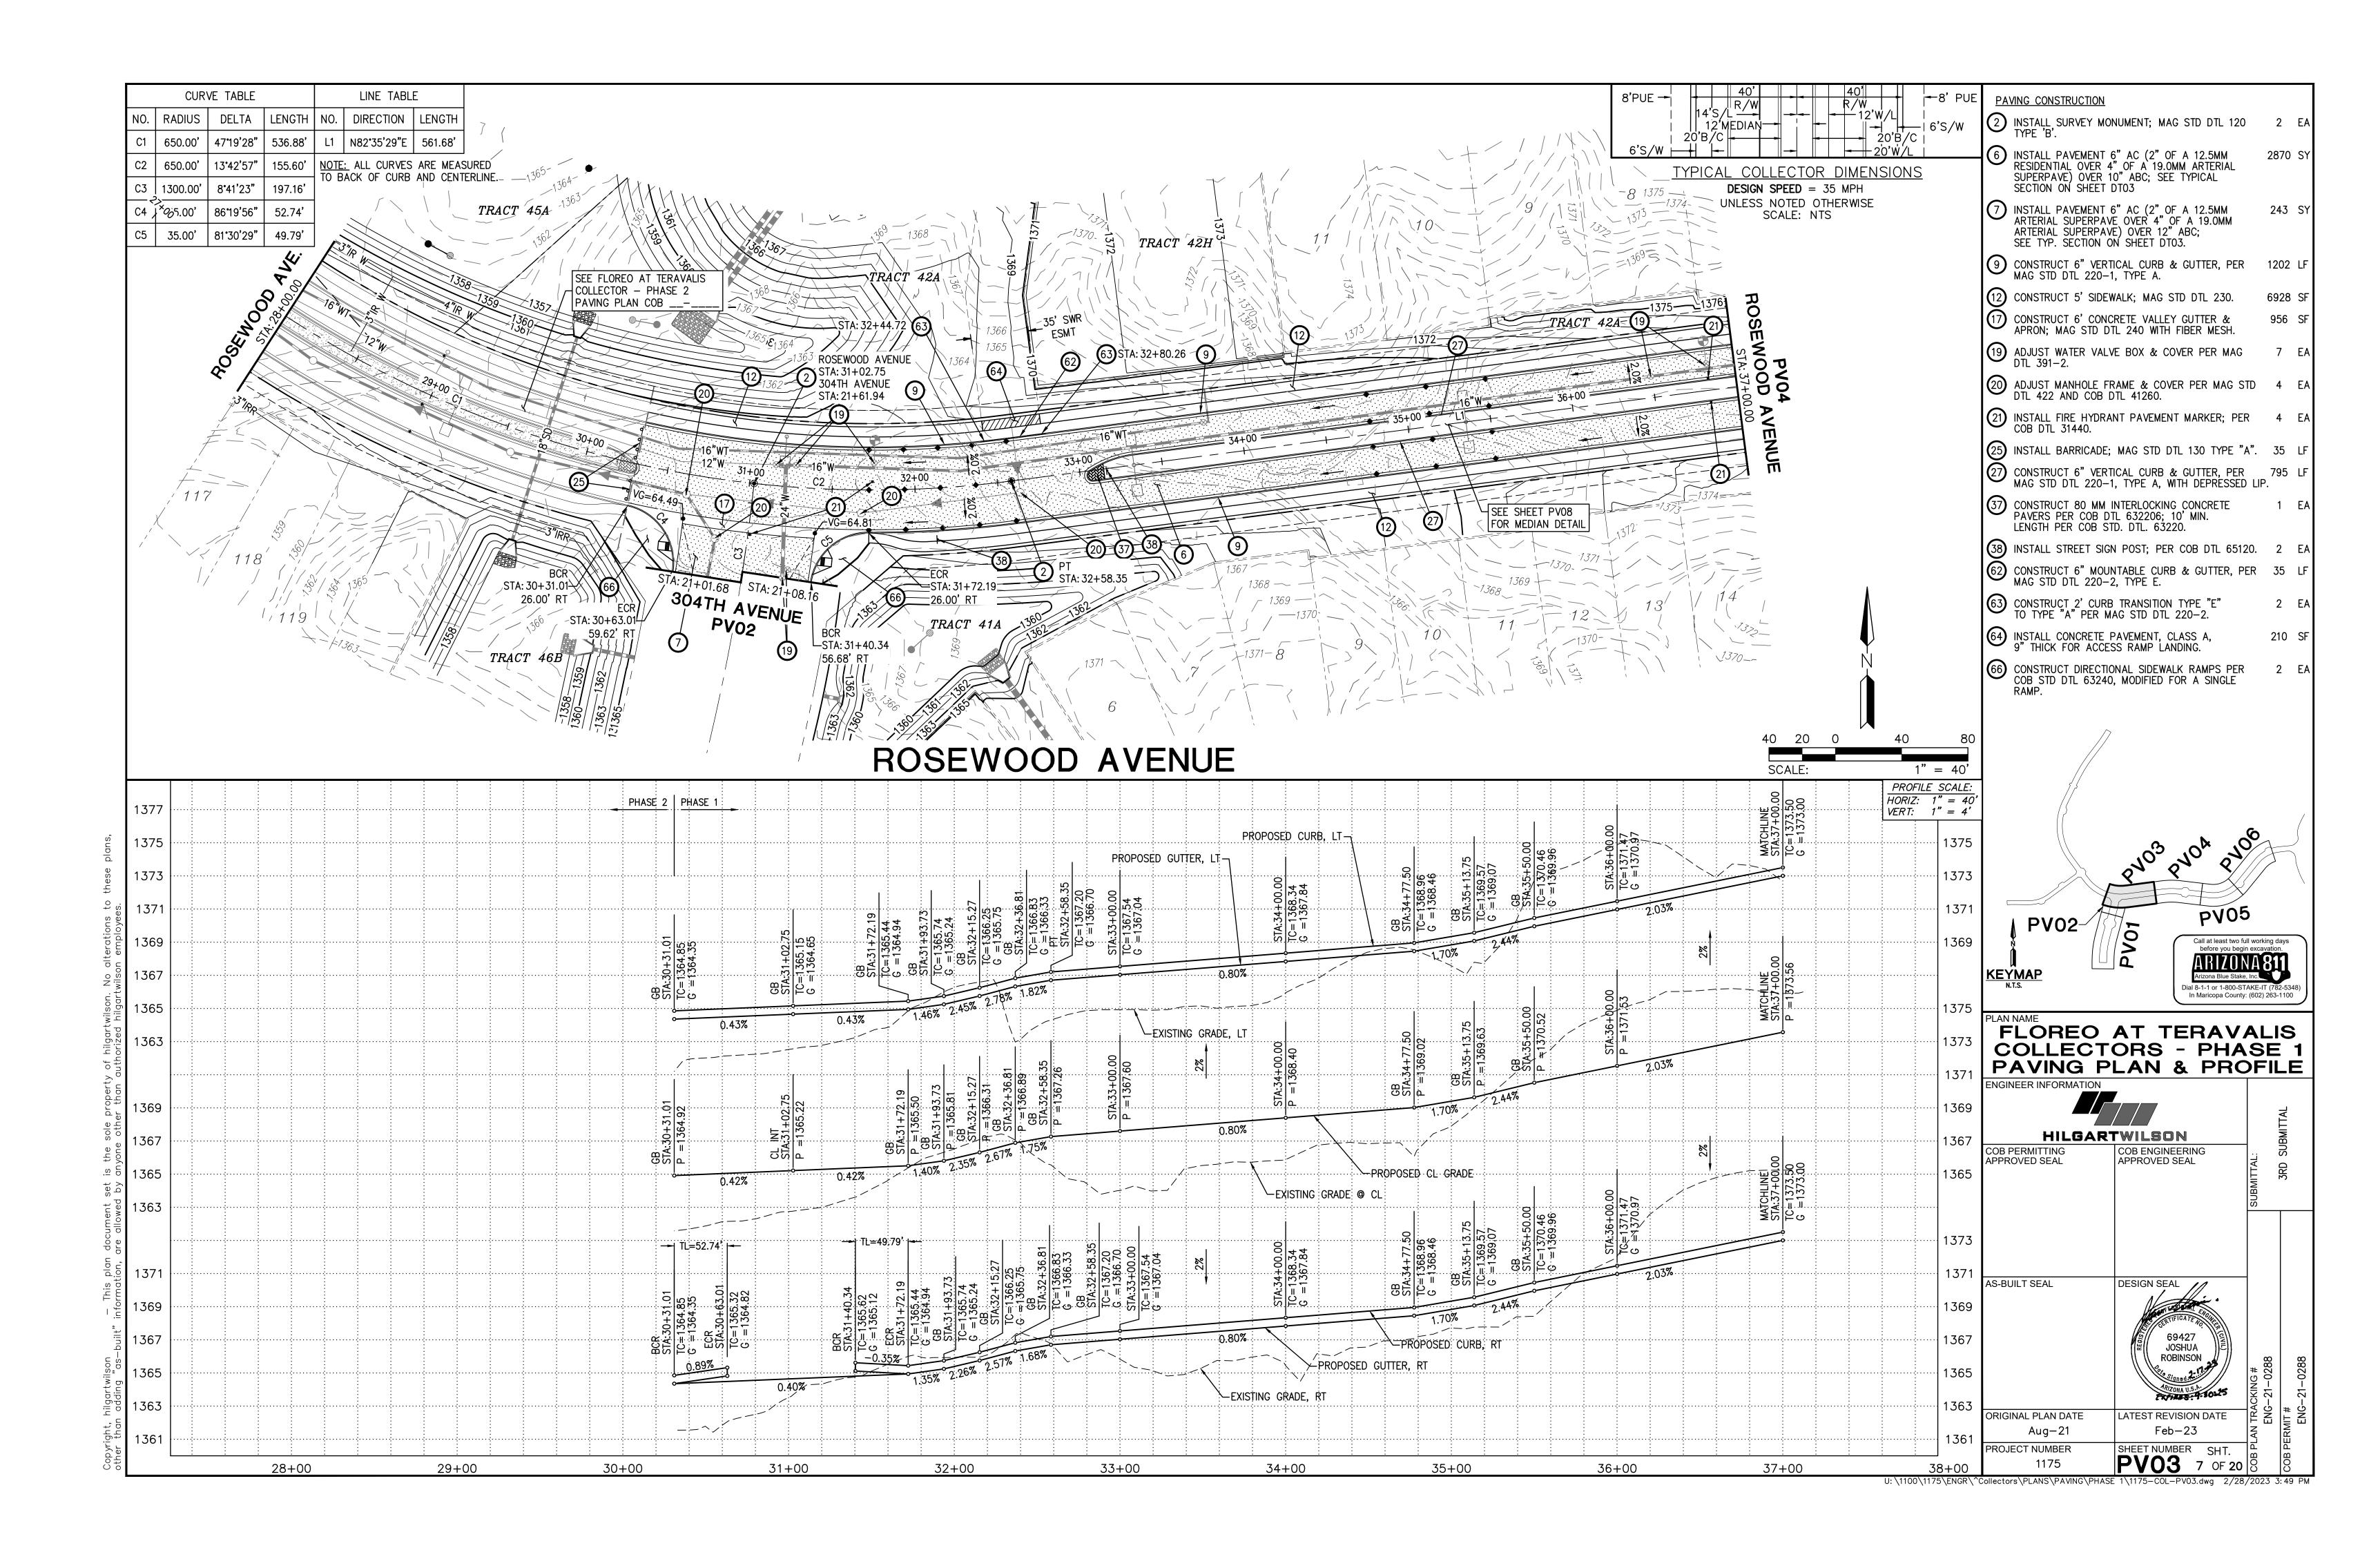


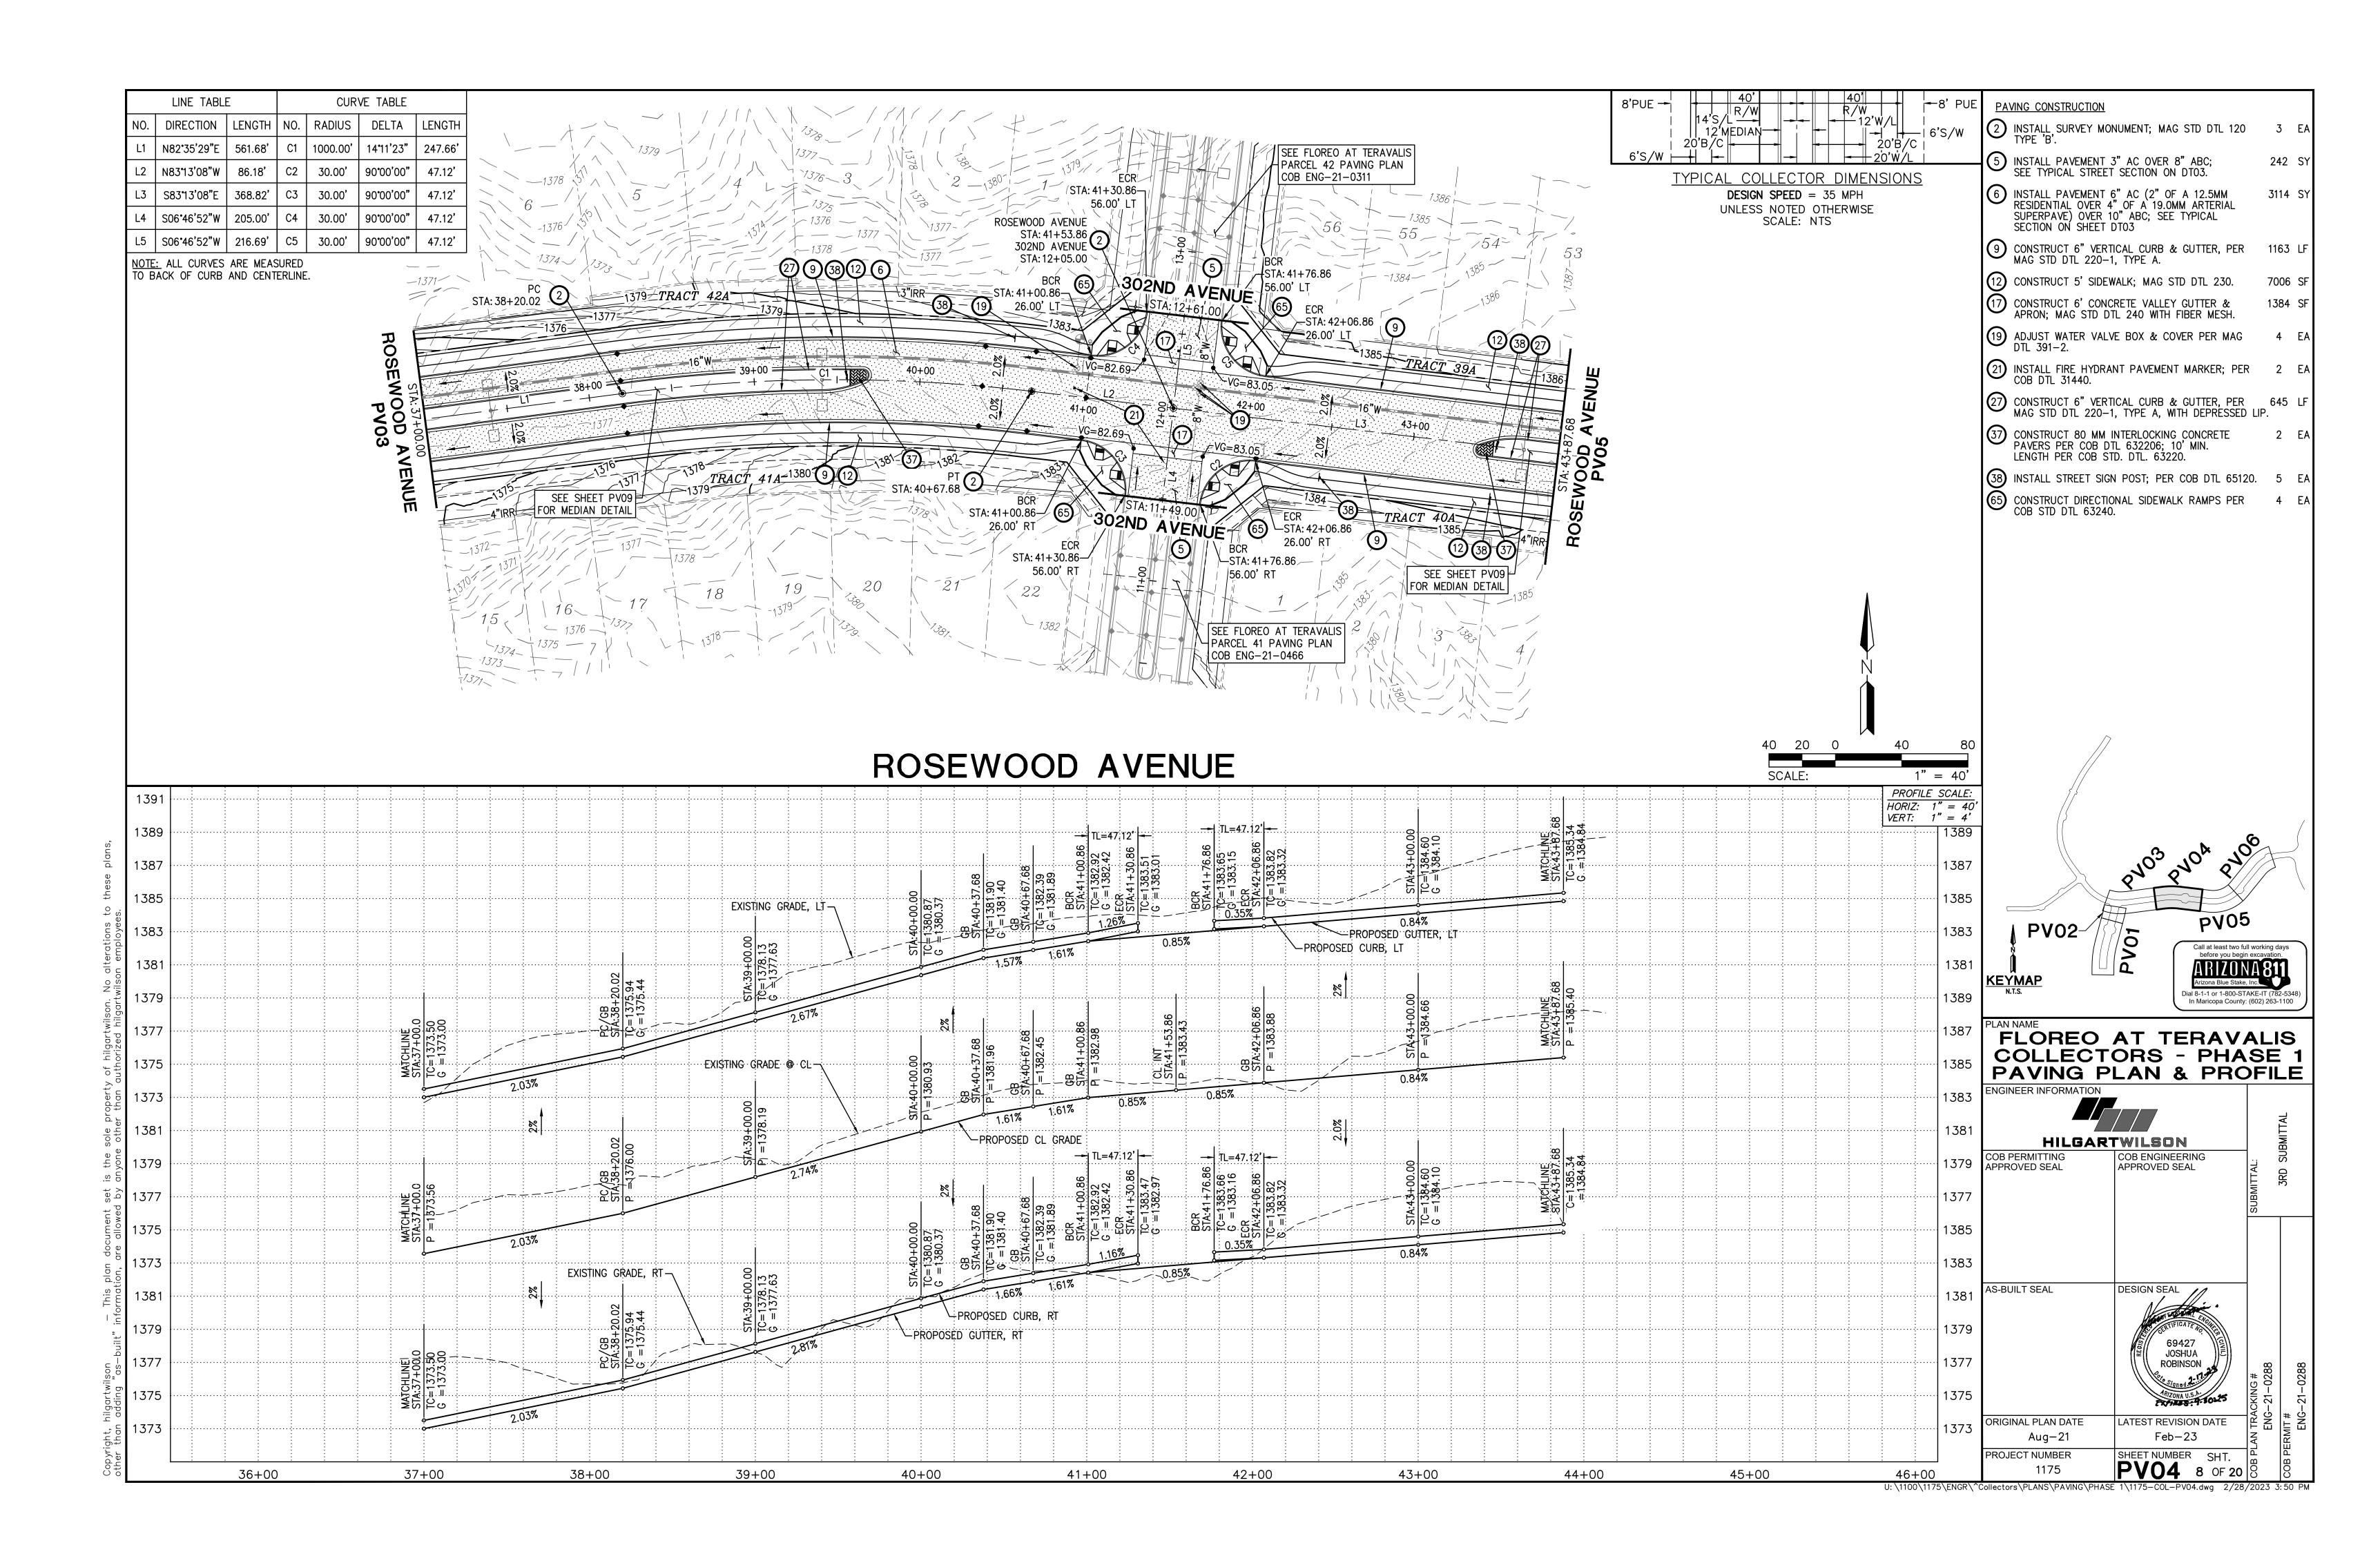


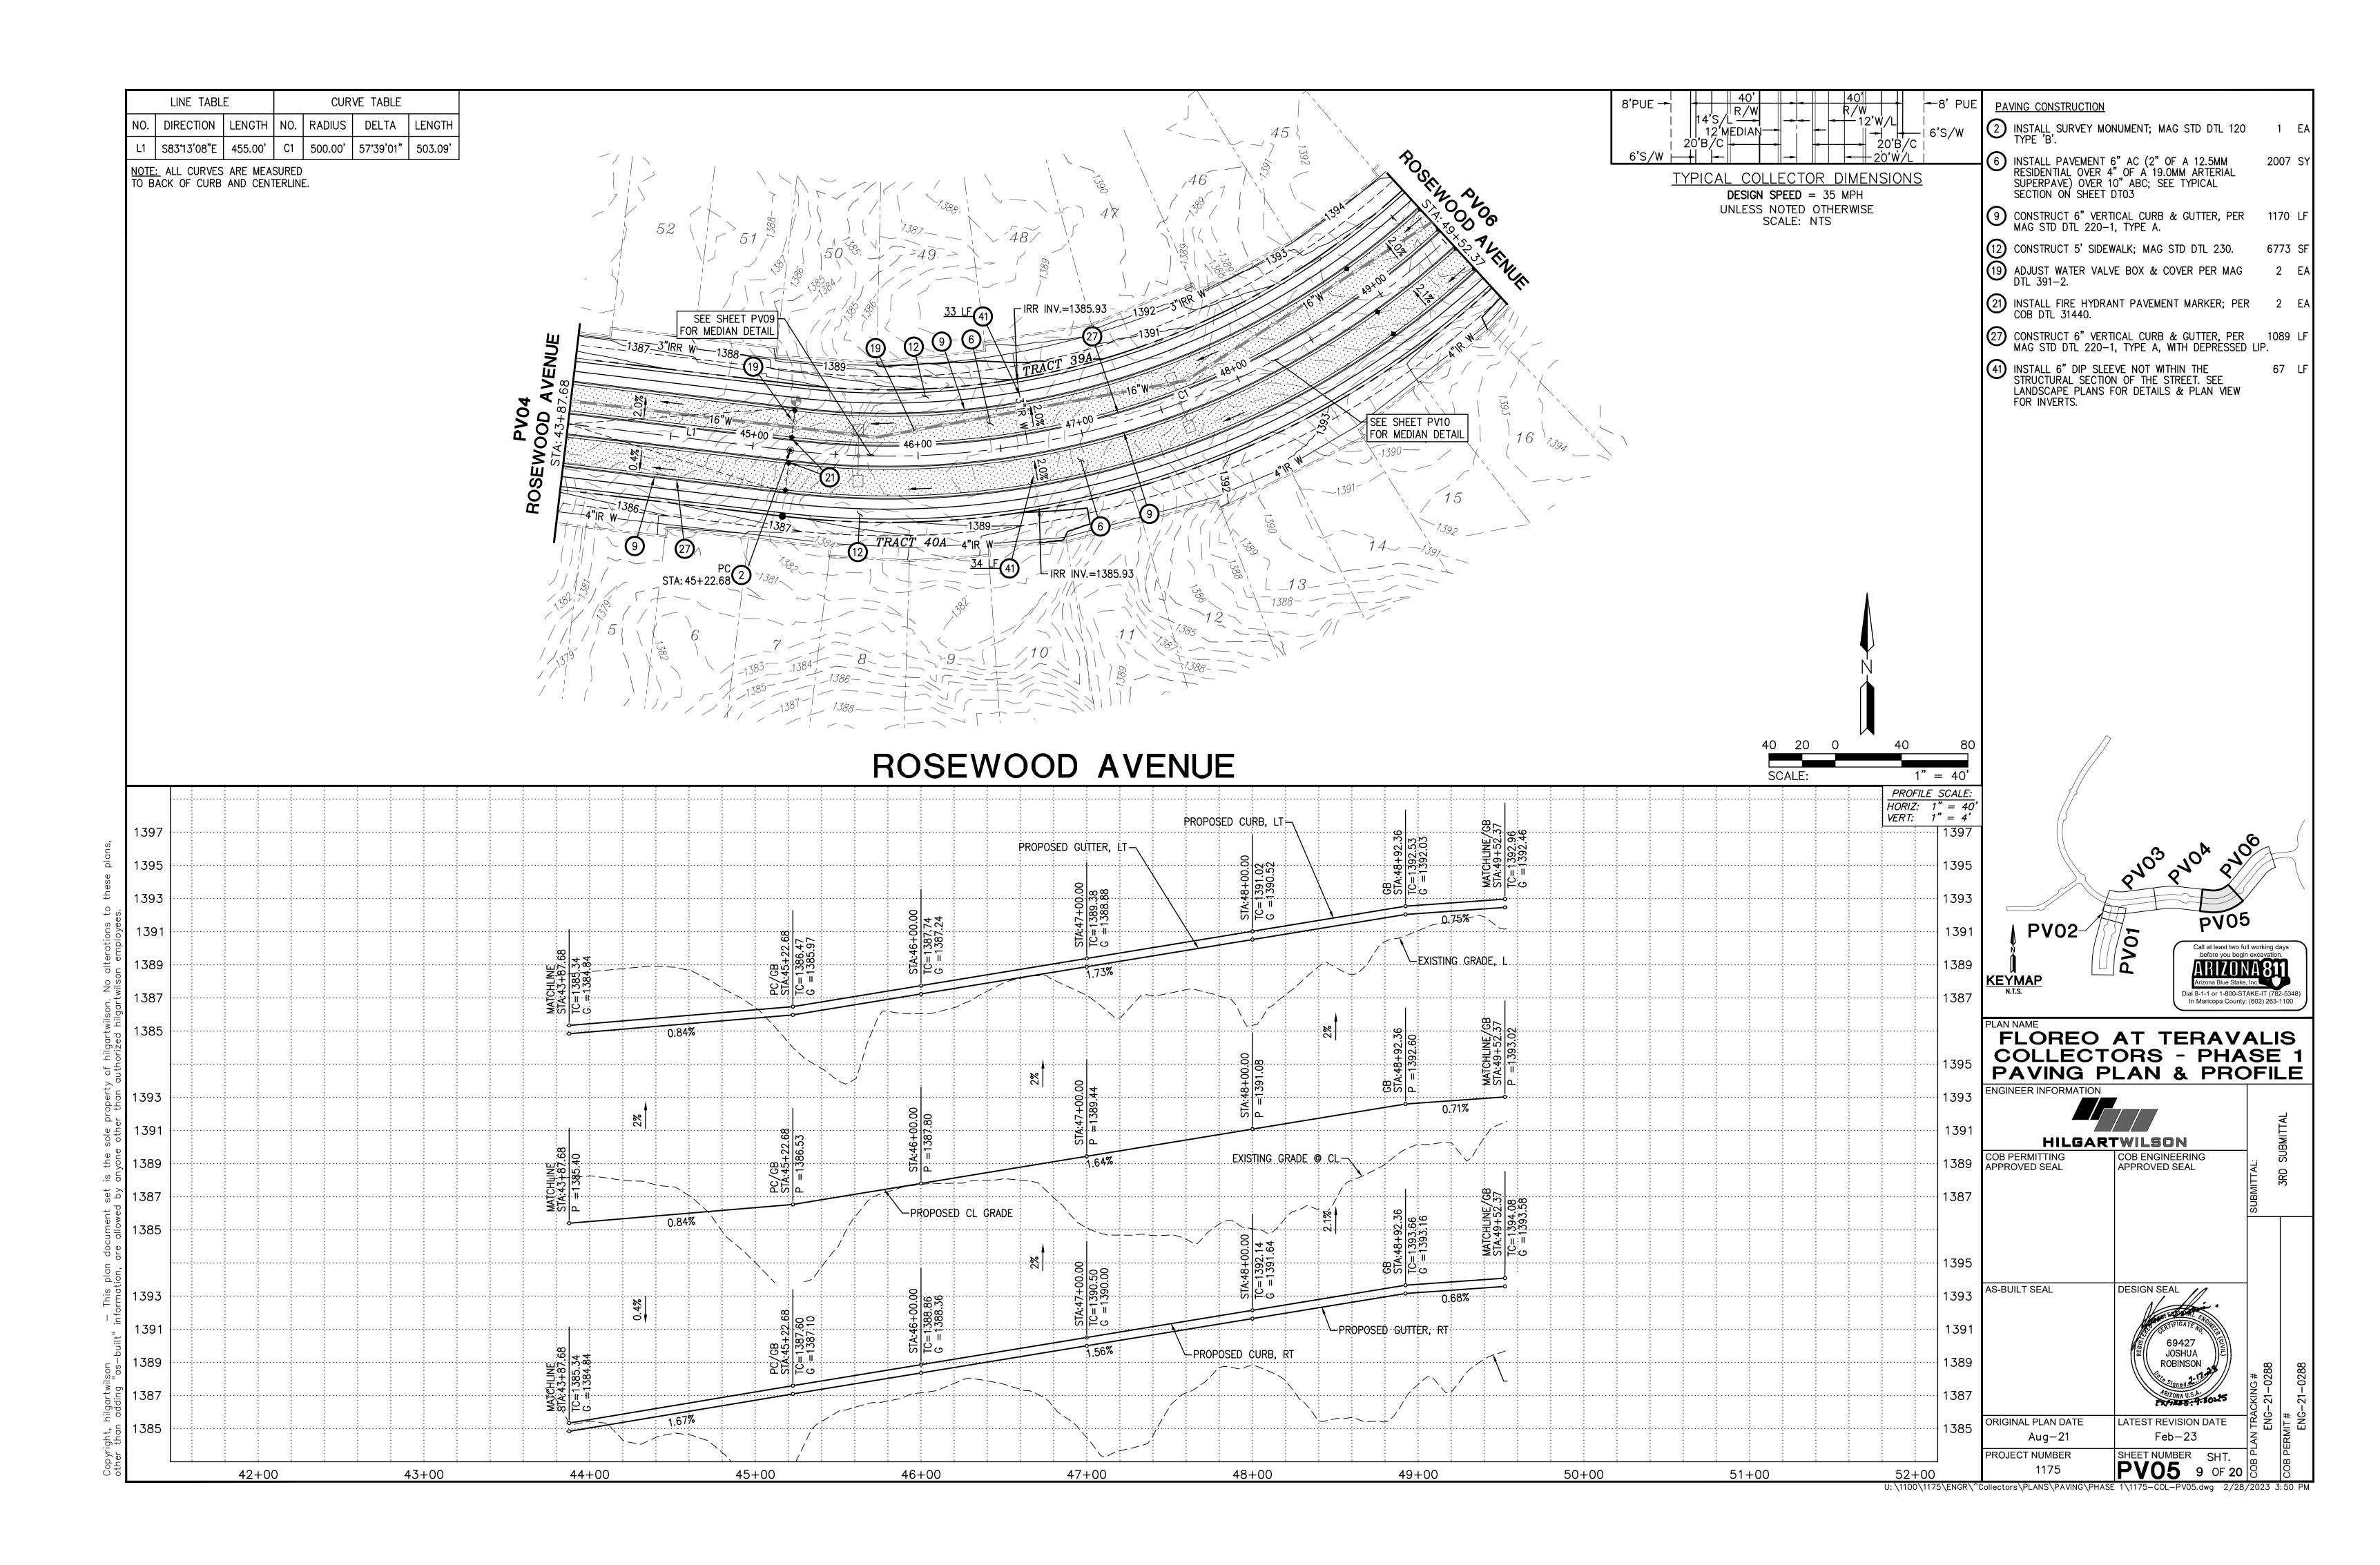


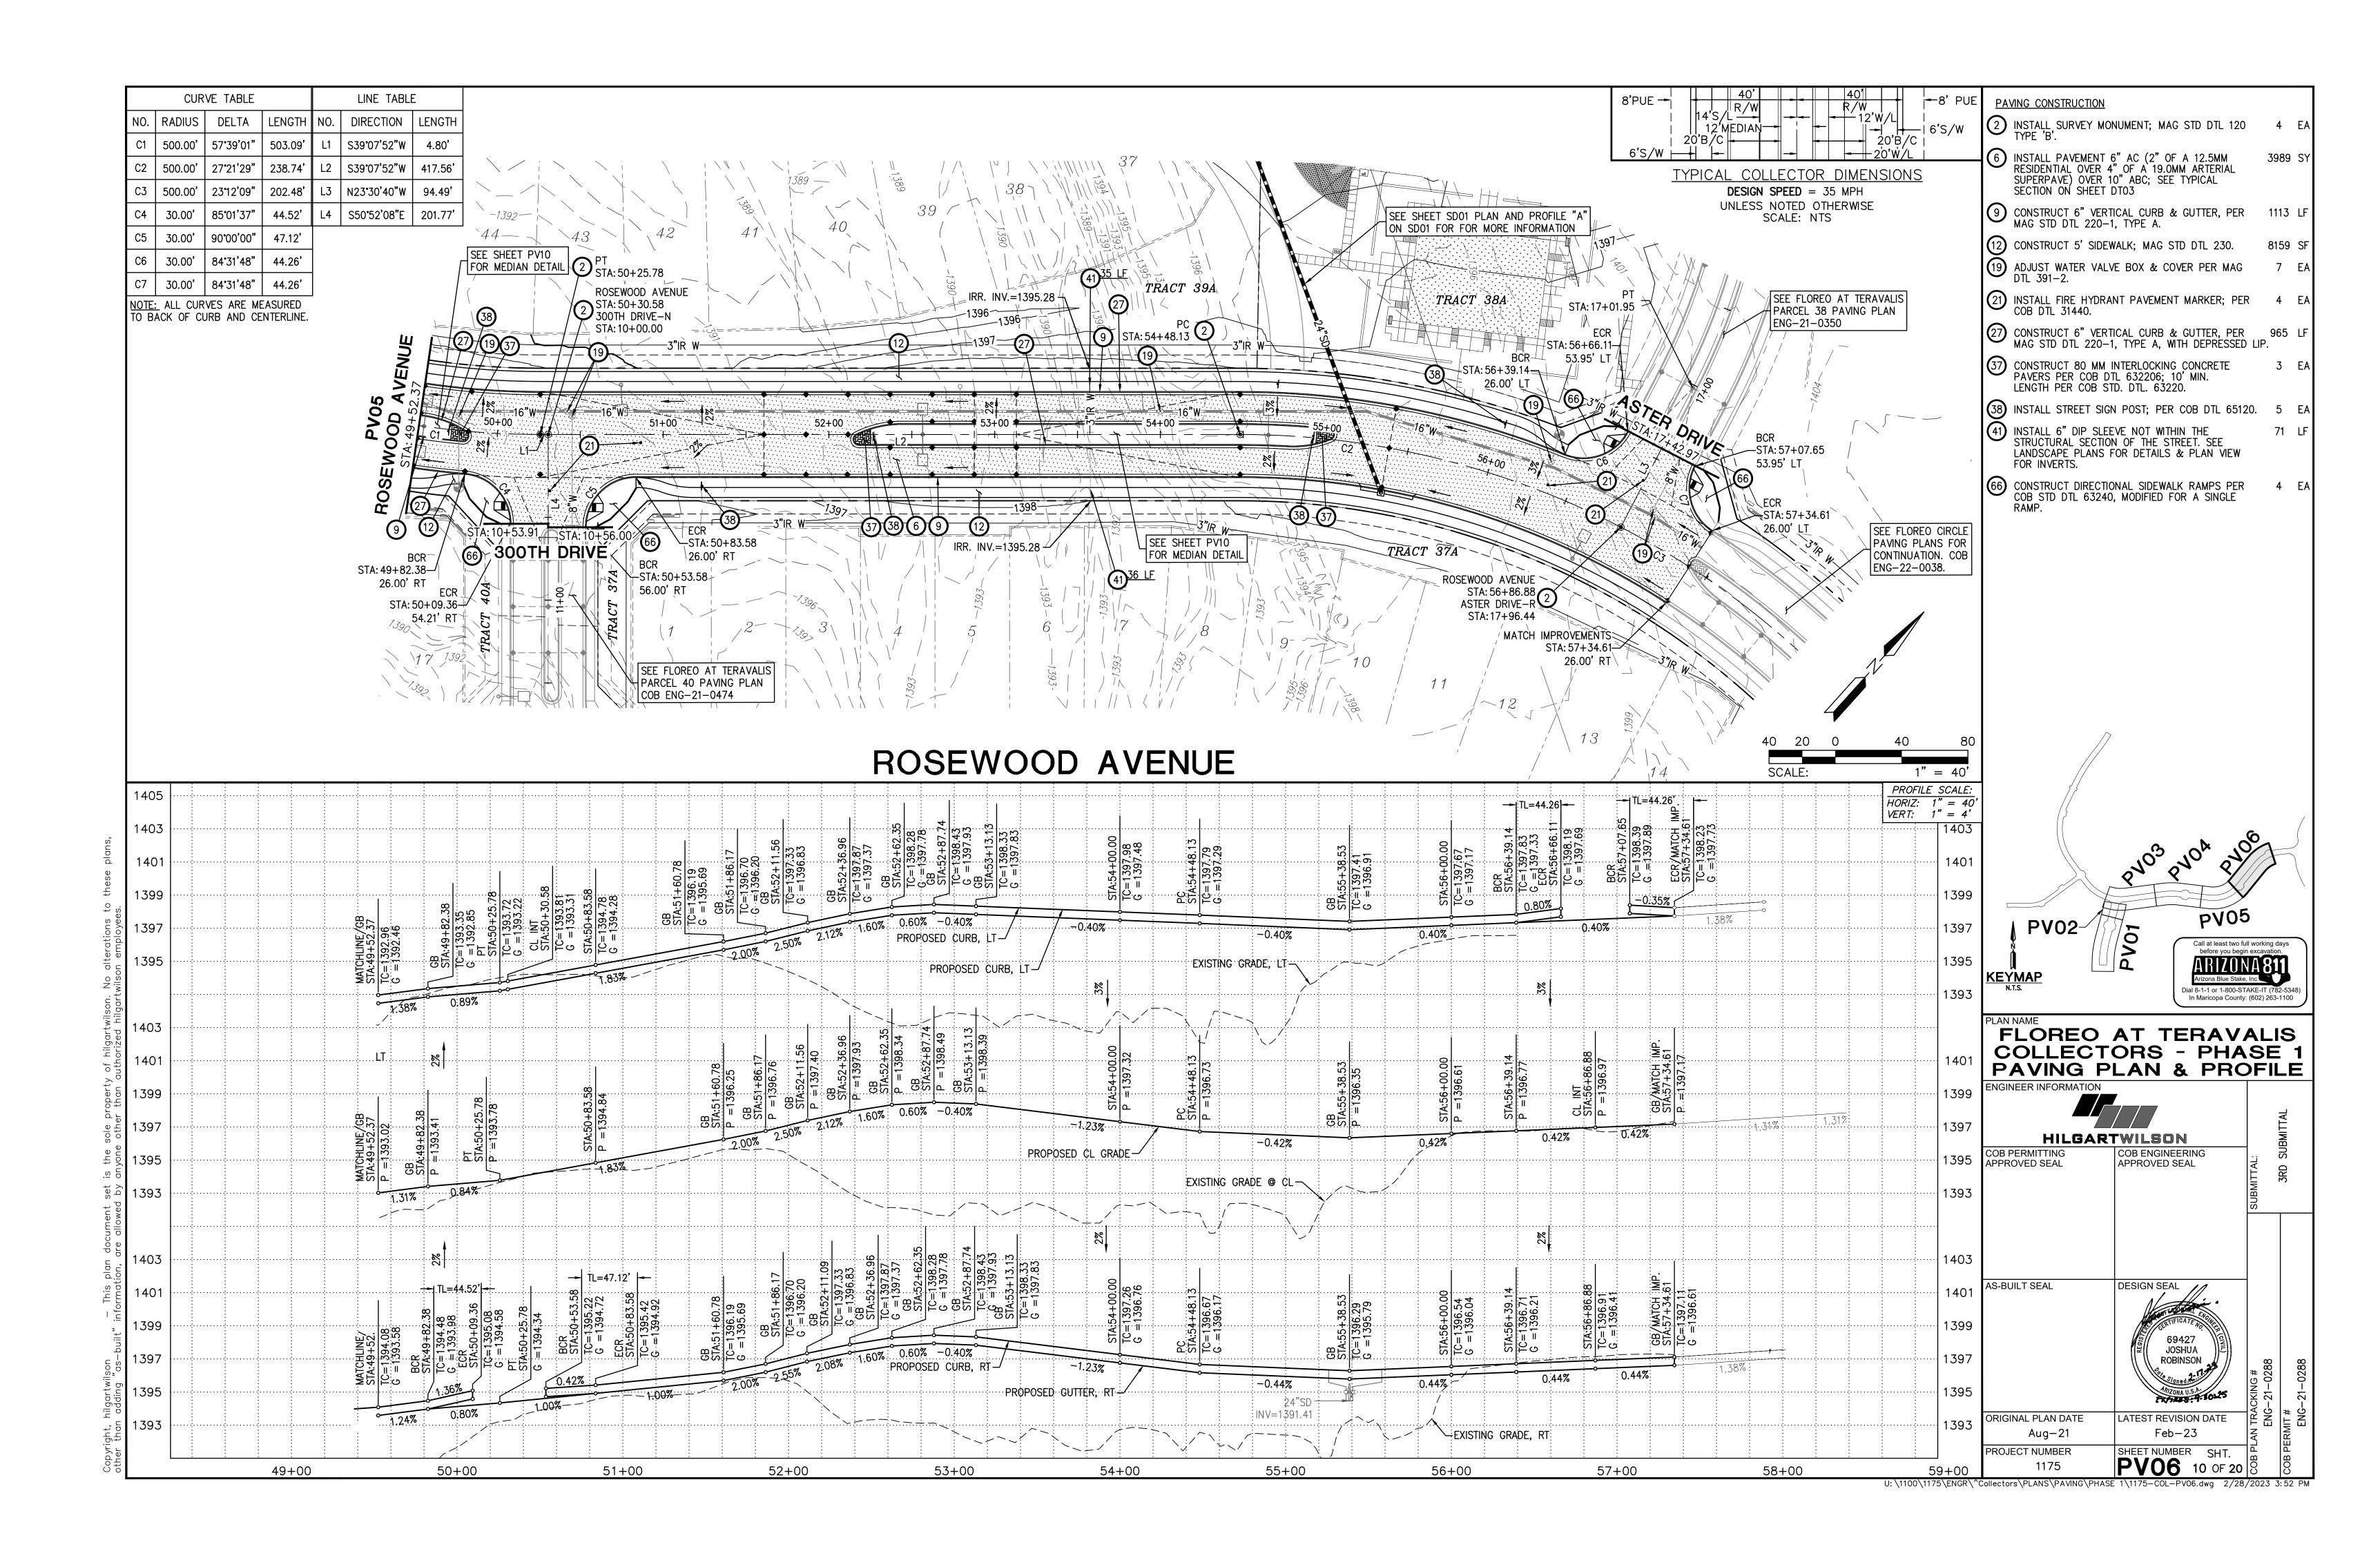


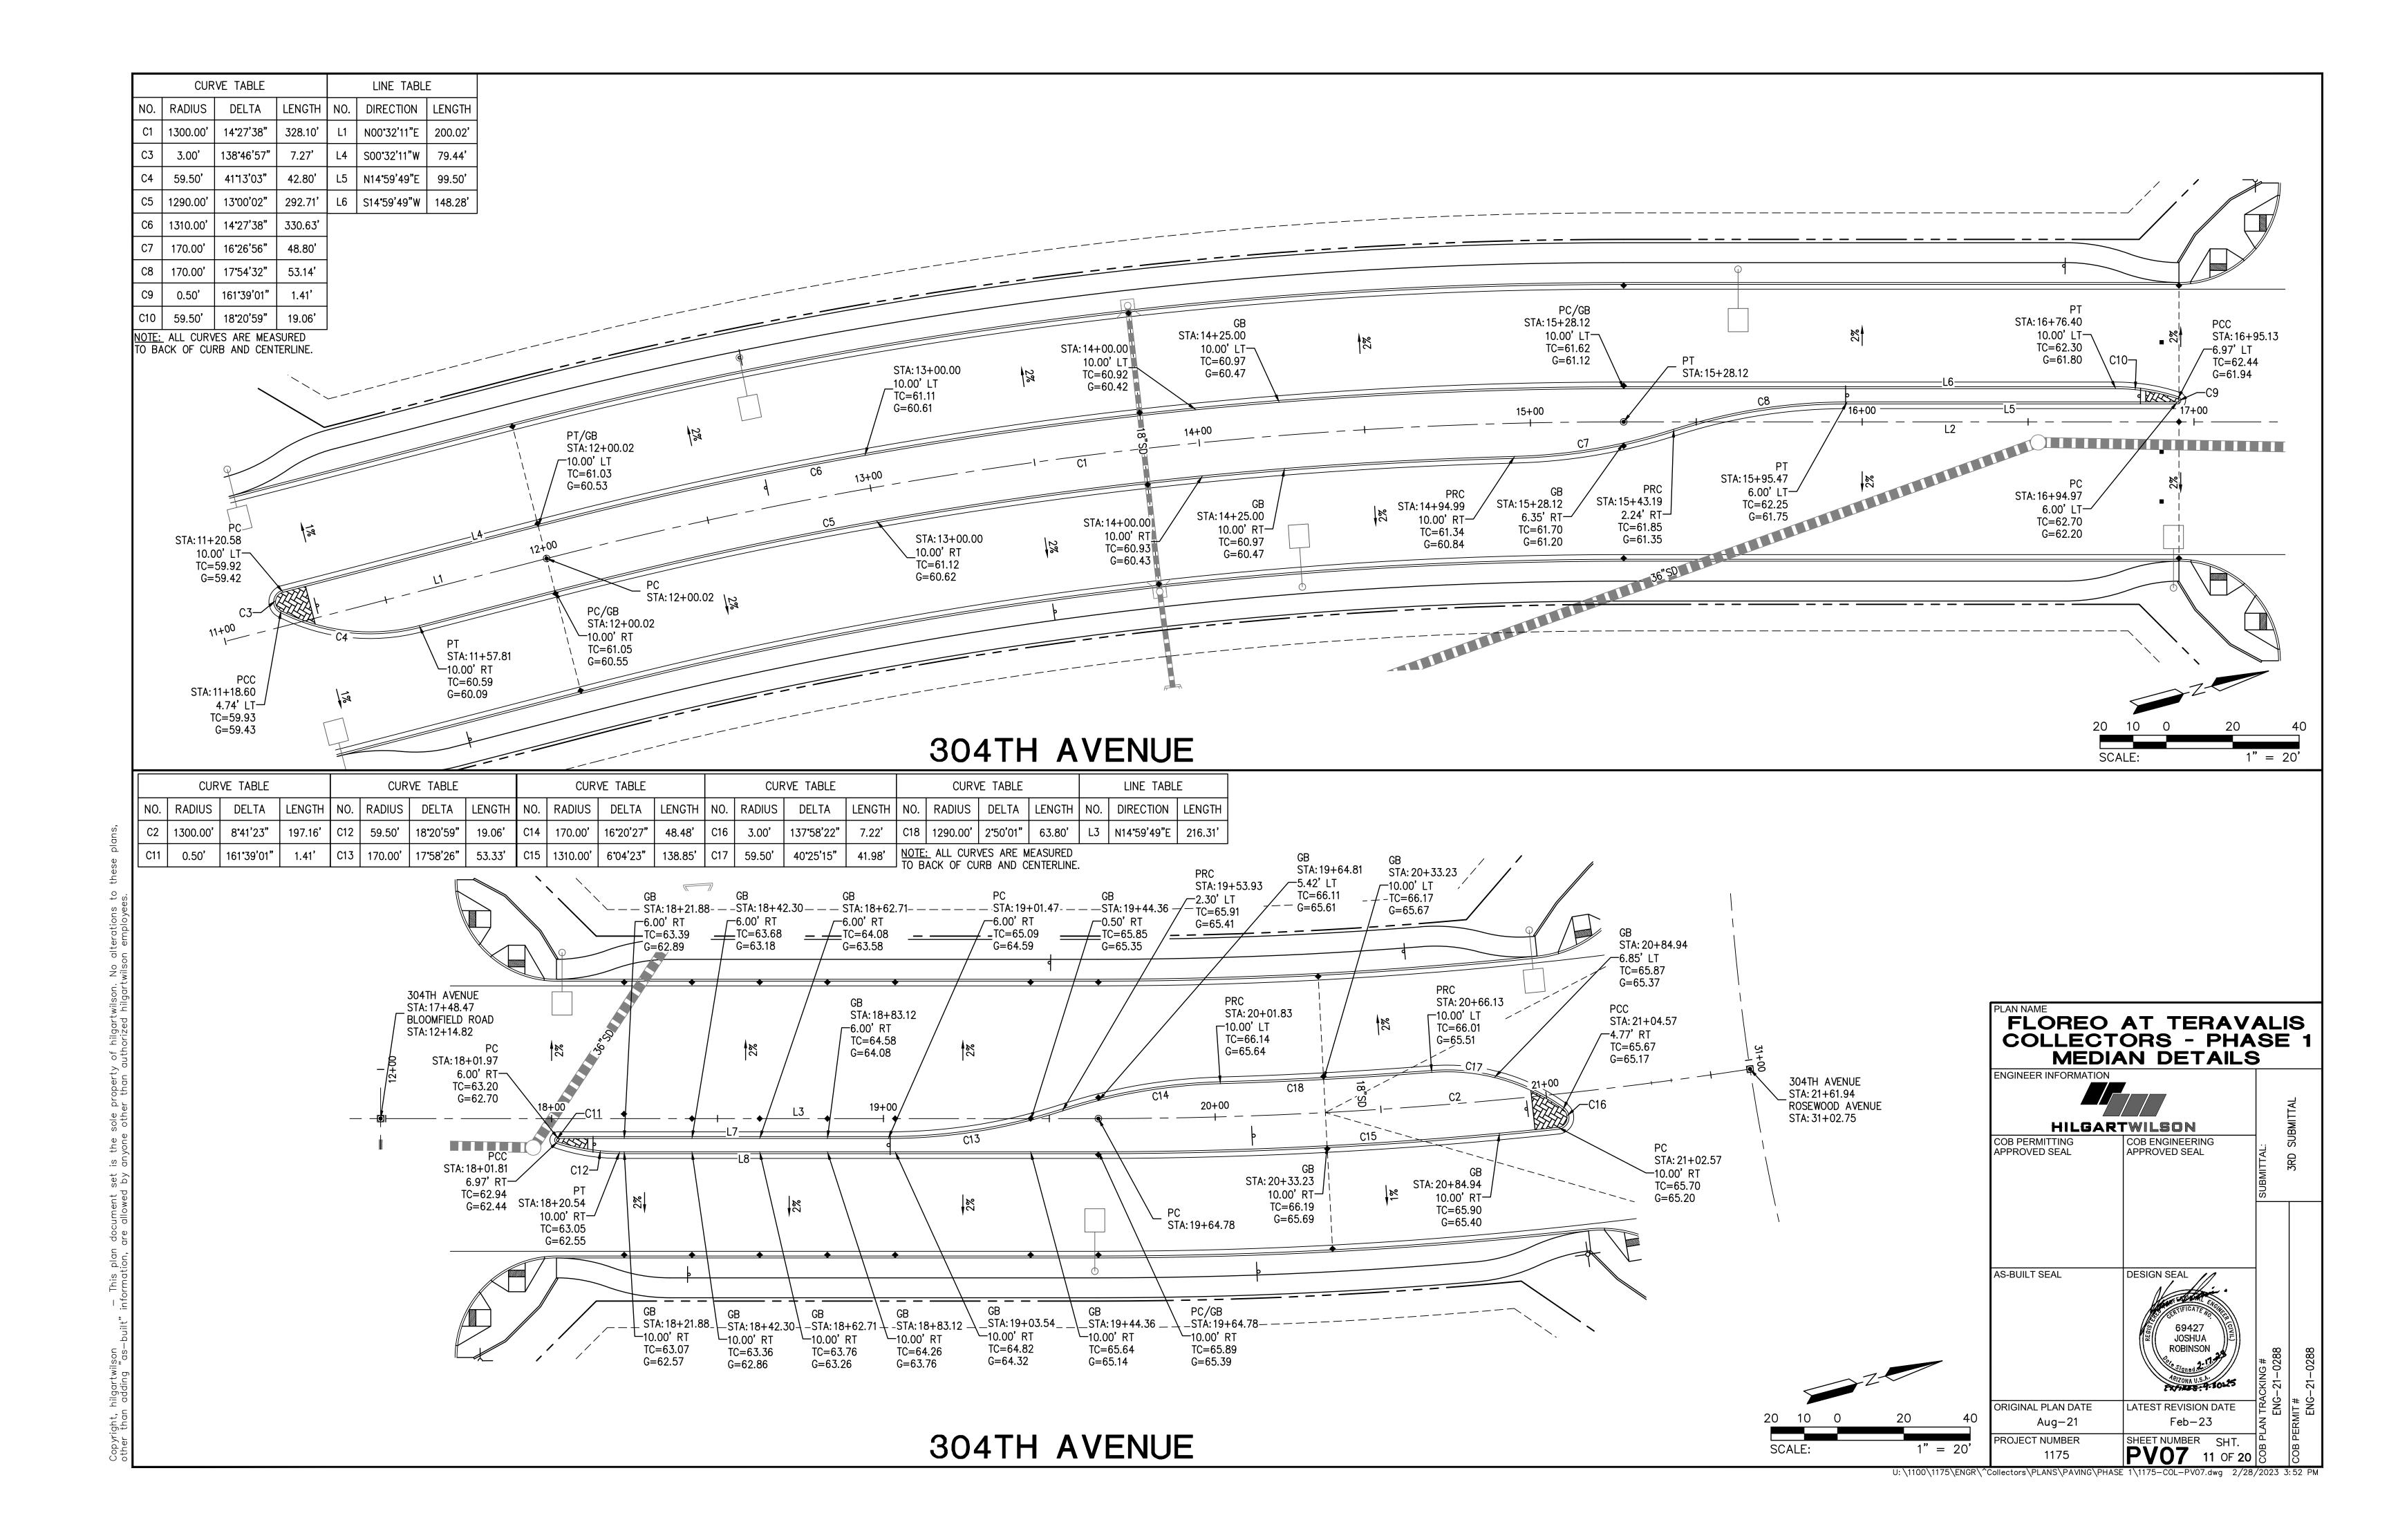


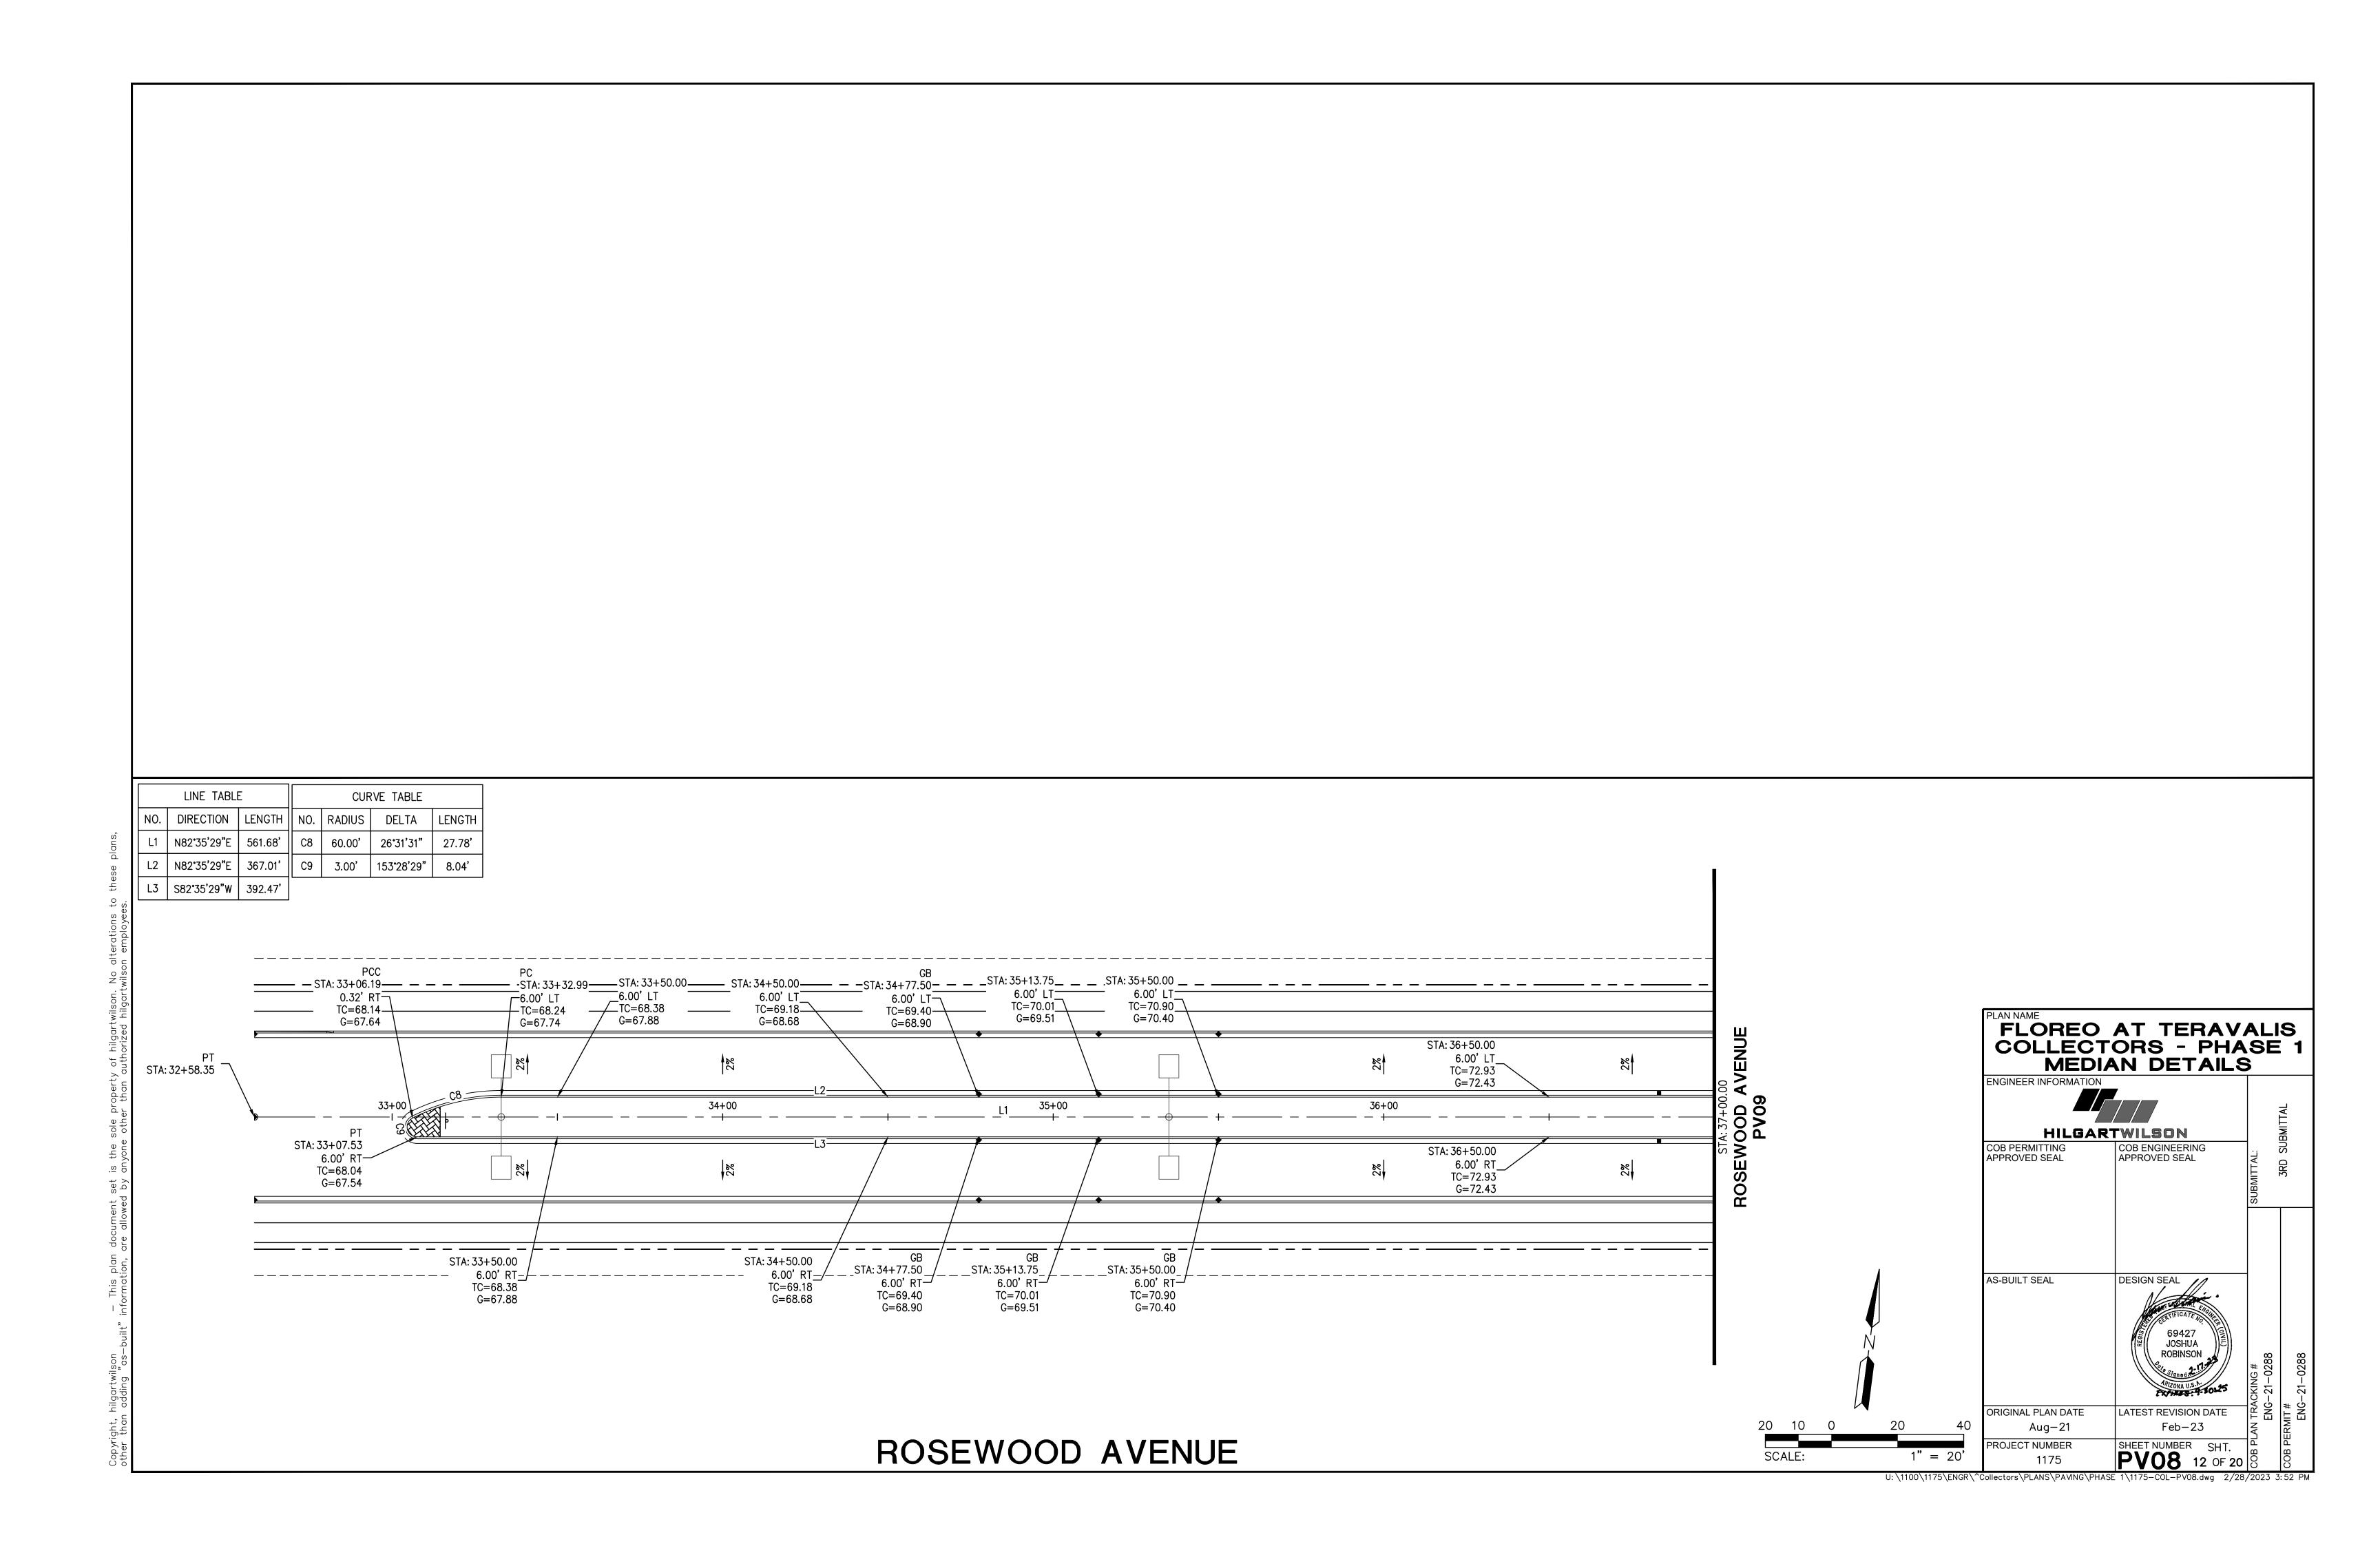

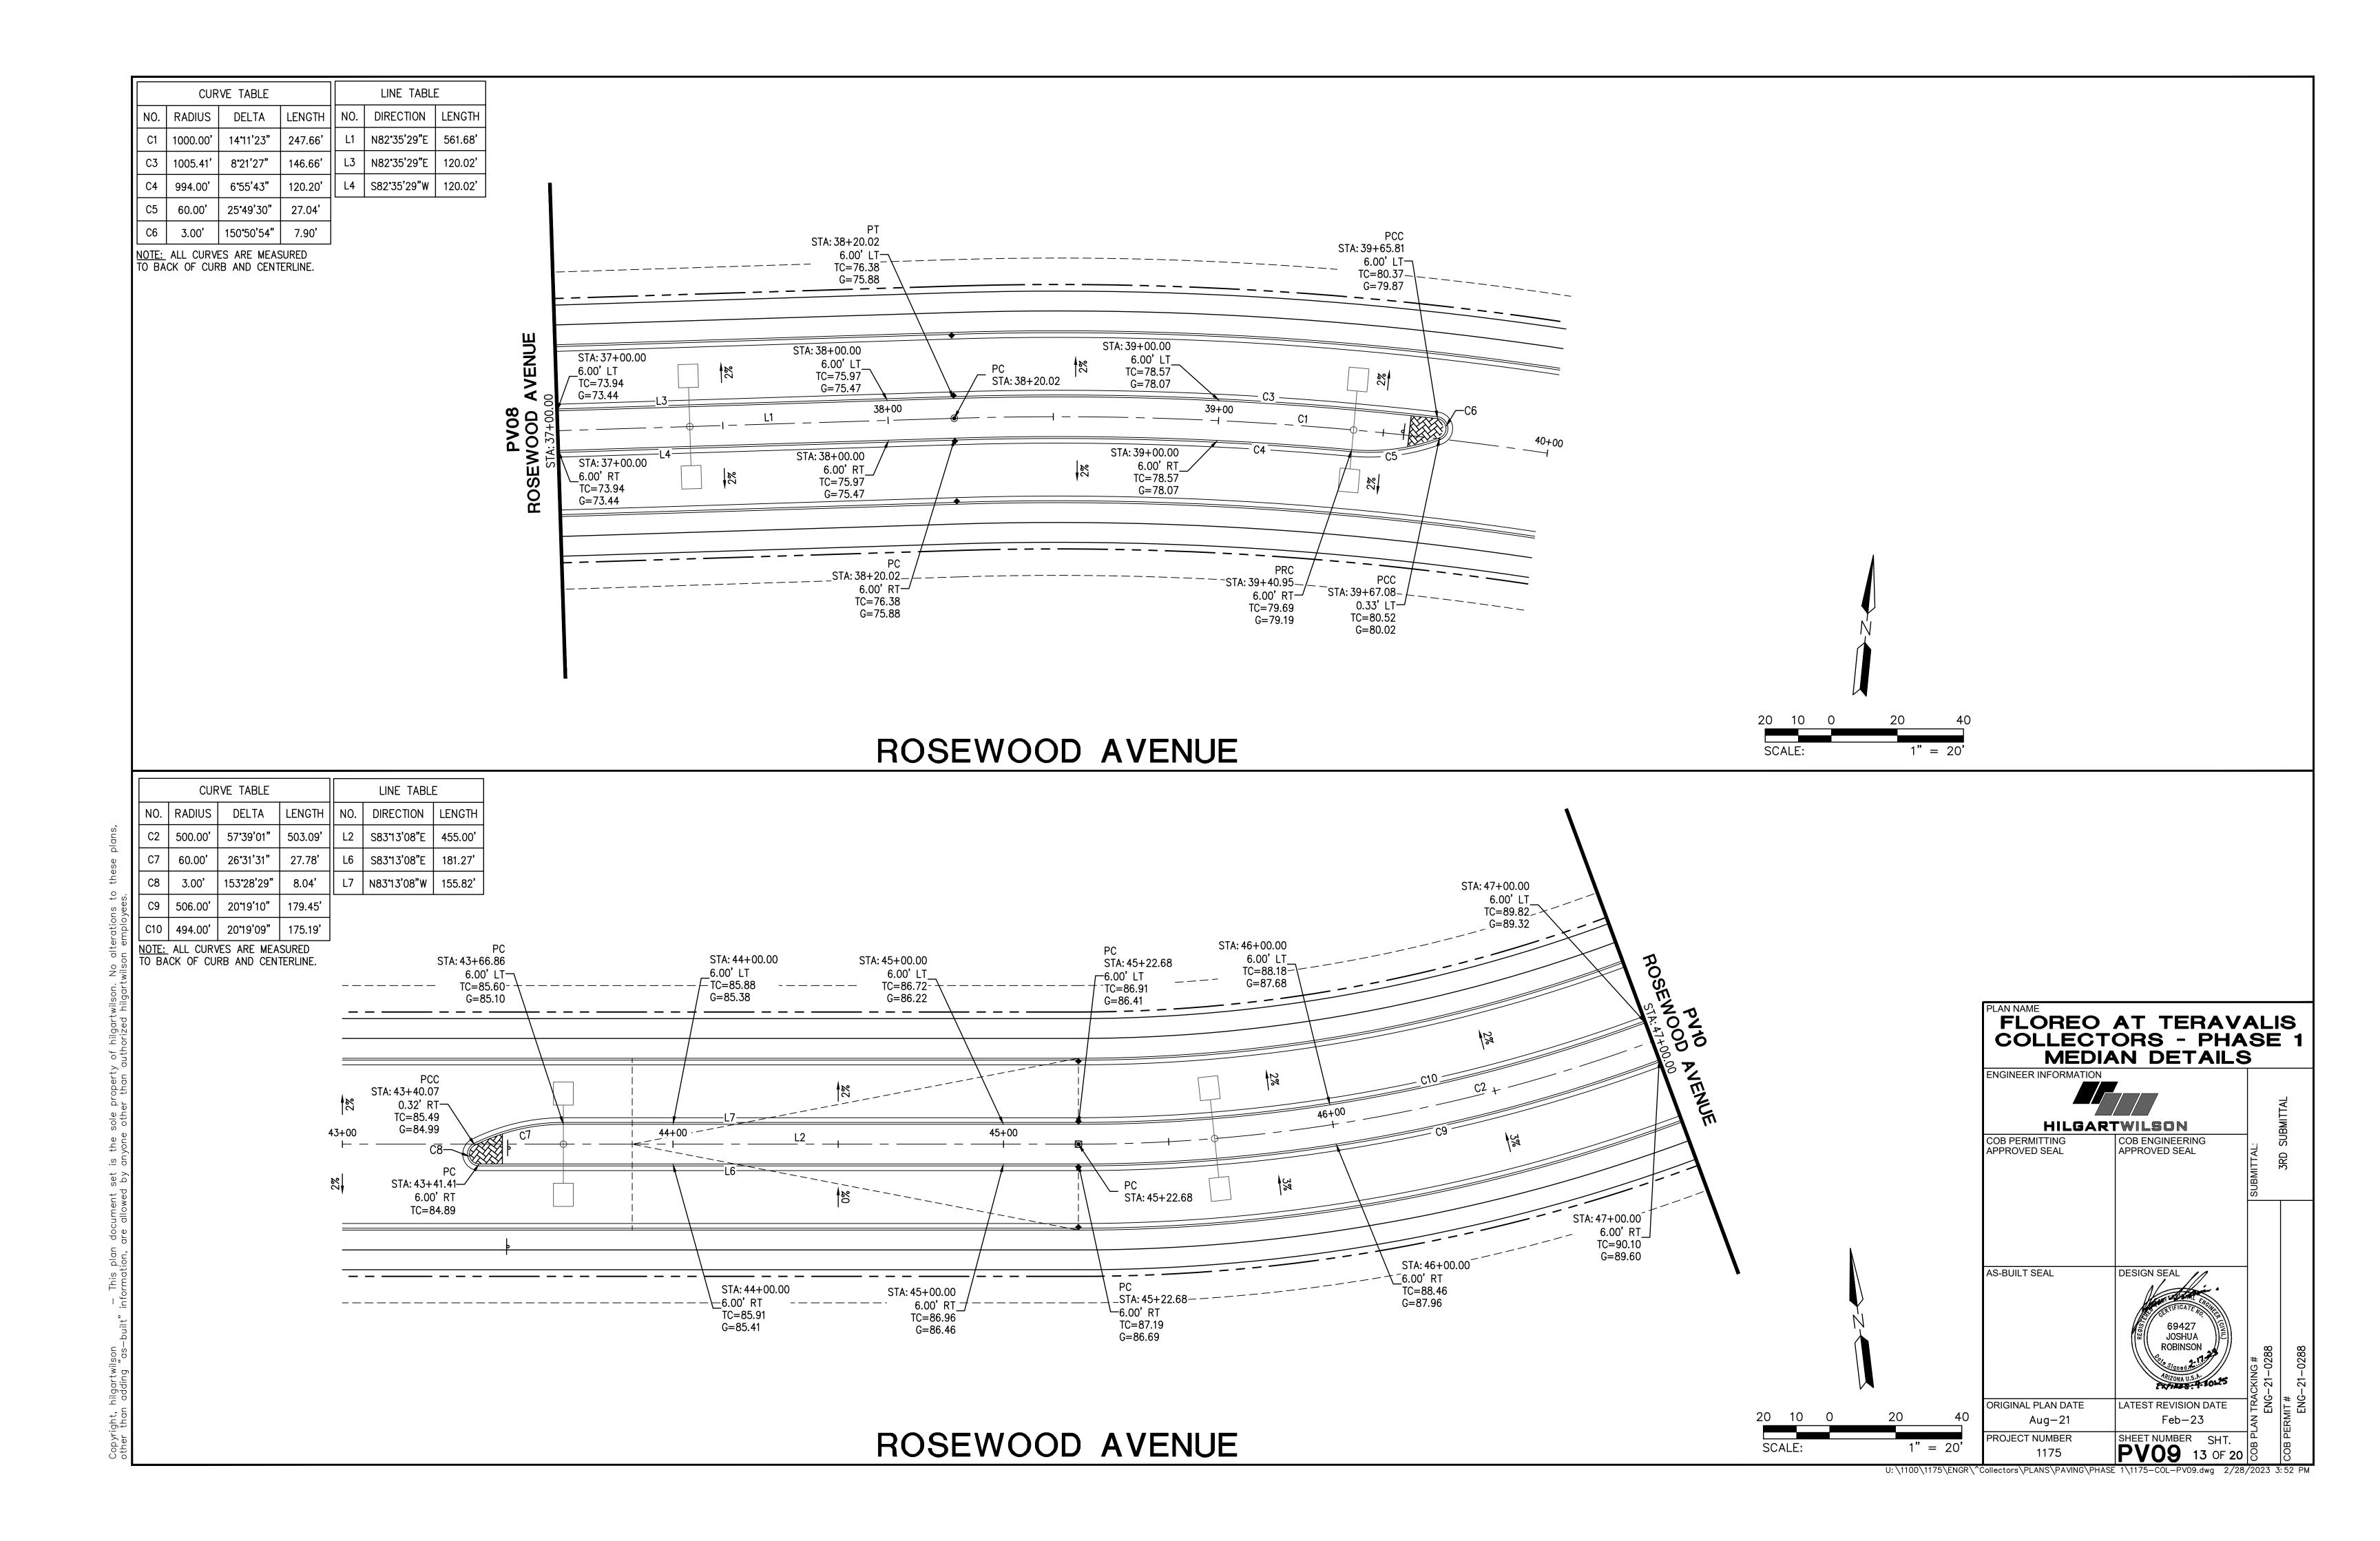

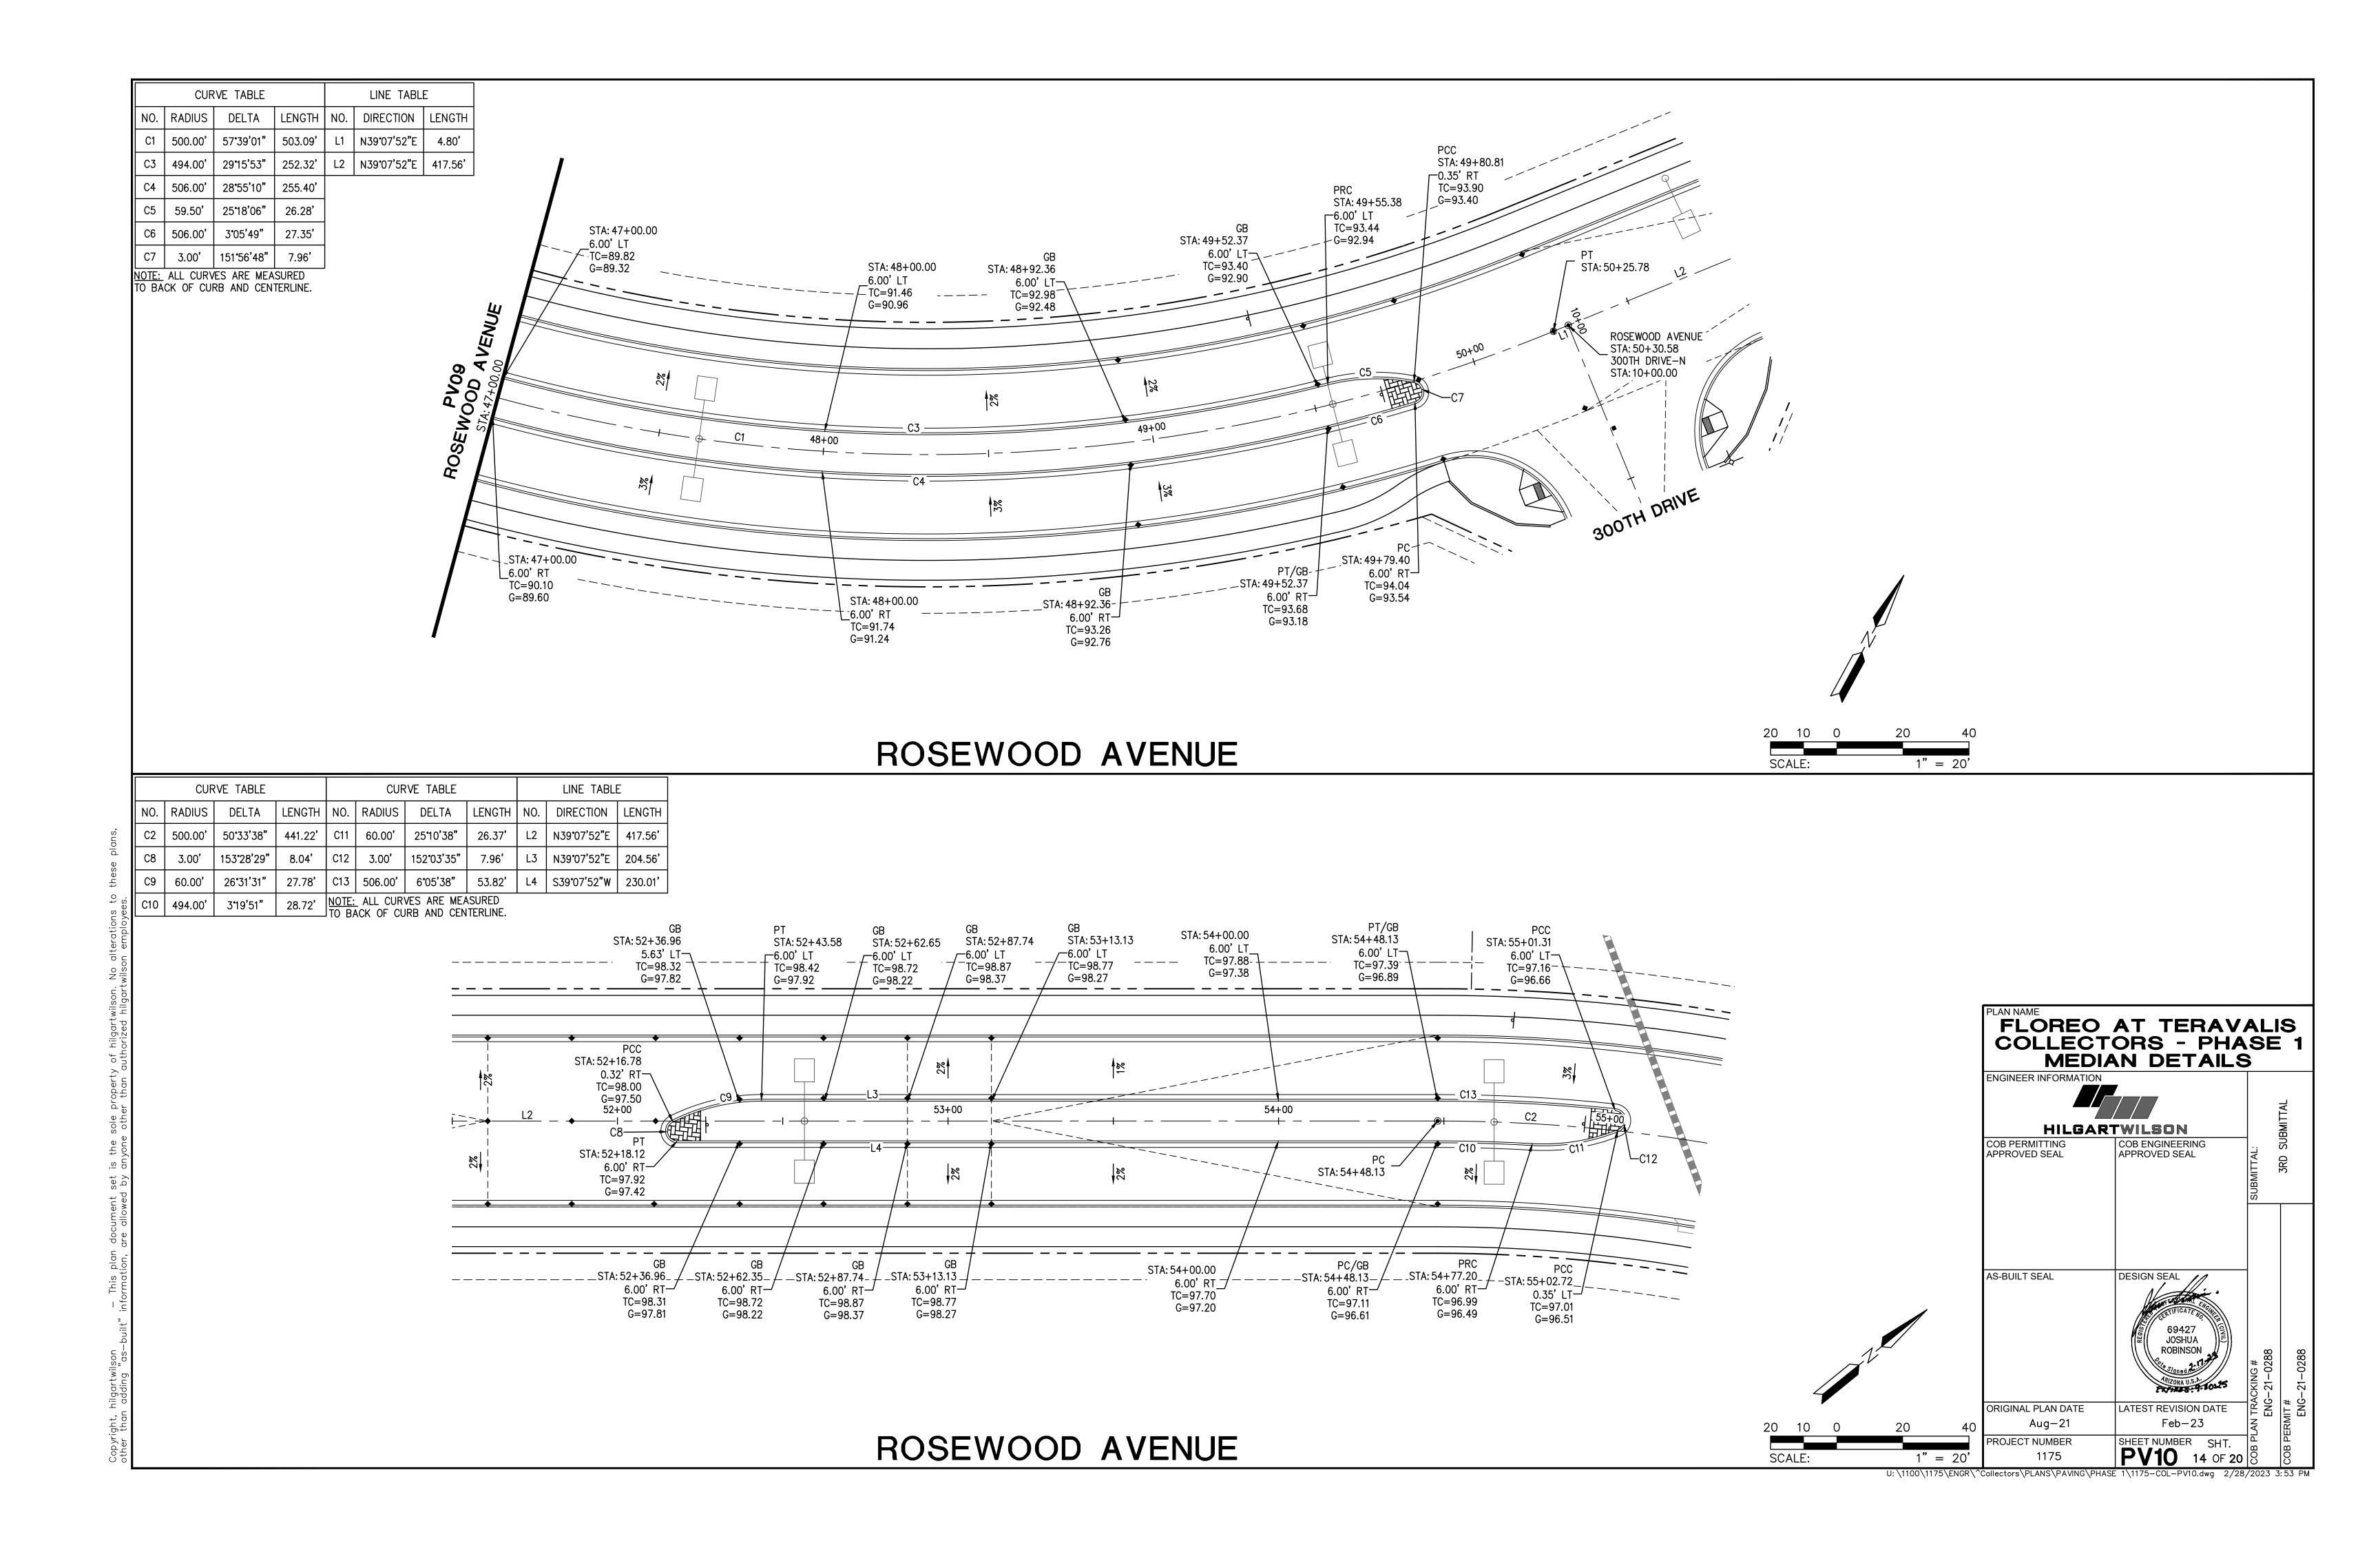

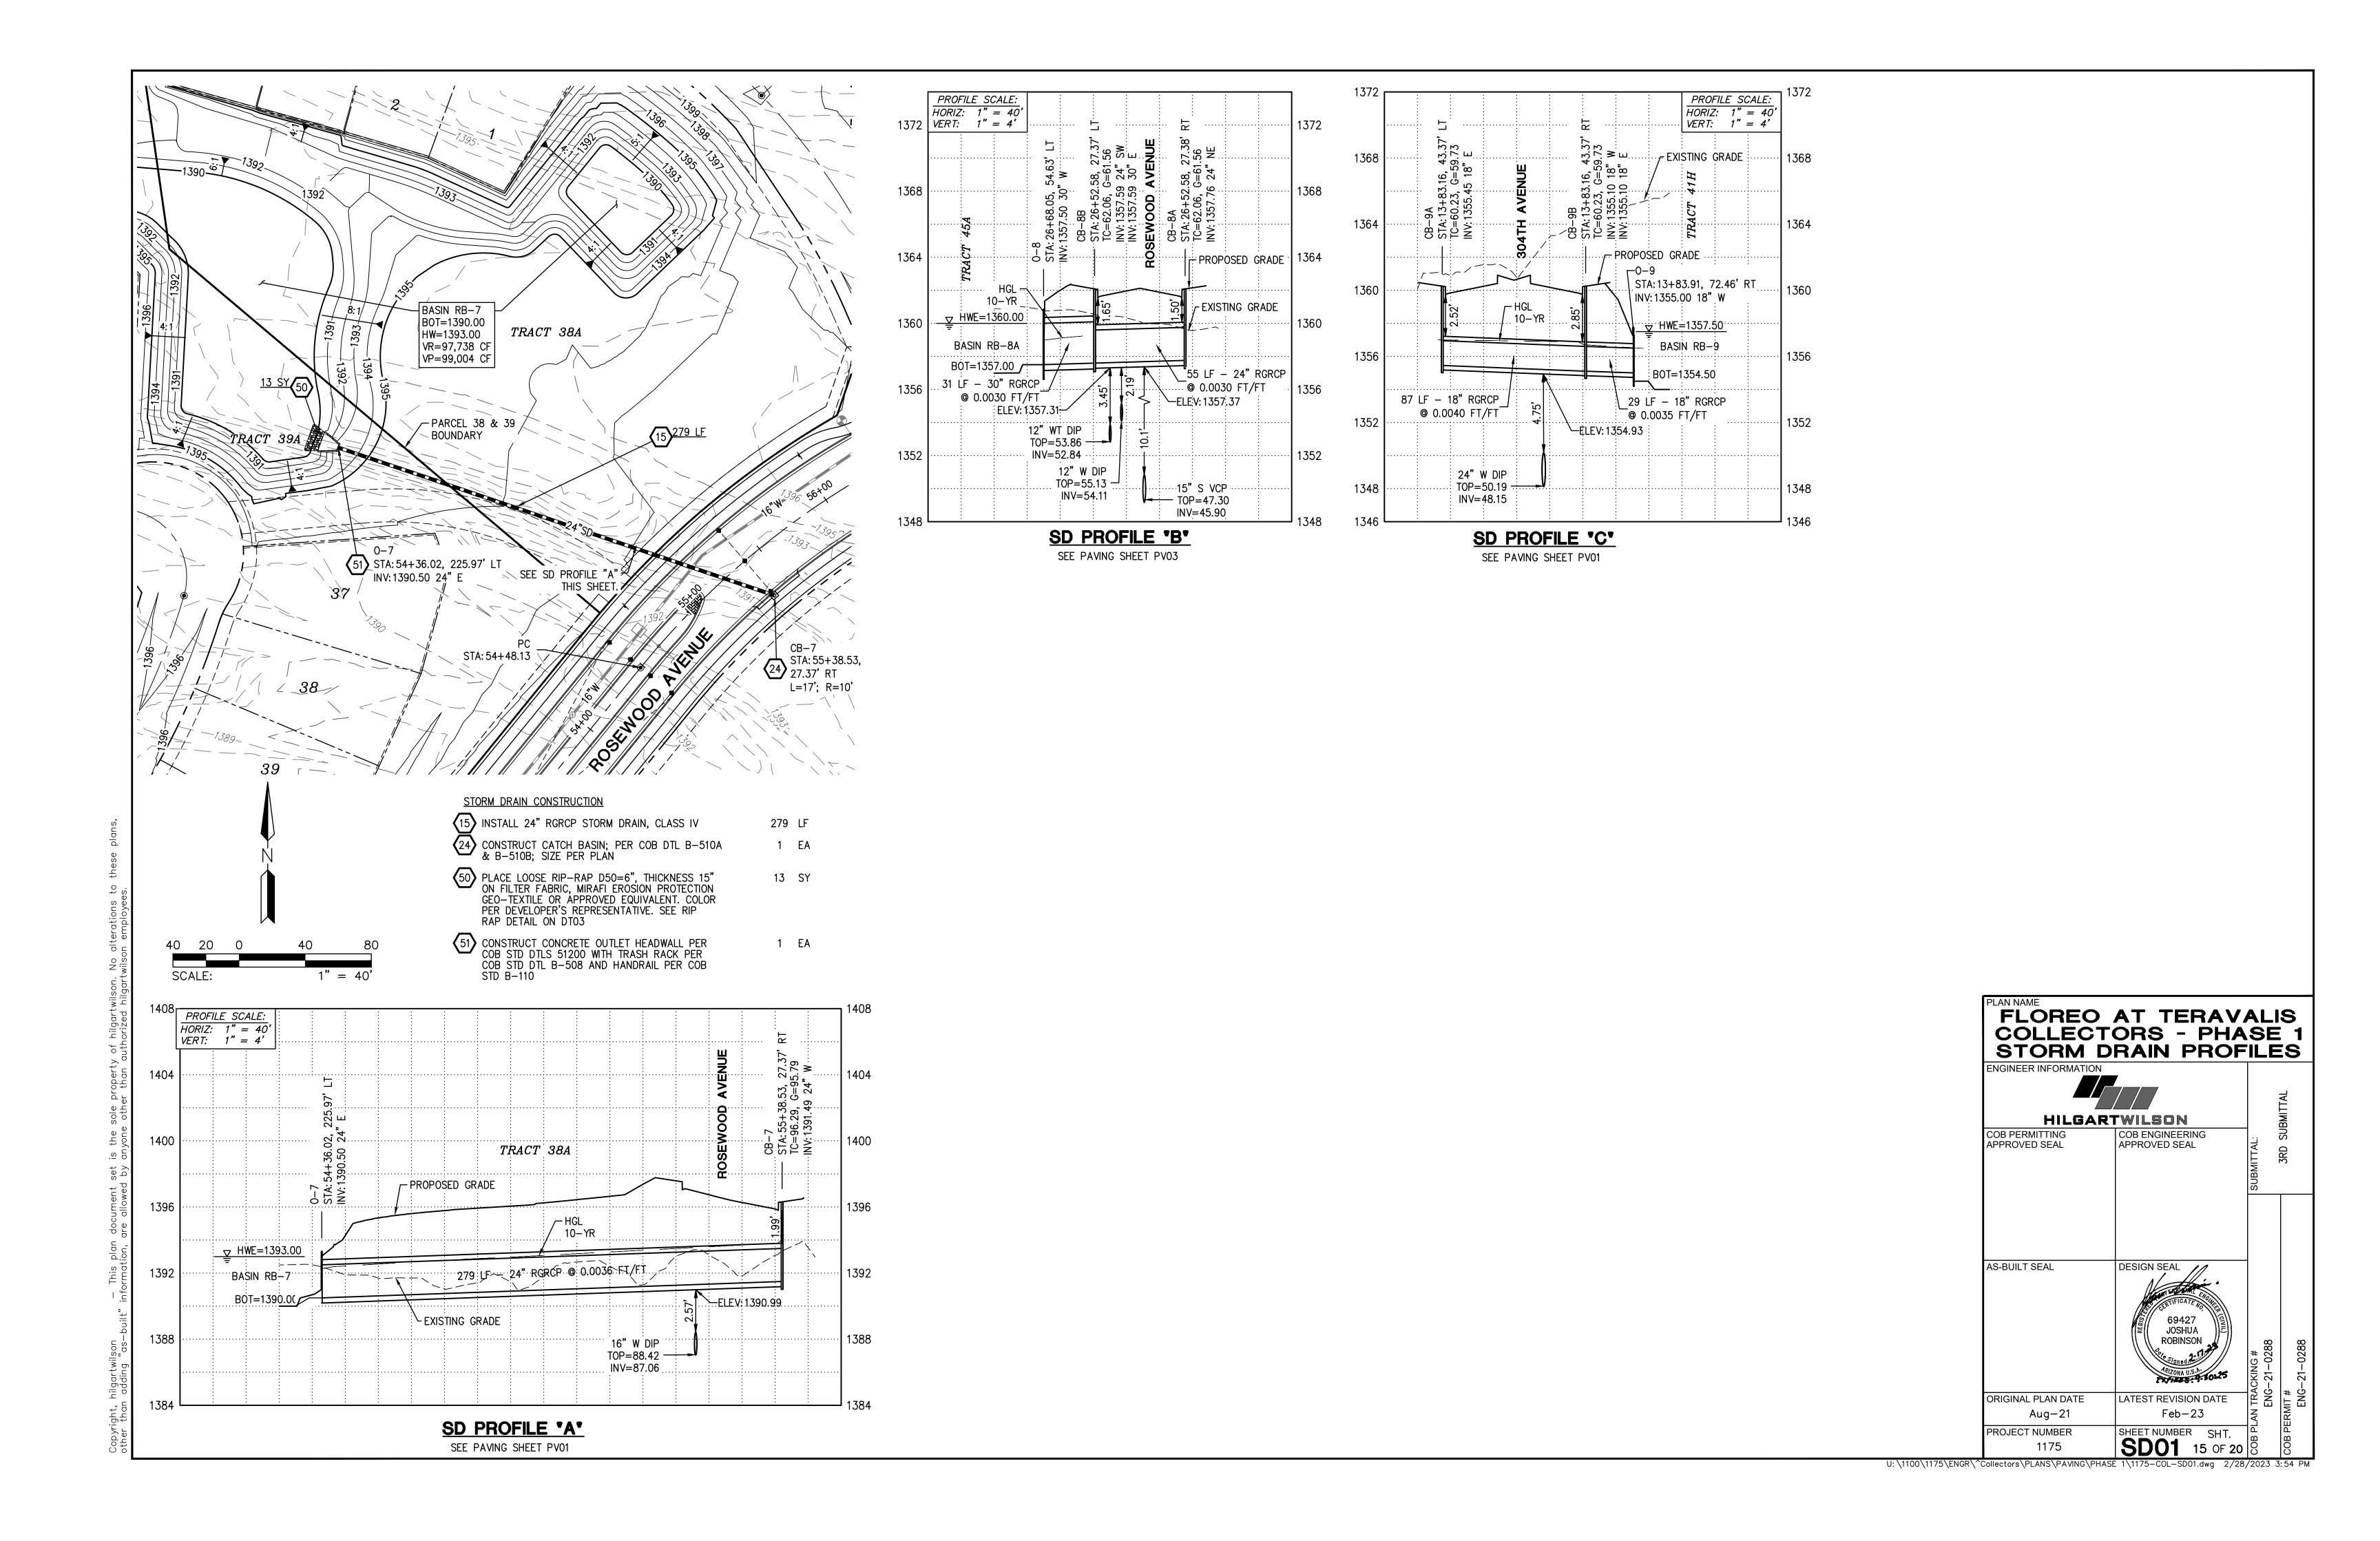

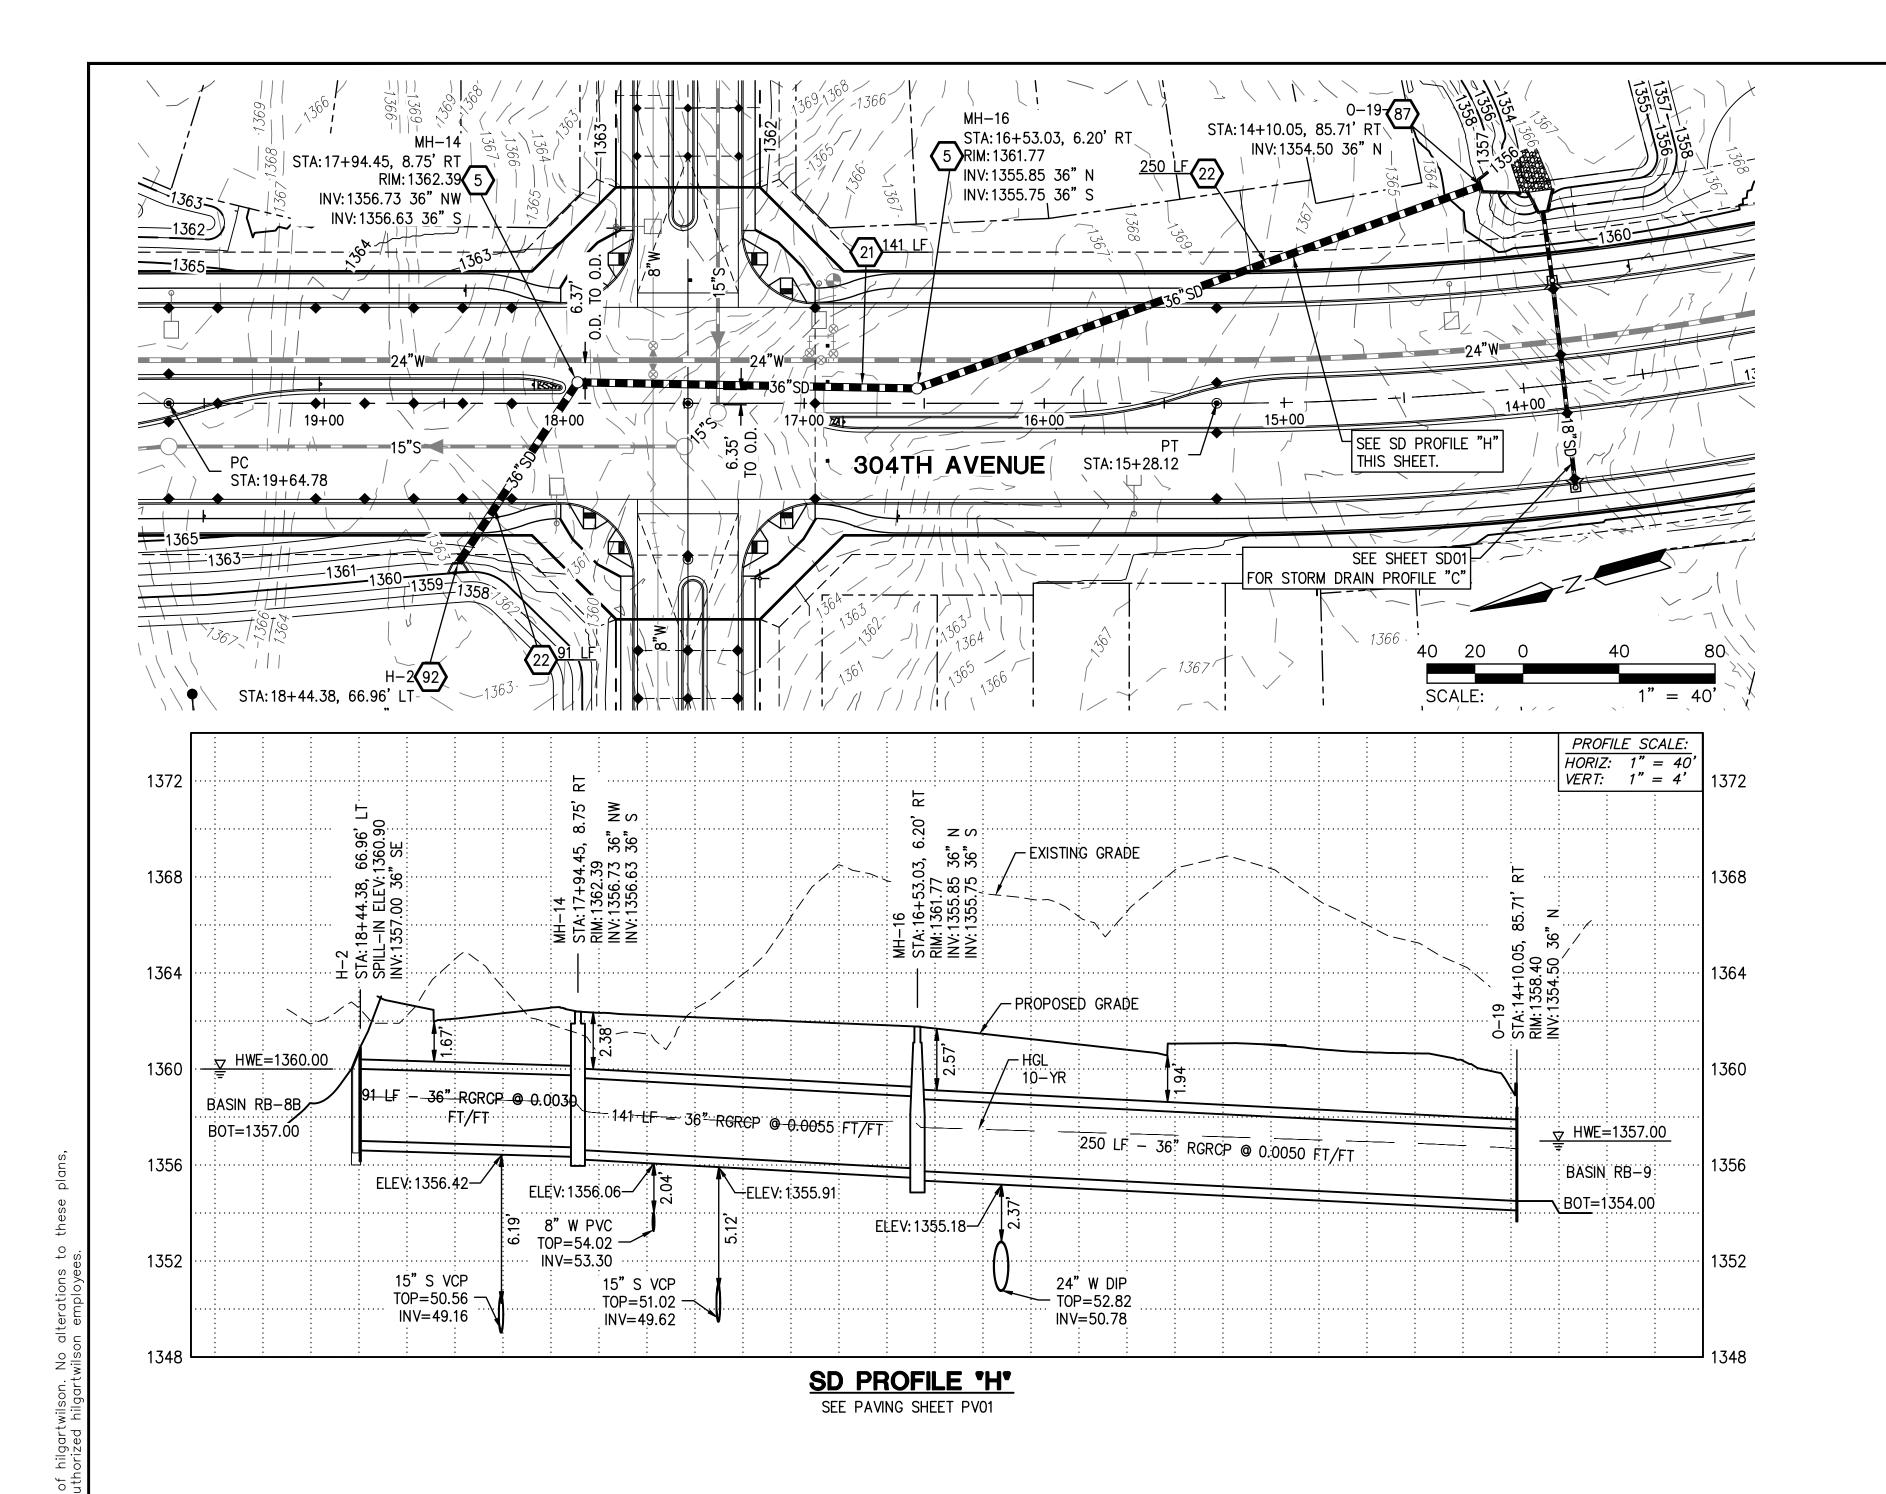

STORM DRAIN CONSTRUCTION

CONSTRUCT STORM DRAIN MANHOLE; MAG STD DTLS 424-2, 520 & 522. ADJUST RIM TO GRADE PER MAG DTL 422, COB DTL 41260.

(21) INSTALL 36" RGRCP STORM DRAIN, CLASS IV

22 INSTALL 36" RGRCP STORM DRAIN, CLASS V

CONSTRUCT CONCRETE HEADWALL MODIFIED FOR 2 PIPES PER COB STD DTL 51200 TYPE AS NOTED WITH TRASH RACK PER COB DTL B-508 AND HAND RAIL PER COB STD DTL B-110.

© CONSTRUCT DROP INLET PER MAG STD DTL 501-5, WITH TRASH RACK PER MAG STD DTL 502-2, SAFETY RAIL PER MAG STD DTL 145.



2 EA


141 LF


336 LF

1 EA

1 EA

	COLLECT	AT TERAVA ORS - PHA RAIN PROF	SE 1
<u>-</u>	ENGINEER INFORMATION	COB ENGINEERING APPROVED SEAL	SUBMITTAL: 3RD SUBMITTAL
	AS-BUILT SEAL	DESIGN SEAL 69427 JOSHUA ROBINSON ROBINSON	NG # -0288 -0288
	ORIGINAL PLAN DATE Aug—21 PROJECT NUMBER	LATEST REVISION DATE Feb-23 SHEET NUMBER SHT.	COB PLAN TRACKING ENG-21-0 COB PERMIT # ENG-21-0
I.\ 1100\ 1175\ ENICD\ ^0.	1175	SD02 16 OF 20	

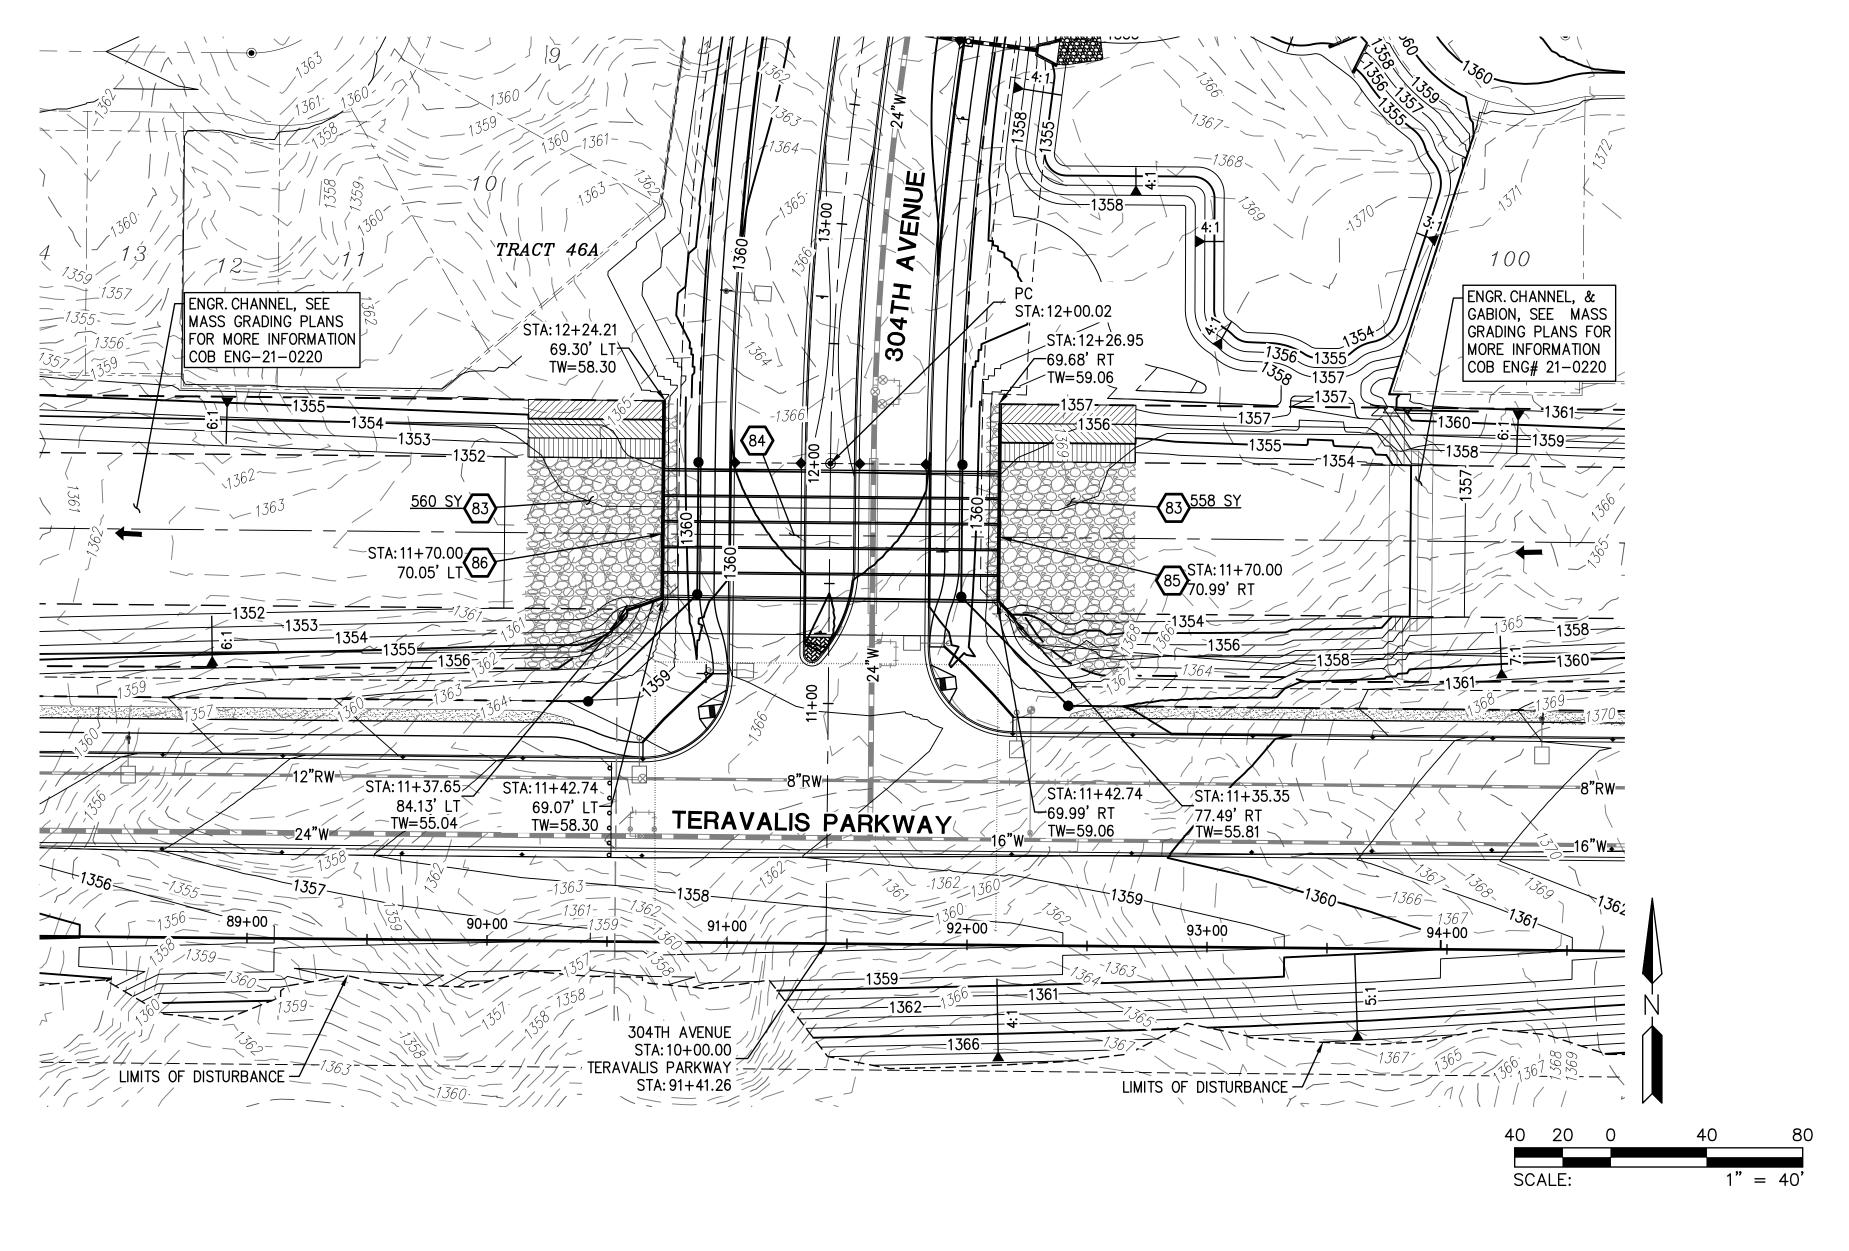

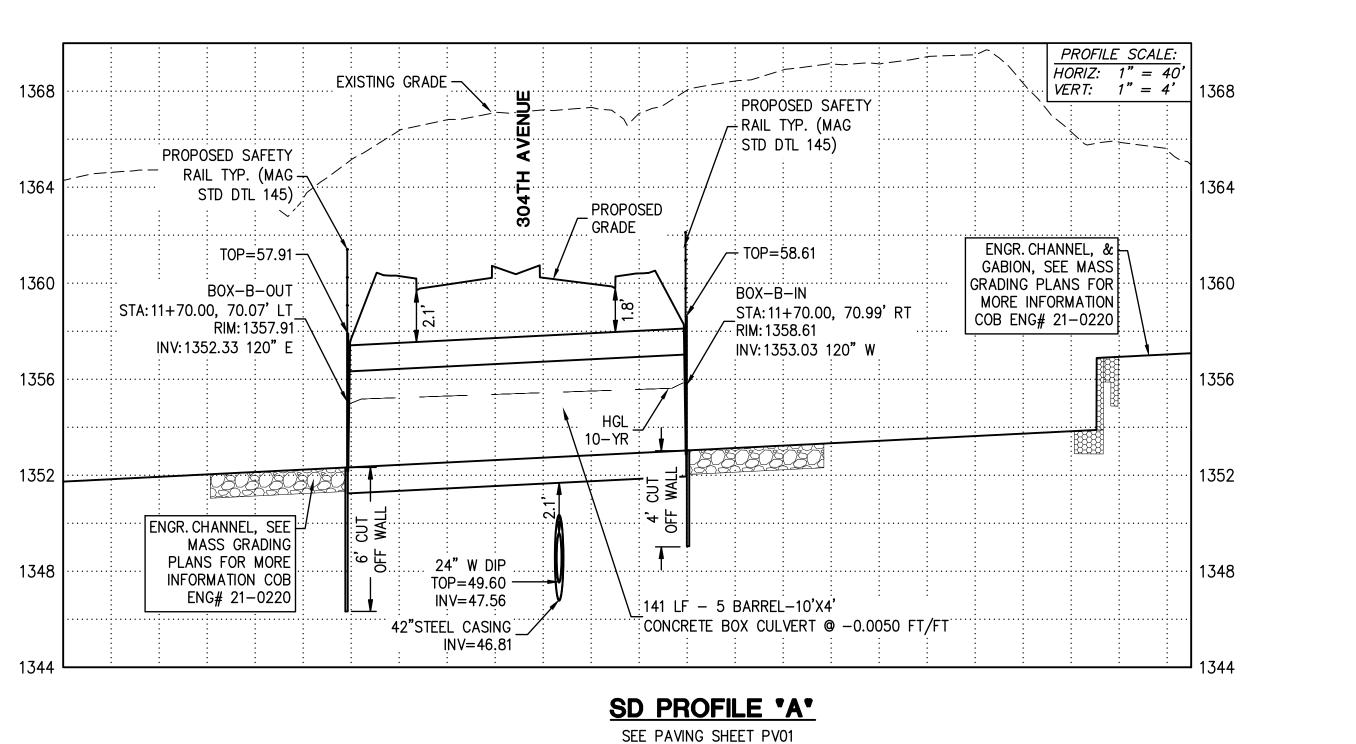



STORM DRAIN CONSTRUCTION


- INSTALL ANGULAR LOOSE RIP-RAP PER MAG SPEC SECTION 220 D50=6" 15" THICK ON MIRAFI EROSION PROTECTION GEO-TEXTILE OR APPROVED EQUAL. FABRIC TO HAVE APPARENT OPENING SIZE OF 0.425MM, PERMITTIVITY OF 50 gal/min/ft AND WOVEN. GRADATION PER TABLE 6.4 OF 2013 DRAINAGE DESIGN MANUAL FOR MARICOPA COUNTY, ARIZONA (HYDRAULICS).
- CONSTRUCT FIVE BARREL 10'X 4' BOX CULVERT
 SEE DETAIL ON SHEET SD03 AND SD04,
 SPECS AND ADOT STD DTL SD 6.05.
- CONSTRUCT INLET WING PER ADOT STD DTL SD 6.08 1 EA (6:1 SLOPE ON WING WALLS).SEE DETAIL ON SHEET SD03 AND SD04, SAFETY RAIL PER MAG STD DTL 145.
- CONSTRUCT OUTLET WING PER ADOT STD DTL SD 6.08 (6:1 SLOPE ON WING WALLS).SEE DETAIL ON SHEET SD03 AND SD04, SAFETY RAIL PER MAG STD DTL 145.




		In Maricopa County:	(602) 263-	1100
	COLLECTO BOX CULVER	AT TERAVA ORS - PHA RT-PLAN & PF	SE	1
	HILGAR1 COB PERMITTING	COB ENGINEERING		SUBMITTAL
	APPROVED SEAL	APPROVED SEAL	SUBMITTAL	3RD
	AS-BUILT SEAL	DESIGN SEAL 69427 JOSHUA ROBINSON ARIZONA U.S. A. AR	ACKING # G-21-0288	# G-21-0288
	ORIGINAL PLAN DATE Aug-21	LATEST REVISION DATE Feb-23	AN TRA ENG	RMIT # ENG
U \4400\4475\ 5N0D\ ^	PROJECT NUMBER 1175 Collectors\PLANS\PAVING\PHASE	SHEET NUMBER SHT. SD03 17 OF 20	COB PLAN TRA	COB PERMIT #

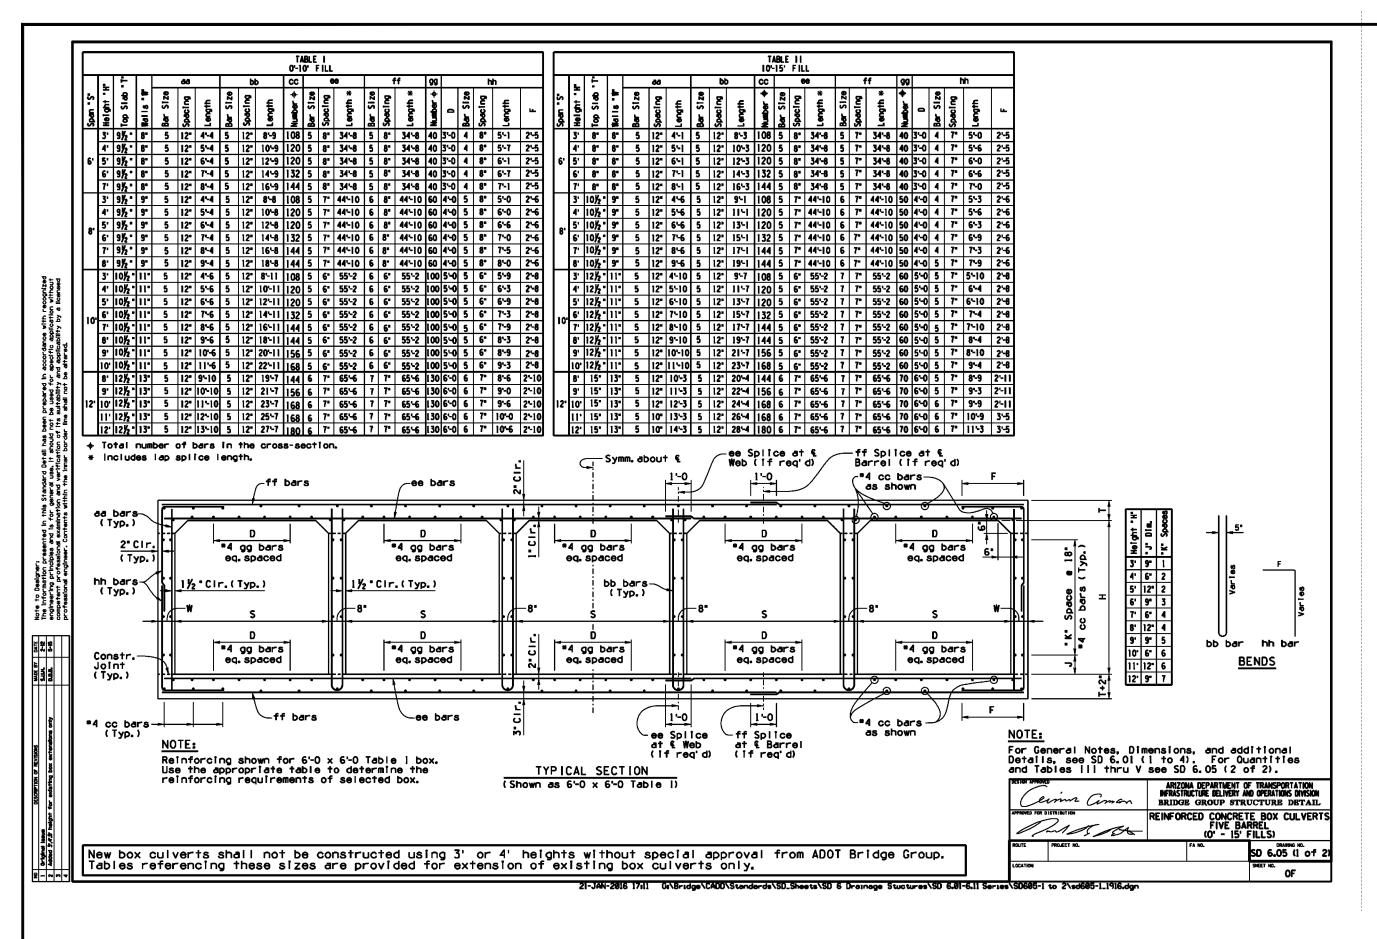


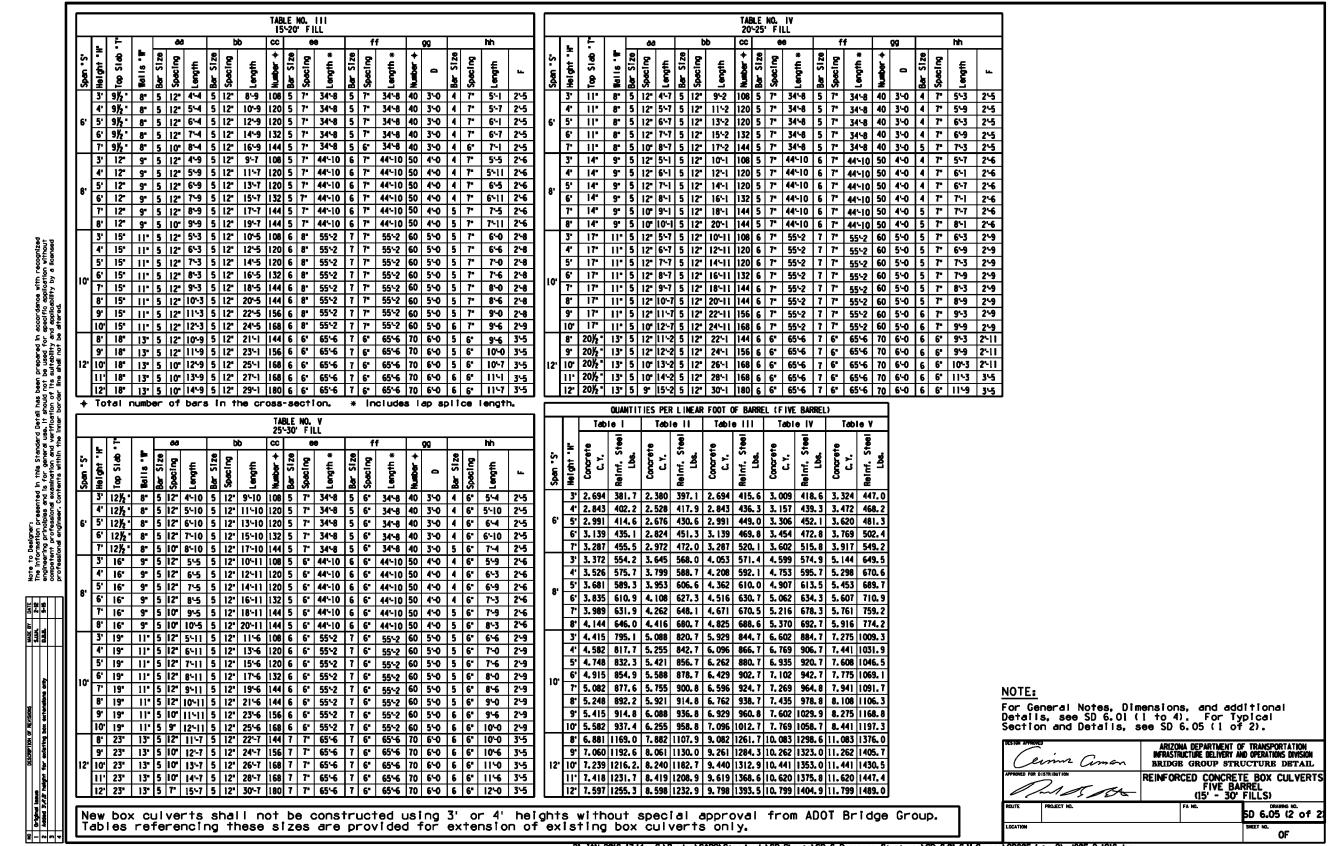

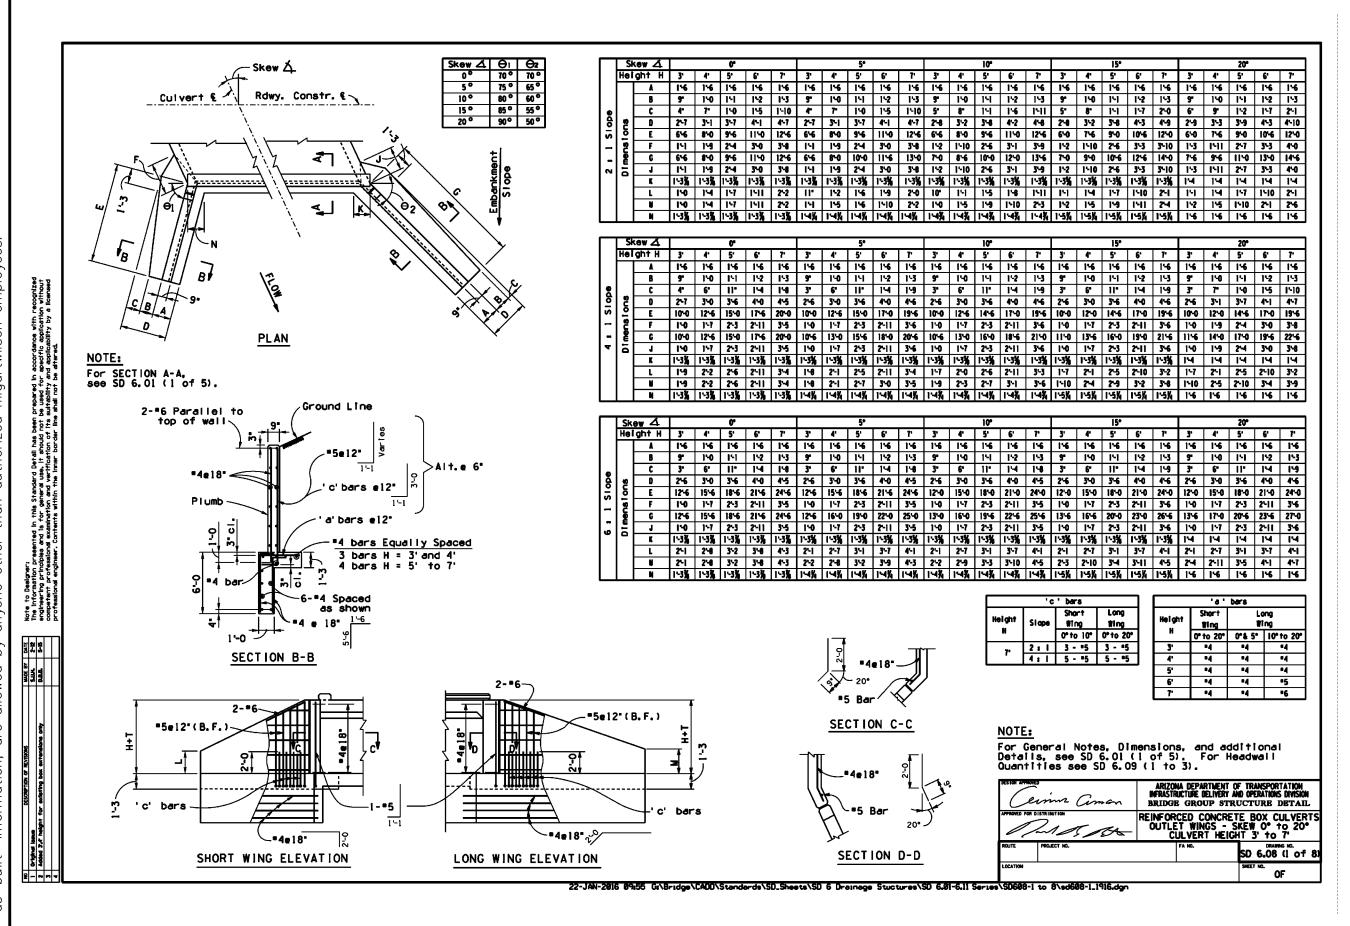


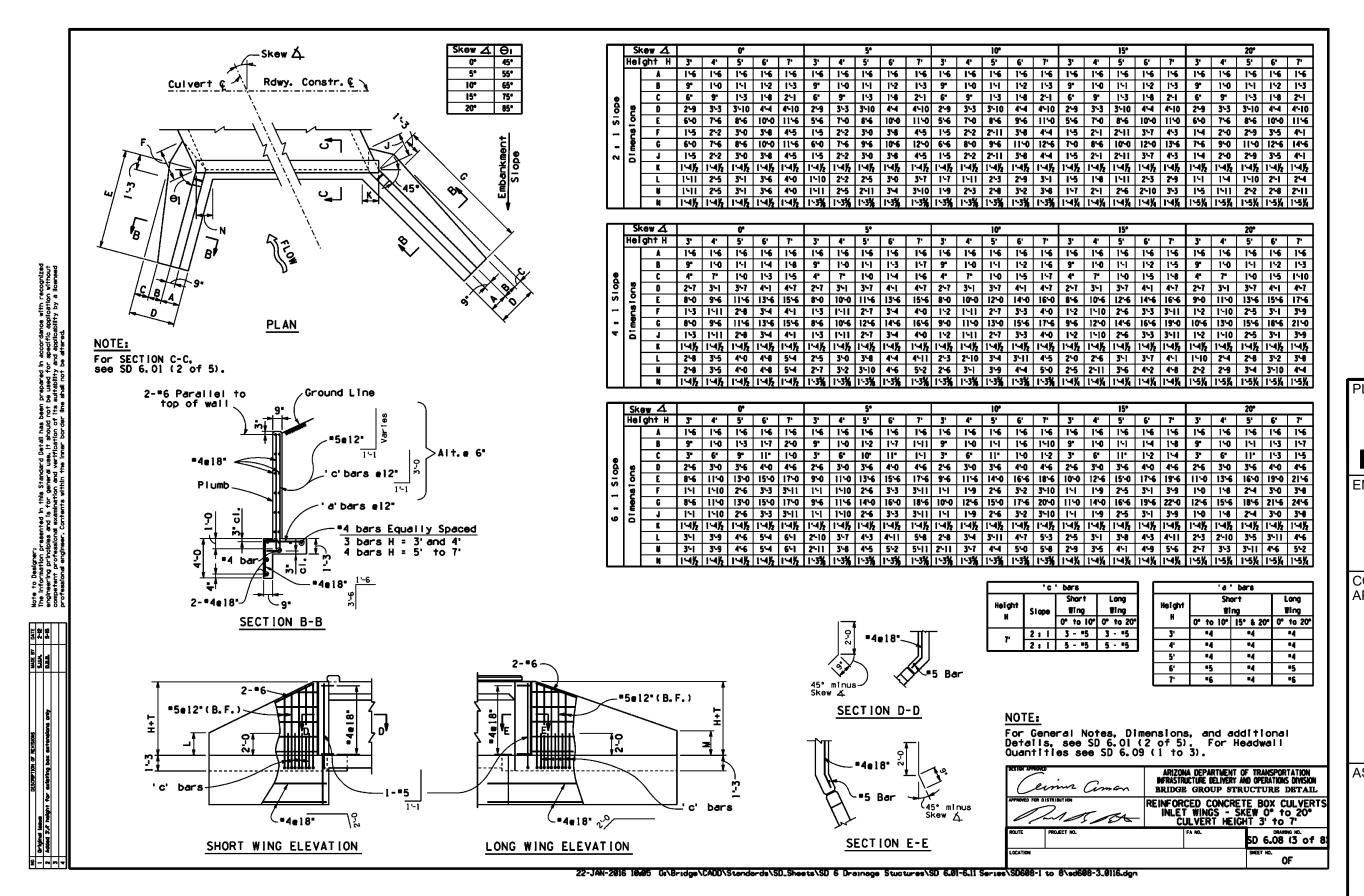





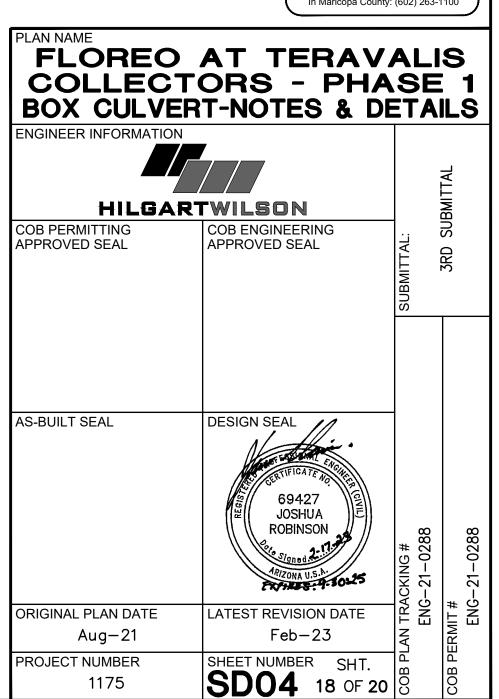

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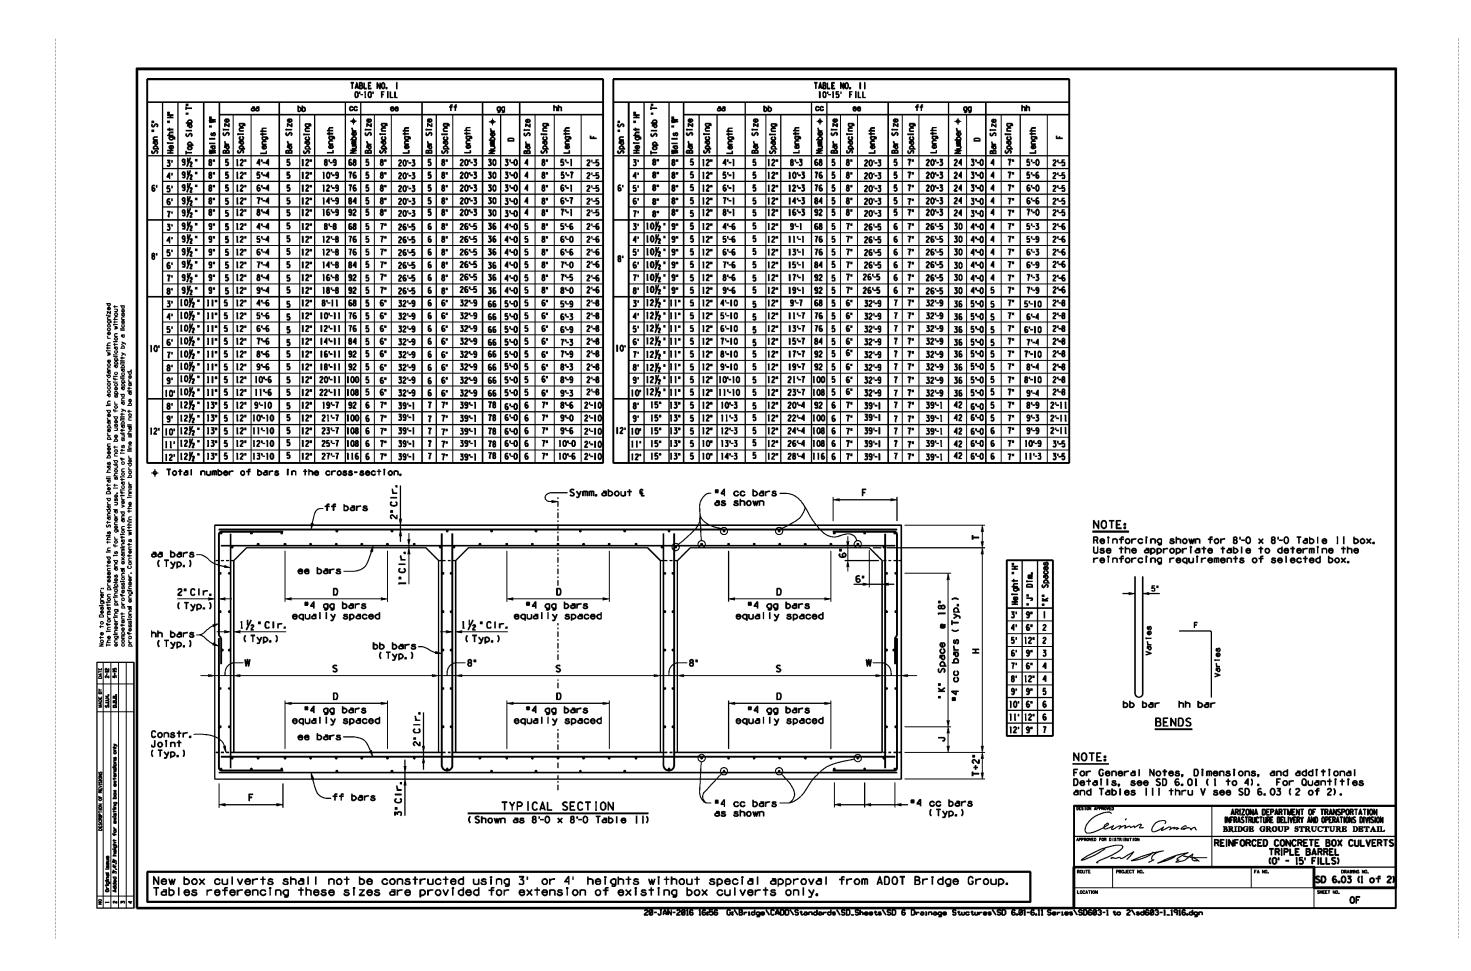


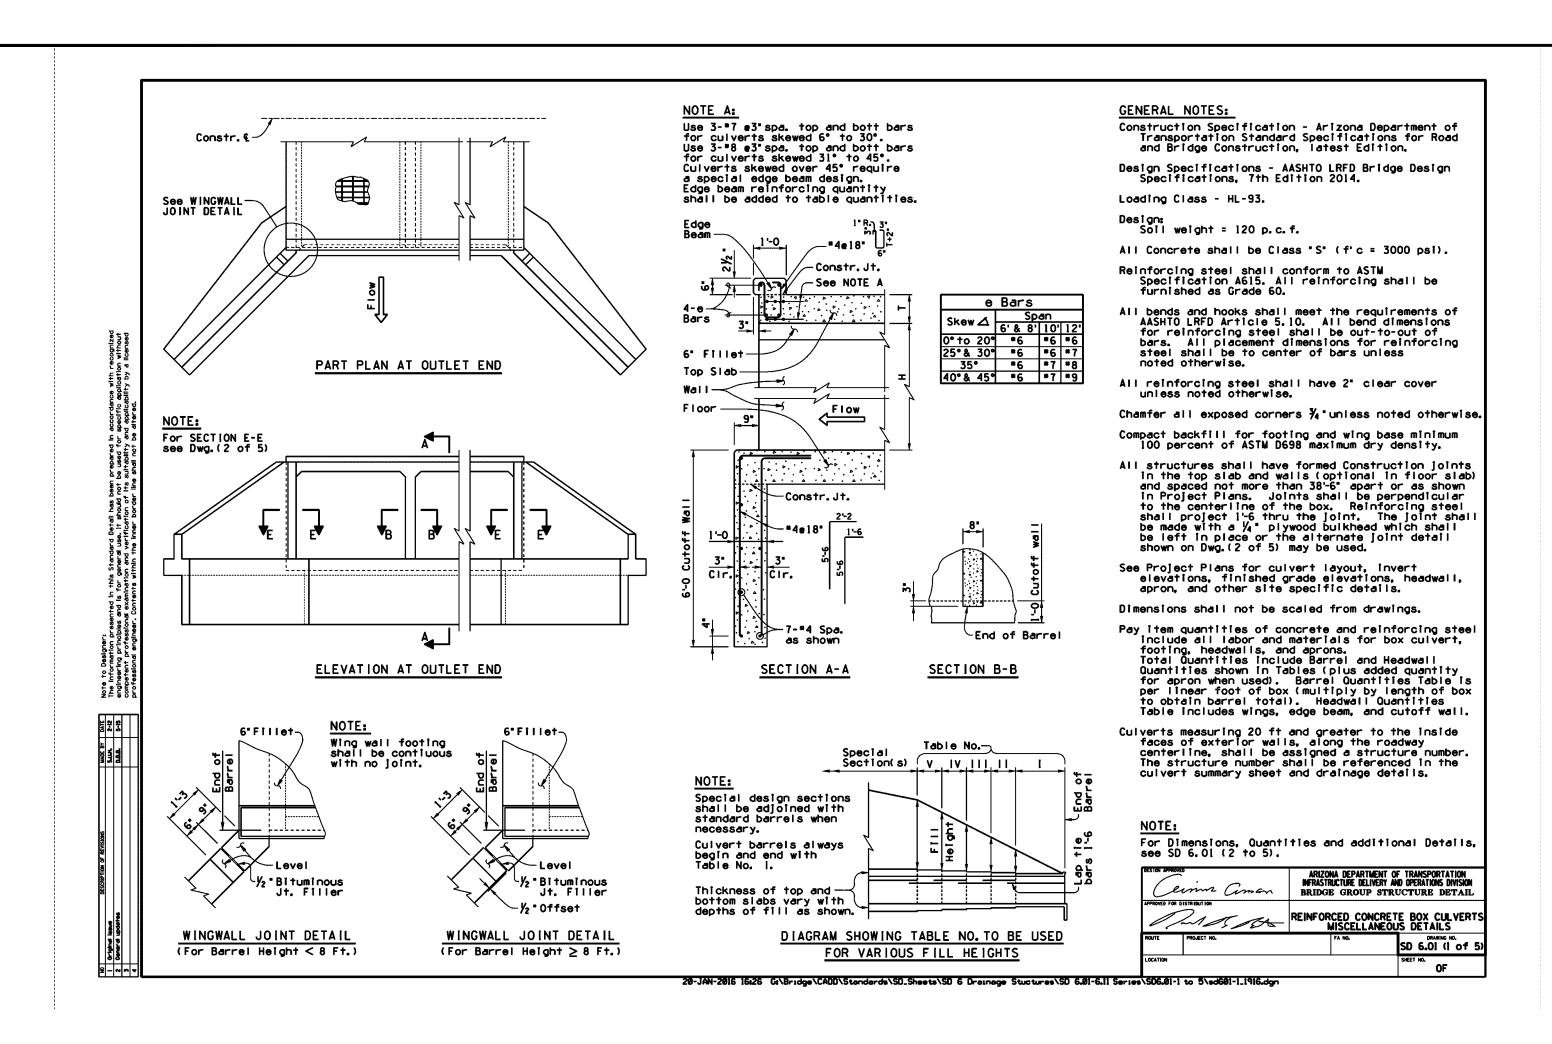


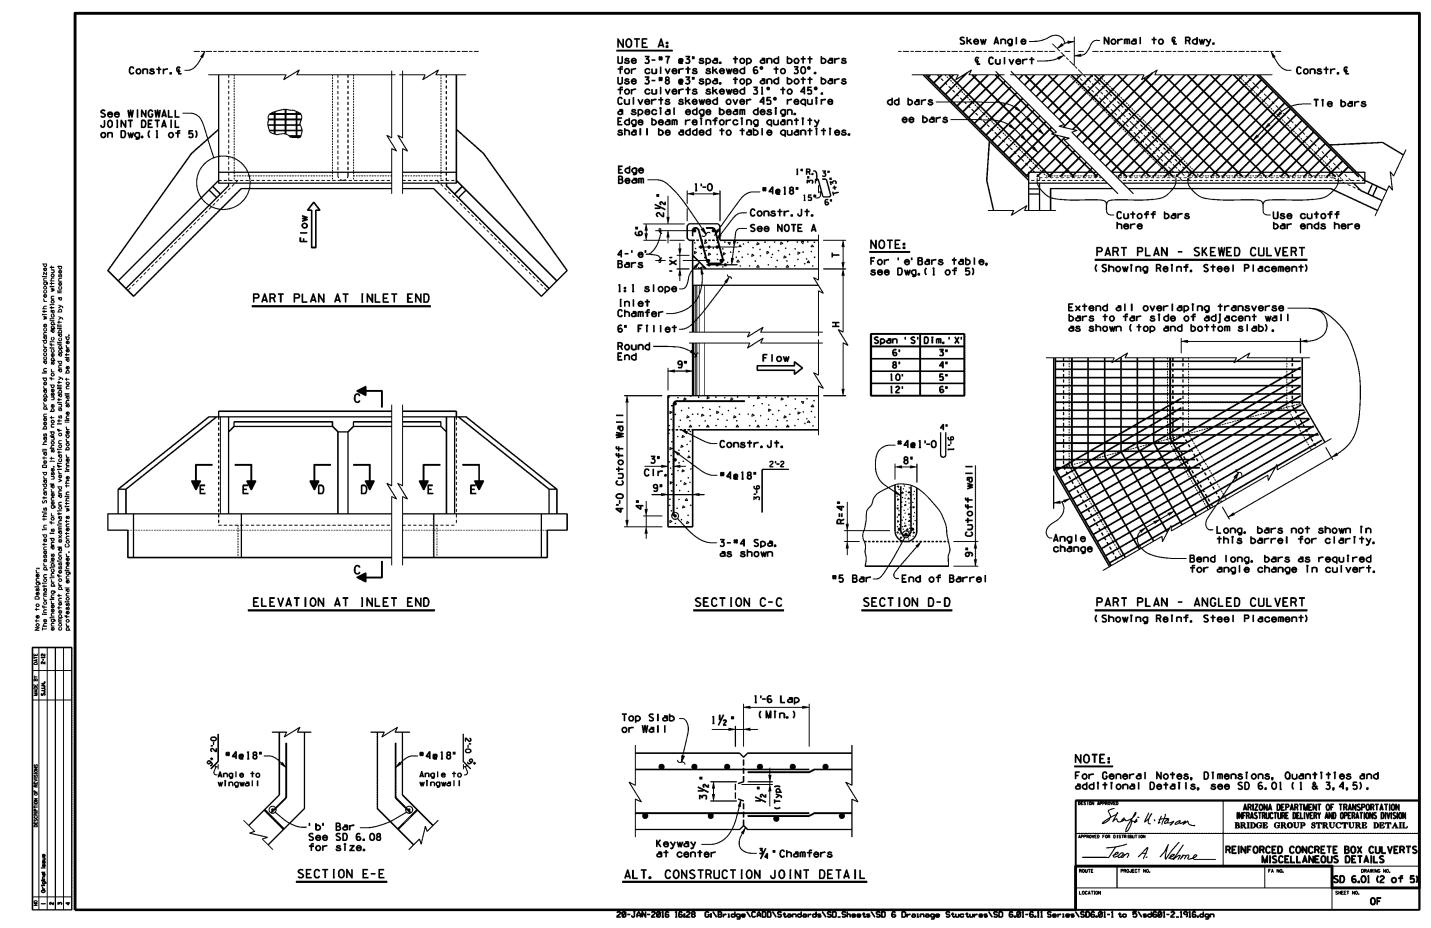

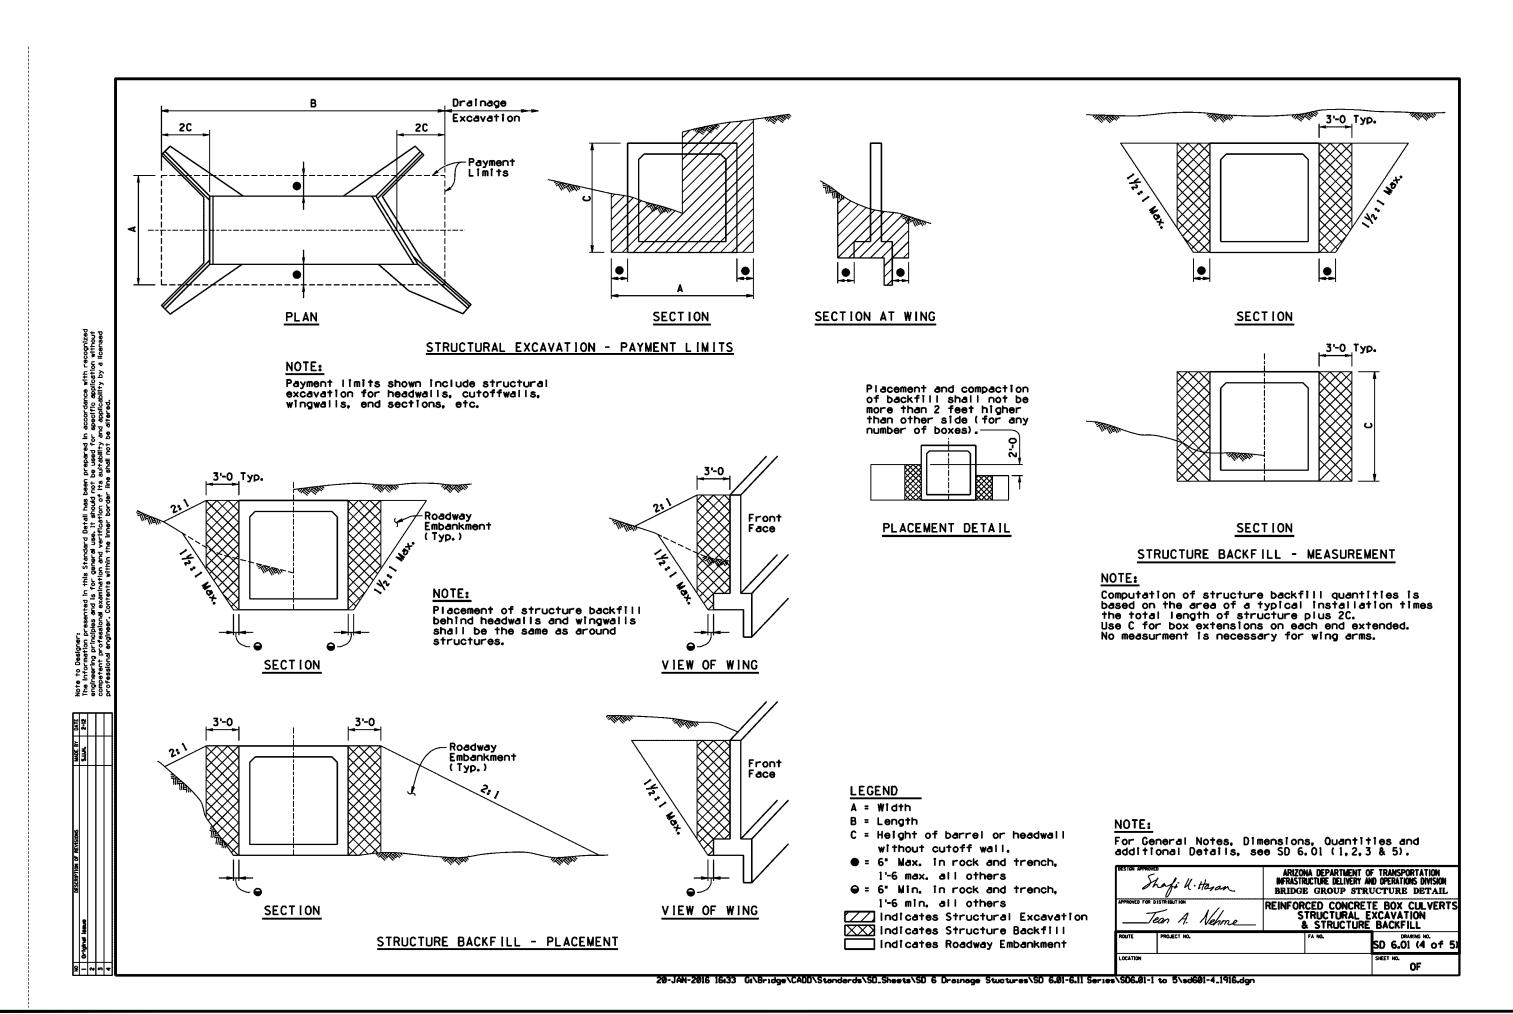

CO BOX	OREO LLECT CULVER	AT TERAV ORS - PHA RT-NOTES & D	SE	1
COB PERM APPROVE	IITTING	TWILSON COB ENGINEERING APPROVED SEAL	SUBMITTAL:	3RD SUBMITTAL
AS-BUILT S	SEAL	DESIGN SEAL 69427 JOSHUA ROBINSON ARIZONA U.S. A.	TRACKING # ENG-21-0288	IT # ENG-21-0288
	PLAN DATE Aug-21 NUMBER 1175	LATEST REVISION DATE Feb-23 SHEET NUMBER SHT. SD05 19 OF 20	B PLAN	COB PERMIT# ENG-2



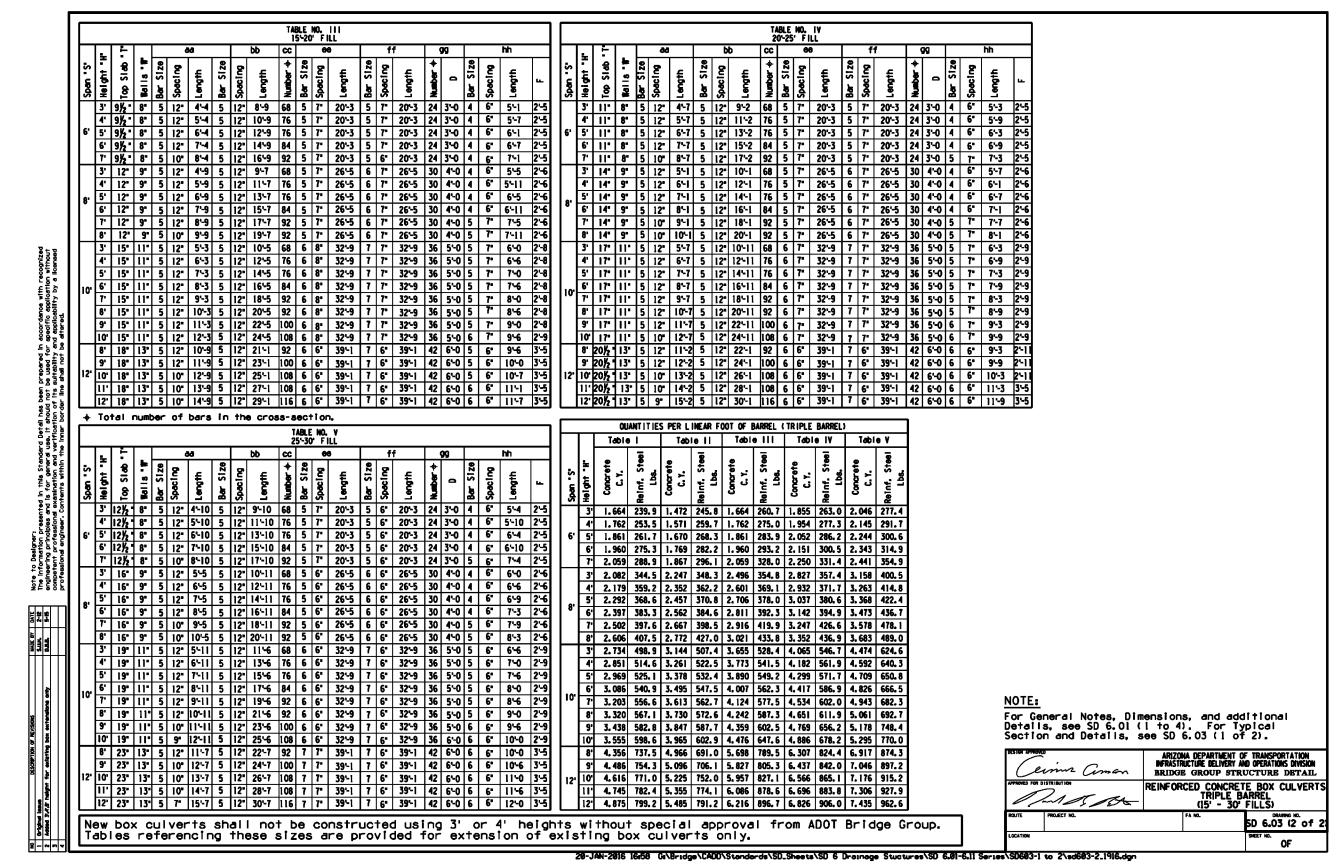



FLOREO AT TERAVALIS COLLECTORS - PHASE 1 BOX CULVERT-NOTES & DETAILS						
HILGA COB PERMITTING APPROVED SEAL	COB ENGINEERING APPROVED SEAL	SUBMITTAL: 3RD SUBMITTAL				
AS-BUILT SEAL	DESIGN SEAL					
	69427 JOSHUA ROBINSON ARIZONA U.S.A.	GOB PLAN TRACKING # COB PERMIT # ENG-21-0288 ENG-21-0288				
ORIGINAL PLAN DATE Aug-21	LATEST REVISION DATE Feb-23	AN TRACIENG—; ENG—; RMIT# ENG—;				
PROJECT NUMBER 1175	SHEET NUMBER SHT. SD06 20 OF 2	COB PLAN TRA COB PERMIT #				

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pyright, migatemisch.

In product than adding "as—built" information, are allowed by anyone other than authorized hilgartwilson employees.