

CITY OF PHOENIX

AVIATION DEPARTMENT

DESIGN & CONSTRUCTION SERVICES



PROJECT NAME **PSHIA INFIELD UTILITY ACCESS UPGRADES AND PAVING TAXIWAY E & F INFIELDS (ES11, ES12, FN11, FN12)**

ADDRESS **3400 EAST SKY HARBOR BOULEVARD, PHOENIX, AZ 85034**

PROJECT NUMBER **AV08000074 ADOT**

ADOT GRANT NUMBER **XXXXXXXXXX**

MAYOR
KATE GALLEG0

VICE MAYOR
YASSAMIN ANSARI

CITY COUNCIL

DISTRICT NO. 1 ANN O'BRIEN	DISTRICT NO. 5 BETTY GUARDADO
DISTRICT NO. 2 JIM WARING	DISTRICT NO. 6 KEVIN ROBINSON
DISTRICT NO. 3 DEBRA STARK	DISTRICT NO. 7 YASSAMIN ANSARI
DISTRICT NO. 4 LAURA PASTOR	DISTRICT NO. 8 KESHA HODGE WASHINGTON

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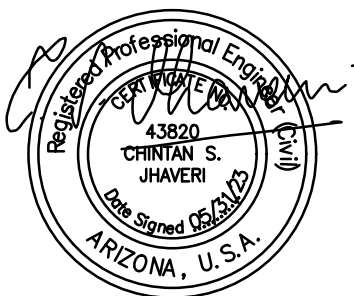
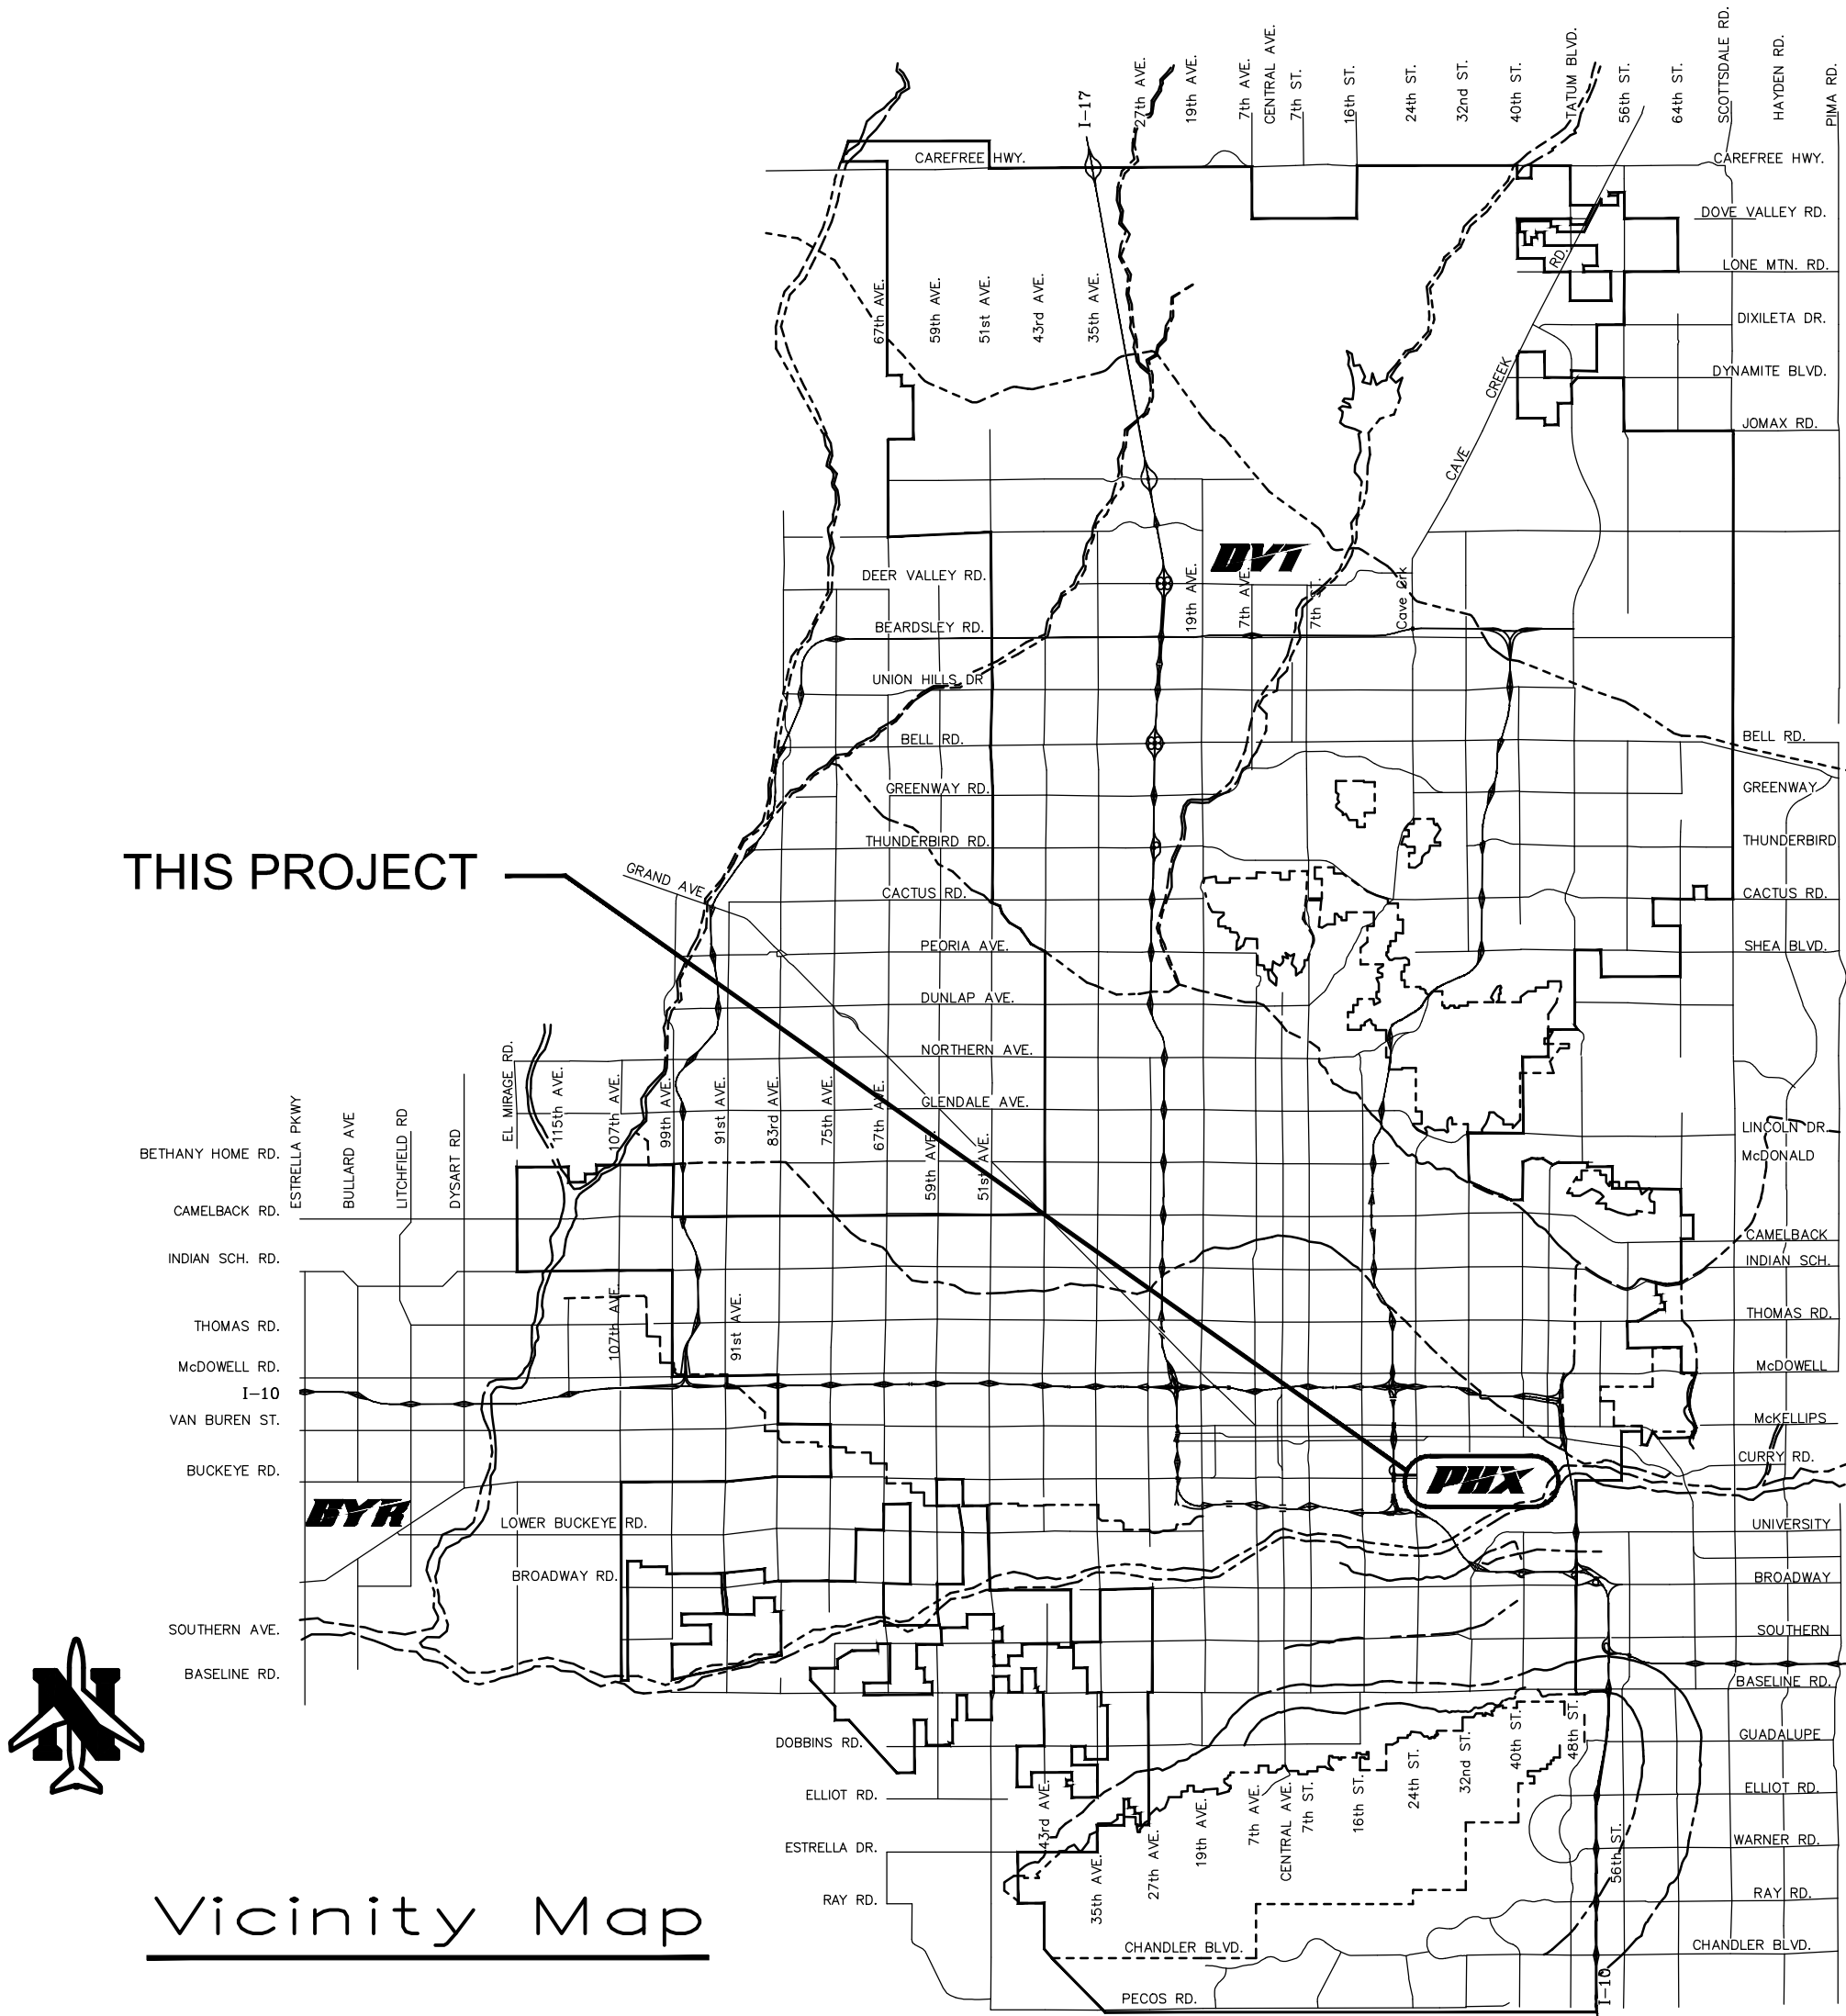
DIRECTOR OF AVIATION SERVICES

CHAD R. MAKOVSKY, C.M.

APPROVALS

DEPUTY AVIATION DIRECTOR
DESIGN & CONSTRUCTION SERVICES DIVISION

DATE



ABBREVIATIONS	
ABBREVIATIONS	DEFINITIONS
7L/25R	RUNWAY DESIGNATION
ABC	AGGREGATE BASE COURSE
AC	ASPHALTIC CONCRETE
ADOT	ARIZONA DEPARTMENT OF TRANSPORTATION
AIP	AIRPORT IMPROVEMENT PROGRAM
APS	ARIZONA PUBLIC SERVICE
ASTM	AMERICAN SOCIETY FOR TESTING MATERIALS
CL OR \mathbb{C}	CENTER LINE
C TO C	CENTER TO CENTER
CMP	CORRUGATED METAL PIPE
CONC	CONCRETE
CF OR CU FT	CUBIC FEET
CY	CUBIC YARDS
CZ	CLEAR ZONE
DIA	DIAMETER
DIP	DUCTILE IRON PIPE
D ₅₀	DIAMETER OF 50% ROCK SIZE
E	EAST OR EASTING
EA	EACH
ELEC	ELEC/ELECTRICAL
EL OR ELEV	ELEVATION
EX OR EXST	EXISTING
FAA	FEDERAL AVIATION ADMINISTRATION
FIN	FINISHED
FL OR $\overline{\mathbb{L}}$	FLOW LINE
FT	FOOT
GPM	GALLONS PER MINUTE
ID	INSIDE DIAMETER
IE	INVERT ELEVATION
JB	JUNCTION BOX
L	LENGTH OR LEFT
LBS	POUNDS
LF	LINEAL FOOT
LS	LUMP SUM
LT	LEFT
MAG	MARICOPA ASSOCIATION OF GOVERNMENTS
MAX	MAXIMUM
MH	MANHOLE
MIN	MINIMUM
N	NORTH OR NORTHING
NO.	NUMBER
NPI	NON-PAY-ITEM
NTS	NOT TO SCALE
N/A	NON APPLICABLE
OC	ON CENTER
OD	OUTSIDE DIAMETER
PROP	PROPOSED
PVC	POLYVINYL CHLORIDE
PVMT	PAVEMENT
R	RADIUS OR RIGHT
RCP	REINFORCED CONCRETE PIPE
REINF	REINFORCING
ROW	RIGHT-OF-WAY
RSA	RUNWAY SAFETY AREA
RT	RIGHT
RWY	RUNWAY
S	SOUTH OR SLOPE
SAL	SAFETY AREA LIMITS
SD	STANDARD DETAIL OR STORM DRAIN
SECT	SECTION
SHT	SHEET
SPECS	SPECIFICATIONS
STA	STATION
SY	SQUARE YARDS
T	TANGENT LENGTH
T.C.	TOP OF CONCRETE
TSA	TAXIWAY SAFETY AREA
TWY	TAXIWAY
TYP	TYPICAL
UG	UNDERGROUND
VCP	VITRIFIED CLAY PIPE
W	WEST OR WATER
w	WATT
WT	WEIGHT
#	REBAR SIZE NUMBER

ABBREVIATIONS	
ABBREVIATIONS	DEFINITIONS
Ⓢ	AT
ILS	INSTRUMENT LANDING SYSTEM
HP	HIGH POINT
GALV	GALVANIZED
GAL	GALLON
GA	GAUGE
EVC	END VERTICAL CURVE
ESMT	EASEMENT
CONST	CONSTRUCTION
CFS	CUBIC FEET PER SECOND
BVC	BEGIN VERTICAL CURB
BOT	BOTTOM
BC	BEGIN CURVE
ATCT	AIR TRAFFIC CONTROL TOWER
APPROX	APPROXIMATE
ARFF	AIRPORT RESCUE AND FIRE FIGHTING
AOA	AIR OPERATIONS AREA
ALT	ALTERNATE
CTB	CEMENT TREATED BASE
SWPPP	STORM WATER POLLUTION PREVENTION PLAN
SCHD	SCHEDULE
PSHIA	PHOENIX SKY HARBOR INTERNATIONAL AIRPORT
RGRCP	RUBBER GASKET REINFORCED CONCRETE PIPE
KV	KILOVOLT
NAVD	NORTH AMERICAN VERTICAL DATUM
CLSM	CONTROLLED LOW STRENGTH MATERIAL
NEMA	NATIONAL ELECTRICAL MANUFACTURERS ASSOC.
NOTAM	NOTICE TO AIRMAN
TBM	TEMPORARY BENCH MARKS
COP	CITY OF PHOENIX
PC	POINT OF CURVATURE
PI	POINT OF INTERSECTION
PCC	PORTLAND CEMENT CONCRETE
PCCP	PORTLAND CEMENT CONCRETE PAVEMENT
PETRO	PETROLEUM
PT	POINT OF TANGENCY
PVI	POINT OF VERTICAL INTERSECTION
CPM	CRITICAL PATH METHOD
ADEQ	ARIZONA DEPARTMENT OF ENVIRONMENTAL QUALITY
SF	SQUARE FEET OR SEMI-FLUSH
STD	STANDARD
VC	VERTICAL CURVE
V OR VERT	VERTICAL
TOFA	TAXIWAY OBJECT FREE AREA
N.O.T.	NOTICE OF TERMINATION
N.O.I.	NOTICE OF INTENT
SIDA	SECURITY IDENTIFICATION DISPLAY AREA
DVT	DEER VALLEY AIRPORT
CPM	CRITICAL PATH METHOD

LEGEND		
DESCRIPTION	EXISTING	PROPOSED
CONCRETE SIGN BASE		
RUNWAY/TAXIWAY EDGE LIGHT		
FLUSH RUNWAY/TAXIWAY EDGE LIGHT		
RUNWAY GUARD LIGHT		
SANITARY SEWER AND MANHOLE		
STORM DRAIN, MANHOLE & INLET		
RUNWAY/TAXIWAY CENTERLINE		
CHAIN LINK FENCE		
MAJOR CONTOUR LINES		
MINOR CONTOUR LINES		
FIBER OPTIC		
GRADE BREAK		
FLOW LINE		
APS MANHOLE		
MONITORING WELL		
WATER LINE		
TELEPHONE		
GAS LINE		
FAA		
ELECTRICAL		
RUNWAY SAFETY AREA		
TAXIWAY SAFETY AREA		
CONSTRUCTION NOTE		
REFERENCE NOTE OR STORM DRAIN CONSTRUCTION NOTE		
ADJUSTMENT/REMOVAL/DEMOLITION NOTE		
SPOT ELEVATION		
SPOT ELEVATION-CATCH BASIN GRATE		
SAWCUT FULL DEPTH AND MATCH EXISTING		
MATCH EXISTING		

SHEET OVERVIEW TITLE		SHEET REFERENCE NUMBER: GI-004			
Designed by: G. SHAW		<div>LEGEND AND ABBREVIATIONS</div>			
Drawn by: A. SANTILLI					
Checked by: C. JHAVERI					
Date: 05/31/2023					
Dwg scale: NTS					
<div>PHX DVT BYA CITY OF PHOENIX AVIATION DEPARTMENT</div> <div>PSHIA INFIELD UTILITY ACCESS UPGRADES AND PAVING AV 08000074 ADOT ADOT GRANT NO.: XXXXXXXX</div>		<div>PRIME CONSULTANT TRACE CONSULTING 100 E. Jefferson St. Suite 1 Phoenix, AZ 85004 100 E. Jefferson St. Suite 1 Phoenix, AZ 85004</div> <div>SUB CONSULTANT</div>			
<div>PER CITY OF PHOENIX CITY CODE CHAPTER 2, SECTION 2-28, THESE PLANS ARE FOR OFFICIAL USE ONLY AND MAY NOT BE SHARED WITH OTHERS EXCEPT AS REQUIRED BY THE OBLIGATIONS OF CONTRACTOR'S CONTRACT WITH THE CITY OF PHOENIX</div>		NO		REVISIONS / SUBMISSIONS	DATE
<div>PHX DVT BYA CITY OF PHOENIX AVIATION DEPARTMENT</div> <div>PSHIA INFIELD UTILITY ACCESS UPGRADES AND PAVING AV 08000074 ADOT ADOT GRANT NO.: XXXXXXXX</div>		<div>PRIME CONSULTANT TRACE CONSULTING 100 E. Jefferson St. Suite 1 Phoenix, AZ 85004 100 E. Jefferson St. Suite 1 Phoenix, AZ 85004</div> <div>SUB CONSULTANT</div>			
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PRIME CONSULTANT

TRACE CONSULTING

201 E. Jefferson St., Suite 100 Phoenix, AZ 85004

SUB CONSULTANT

ARIZONA 811

ARIZONA 811

PER CITY OF PHOENIX CITY CODE CHAPTER 2, SECTION 2-2-28, THESE PLANS ARE FOR OFFICIAL USE ONLY AND MAY NOT BE SHARED WITH OTHERS EXCEPT AS REQUIRED TO FULFILL THE OBLIGATIONS OF CONTRACTOR'S CONTRACT WITH THE CITY OF PHOENIX.

NO	REVISIONS / SUBMISSIONS	DATE

PHX BYR

CITY OF PHOENIX AVIATION DEPARTMENT

PSHIA INFILDT UTILITY ACCESS UPGRADES AND PAVING

AV 08000074 ADOT

ADOT GRANT NO.: XXXXXXX

Designed by: C. SHAW

Drawn by: A. SANTILLI

Checked by: C. JHAVERI

Date: 05/31/2023

Dwg scale: NTS

SHEET OVERVIEW TITLE


KEY MAP

SHEET REFERENCE NUMBER:

GI-401

SHEET 5 OF 23

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PRIME CONSULTANT
TRACE
CONSULTING
1201 E. Jefferson St., Suite 100 Phoenix, AZ 85004

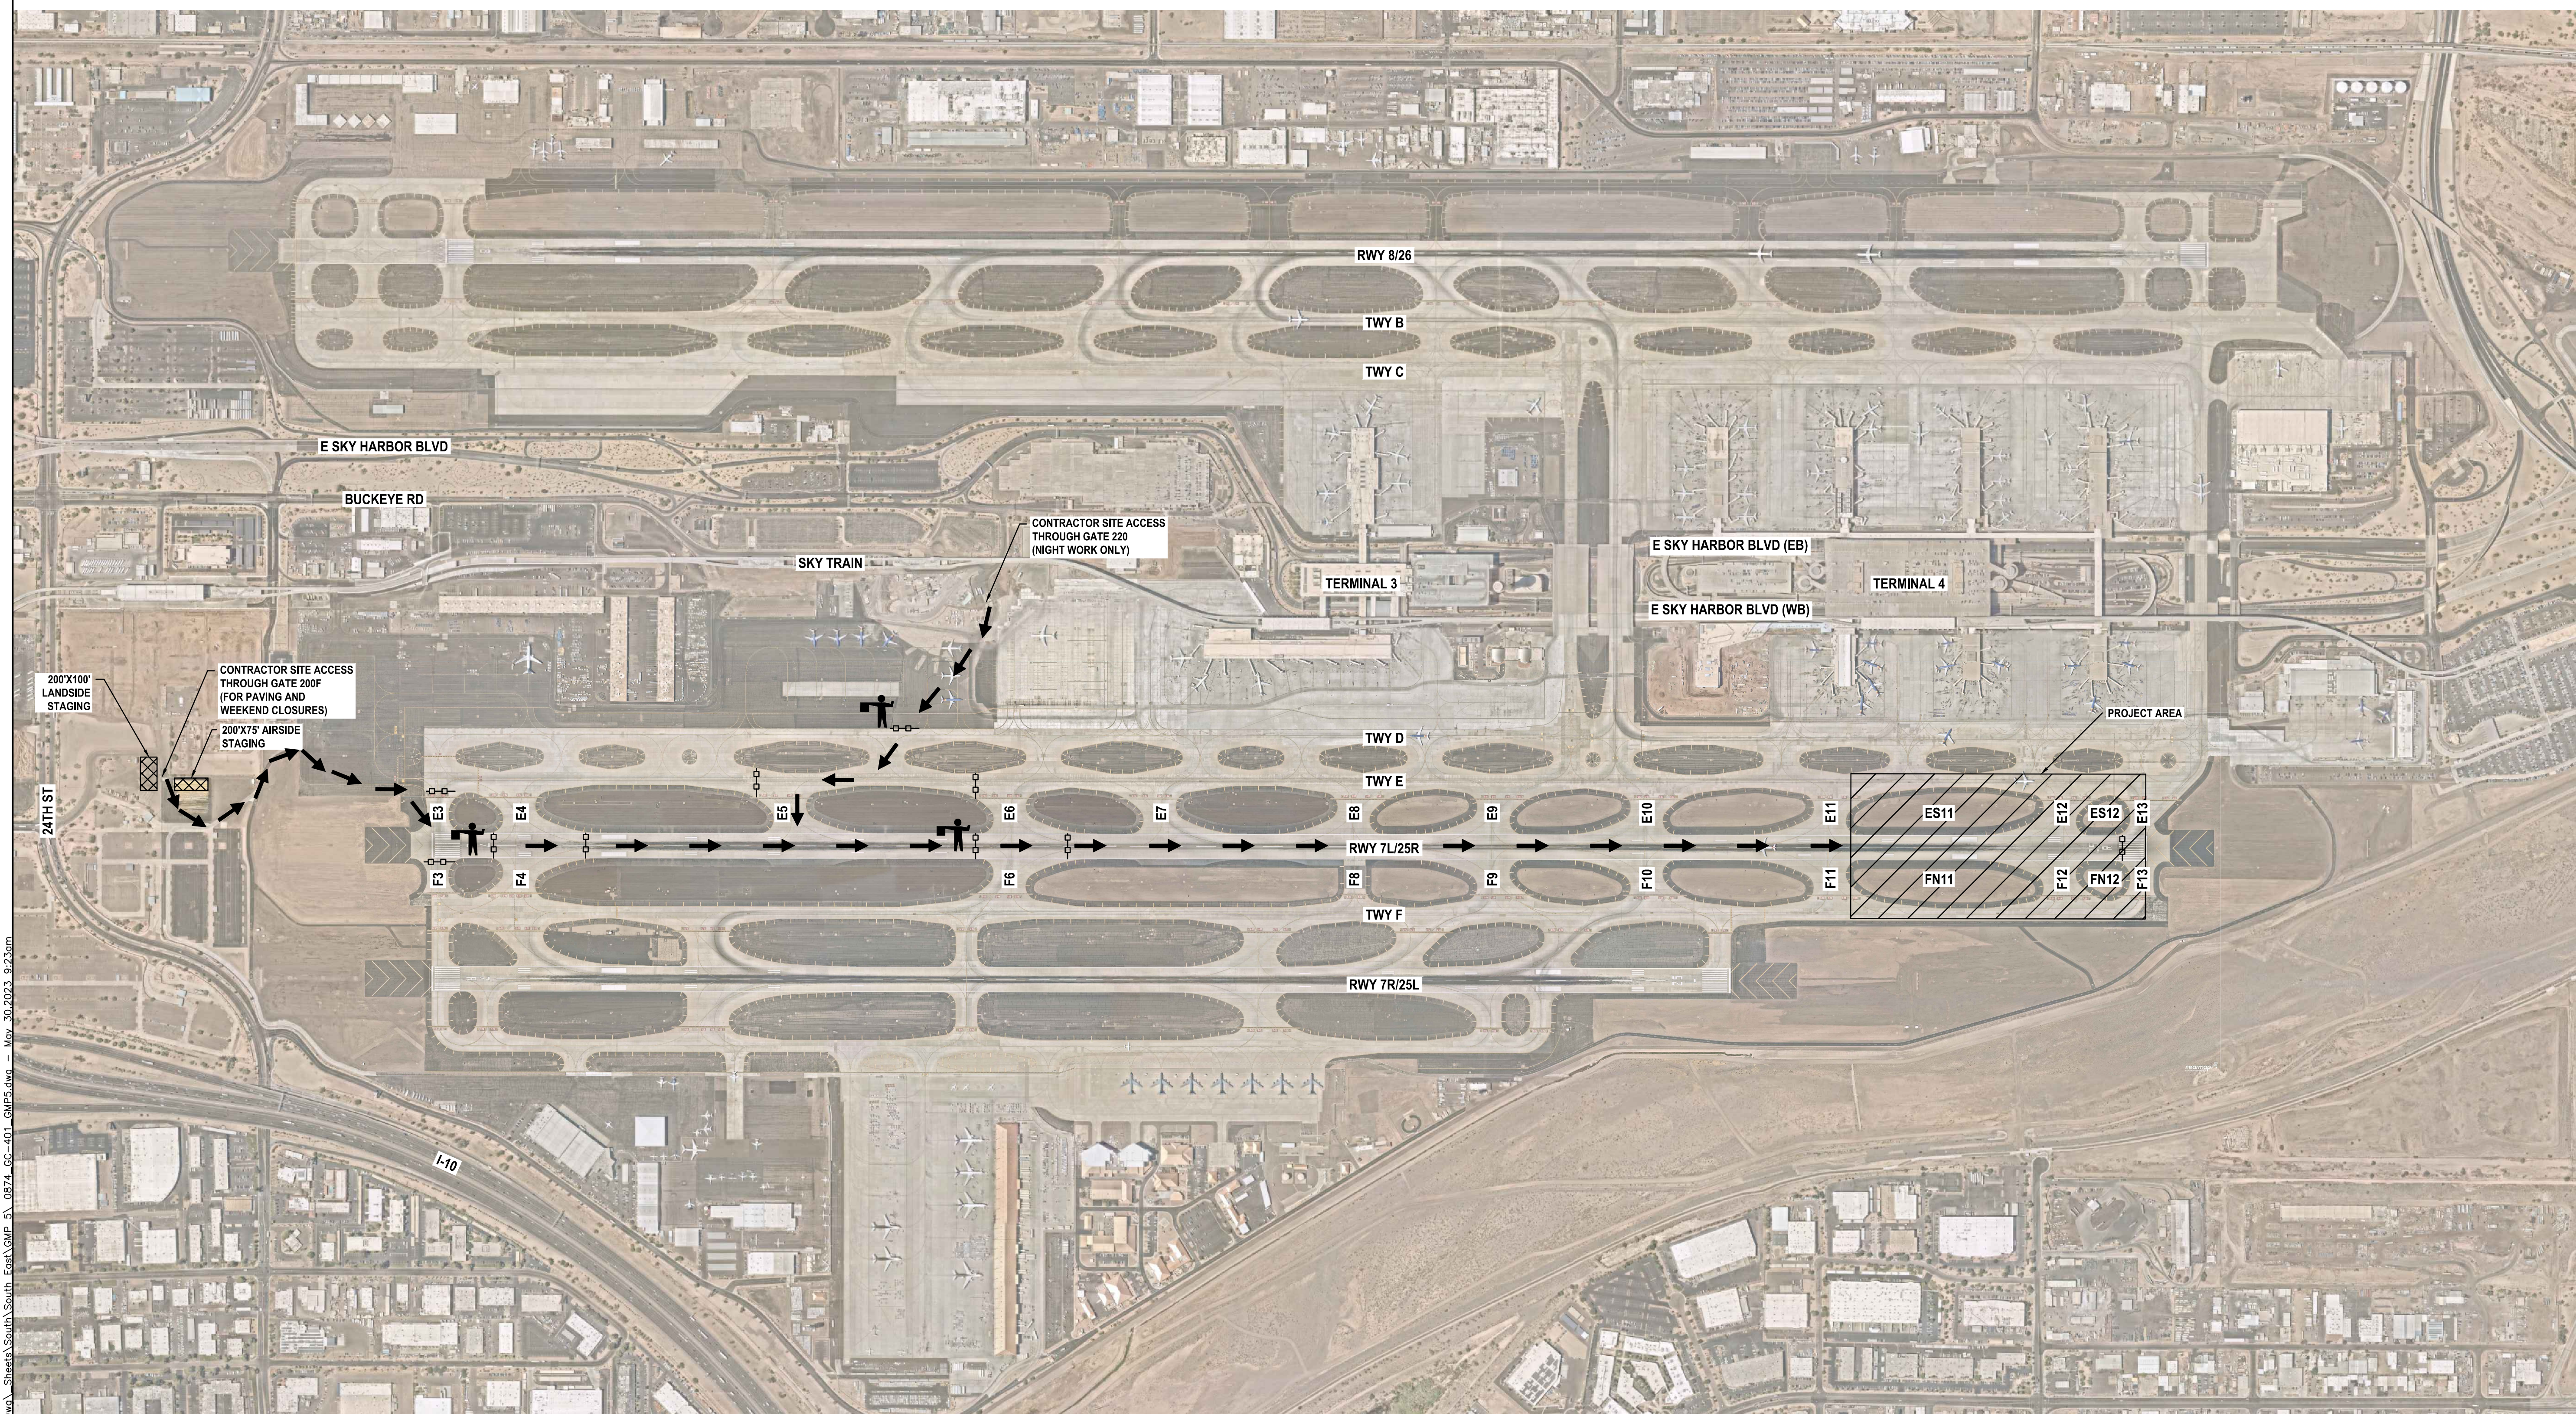SUB CONSULTANT

PER CITY OF PHOENIX CITY CODE CHAPTER 2, SECTION 2-2-28, THESE PLANS ARE CONSIDERED PUBLIC RECORDS AND MAY NOT BE SHARED WITH OTHERS EXCEPT AS REQUIRED TO FULFILL THE OBLIGATIONS OF CONTRACTOR'S CONTRACT WITH THE CITY OF PHOENIX.

NO	REVISIONS / SUBMISSIONS	DATE

PHX **PHX** **PHX**
CITY OF PHOENIX AVIATION DEPARTMENT

PSHIA INFIELD UTILITY ACCESS UPGRADES AND PAVING
ADOT GRANT NO.: XXXXXXXX


Designed by: C. SHAW
Drawn by: A. SANTILLI
Checked by: C. JHAVERI
Date: 05/31/2023
Dwg scale: NTS

PROJECT LAYOUT PLAN

SHEET REFERENCE NUMBER:
GC-401
SHEET 6 OF 23

Contact Arizona 811 at least two full working days before you begin excavation
ARIZONA811
Call 811 or click Arizona811.com

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SURVEY CONTROL NOTES

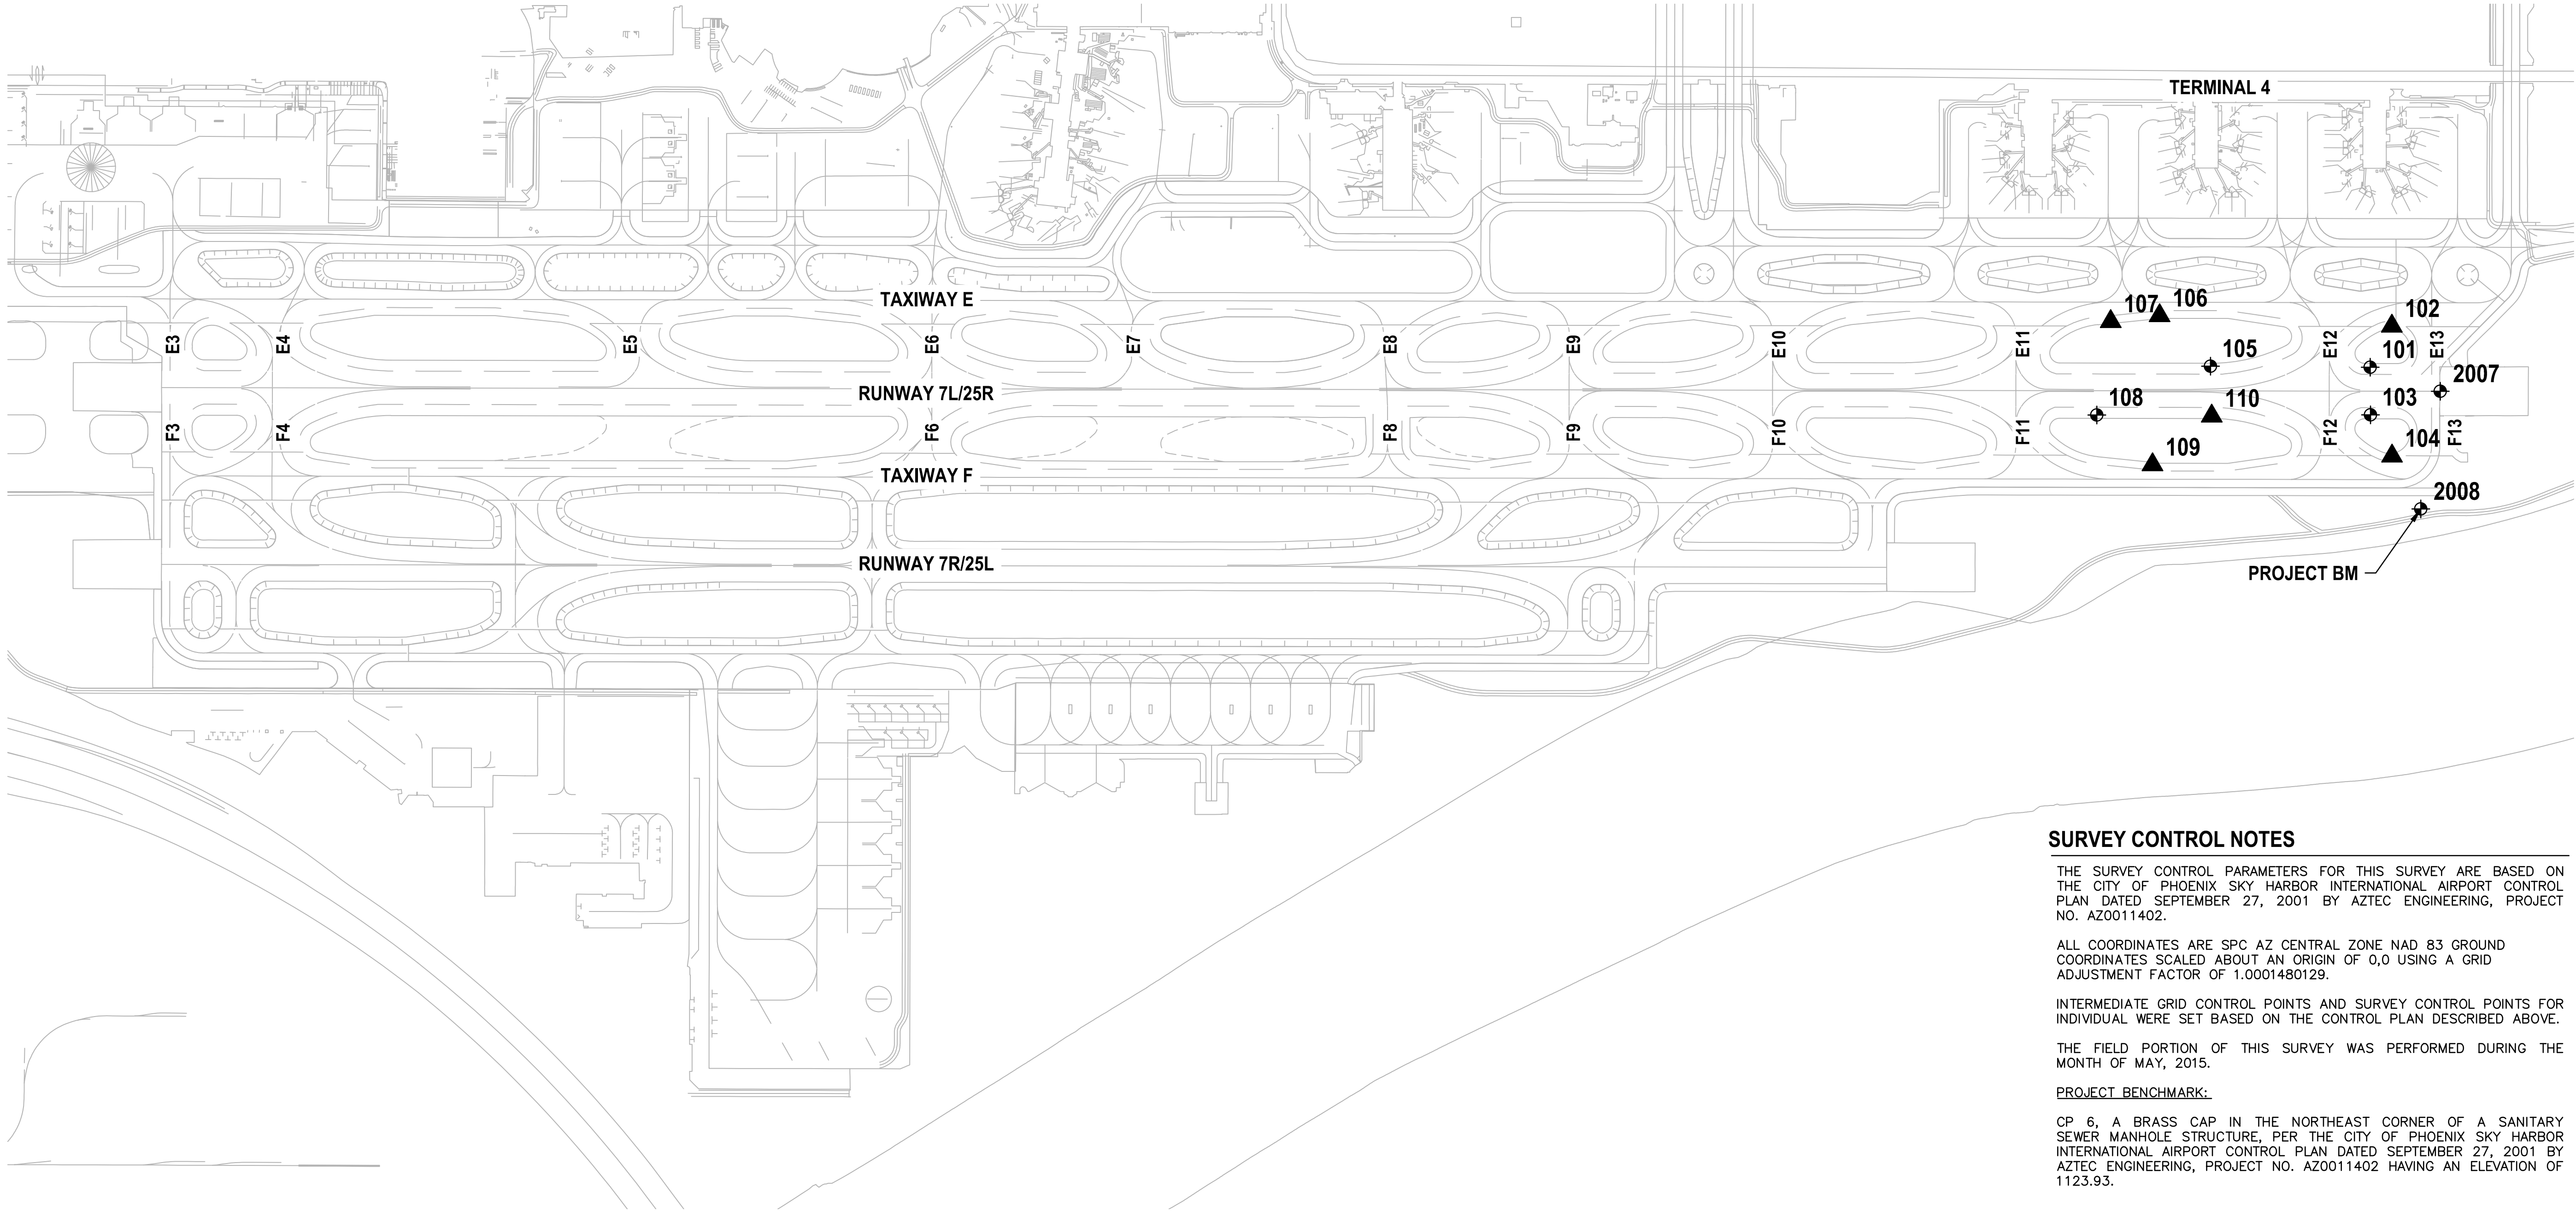THE SURVEY CONTROL PARAMETERS FOR THIS SURVEY ARE BASED ON THE CITY OF PHOENIX SKY HARBOR INTERNATIONAL AIRPORT CONTROL PLAN DATED SEPTEMBER 27, 2001 BY AZTEC ENGINEERING, PROJECT NO. AZ0011402.

ALL COORDINATES ARE SPC AZ CENTRAL ZONE NAD 83 GROUND COORDINATES SCALED ABOUT AN ORIGIN OF 0,0 USING A GRID ADJUSTMENT FACTOR OF 1.0001480129.

INTERMEDIATE GRID CONTROL POINTS AND SURVEY CONTROL POINTS FOR INDIVIDUAL WERE SET BASED ON THE CONTROL PLAN DESCRIBED ABOVE.


THE FIELD PORTION OF THIS SURVEY WAS PERFORMED DURING THE MONTH OF MAY, 2015.

PROJECT BENCHMARK:

CP 6, A BRASS CAP IN THE NORTHEAST CORNER OF A SANITARY SEWER MANHOLE STRUCTURE, PER THE CITY OF PHOENIX SKY HARBOR INTERNATIONAL AIRPORT CONTROL PLAN DATED SEPTEMBER 27, 2001 BY AZTEC ENGINEERING, PROJECT NO. AZ0011402 HAVING AN ELEVATION OF 1123.93.

◆ GRID CONTROL POINTS				
POINT NO.	NORTHING	EASTING	ELEVATION	DESCRIPTION
101	884605.90	676391.79	1129.09	SET-PK NAIL IN ASPHALT
103	884390.68	676393.22	1129.18	SET-PK NAIL IN ASPHALT
105	884610.48	675669.54	1127.25	SET-PK NAIL IN ASPHALT
108	884390.02	675155.61	1125.90	SET-PK NAIL IN ASPHALT
2007	884496.84	676708.10	1132.07	FOUND BRASS CAP FLUSH R25
2008	883965.04	676620.14	1123.94	FOUND AZTEC CP#6 PROJ. BM

▲ SURVEY CONTROL POINTS				
POINT NO.	NORTHING	EASTING	ELEVATION	DESCRIPTION
102	884791.74	676489.31	1127.74	SET-PK NAIL IN ASPHALT
104	884204.55	676490.22	1125.62	SET-PK NAIL IN ASPHALT
106	884838.92	675439.45	1125.79	SET-PK NAIL IN ASPHALT
107	884812.57	675218.57	1124.89	SET-PK NAIL IN ASPHALT
109	884164.96	675407.36	1123.76	SET-PK NAIL IN ASPHALT
110	884385.25	675675.14	1127.19	SET-PK NAIL IN ASPHALT

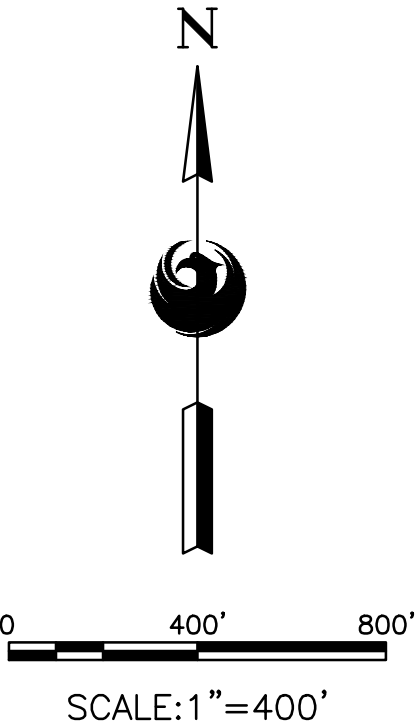

PRIME CONSULTANT
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1201 E. Jefferson St., Suite 1 Phoenix, AZ 85005

SUB CONSULTANT

REGISTERED LAND SURVEYOR
PHILIP R. ANDERSON
No. 12345
Arizona

PER CITY OF PHOENIX CITY CODE CHAPTER 2, SECTION 2-2-28, THESE PLANS ARE FOR OFFICIAL USE ONLY AND MAY NOT BE SHARED WITH OTHERS EXCEPT AS REQUIRED TO FULFILL THE OBLIGATIONS OF CONTRACTOR'S CONTRACT WITH THE CITY OF PHOENIX.

NO	REVISIONS / SUBMISSIONS	DATE



Designed by: C. SHAW
Drawn by: A. SANTILLI
Checked by: C. JHAVERI
Date: 05/31/2023
Dwg scale: NTS

SURVEY CONTROL PLAN

SHEET REFERENCE NUMBER:
VF-401

SHEET 7 OF 23


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TYPICAL SECTION A-A

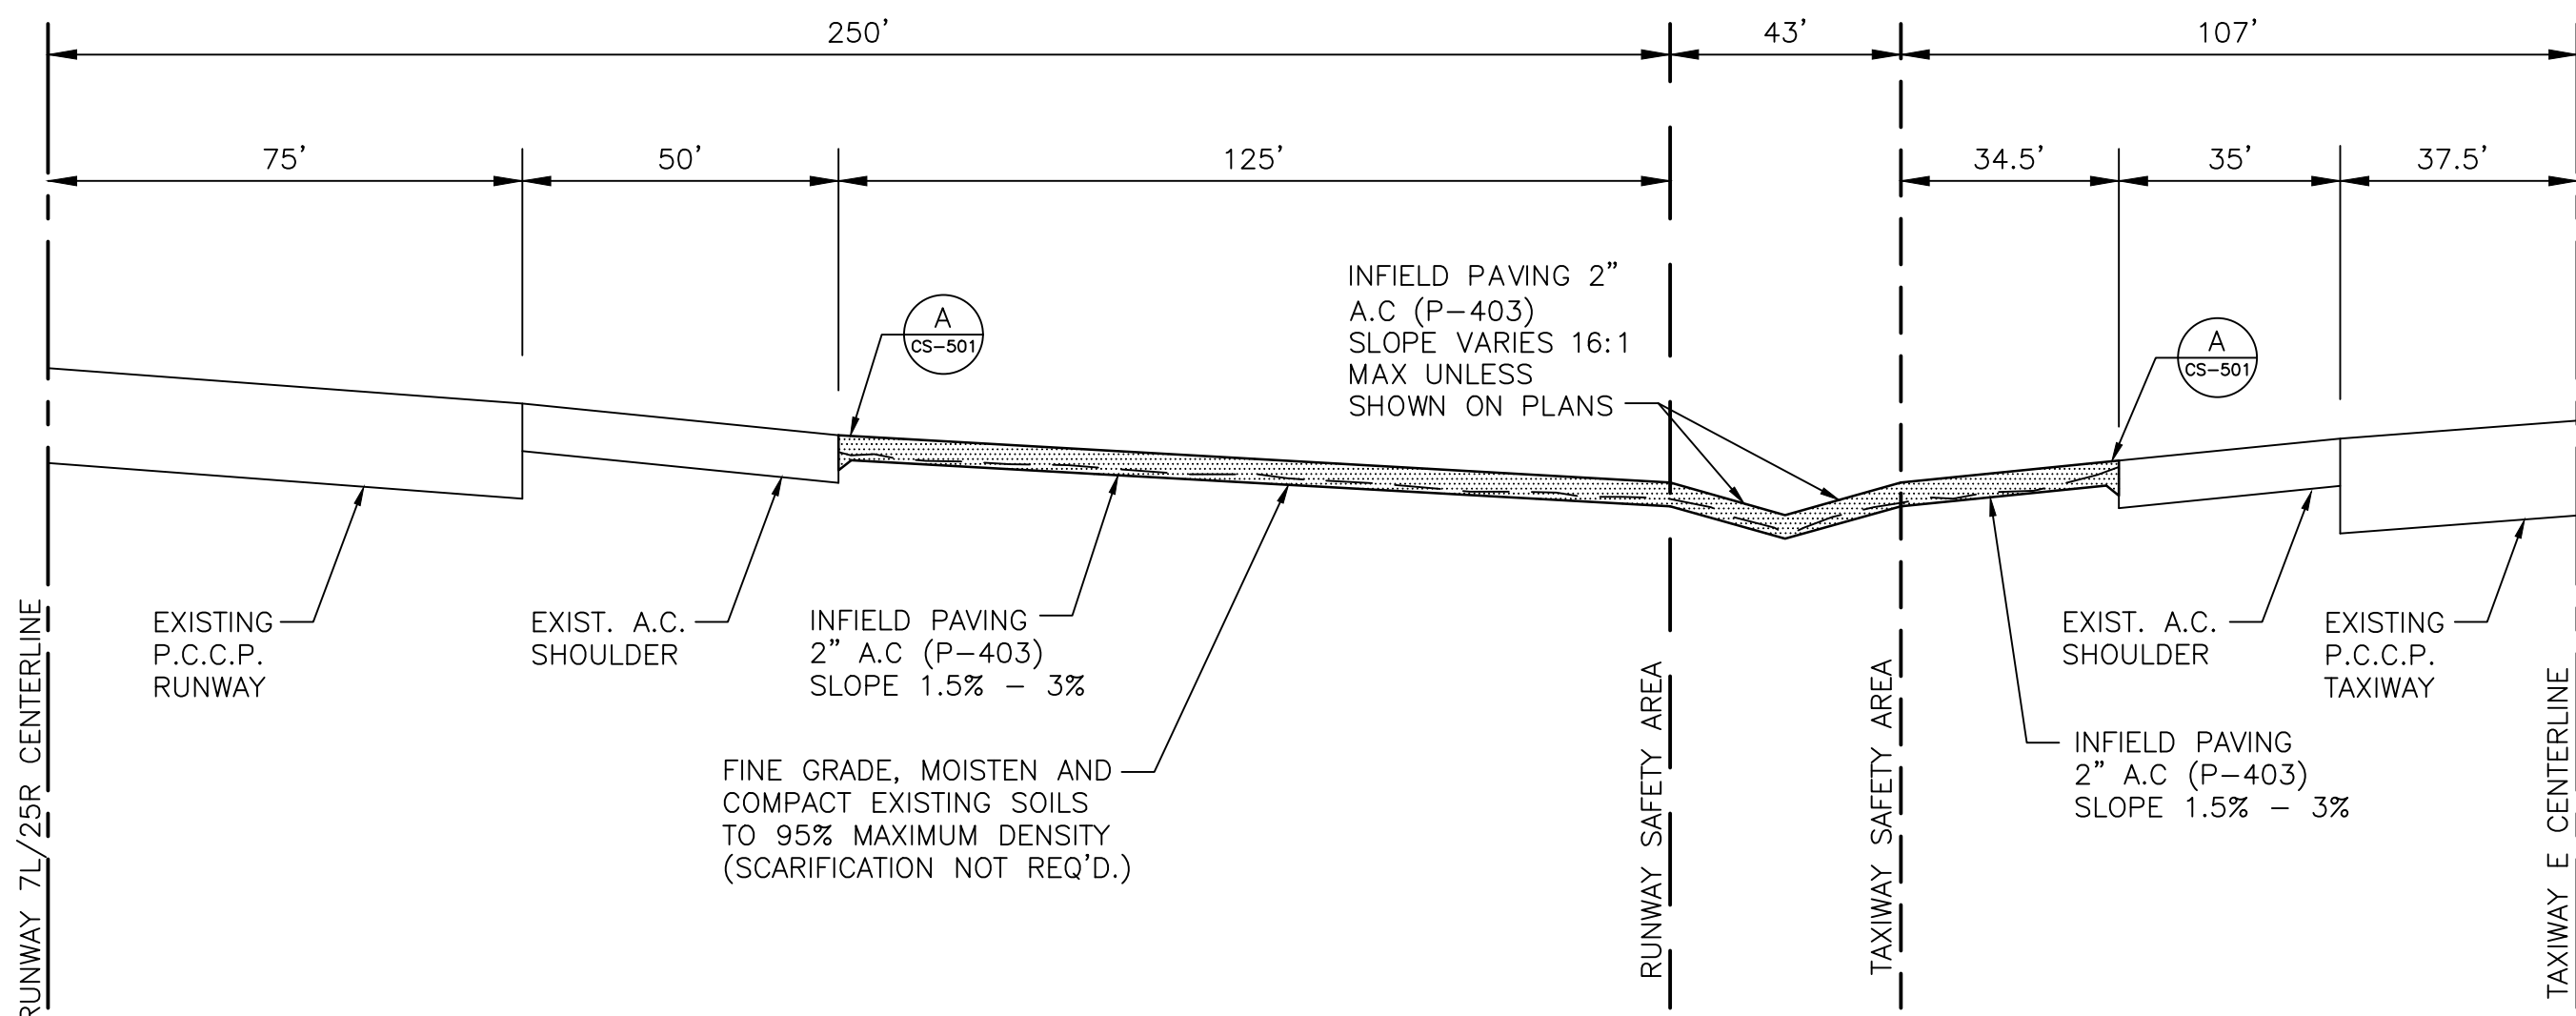
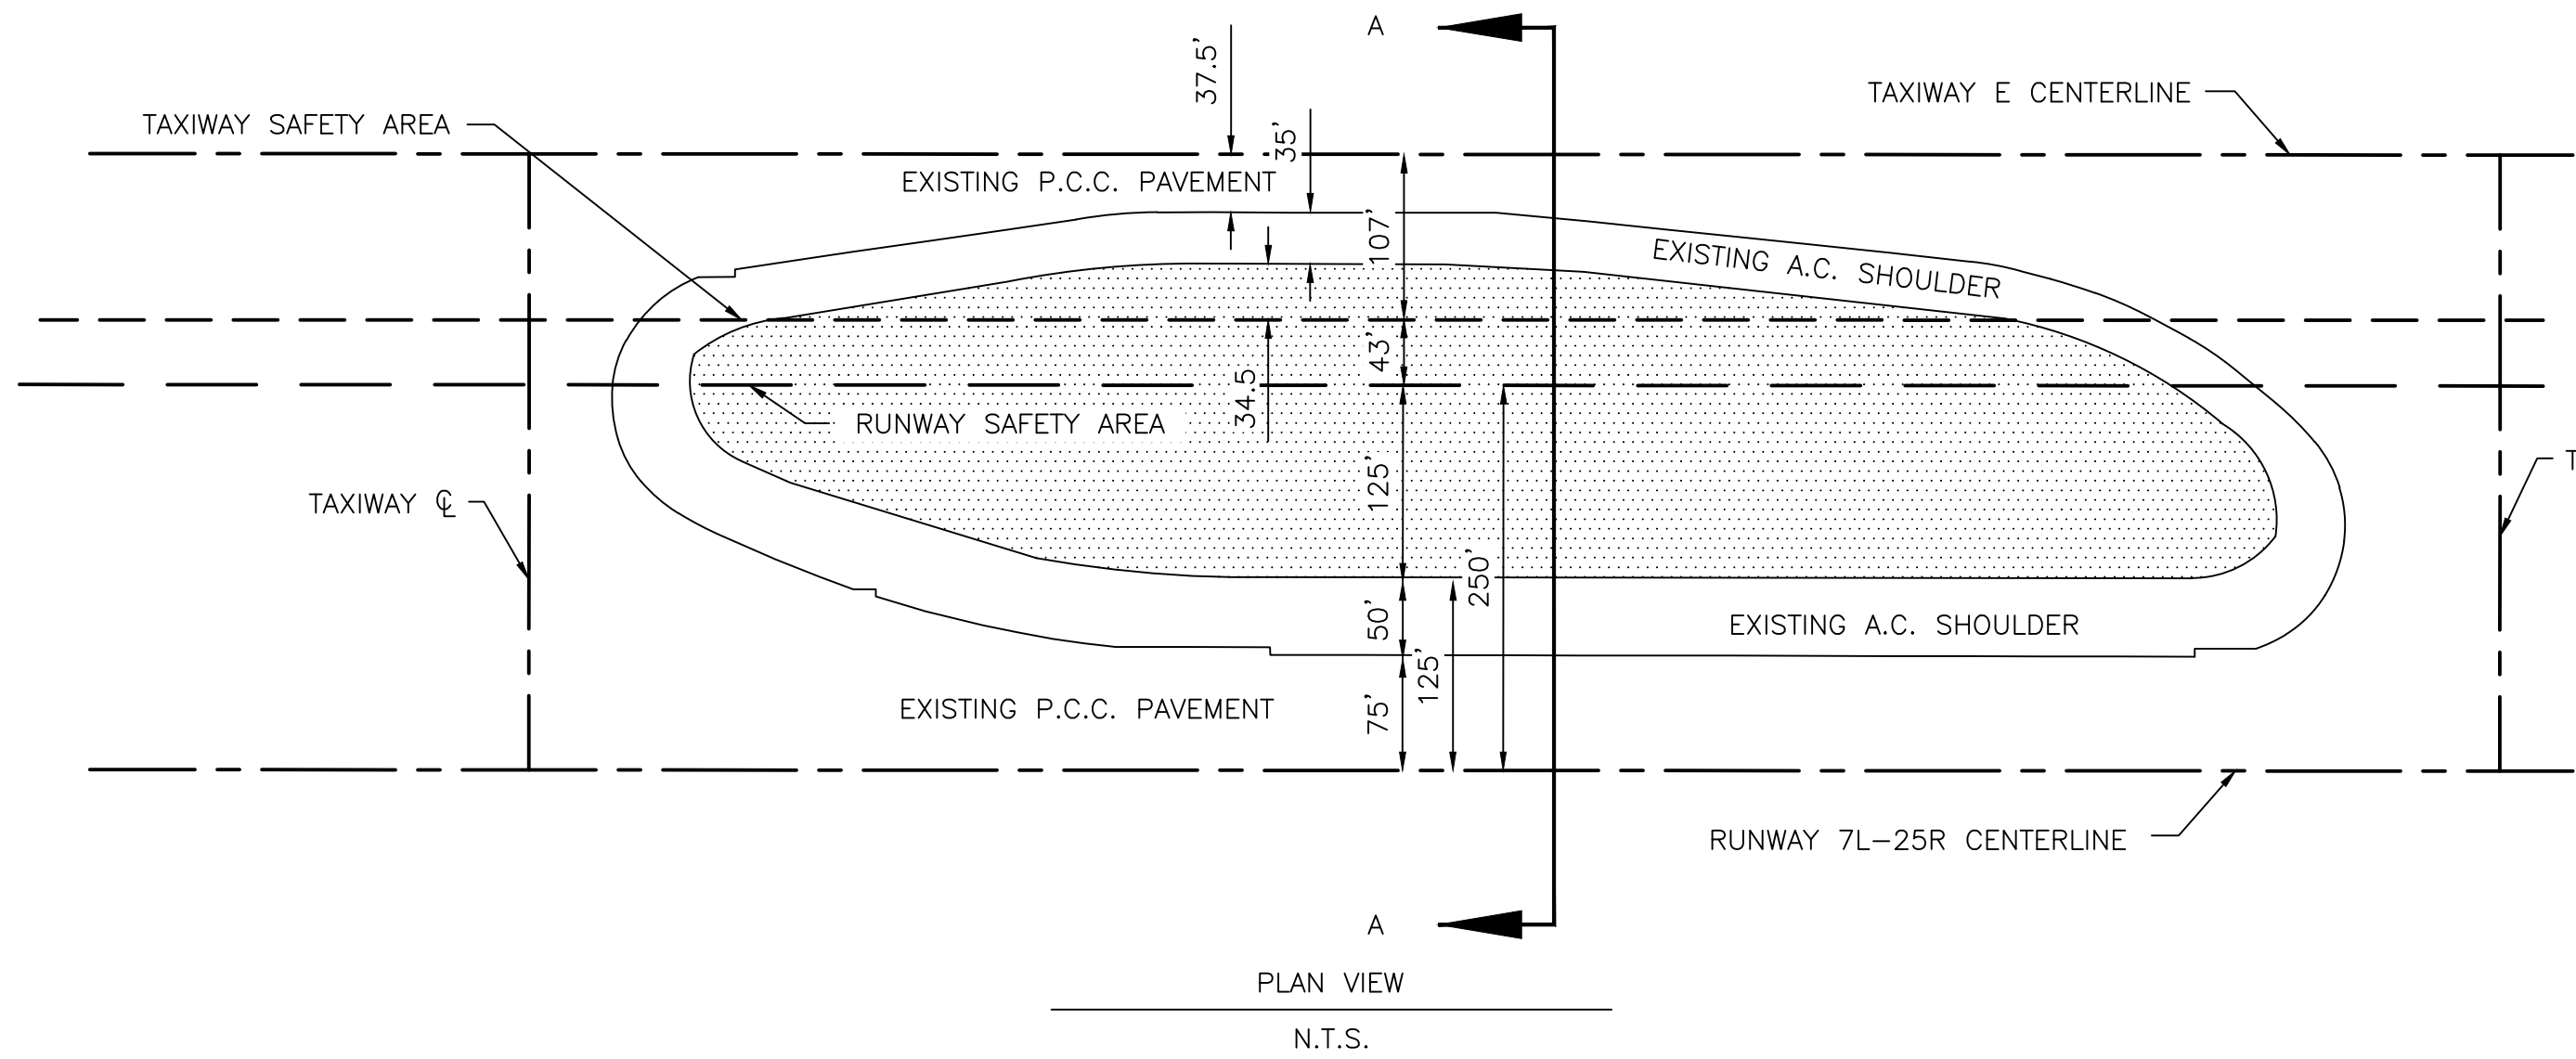
TYPICAL "E" INFIELD DETAIL

N.T.S.



(A) MATCH EXISTING PAVEMENT DETAIL

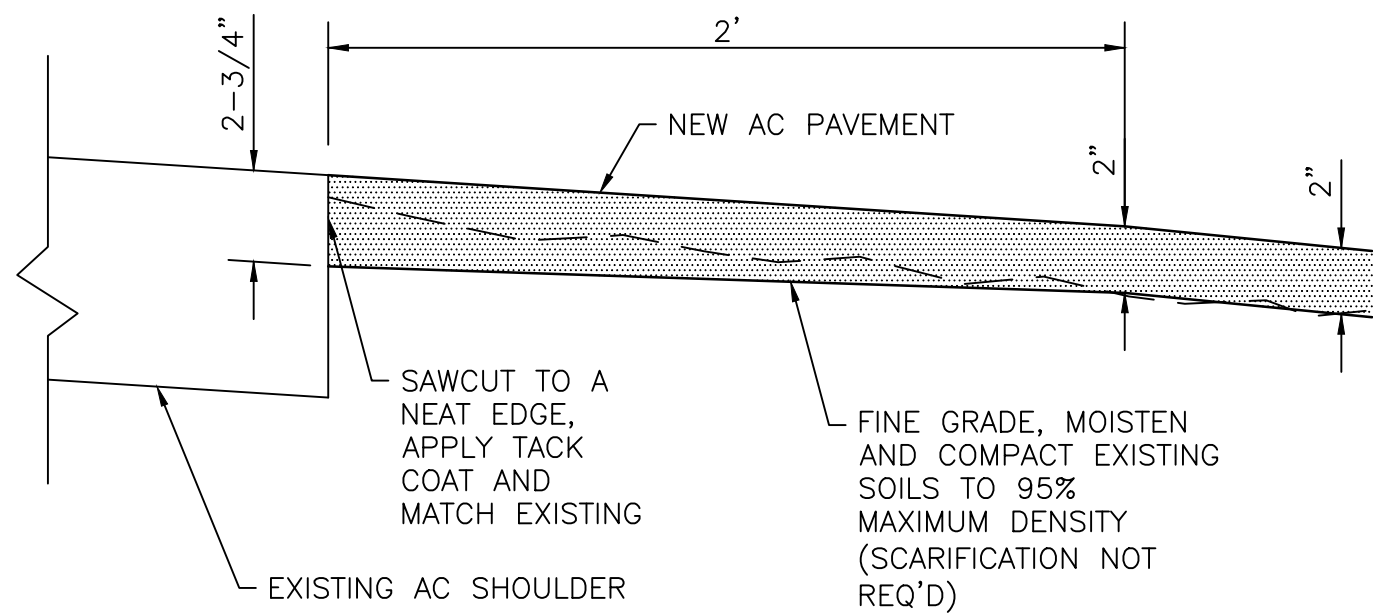
N.T.S.

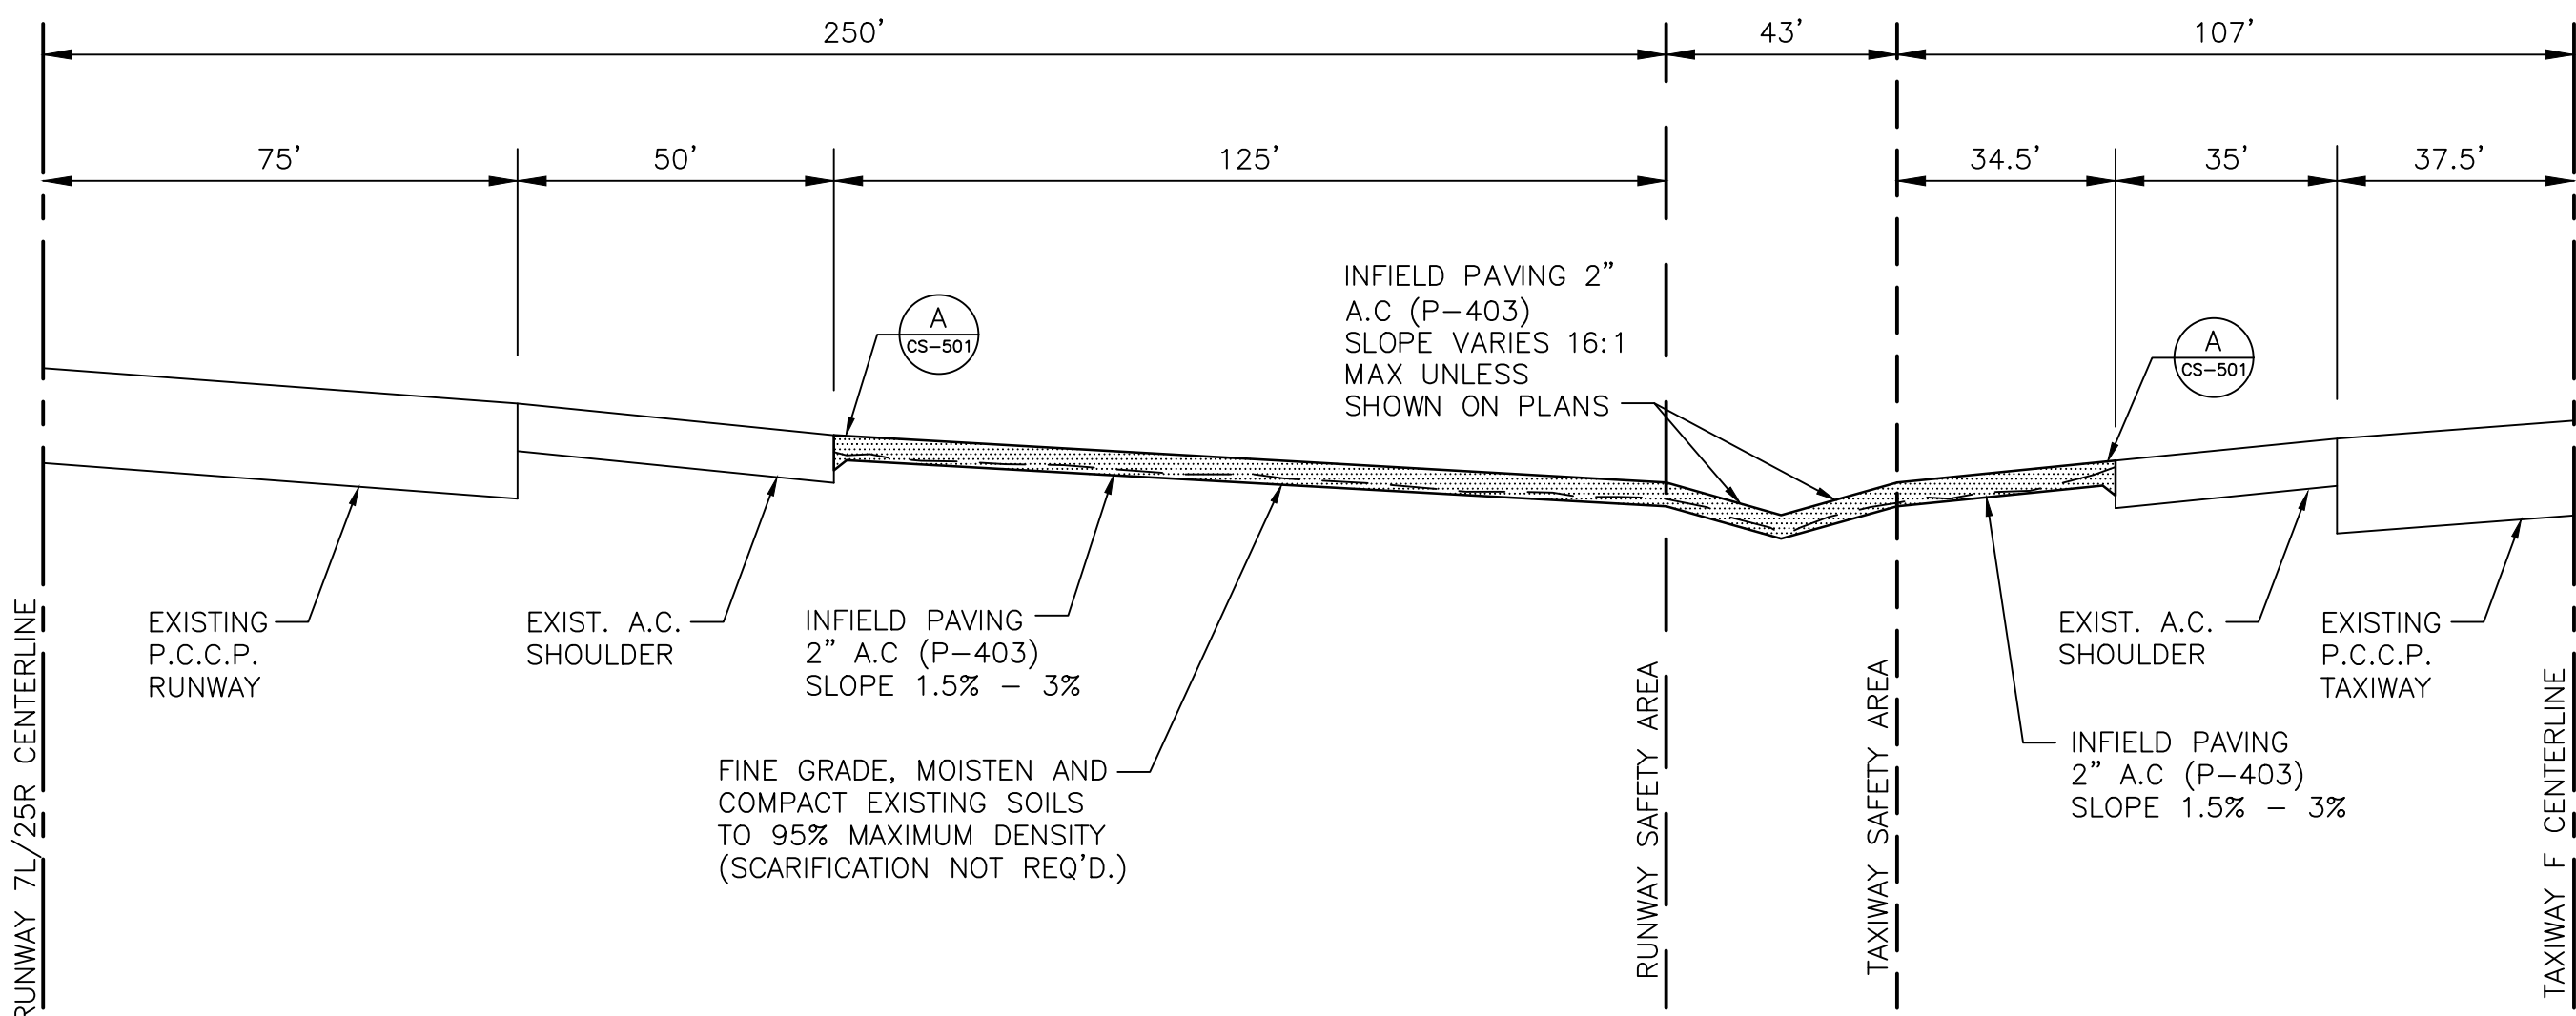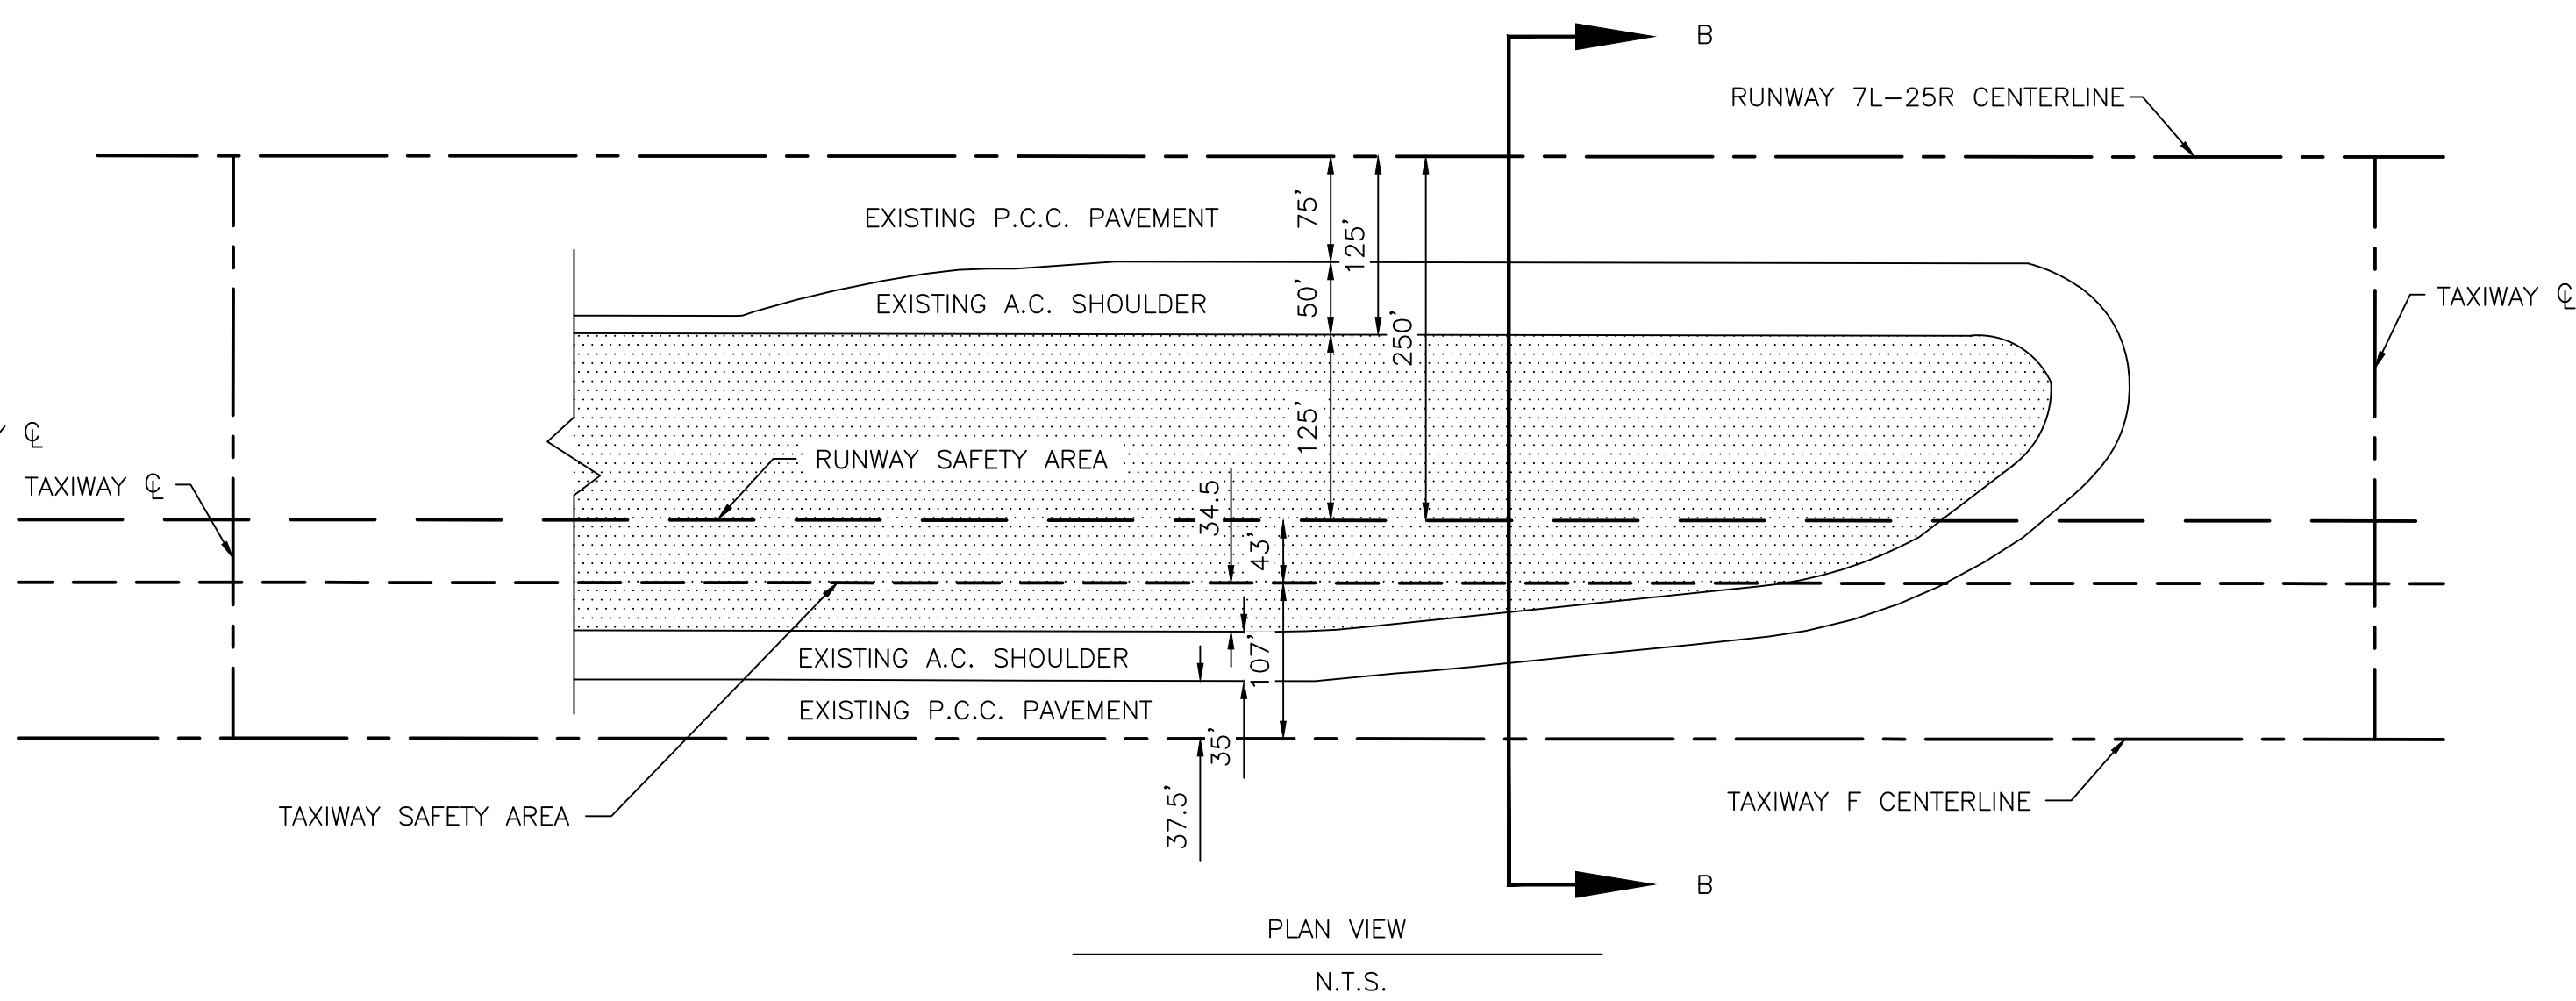

TYPICAL SECTION B-B

TYPICAL "F" INFIELD DETAIL

N.T.S.

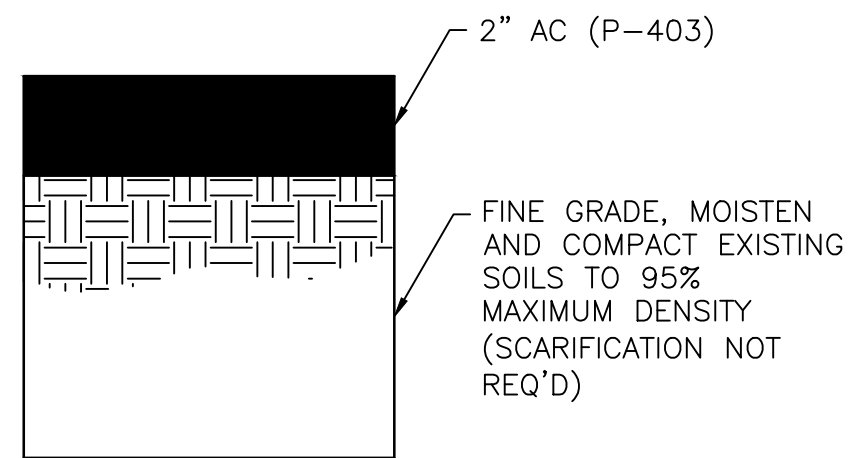


STRUCTURAL SECTION NO. 1


N.T.S.

PRIME CONSULTANT TRACE CONSULTING 1201 E. Jefferson St., Suite 1 Phoenix, AZ 85005		SUB CONSULTANT	
PER CITY OF PHOENIX CITY CODE CHAPTER 2, SECTION 2-2-28, THESE PLANS ARE FOR OFFICIAL USE ONLY AND MAY NOT BE SHARED WITH OTHERS EXCEPT AS REQUIRED TO FULFILL THE OBLIGATIONS OF CONTRACTOR'S CONTRACT WITH THE CITY OF PHOENIX.			
DESIGNED BY: C. SHAW		DRAWN BY: A. SANTILLI	
CHECKED BY: C. JHAVERI		DATE: 05/31/2023	
DWG SCALE: NTS			
SHEET OVERVIEW TITLE		TYPICAL SECTIONS	
SHEET REFERENCE NUMBER:		CS-501	
SHEET 8 OF 23			

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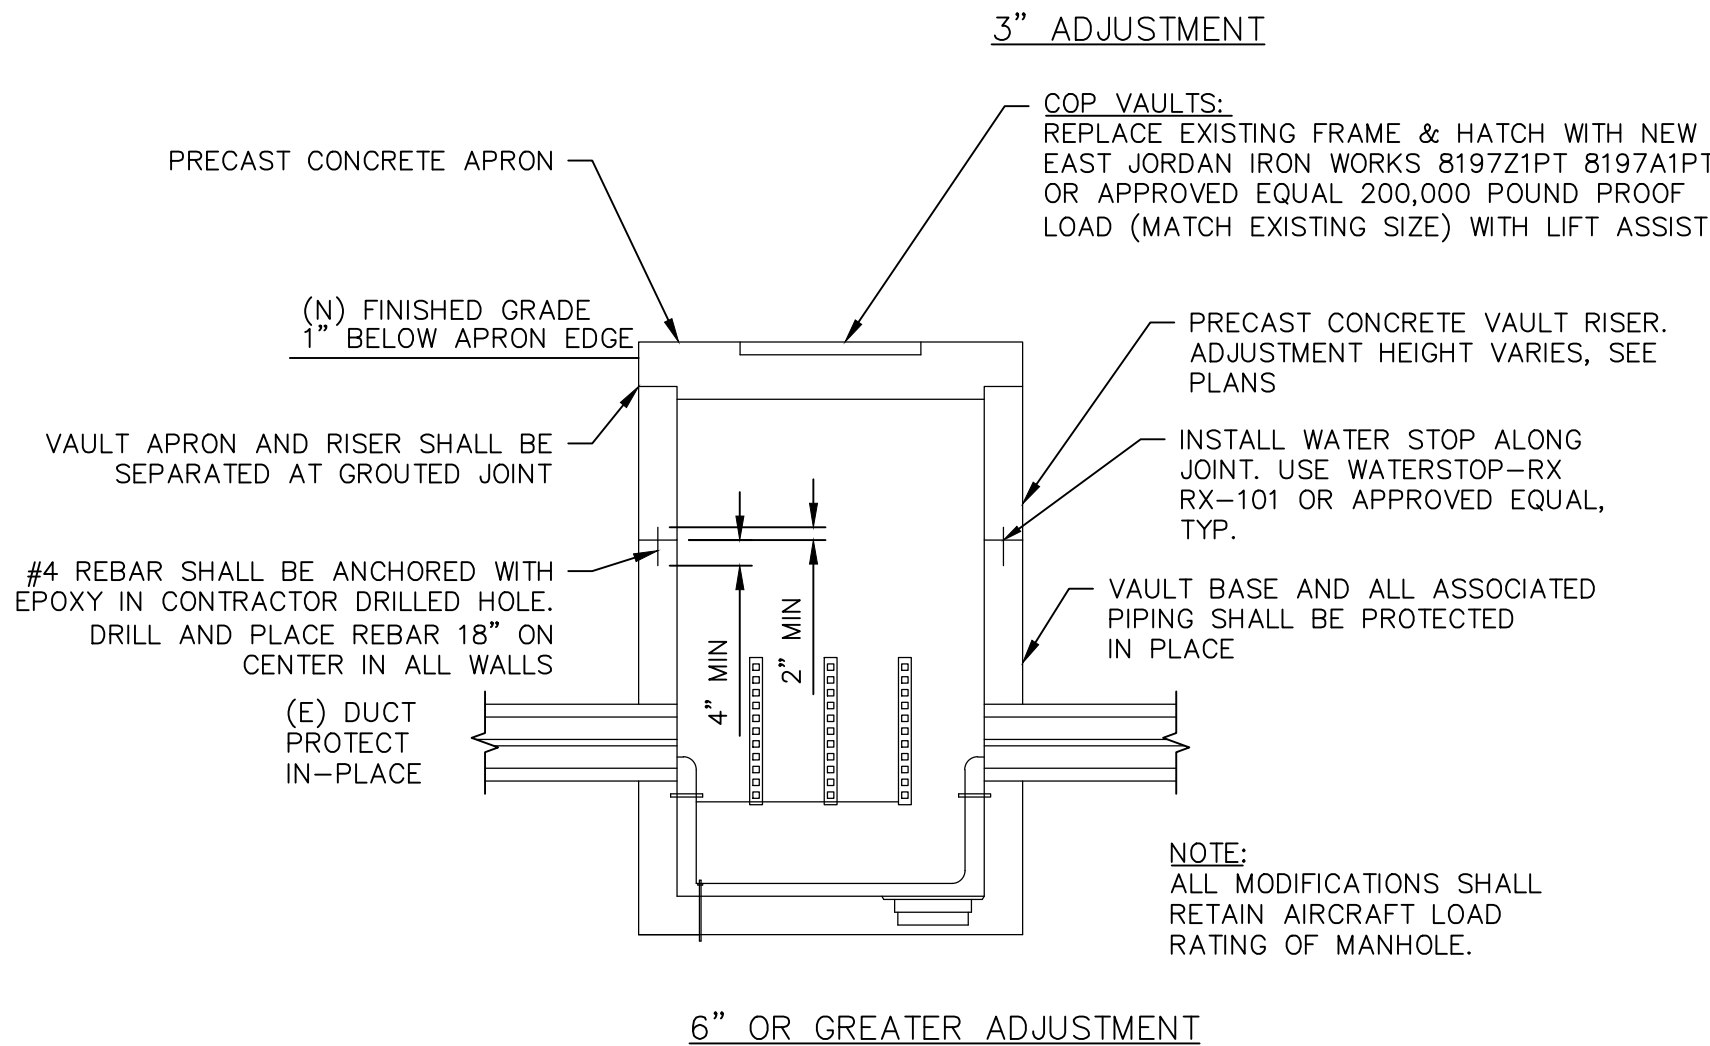
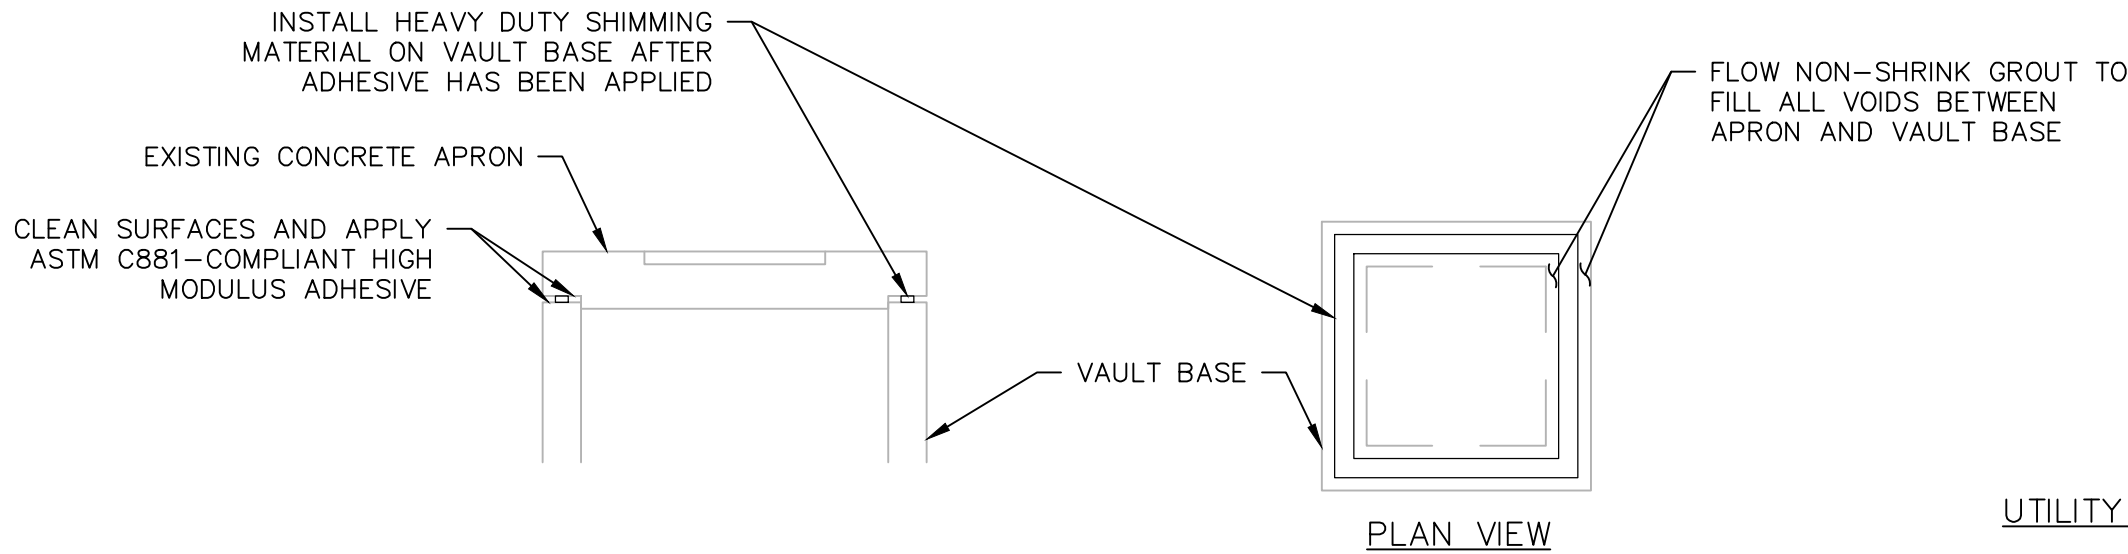
B SIGN BASE PAVING DETAIL
N.T.S.

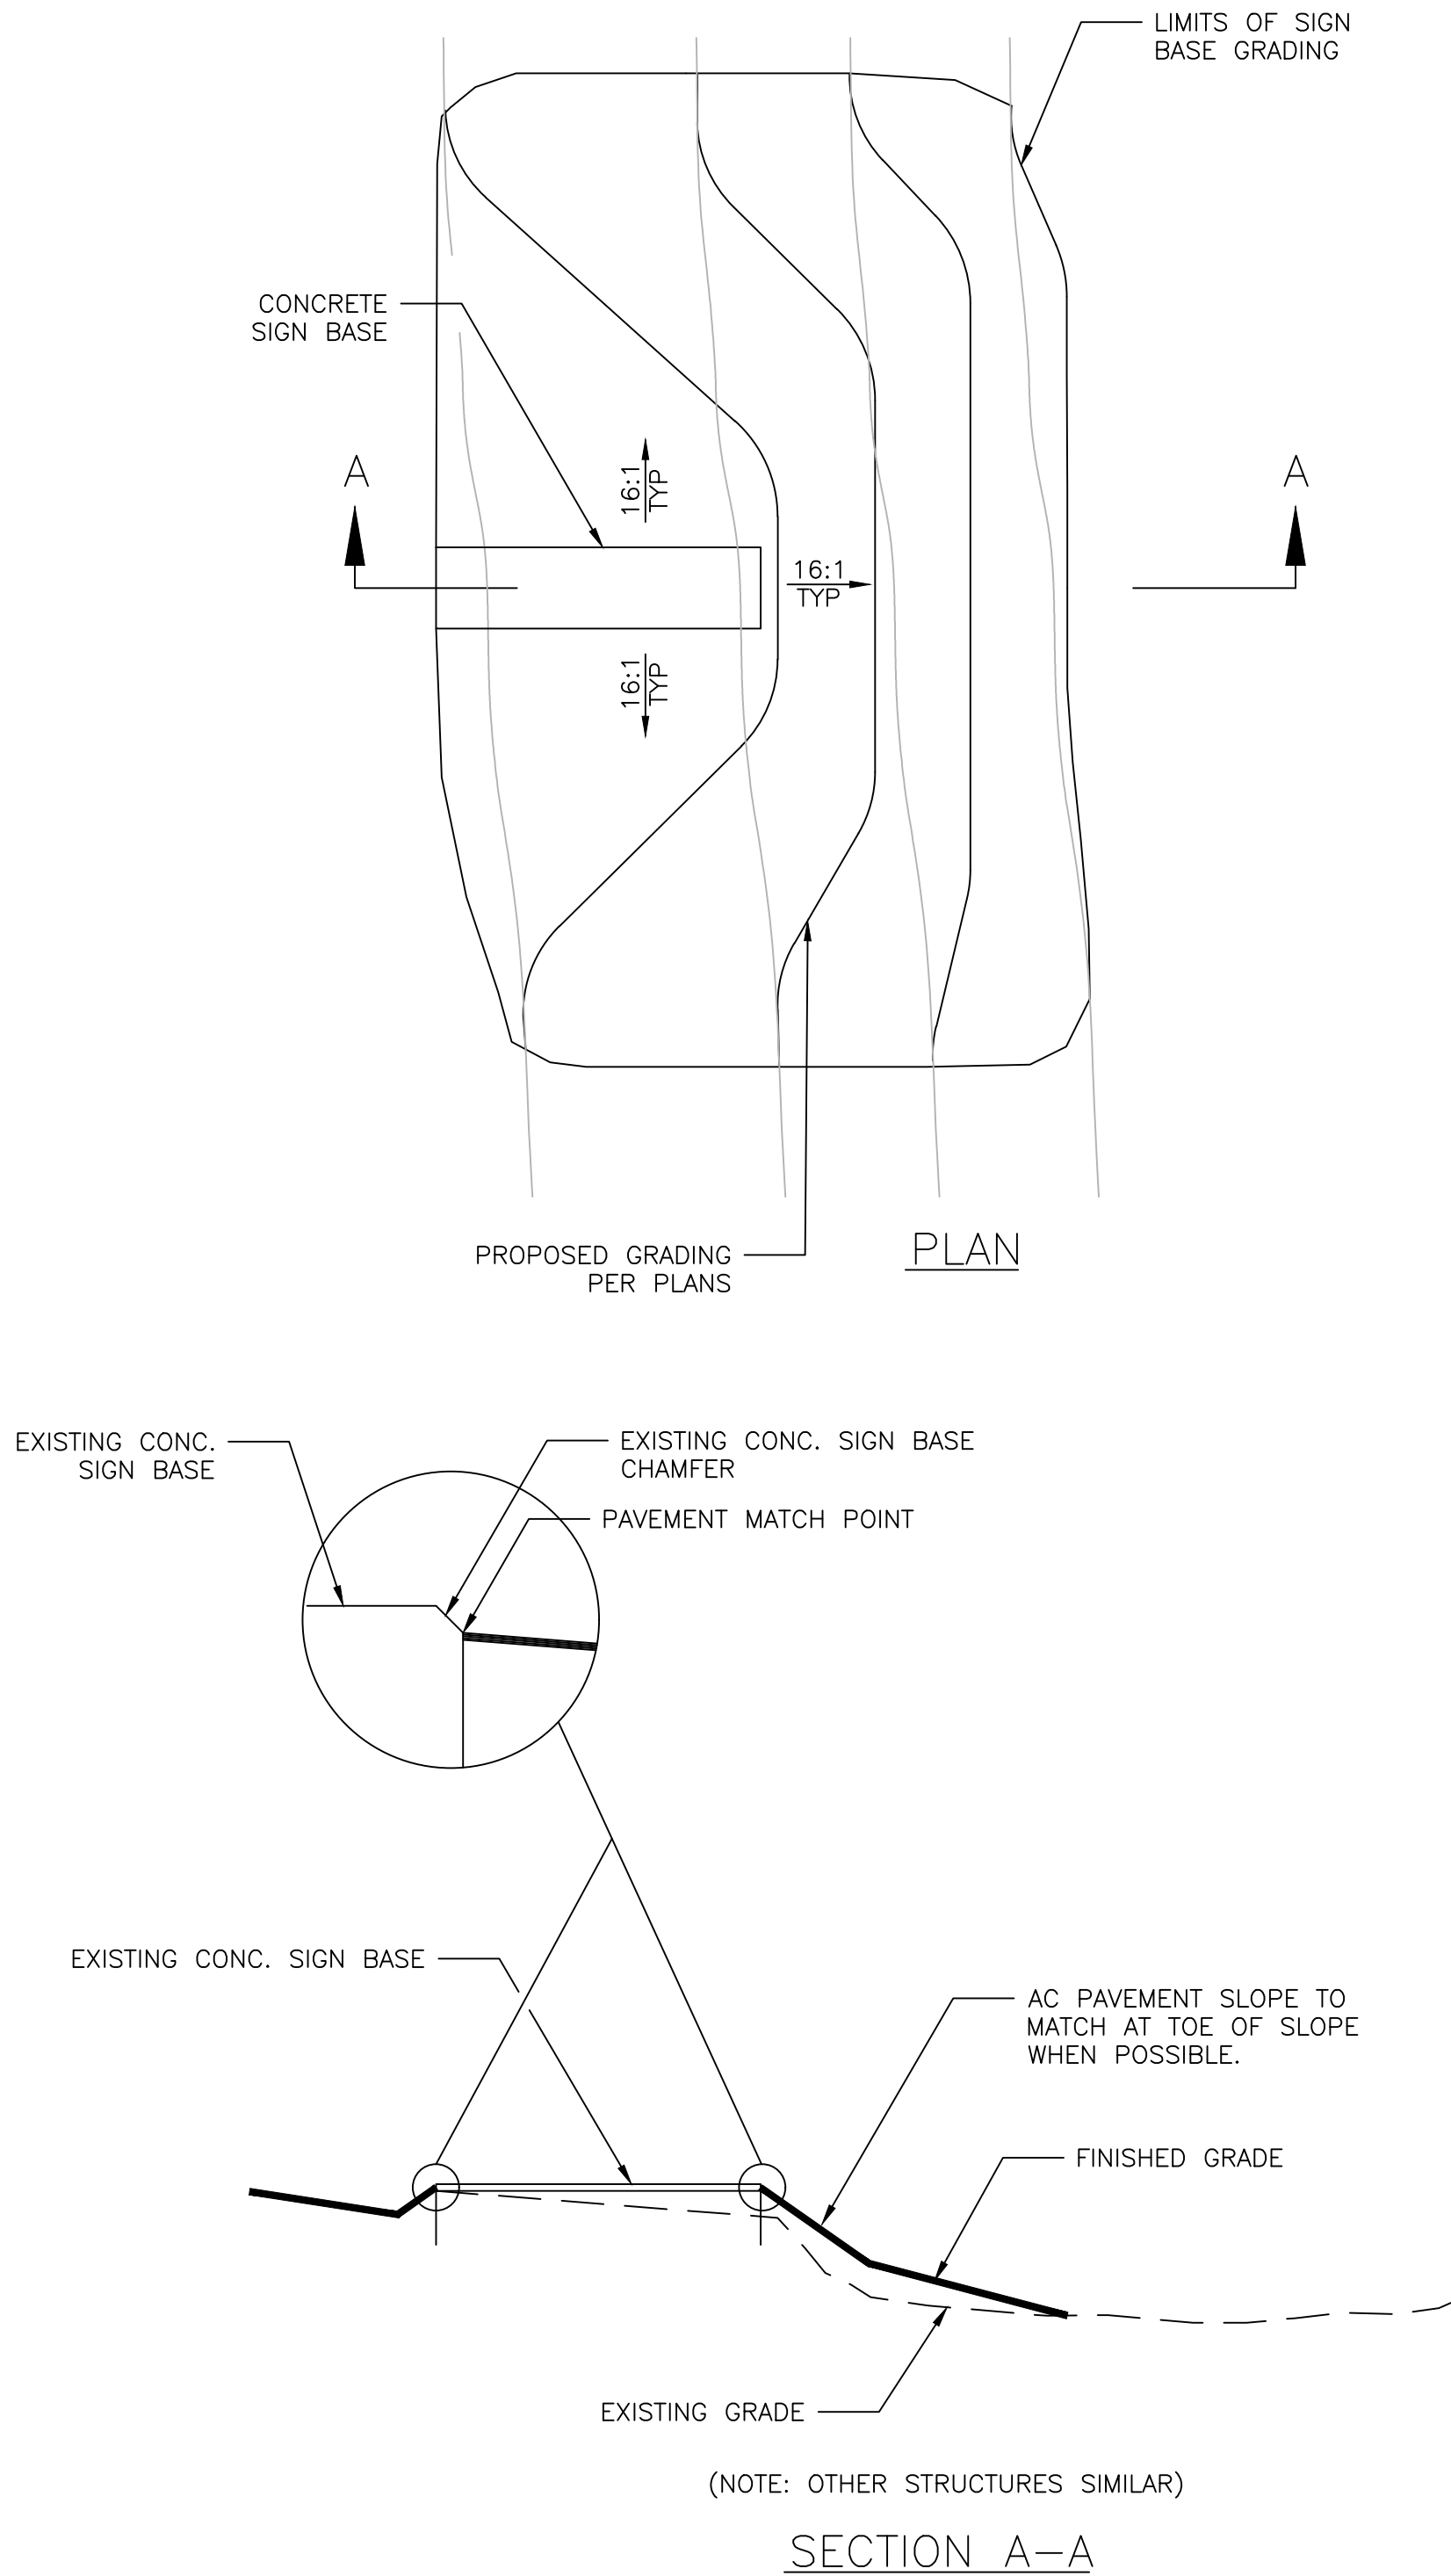

C STRUCTURE PAVING DETAIL
N.T.S.

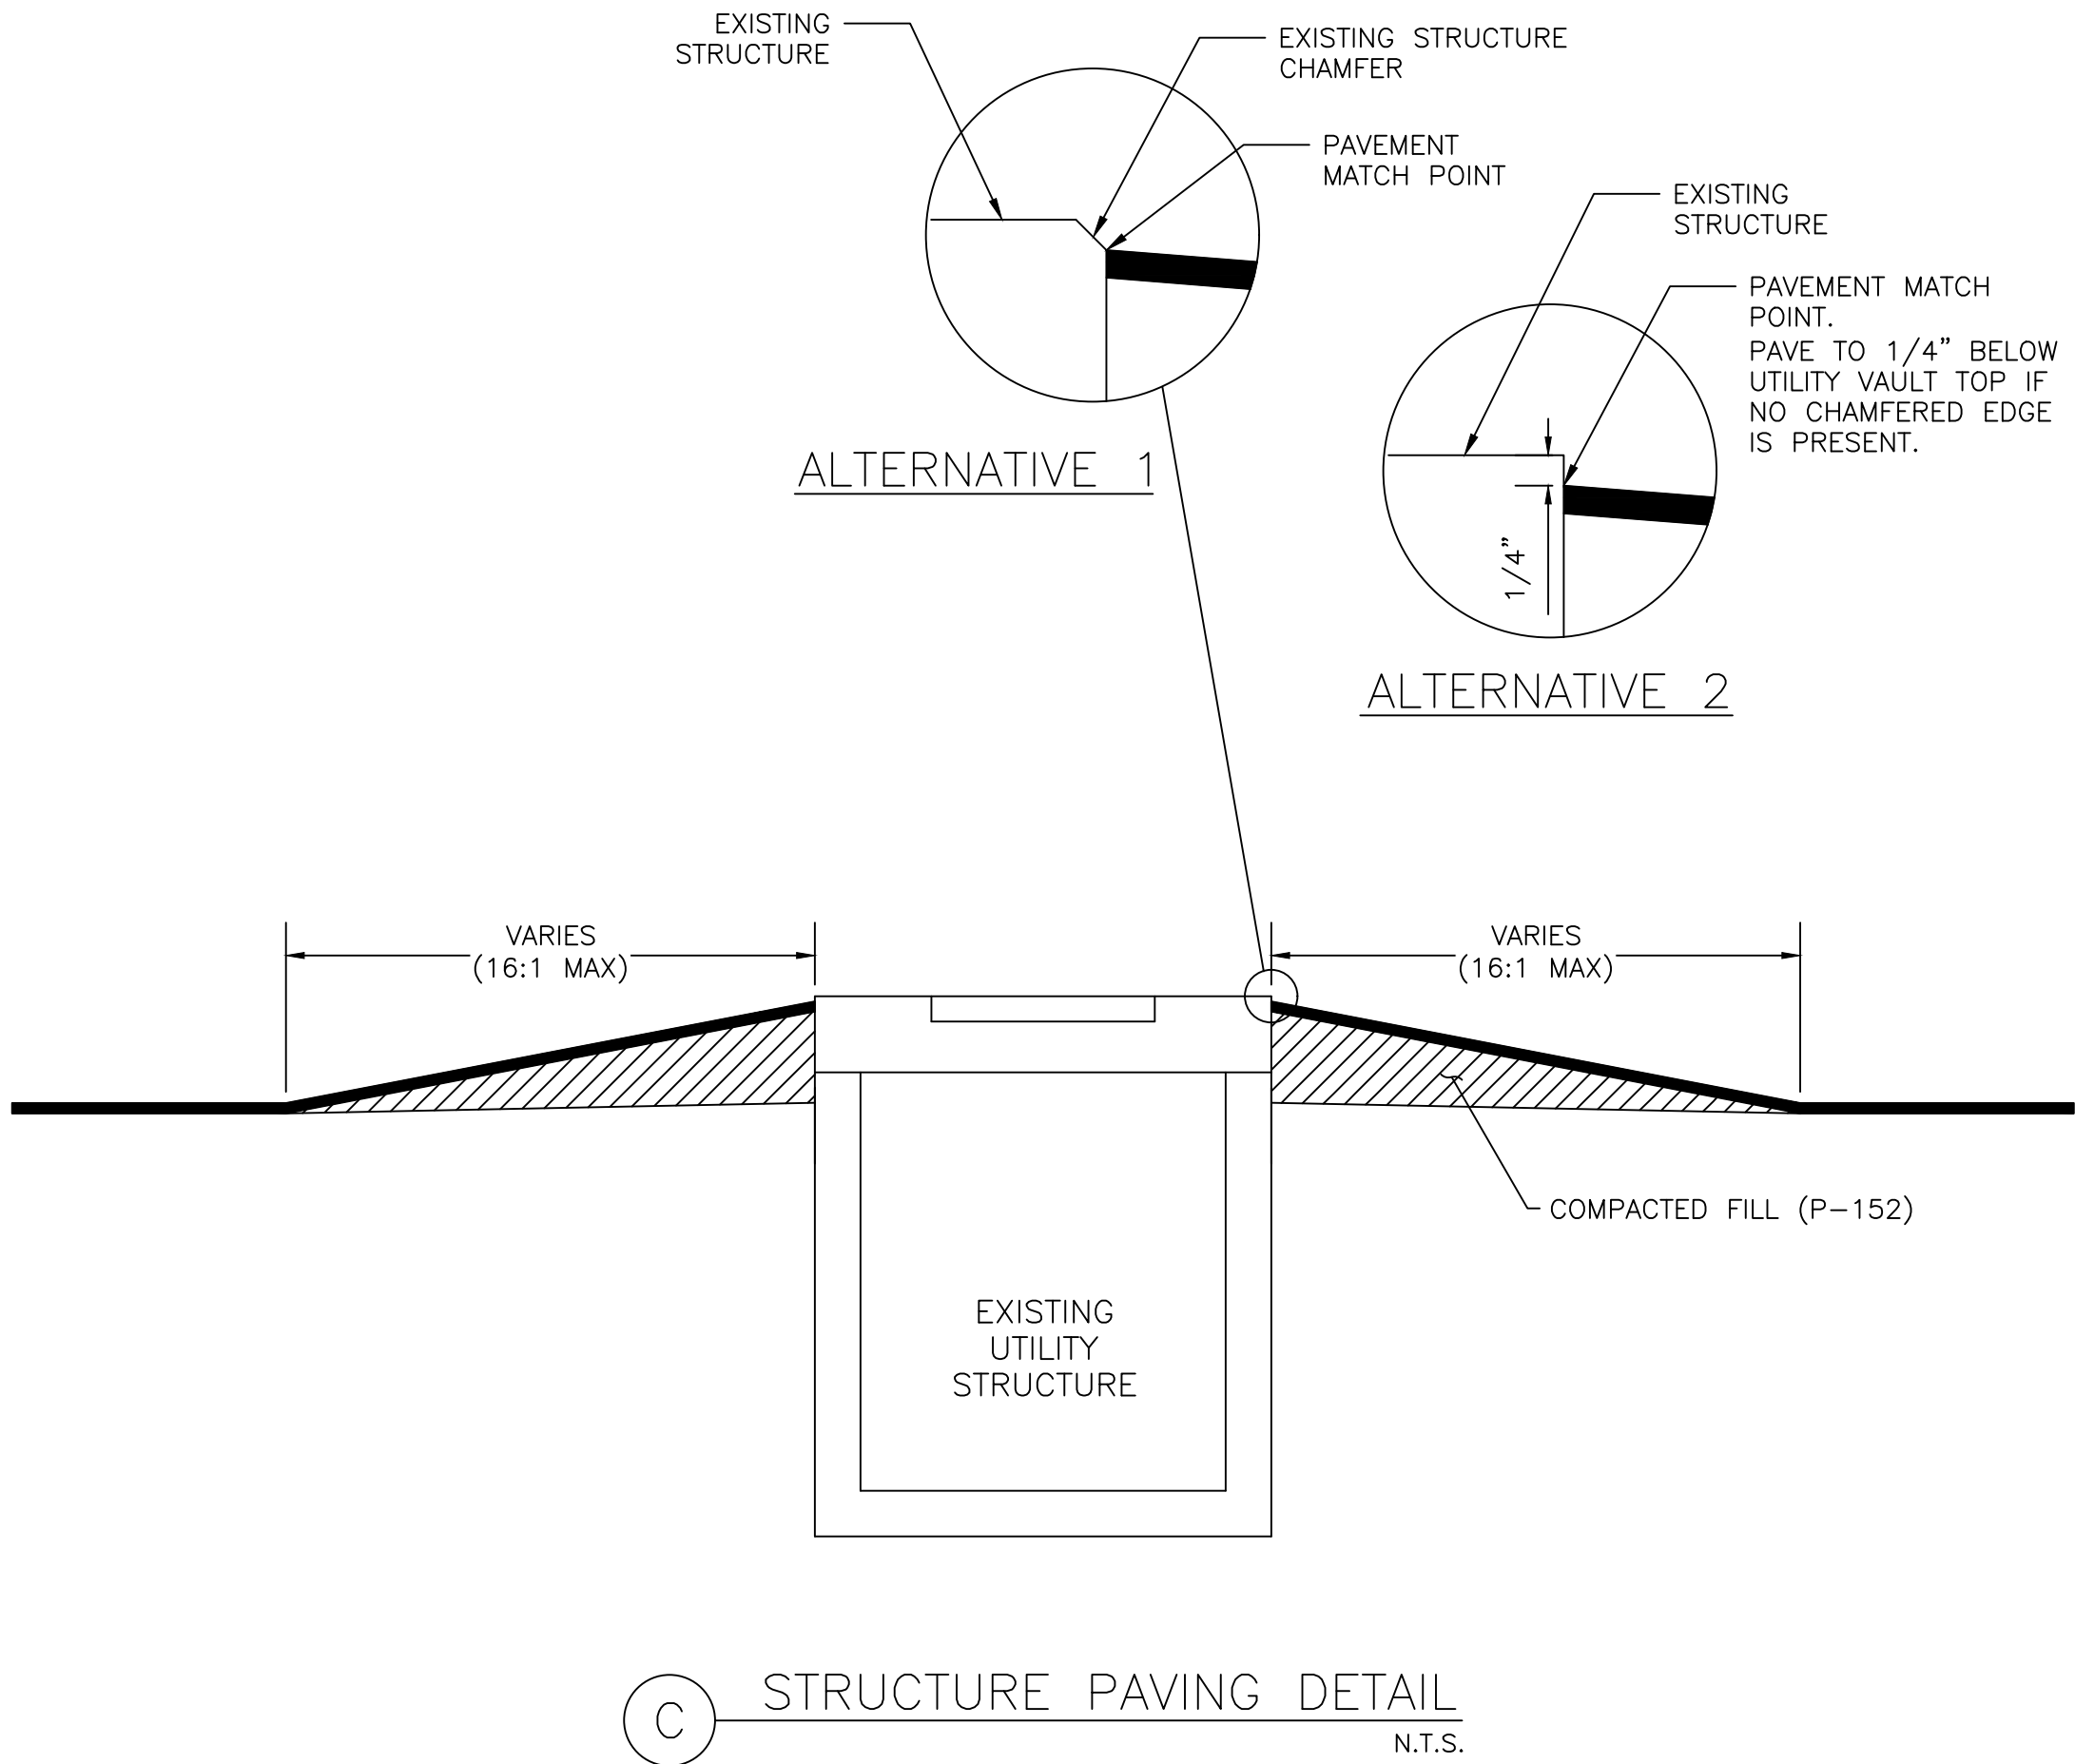SHEET OVERVIEW TITLE	PAVING DETAILS				SHEET REFERENCE NUMBER: CS-502 SHEET 9 OF 23
	DESIGNED BY: C. SHAW DRAWN BY: A. SANTILLI CHECKED BY: C. JHAVERI DATE: 05/31/2023 DWG SCALE: NTS				
PRIME CONSULTANT		SUB CONSULTANT		REVISIONS / SUBMISSIONS	
TRACE CONSULTING 1301 E. Jefferson St., Suite 1 Phoenix, AZ 85005		PHX INVT BYR CITY OF PHOENIX AVIATION DEPARTMENT PSHIA INFIELD UTILITY ACCESS UPGRADES AND PAVING AV 08000074 ADOT ADOT GRANT NO.: XXXXXXX		NO	
PER CITY OF PHOENIX CITY CODE CHAPTER 2, SECTION 2-2-28, THESE PLANS ARE FOR OFFICIAL USE ONLY AND MAY NOT BE SHARED WITH OTHERS EXCEPT AS REQUIRED TO FULFILL THE OBLIGATIONS OF CONTRACTOR'S CONTRACT WITH THE CITY OF PHOENIX.		DATE		NO	

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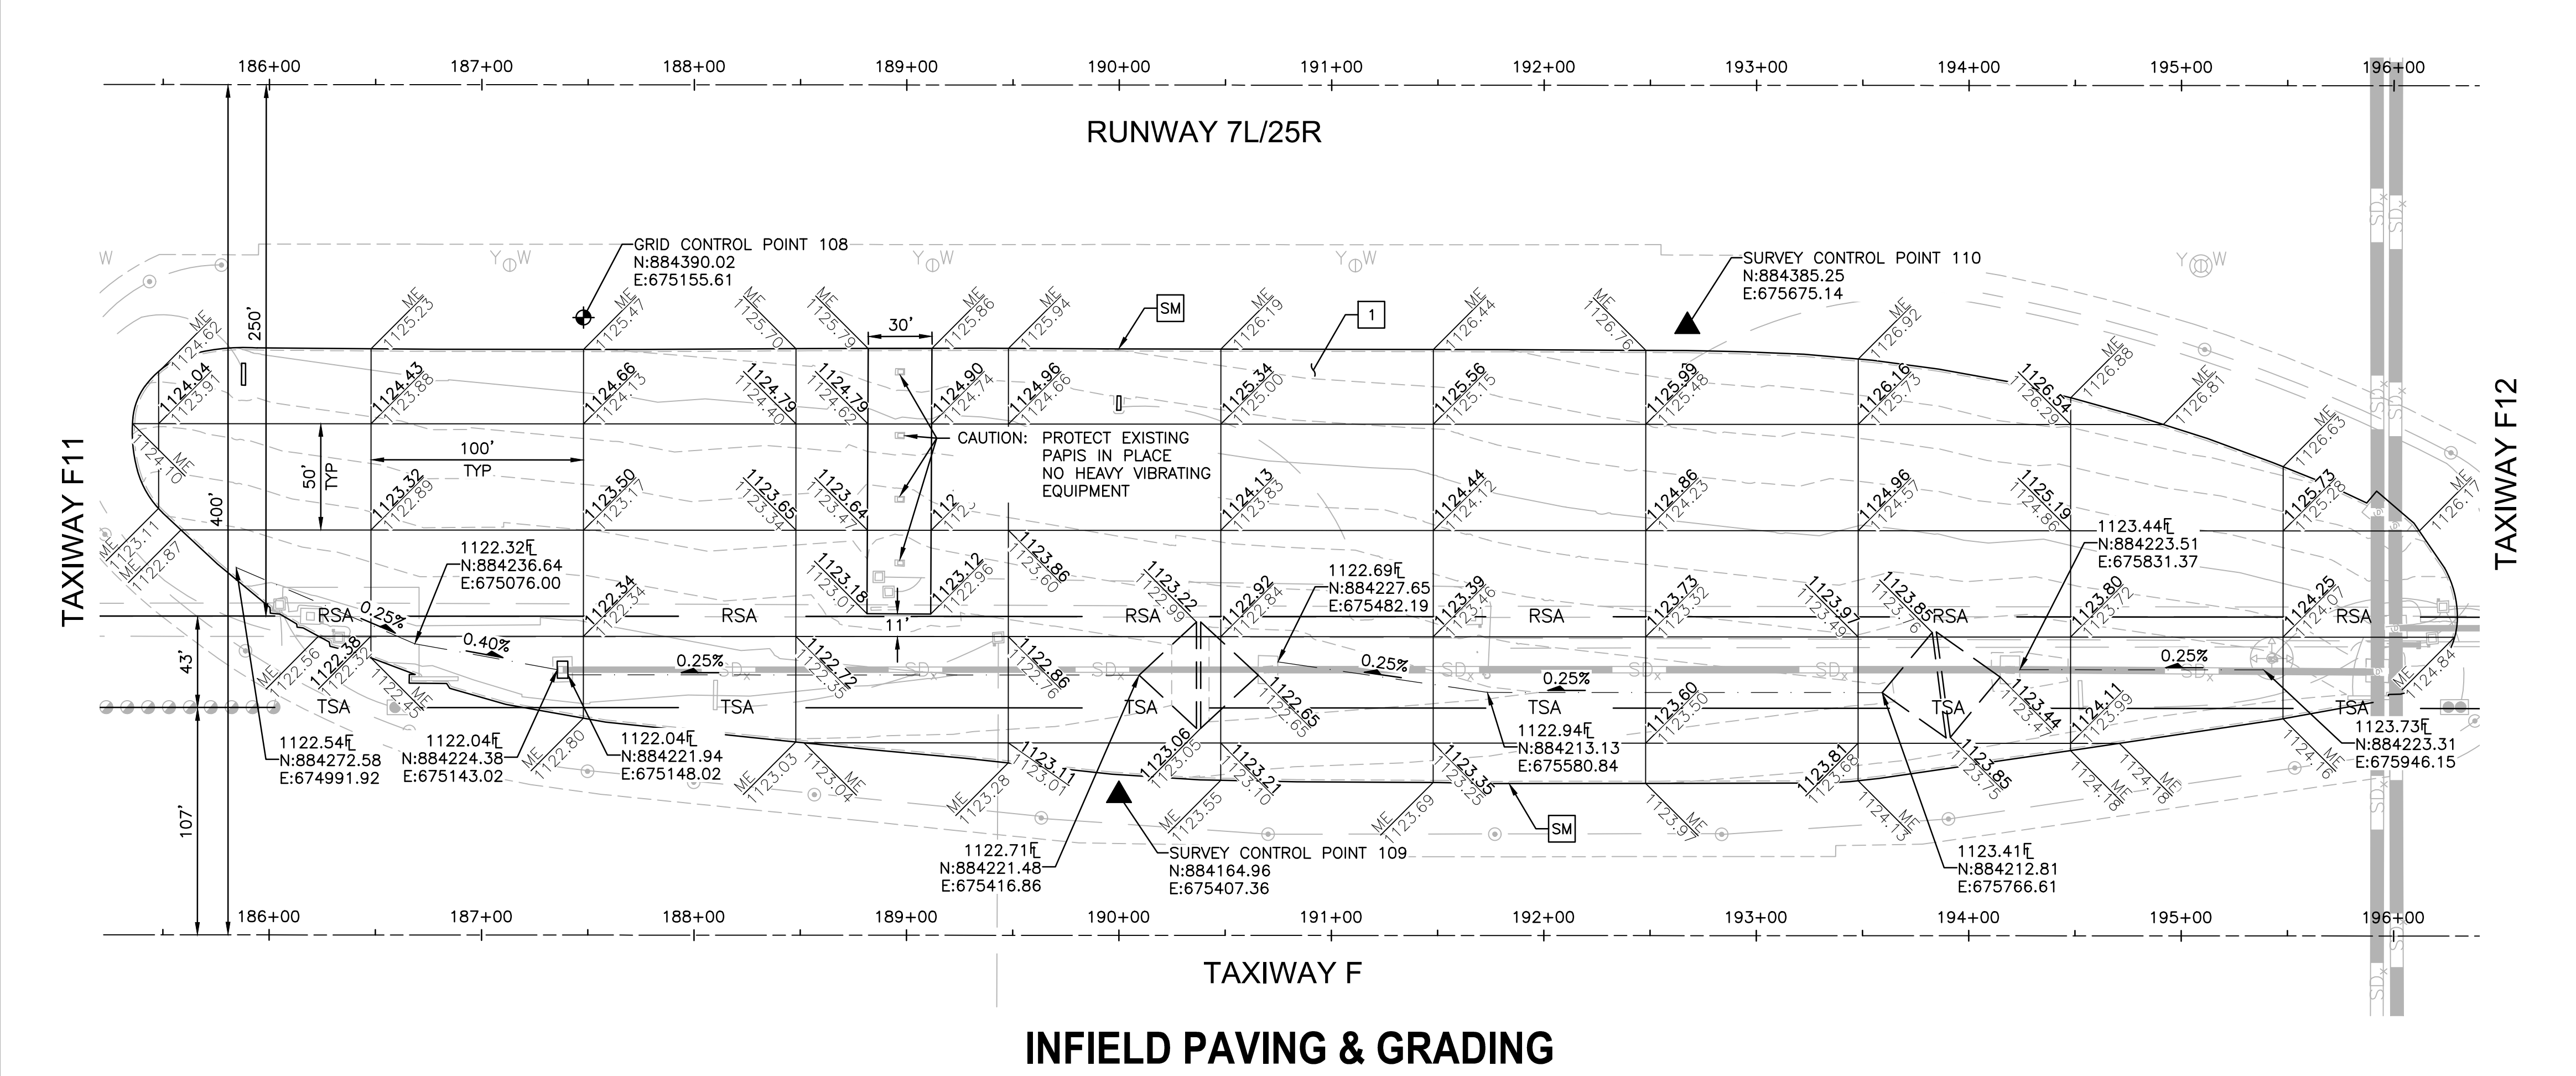
E UTILITY VAULT EXTENSION
N.T.S.

UTILITY VAULT NOTES


1. ALL STEEL, OTHER THAN REBAR, TO BE HOT DIPPED GALVANIZED AFTER FABRICATION.
2. GROUT ALL CONDUIT PENETRATIONS.
3. PROVIDE MANUFACTURER'S DRAWINGS AND STRUCTURAL CALCULATIONS FOR ALL CONCRETE ELEMENTS OF UTILITY VAULTS AND FABRICATED TRAFFIC LIDS.
4. DO NOT CONNECT COUNTERPOISE TO GROUNDING SYSTEM.
5. AFTER ADJUSTING THE UTILITY VAULT TO GRADE, THE CONTRACTOR SHALL REPLACE THE LADDER (SEE NOTE 6) AS NECESSARY TO ENSURE THAT IT IS THE CORRECT LENGTH FOR THE NEW DEPTH OF THE VAULT.
6. ALL REPLACED LADDERS TO BE FIBERGLASS WITH MOUNTED HOOKS AT TOP. A PERMANENT MOUNTED TOP STEP TO BE INSTALLED WITHIN THE VAULT COLLAR TO HOOK LADDERS TO.
7. ALL UTILITIES WITHIN EXISTING UTILITY VAULTS SHALL BE PROTECTED IN PLACE. EXISTING UTILITIES DAMAGED AS A RESULT OF CONSTRUCTION SHALL BE FIXED BY CONTRACTOR AT NO COST TO THE CITY.
8. THE HINGE OF THE LID SHALL BE FACING THE NEAREST RUNWAY OR PARALLEL TAXIWAY PAVEMENT.
9. REFER TO SHEET EA-502 FOR VAULT NAME PLATE INSTALLATION DETAIL.

SHEET OVERVIEW TITLE	UTILITY ADJUSTMENT DETAILS	SHEET REFERENCE NUMBER: CS-504	SHEET 11 OF 23	Designed by: C. SHAW	Drawn by: A. SANTILLI	Checked by: C. JHAVERI	Date: 05/31/2023	Dwg scale: NTS	CITY OF PHOENIX AVIATION DEPARTMENT PSHIA INFIELD UTILITY ACCESS UPGRADES AND PAVING AV 08000074 ADOT ADOT GRANT NO.: XXXXXXX	PHX MTI BYR	PRIME CONSULTANT TRACE CONSULTING 1201 E. Jefferson St., Suite 1 Phoenix, AZ 85005	SUB CONSULTANT
				PRIME CONSULTANT TRACE CONSULTING 1201 E. Jefferson St., Suite 1 Phoenix, AZ 85005								
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NO REVISIONS / SUBMISSIONS DATE												

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INFIELD PAVING & GRADING
INFIELD FN-11



UTILITY ACCESS UPGRADES

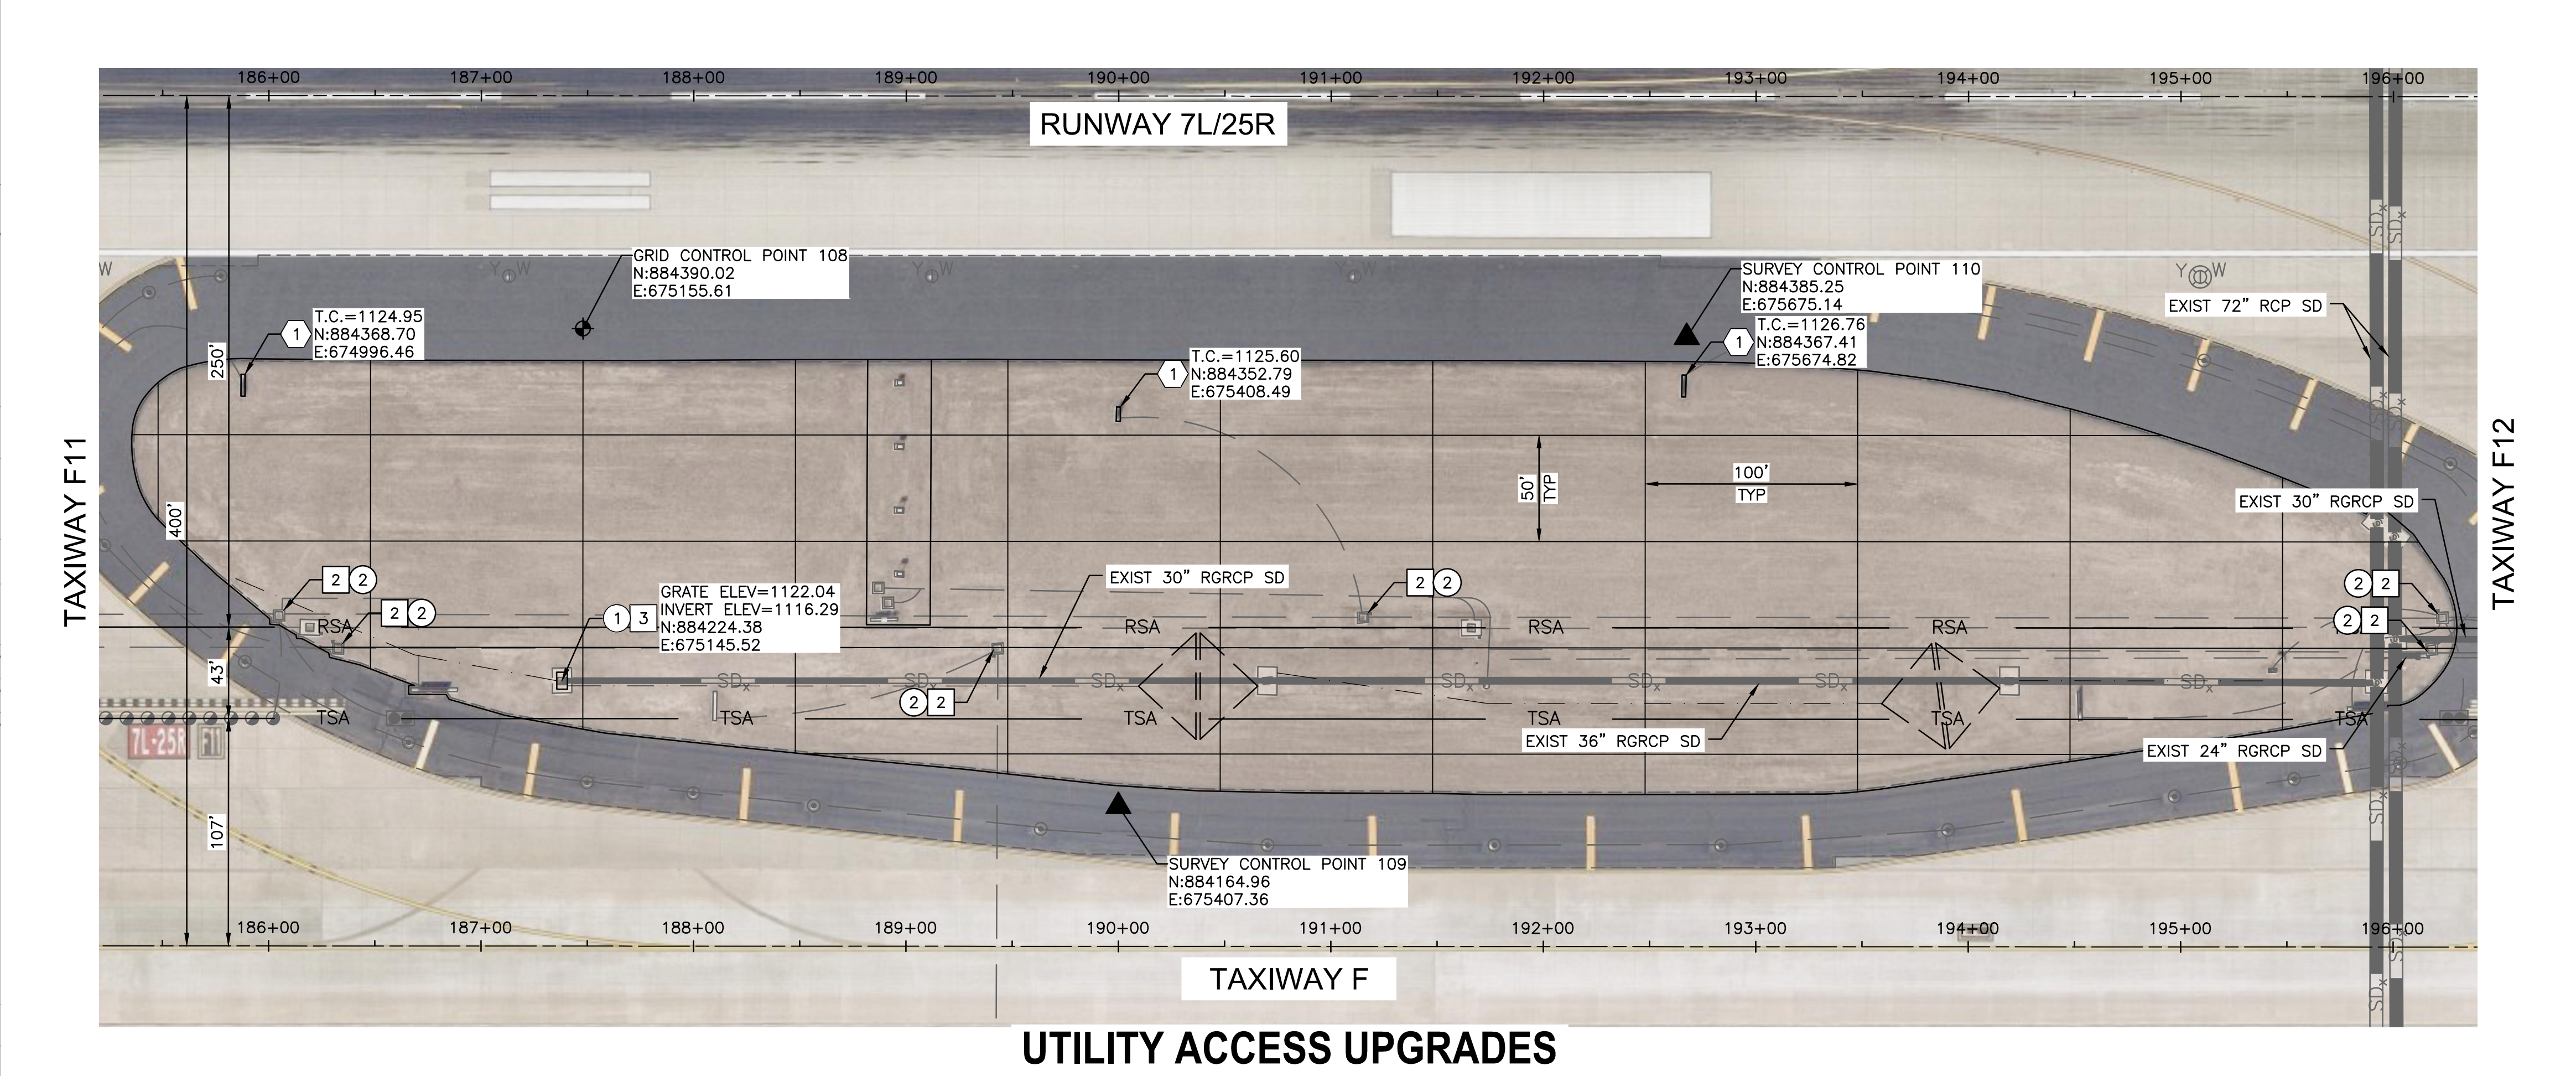ADJUSTMENT & REMOVAL NOTES

ITEM	DESCRIPTION	QTY
①	REMOVE EXISTING CATCH BASIN (DOUBLE GRATE)	1 EA
②	REMOVE AND SALVAGE EXISTING CONCRETE LID AND APRON	6 EA


CONSTRUCTION NOTES

ITEM	DESCRIPTION	QTY
①	CONSTRUCT ASPHALT PAVEMENT PER STRUCTURAL SECTION NO. 1, SHEET CS-501	2,677 TON
②	CONSTRUCT NEW PRECAST CONCRETE LID AND APRON	6 EA
③	CONSTRUCT NEW CONCRETE CATCH BASIN (TRIPLE BASIN) PER DETAIL D, SHEET CS-503	1 EA
SM	SAWCUT ASPHALT PAVEMENT (FULL DEPTH)	2,347 LF

REFERENCE NOTES

- ① SEE ELECTRICAL PLANS FOR SIGN BASE NOTES

- GENERAL NOTES
- RUNWAY AND TAXIWAY STATIONING SHOWN FOR REFERENCE ONLY.
 - AERIAL PHOTOGRAPH SHOWN IS INTENDED TO PROVIDE CLARITY FOR VAULT LOCATING AND IS INTENDED TO BE USED FOR REFERENCE ONLY.
 - EXISTING INFIELD UTILITIES AND STRUCTURES SHALL BE PROTECTED IN PLACE UNLESS OTHERWISE NOTED.

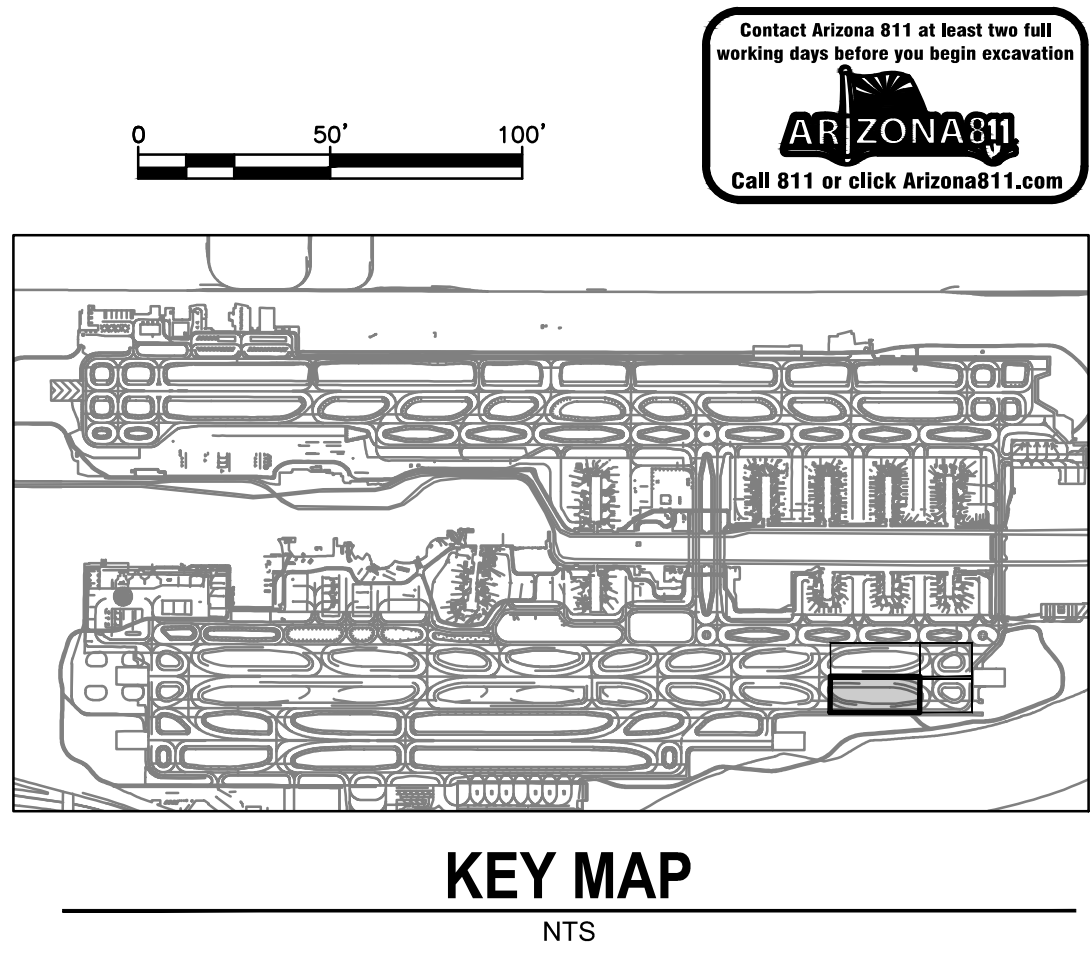

PRIME CONSULTANT

TRACE CONSULTING

SUB CONSULTANT

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NO	REVISIONS / SUBMISSIONS	DATE

PHX **PHX** BYR

CITY OF PHOENIX AVIATION DEPARTMENT

PSHIA INFIELD UTILITY ACCESS UPGRADES AND PAVING

AV 08000074 ADOT

ADOT GRANT NO.: XXXXXXXX

Designed by: C. SHAW

Drawn by: A. SANTILLI

Checked by: C. JHAVERI

Date: 05/31/2023

Dwg scale: NTS


SHEET OVERVIEW TITLE

TAXIWAY F INFIELDS UTILITY ACCESS UPGRADES AND PAVING

SHEET REFERENCE NUMBER:


CG-101

SHEET 12 OF 23

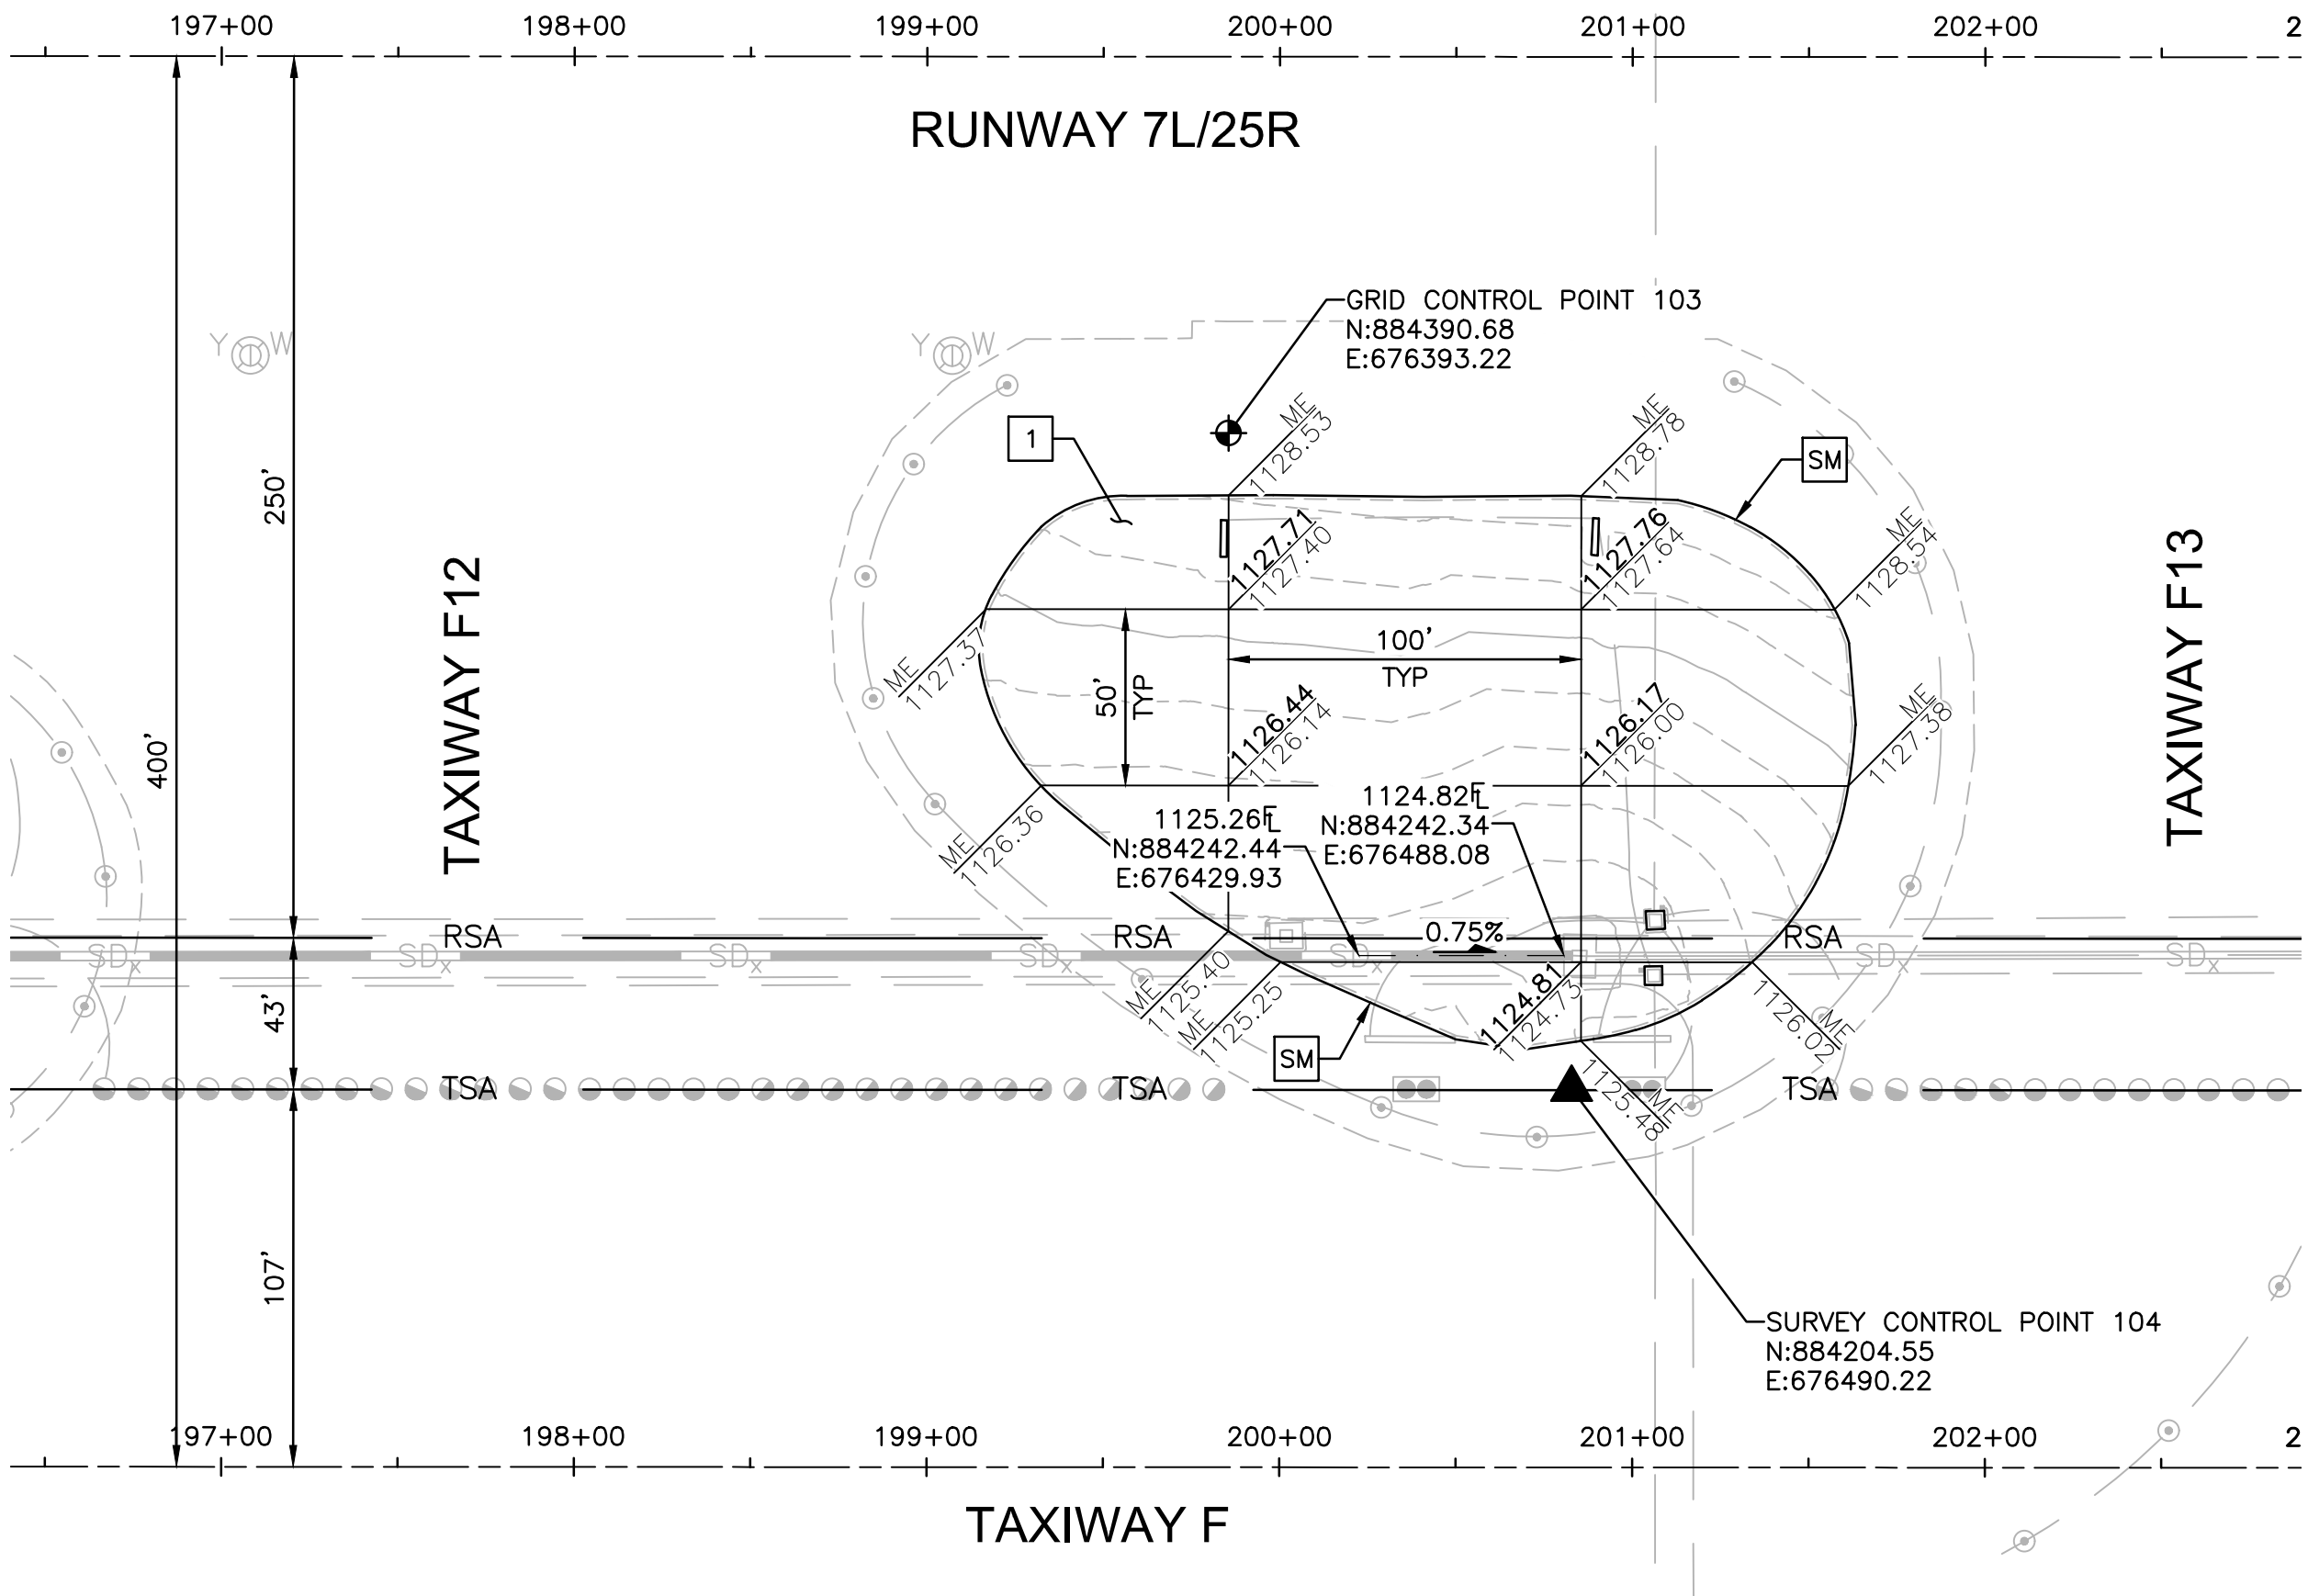

INFIELD PAVING & GRADING

INFIELD FN-12

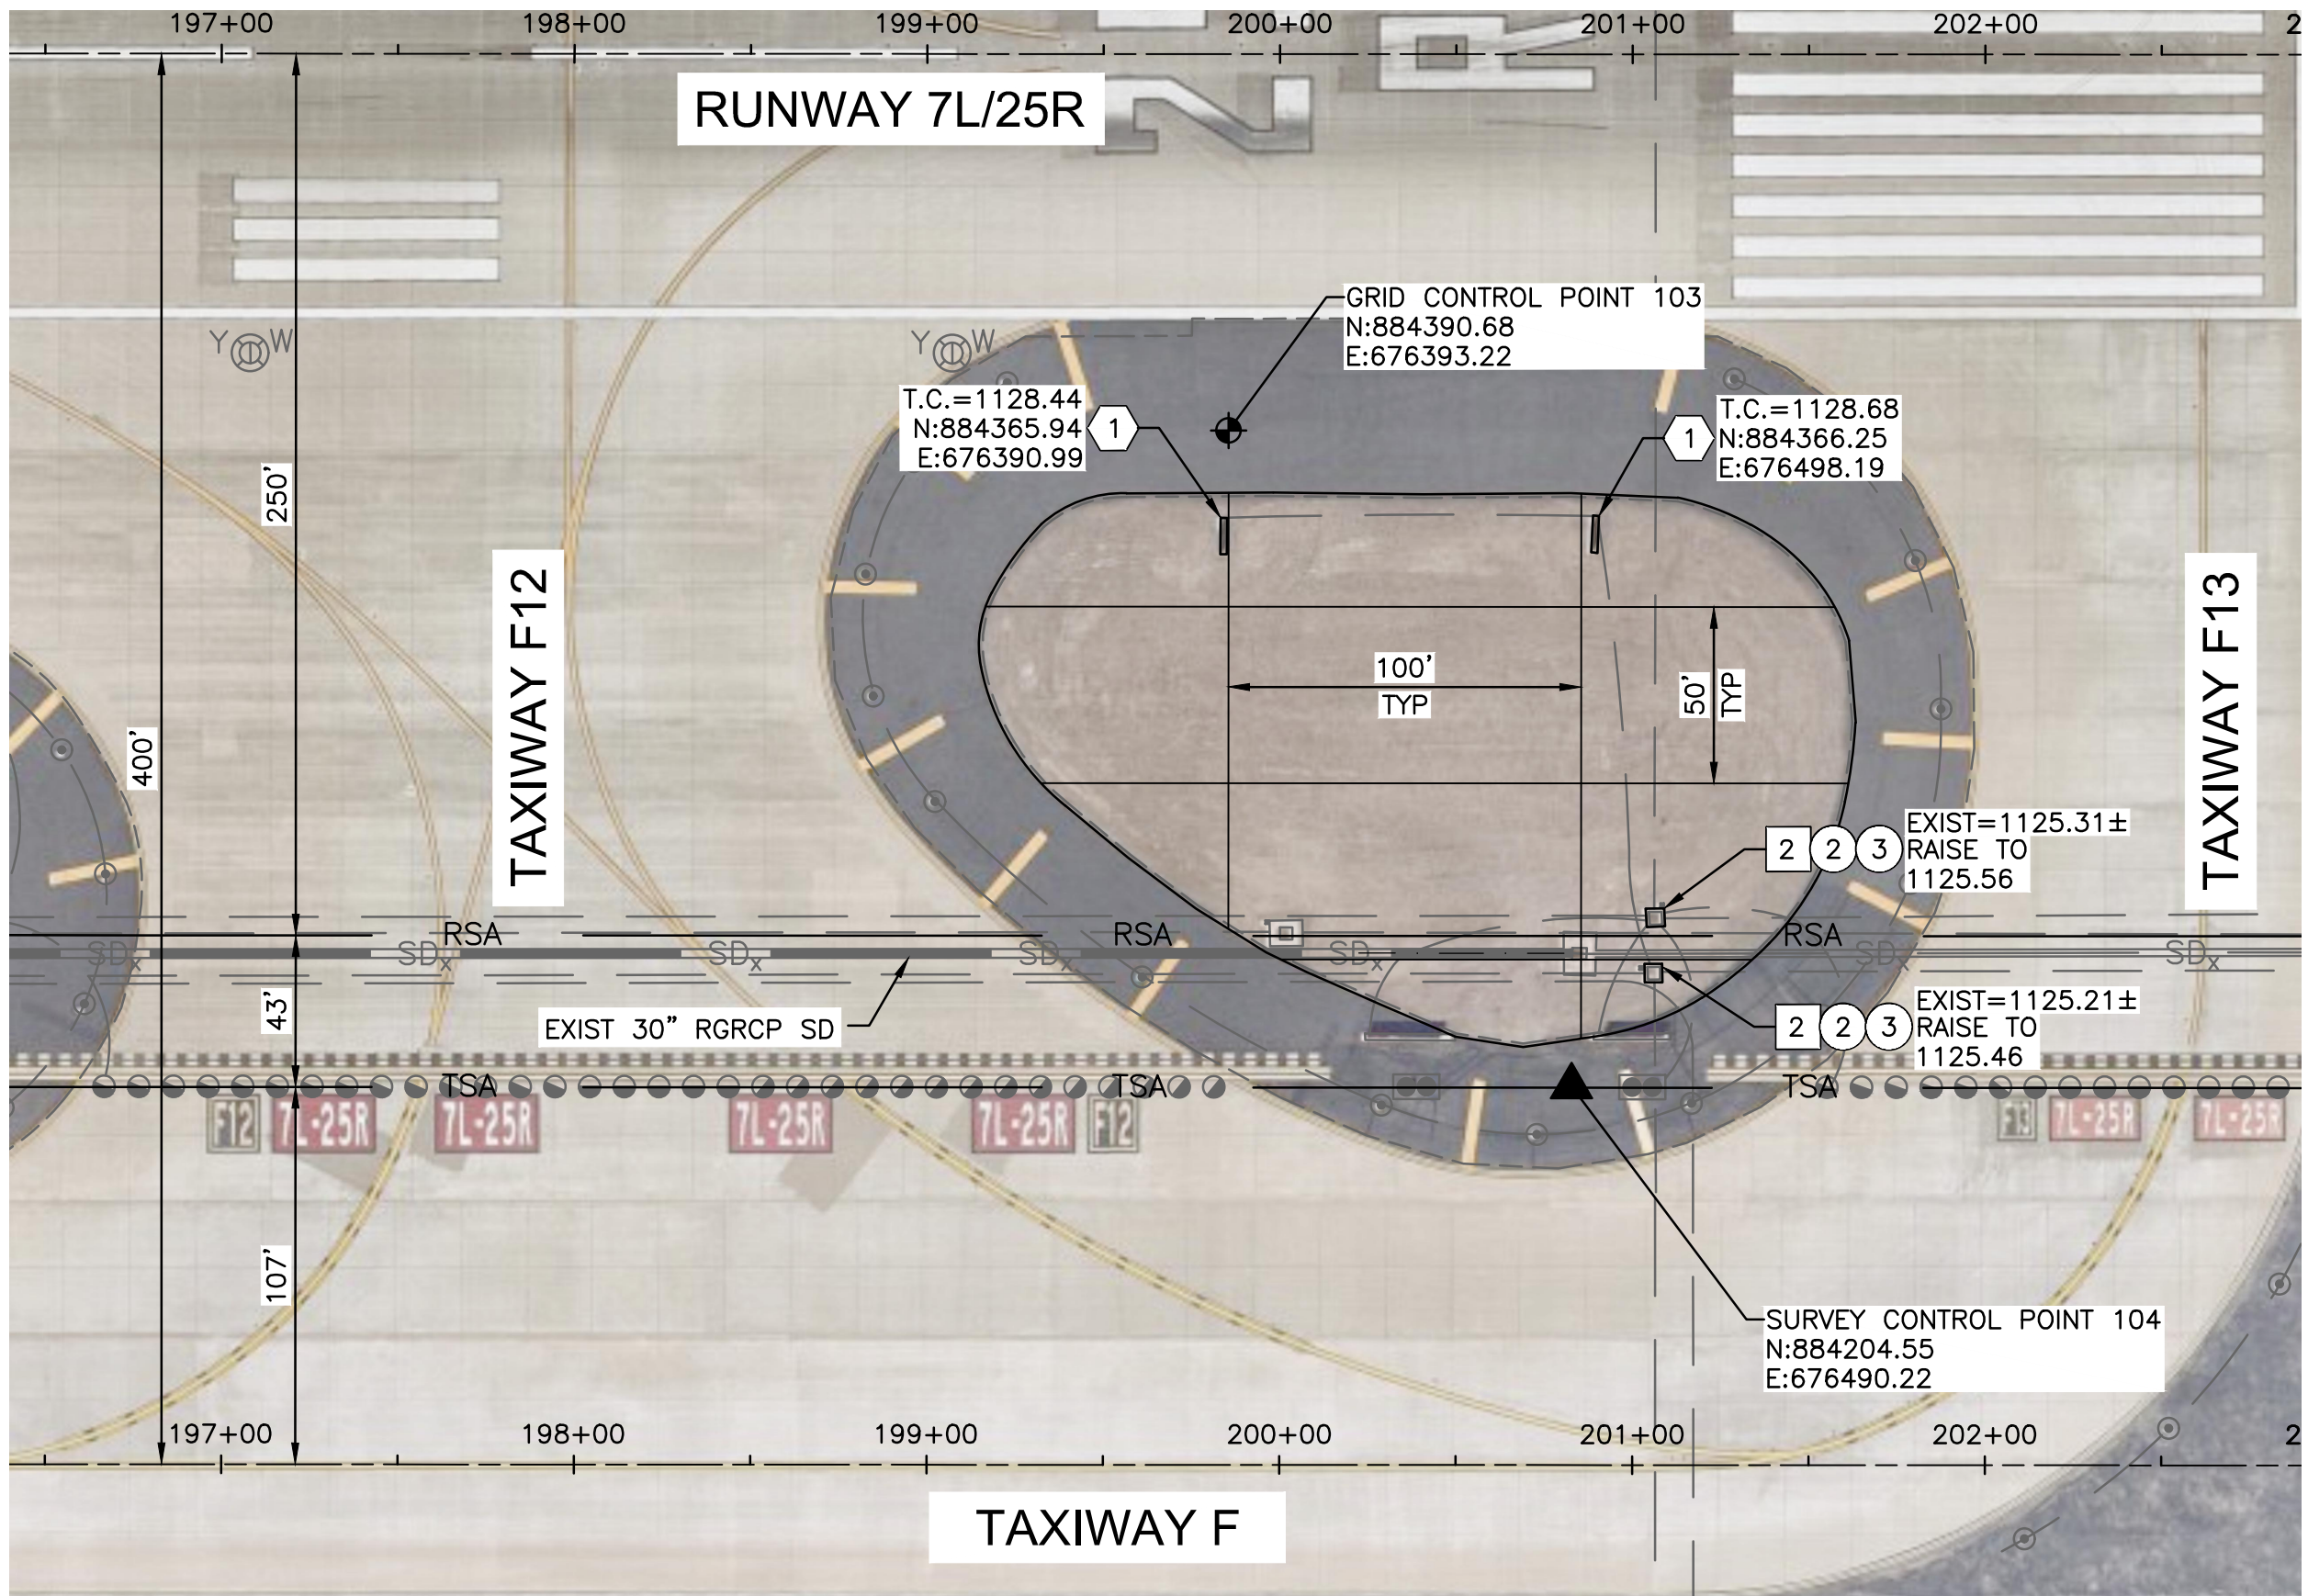

UTILITY ACCESS UPGRADES

ADJUSTMENT & REMOVAL NOTES

ITEM	DESCRIPTION	QTY
②	REMOVE AND SALVAGE EXISTING CONCRETE LID AND APRON	2 EA
③	RAISE EXISTING COP UTILITY VAULT PER DETAIL E, SHEET CS-504	2 EA

CONSTRUCTION NOTES


ITEM	DESCRIPTION	QTY
1	CONSTRUCT ASPHALT PAVEMENT PER STRUCTURAL SECTION NO. 1, SHEET CS-501	438 TON
2	CONSTRUCT NEW PRECAST CONCRETE LID AND APRON	2 EA
SM	SAWCUT ASPHALT PAVEMENT (FULL DEPTH)	661 LF

REFERENCE NOTES

- ① SEE ELECTRICAL PLANS FOR SIGN BASE NOTES

GENERAL NOTES

- RUNWAY AND TAXIWAY STATIONING SHOWN FOR REFERENCE ONLY.
- AERIAL PHOTOGRAPH SHOWN IS INTENDED TO PROVIDE CLARITY FOR VAULT LOCATING AND IS INTENDED TO BE USED FOR REFERENCE ONLY.
- EXISTING INFIELD UTILITIES AND STRUCTURES SHALL BE PROTECTED IN PLACE UNLESS OTHERWISE NOTED.

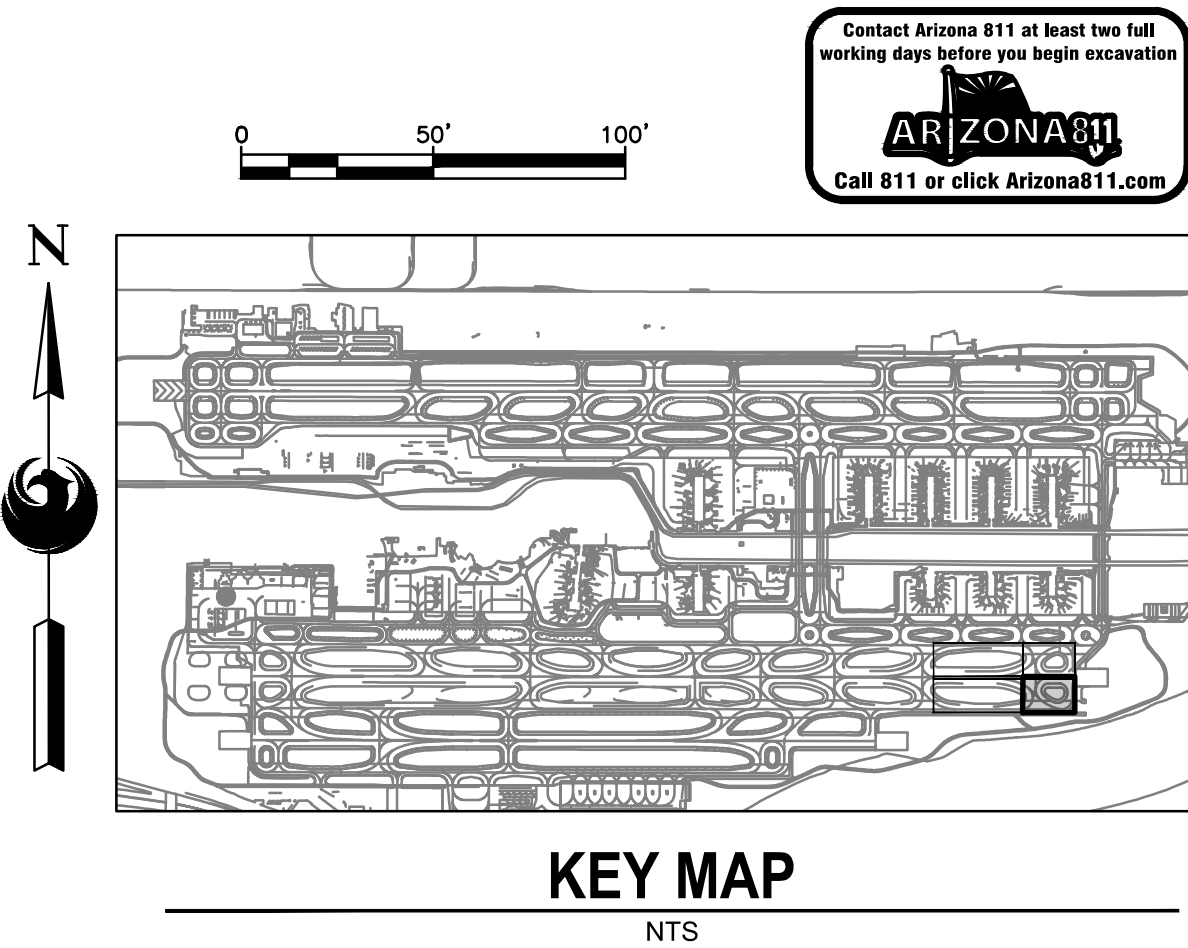

PRIME CONSULTANT

TRACER CONSULTING

SUB CONSULTANT

PER CITY OF PHOENIX CITY CODE CHAPTER 2, SECTION 2-2-28, THESE PLANS ARE FOR OFFICIAL USE ONLY AND MAY NOT BE SHARED WITH OTHERS EXCEPT AS REQUIRED TO FULFILL THE OBLIGATIONS OF CONTRACTOR'S CONTRACT WITH THE CITY OF PHOENIX.

NO

REVISIONS / SUBMISSIONS

DATE

PHX DVI BYR

CITY OF PHOENIX AVIATION DEPARTMENT

PSHIA INFIELD UTILITY ACCESS UPGRADES AND PAVING

AV 08000074 ADOT

ADOT GRANT NO.: XXXXXXXX

Designed by: C. SHAW

Drawn by: A. SANTILLI

Checked by: C. JHAVERI

Date: 05/31/2023

Dwg scale: NTS

SHEET OVERVIEW TITLE


TAXIWAY F INFIELDS UTILITY ACCESS UPGRADES AND PAVING

SHEET REFERENCE NUMBER:

CG-102


SHEET 13 OF 23

N:\2015\150106 - PHX Infield Utilities and Paving\Drawings\Sheets\South South East\GMP 5\ 0874 - CG-103-GMP5.dwg - May 30 2023 9:27am

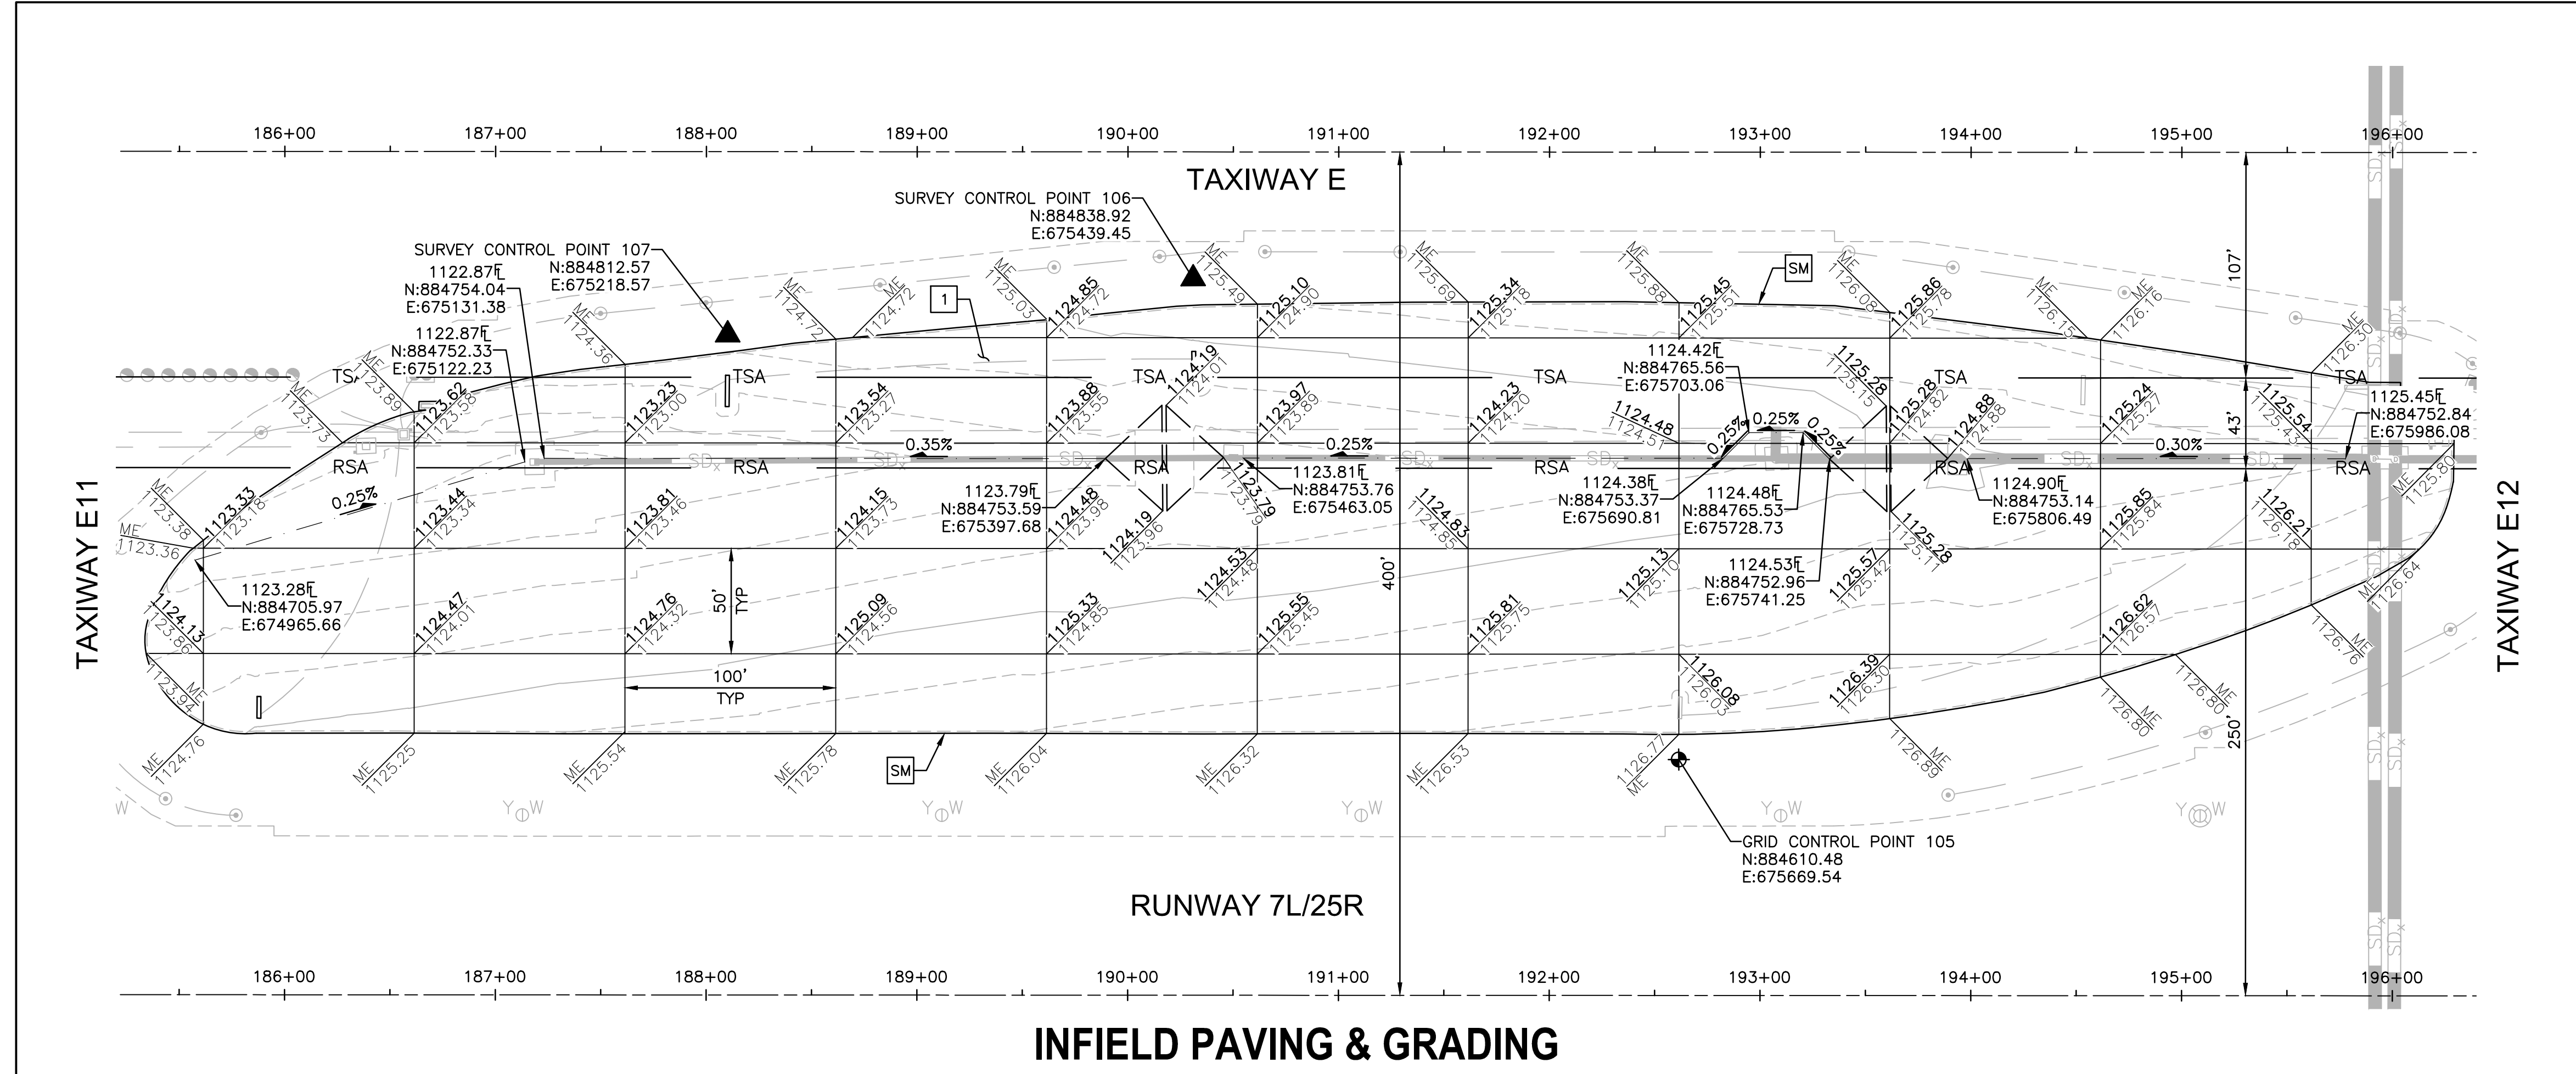

INFIELD PAVING & GRADING

INFIELD ES-11

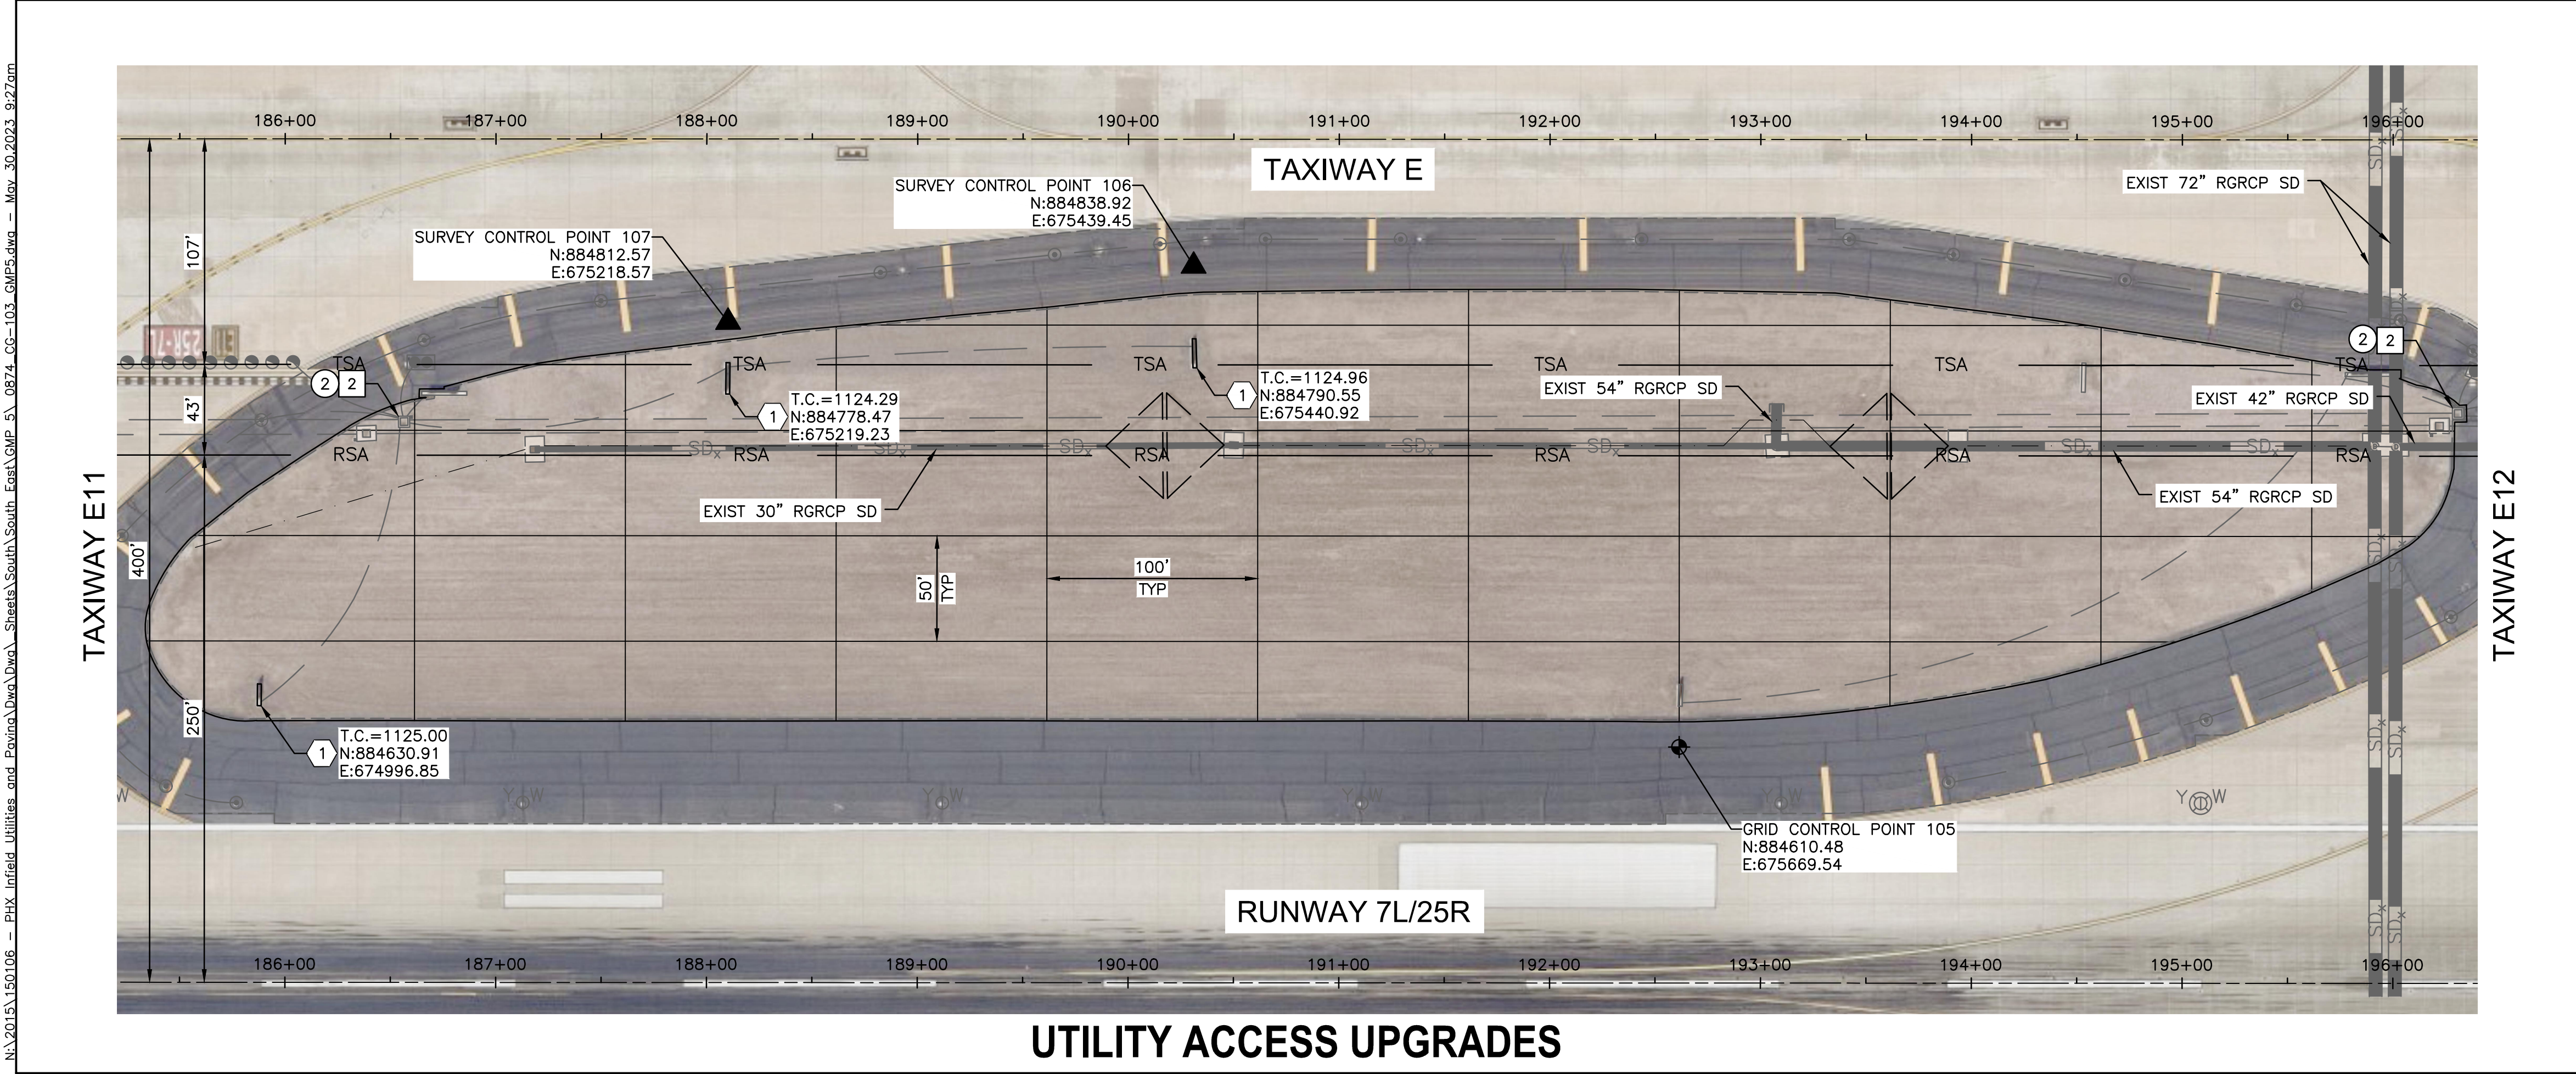

ADJUSTMENT & REMOVAL NOTES

ITEM	DESCRIPTION	QTY
②	REMOVE AND SALVAGE EXISTING CONCRETE LID AND APRON	2 EA

CONSTRUCTION NOTES


ITEM	DESCRIPTION	QTY
①	CONSTRUCT ASPHALT PAVEMENT PER STRUCTURAL SECTION NO. 1, SHEET CS-501	2,682 TON
②	CONSTRUCT NEW PRECAST CONCRETE LID AND APRON	2 EA
SM	SAWCUT ASPHALT PAVEMENT (FULL DEPTH)	2,365 LF

REFERENCE NOTES

- ① SEE ELECTRICAL PLANS FOR SIGN BASE NOTES

GENERAL NOTES

- RUNWAY AND TAXIWAY STATIONING SHOWN FOR REFERENCE ONLY.
- AERIAL PHOTOGRAPH SHOWN IS INTENDED TO PROVIDE CLARITY FOR VAULT LOCATING AND IS INTENDED TO BE USED FOR REFERENCE ONLY.
- EXISTING INFIELD UTILITIES AND STRUCTURES SHALL BE PROTECTED IN PLACE UNLESS OTHERWISE NOTED.

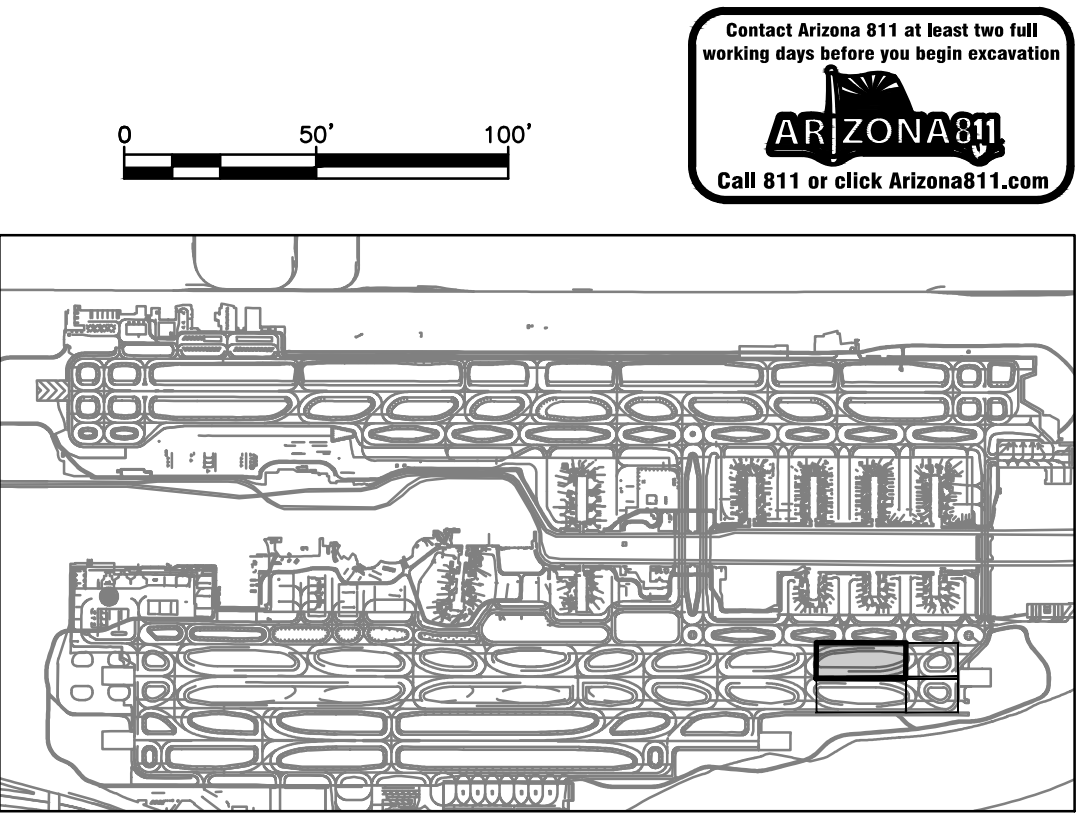

KEY MAP

NTS

PRIME CONSULTANT

TRACER CONSULTING

SUB CONSULTANT

PER CITY OF PHOENIX CITY CODE CHAPTER 2, SECTION 2-2-28, THESE PLANS ARE FOR INFORMATION ONLY AND MAY NOT BE SHARED WITH OTHERS EXCEPT AS REQUIRED TO FULFILL THE OBLIGATIONS OF CONTRACTOR'S CONTRACT WITH THE CITY OF PHOENIX.

NO

REVISIONS / SUBMISSIONS

DATE

PHX **PHX** BYR

CITY OF PHOENIX AVIATION DEPARTMENT

PSHIA INFIELD UTILITY ACCESS UPGRADES AND PAVING

AV 08000074 ADOT

ADOT GRANT NO.: XXXXXXX

Designed by: C. SHAW

Drawn by: A. SANTILLI

Checked by: C. JHAVERI

Date: 05/31/2023

Dwg scale: NTS

SHEET OVERVIEW TITLE


TAXIWAY E INFIELDS UTILITY ACCESS UPGRADES AND PAVING

SHEET REFERENCE NUMBER:

CG-103


SHEET 14 OF 23

N:\2015\150106 - PHX Infield Utilities and Paving\Drawings\Sheets\South\South East\GMP 5\ 0874_CG-104_GMP5.dwg - May 30 2023 9:27am

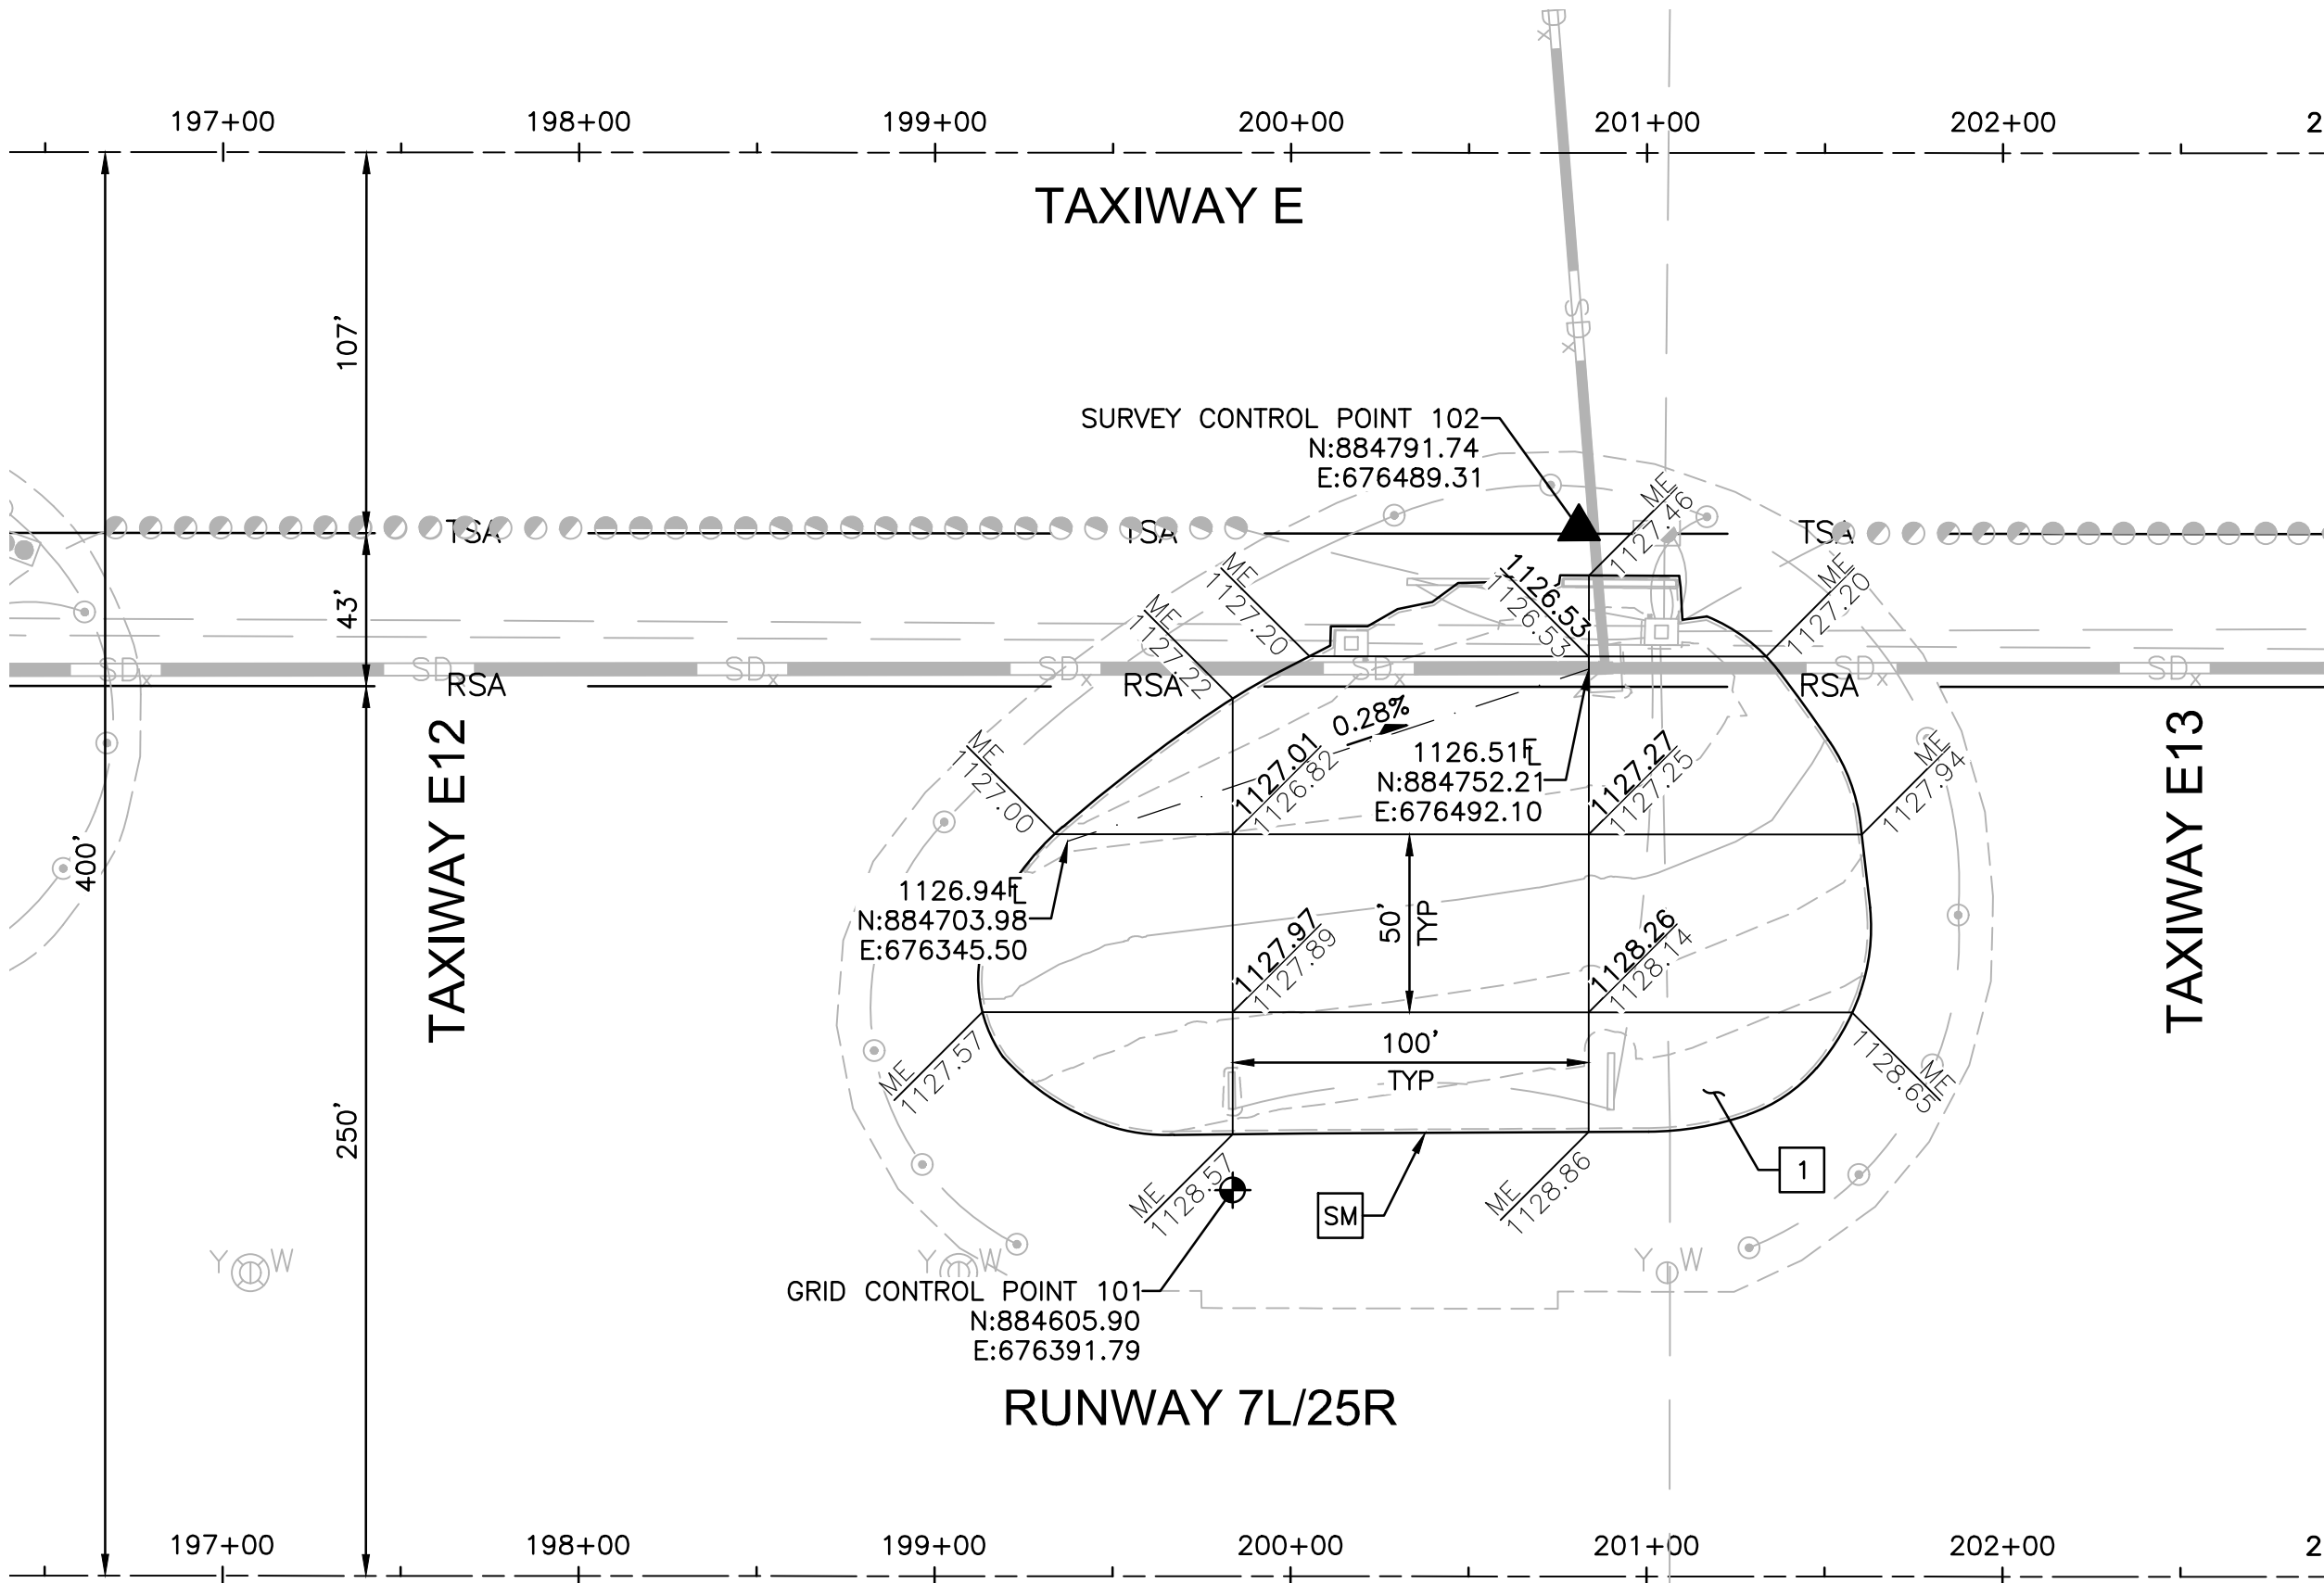

INFIELD PAVING & GRADING

INFIELD ES-12

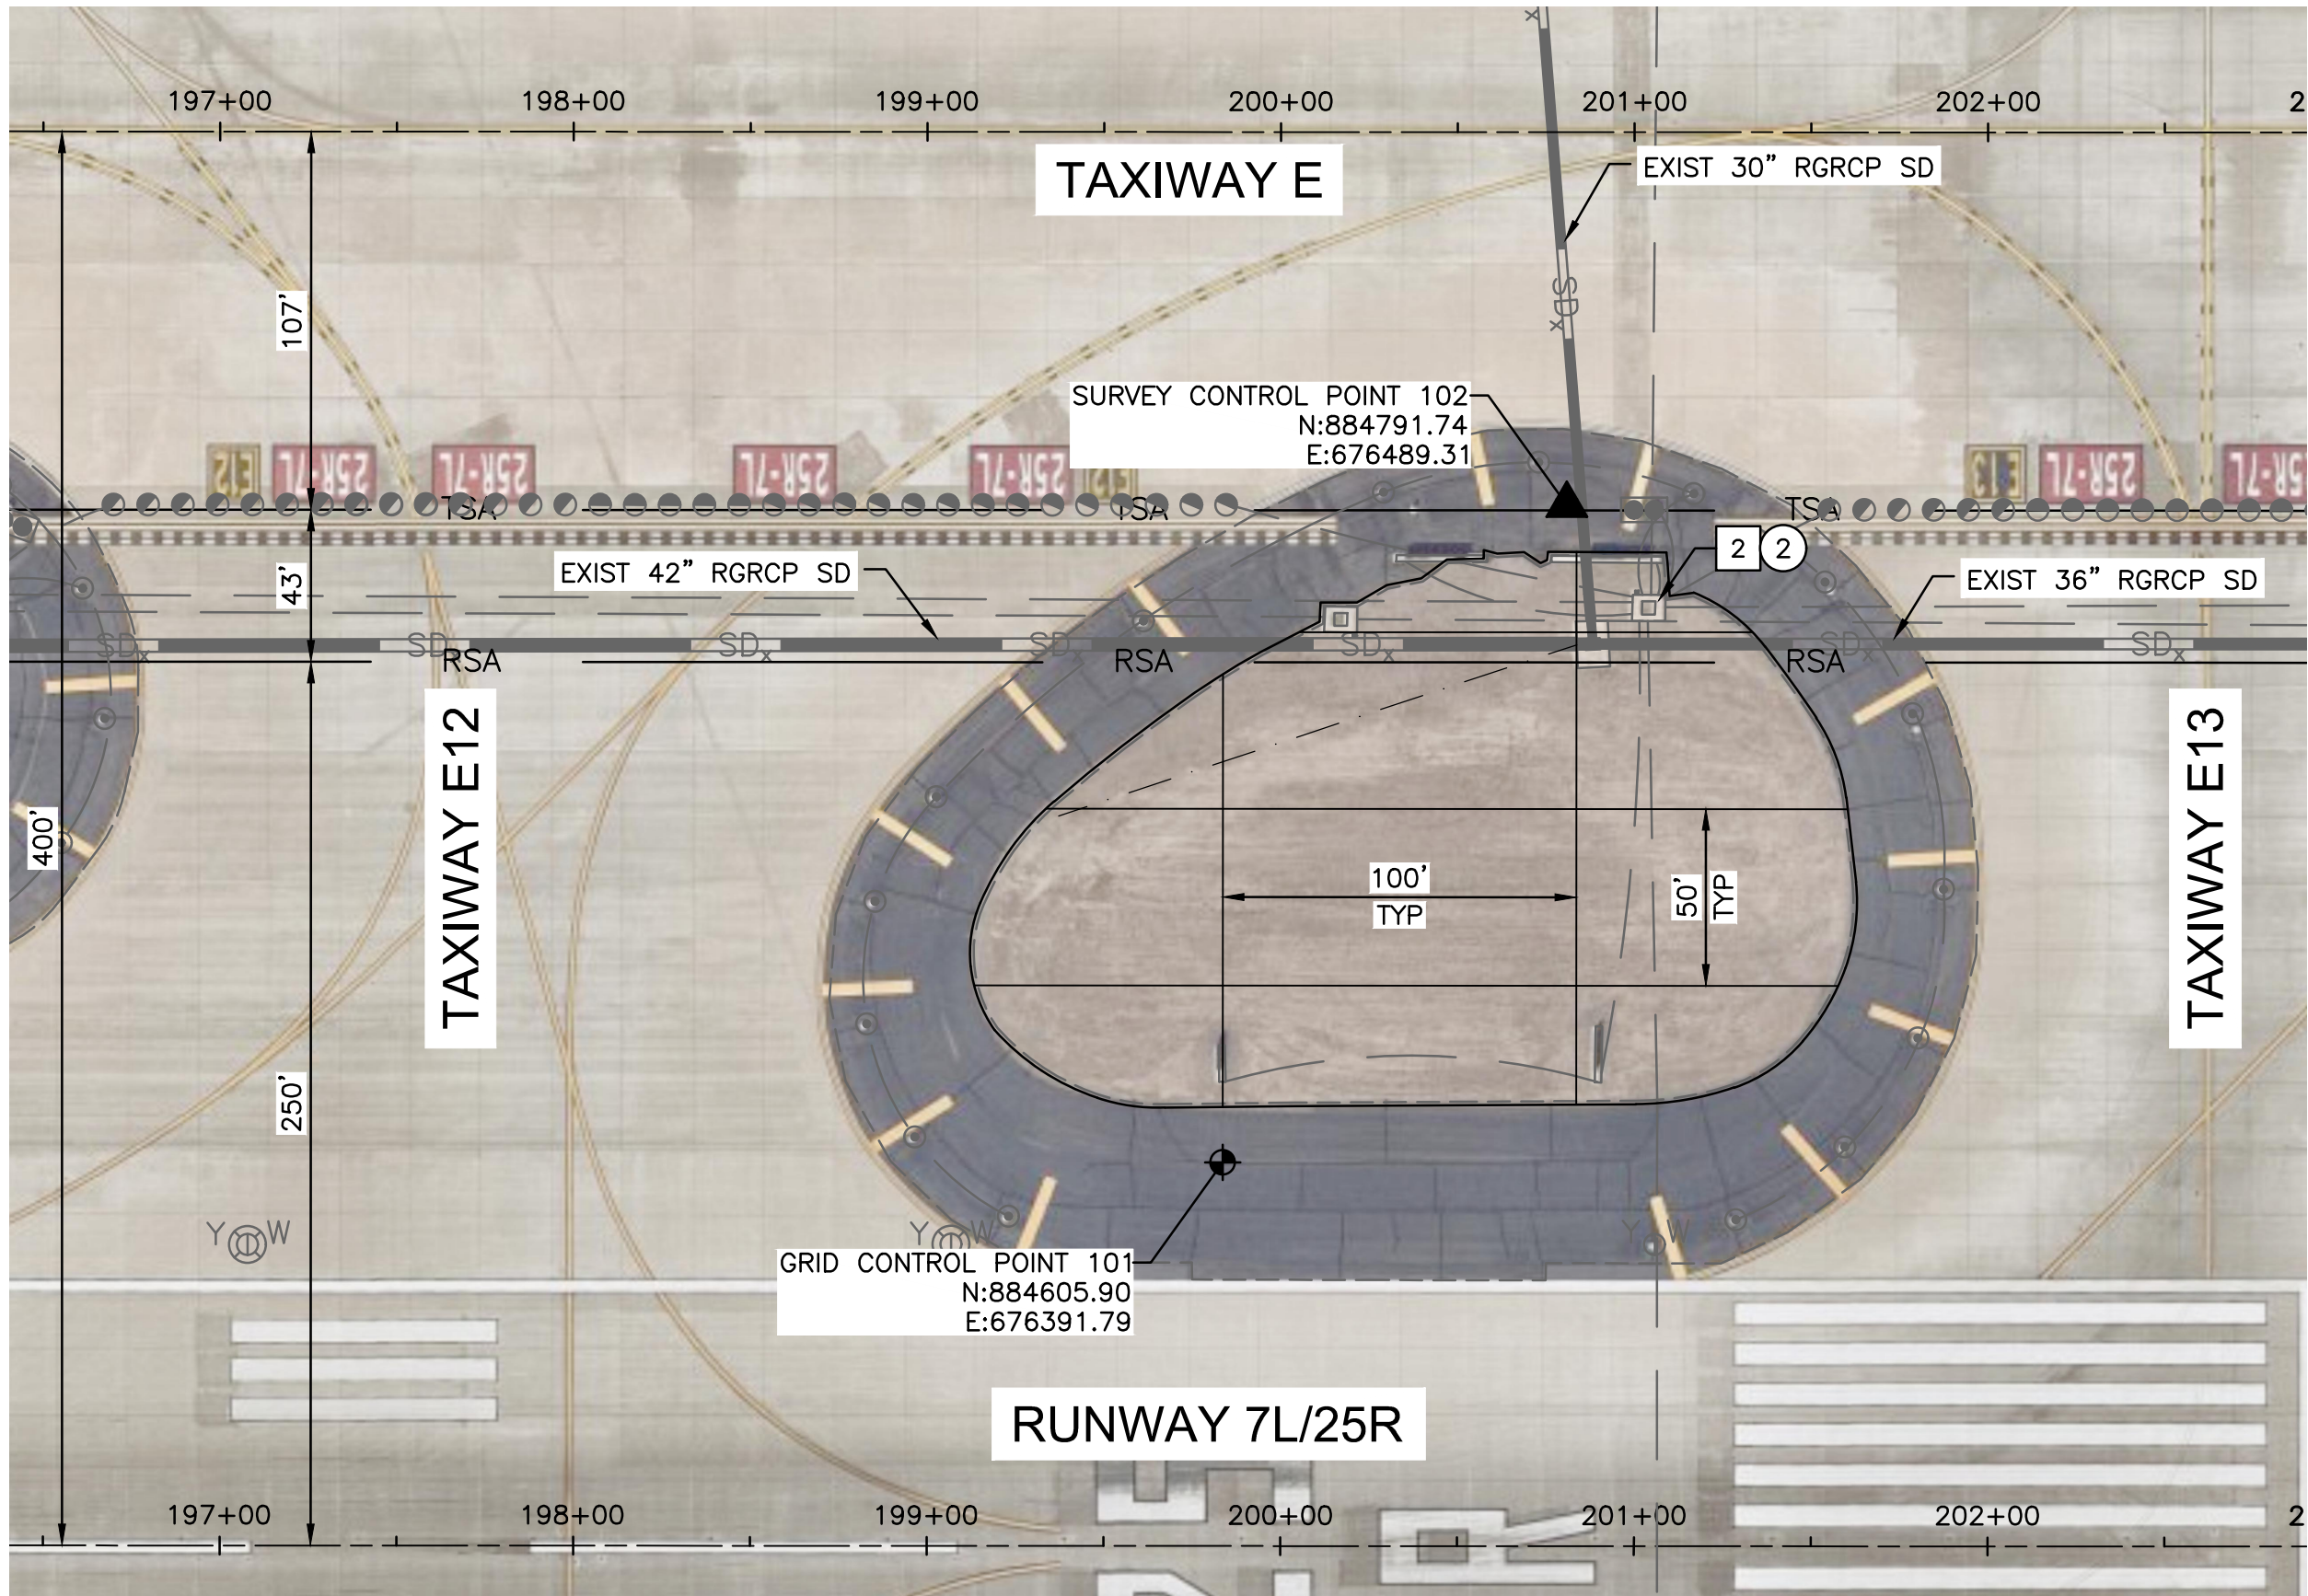

UTILITY ACCESS UPGRADES


ADJUSTMENT & REMOVAL NOTES

ITEM	DESCRIPTION	QTY
②	REMOVE AND SALVAGE EXISTING CONCRETE LID AND APRON	1 EA

CONSTRUCTION NOTES

ITEM	DESCRIPTION	QTY
1	CONSTRUCT ASPHALT PAVEMENT PER STRUCTURAL SECTION NO. 1, SHEET CS-501	443 TON
2	CONSTRUCT NEW PRECAST CONCRETE LID AND APRON	1 EA
SM	SAWCUT ASPHALT PAVEMENT (FULL DEPTH)	684 LF

- GENERAL NOTES
- RUNWAY AND TAXIWAY STATIONING SHOWN FOR REFERENCE ONLY.
 - AERIAL PHOTOGRAPH SHOWN IS INTENDED TO PROVIDE CLARITY FOR VAULT LOCATING AND IS INTENDED TO BE USED FOR REFERENCE ONLY.
 - EXISTING INFIELD UTILITIES AND STRUCTURES SHALL BE PROTECTED IN PLACE UNLESS OTHERWISE NOTED.

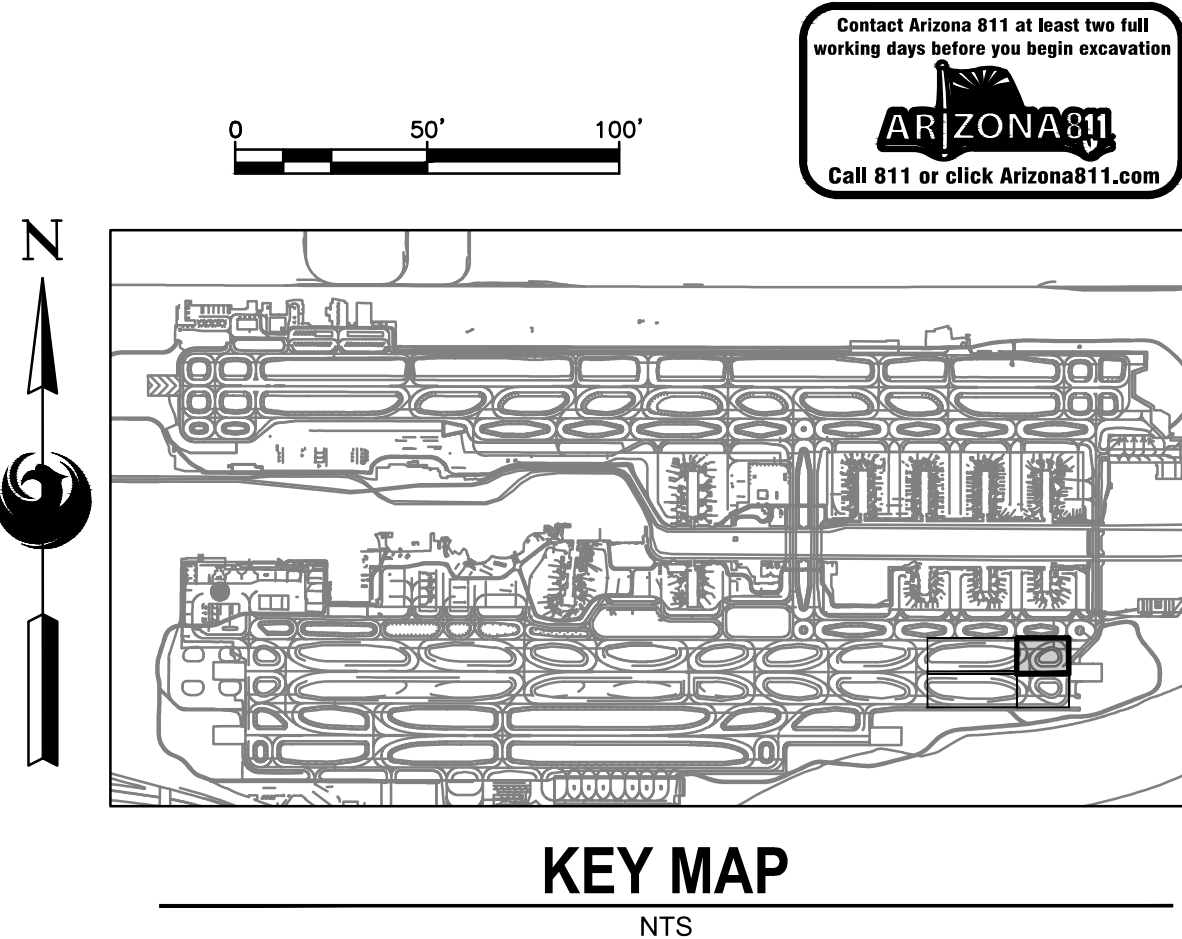

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PER CITY OF PHOENIX CITY CODE CHAPTER 2, SECTION 2-2-28, THESE PLANS ARE FOR OFFICIAL USE ONLY AND MAY NOT BE SHARED WITH OTHERS EXCEPT AS REQUIRED TO FULFILL THE OBLIGATIONS OF CONTRACTOR'S CONTRACT WITH THE CITY OF PHOENIX.

NO

REVISIONS / SUBMISSIONS

DATE

PHX DVI BYR

CITY OF PHOENIX AVIATION DEPARTMENT

PSHIA INFIELD UTILITY ACCESS UPGRADES AND PAVING

AV 08000074 ADOT

ADOT GRANT NO.: XXXXXXX

Designed by: C. SHAW

Drawn by: A. SANTILLI

Checked by: C. JHAVERI

Date: 05/31/2023

Dwg scale: NTS

SHEET OVERVIEW TITLE

TAXIWAY E INFIELDS UTILITY ACCESS UPGRADES AND PAVING

SHEET REFERENCE NUMBER:

CG-104

SHEET 15 OF 23

ELECTRICAL ABBREVIATIONS:











APS	ARIZONA PUBLIC SERVICE
BCC	BARE COPPER CONDUCTOR
CE	CONCRETE ENCASED
CKT	CIRCUIT
FAA	FEDERAL AVIATION ADMINISTRATION
GRS	GALVANIZED RIGID STEEL
ID	INNER DIAMETER OR IDENTIFICATION
LED	LIGHT EMITTING DIODE
LF	LINEAR FEET
MALSR	MEDIUM-INTENSITY APPROACH LIGHTING SYSTEM WITH RUNWAY ALIGNMENT INDICATOR LIGHTS
PAPI	PRECISION APPROACH PATH INDICATOR
PVC	POLY-VINYL CHLORIDE
R2S	RUNWAY 2 (MANDATORY SIGNS)
RDR	RUNWAY DISTANCE REMAINING
RGL	RUNWAY GUARD LIGHT
SE	SLURRY ENCASED
SGN	SIGN
TYP	TYPICAL
TES	TAXIWAY ECHO SIGNS
TFS	TAXIWAY FOXTROT SIGNS

ELECTRICAL DEMOLITION GENERAL NOTES

3. WITHIN AREAS OF DEMOLITION AND AS OTHERWISE SHOWN, REMOVE IDENTIFIED SIGN BASES, ISOLATION TRANSFORMERS AND OTHER INDICATED ITEMS.
2. CABLE REMOVAL
 - A. DIRECT BURIAL: REMOVE FROM WITHIN MANHOLES AND HANDHOLES AND REMOVE IN AREAS WHERE EXCAVATION REQUIRES DISTURBING, ABANDON ELSEWHERE.
 - B. IN CONDUIT: REMOVE COMPLETELY BETWEEN NEAREST BASES, HANDHOLES OR MANHOLES.
3. AT INDICATED DEVICES TO BE REMOVED OR IN DEMOLITION AREAS INDICATED, REMOVE ALL CONDUCTORS BACK TO NEAREST MANHOLE OR HANDHOLE OUTSIDE DEMOLITION AREA.
4. SIGNS AND/OR SIGN BASES, CABLES, CONDUITS, DUCTS, ETC. WHICH ARE NOT SPECIFICALLY INDICATED TO BE REMOVED (OR WHICH ARE SHOWN TO REMAIN WITHIN AREAS OF GENERAL DEMOLITION) SHALL REMAIN IN-PLACE AND FUNCTIONAL.
5. CONTRACTOR SHALL VERIFY EQUIPMENT AND CABLE DESIGNATIONS AND STATUS PRIOR TO REMOVAL OR DISCONNECTING.
6. UNLESS OTHERWISE NOTED, ALL REMOVED MATERIAL SHALL BECOME THE PROPERTY OF THE CONTRACTOR AND SHALL BE REMOVED FROM THE SITE AND DISPOSED OF IN ACCORDANCE WITH APPLICABLE LOCAL ORDINANCES.
7. DRAWINGS MAY NOT DETAIL ALL EXISTING FACILITIES IN AREAS OF DEMOLITION. CONTRACTOR SHALL REVIEW THE SITE AND RECORD DRAWINGS TO VERIFY THE DEMOLITION EFFORT INVOLVED.
8. EXISTING SIGNS MUST REMAIN OPERATIONAL DURING CONSTRUCTION. TEMPORARY CONNECTIONS TO EXISTING SIGNS REQUIRED DURING RELOCATION. TEMPORARY MOUNTING OF EXISTING SIGNS REQUIRED WHERE NEW LOCATION CONFLICTS WITH EXISTING LOCATION.

ELECTRICAL LEGEND:

(UNLESS OTHERWISE NOTED ON PLANS)

	PVC W/8-5KV L-824 TYPE "C" CABLE PER INDICATED LIGHTING CIRCUIT. (QUANTITY AND SIZE AS INDICATED ON PLAN SHEETS)
	EXISTING ELECTRICAL CONDUIT AND CONDUCTOR
	EXISTING ELEVATED EDGE LIGHT
	EXISTING LIGHT CAN WITH COVER
	EXISTING RUNWAY GUARD LIGHT
	EXISTING IN-PAVEMENT RUNWAY GUARD LIGHT
	EXISTING AIRFIELD GUIDANCE SIGN
	RELOCATED EXISTING AIRFIELD GUIDANCE SIGN
	EXISTING ELECTRICAL HANDHOLE
	EXISTING ELECTRICAL MANHOLE

ELECTRICAL SHEET INDEX


EA-001	ELECTRICAL LEGEND AND NOTES
EA-101	PARTIAL AIRFIELD ELECTRICAL SITE PLAN
EA-102	PARTIAL AIRFIELD ELECTRICAL SITE PLAN
EA-103	PARTIAL AIRFIELD ELECTRICAL SITE PLAN
EA-104	PARTIAL AIRFIELD ELECTRICAL SITE PLAN
EA-501	AIRFIELD GUIDANCE SIGN BASE INSTALLATION DETAIL
EA-502	RDR SIGN BASE INSTALLATION AND MANHOLE DETAILS
EA-503	SPLICING AND GROUNDING DETAILS

ADVISORY CIRCULARS FOR AIRPORT PROJECTS (MOST RECENT VERSION):

150/5340-18	STANDARDS FOR AIRPORT SIGN SYSTEMS
150/5340-30	DESIGN & INSTALLATION DETAILS FOR AIRPORT VISUAL AIDS
150/5345-7	SPECIFICATION FOR L-824 UNDERGROUND ELECTRICAL CABLE FOR AIRPORT LIGHTING CIRCUITS
150/5345-26	SPECIFICATION FOR L-823 PLUG AND RECEPTACLE, CABLE CONNECTORS
150/5345-42	SPECIFICATION FOR AIRPORT LIGHT BASES, TRANSFORMER HOUSINGS, JUNCTION BOXES, AND ACCESSORIES
150/5345-44	SPECIFICATION FOR RUNWAY AND TAXIWAY SIGNS
150/5345-47	SPECIFICATION FOR SERIES TO SERIES ISOLATION TRANSFORMERS FOR AIRPORT LIGHTING SYSTEMS
150/5345-53	AIRPORT LIGHTING EQUIPMENT CERTIFICATION PROGRAM
150/5370-2	OPERATIONAL SAFETY ON AIRPORTS DURING CONSTRUCTION
150/5370-10	STANDARDS FOR SPECIFYING CONSTRUCTION OF AIRPORTS
ADDENDUM	AIRPORT LIGHTING EQUIPMENT CERTIFICATION PROGRAM (PUBLISHED MONTHLY AND LISTING APPROVED SUPPLIERS)

SHEET OVERVIEW TITLE	ELECTRICAL LEGEND AND NOTES	SHEET REFERENCE NUMBER: EA-001	SHEET 16 OF 23	Designed by: SW	Drawn by: JBW	Checked by: CA	Date: 05/31/2023	Dwg scale: NTS	PHX DVT BYR CITY OF PHOENIX AVIATION DEPARTMENT PSHIA INFIELD UTILITY ACCESS UPGRADES AND PAVING AV 08000074 ADOT ADOT GRANT NO.: XXXXXXXX				"PER CITY OF PHOENIX CITY CODE CHAPTER 2, SECTION 2-28, THESE PLANS ARE FOR OFFICIAL USE ONLY AND MAY NOT BE SHARED WITH OTHERS EXCEPT AS REQUIRED TO FULFILL THE OBLIGATIONS OF CONTRACTOR'S CONTRACT WITH THE CITY OF PHOENIX"						PRIME CONSULTANT TRACE CONSULTING 1571 E. Johnson St. Suite 11 Phoenix, AZ 85034		SUB CONSULTANT CR engineers 16710 East Palisades Blvd., Suite 202 Fountain Hills, AZ 85268 Phone: (480) 816-5541 Fax: (480) 816-5540 www.creng.com	
				NO						REVISIONS / SUBMISSIONS	DATE											



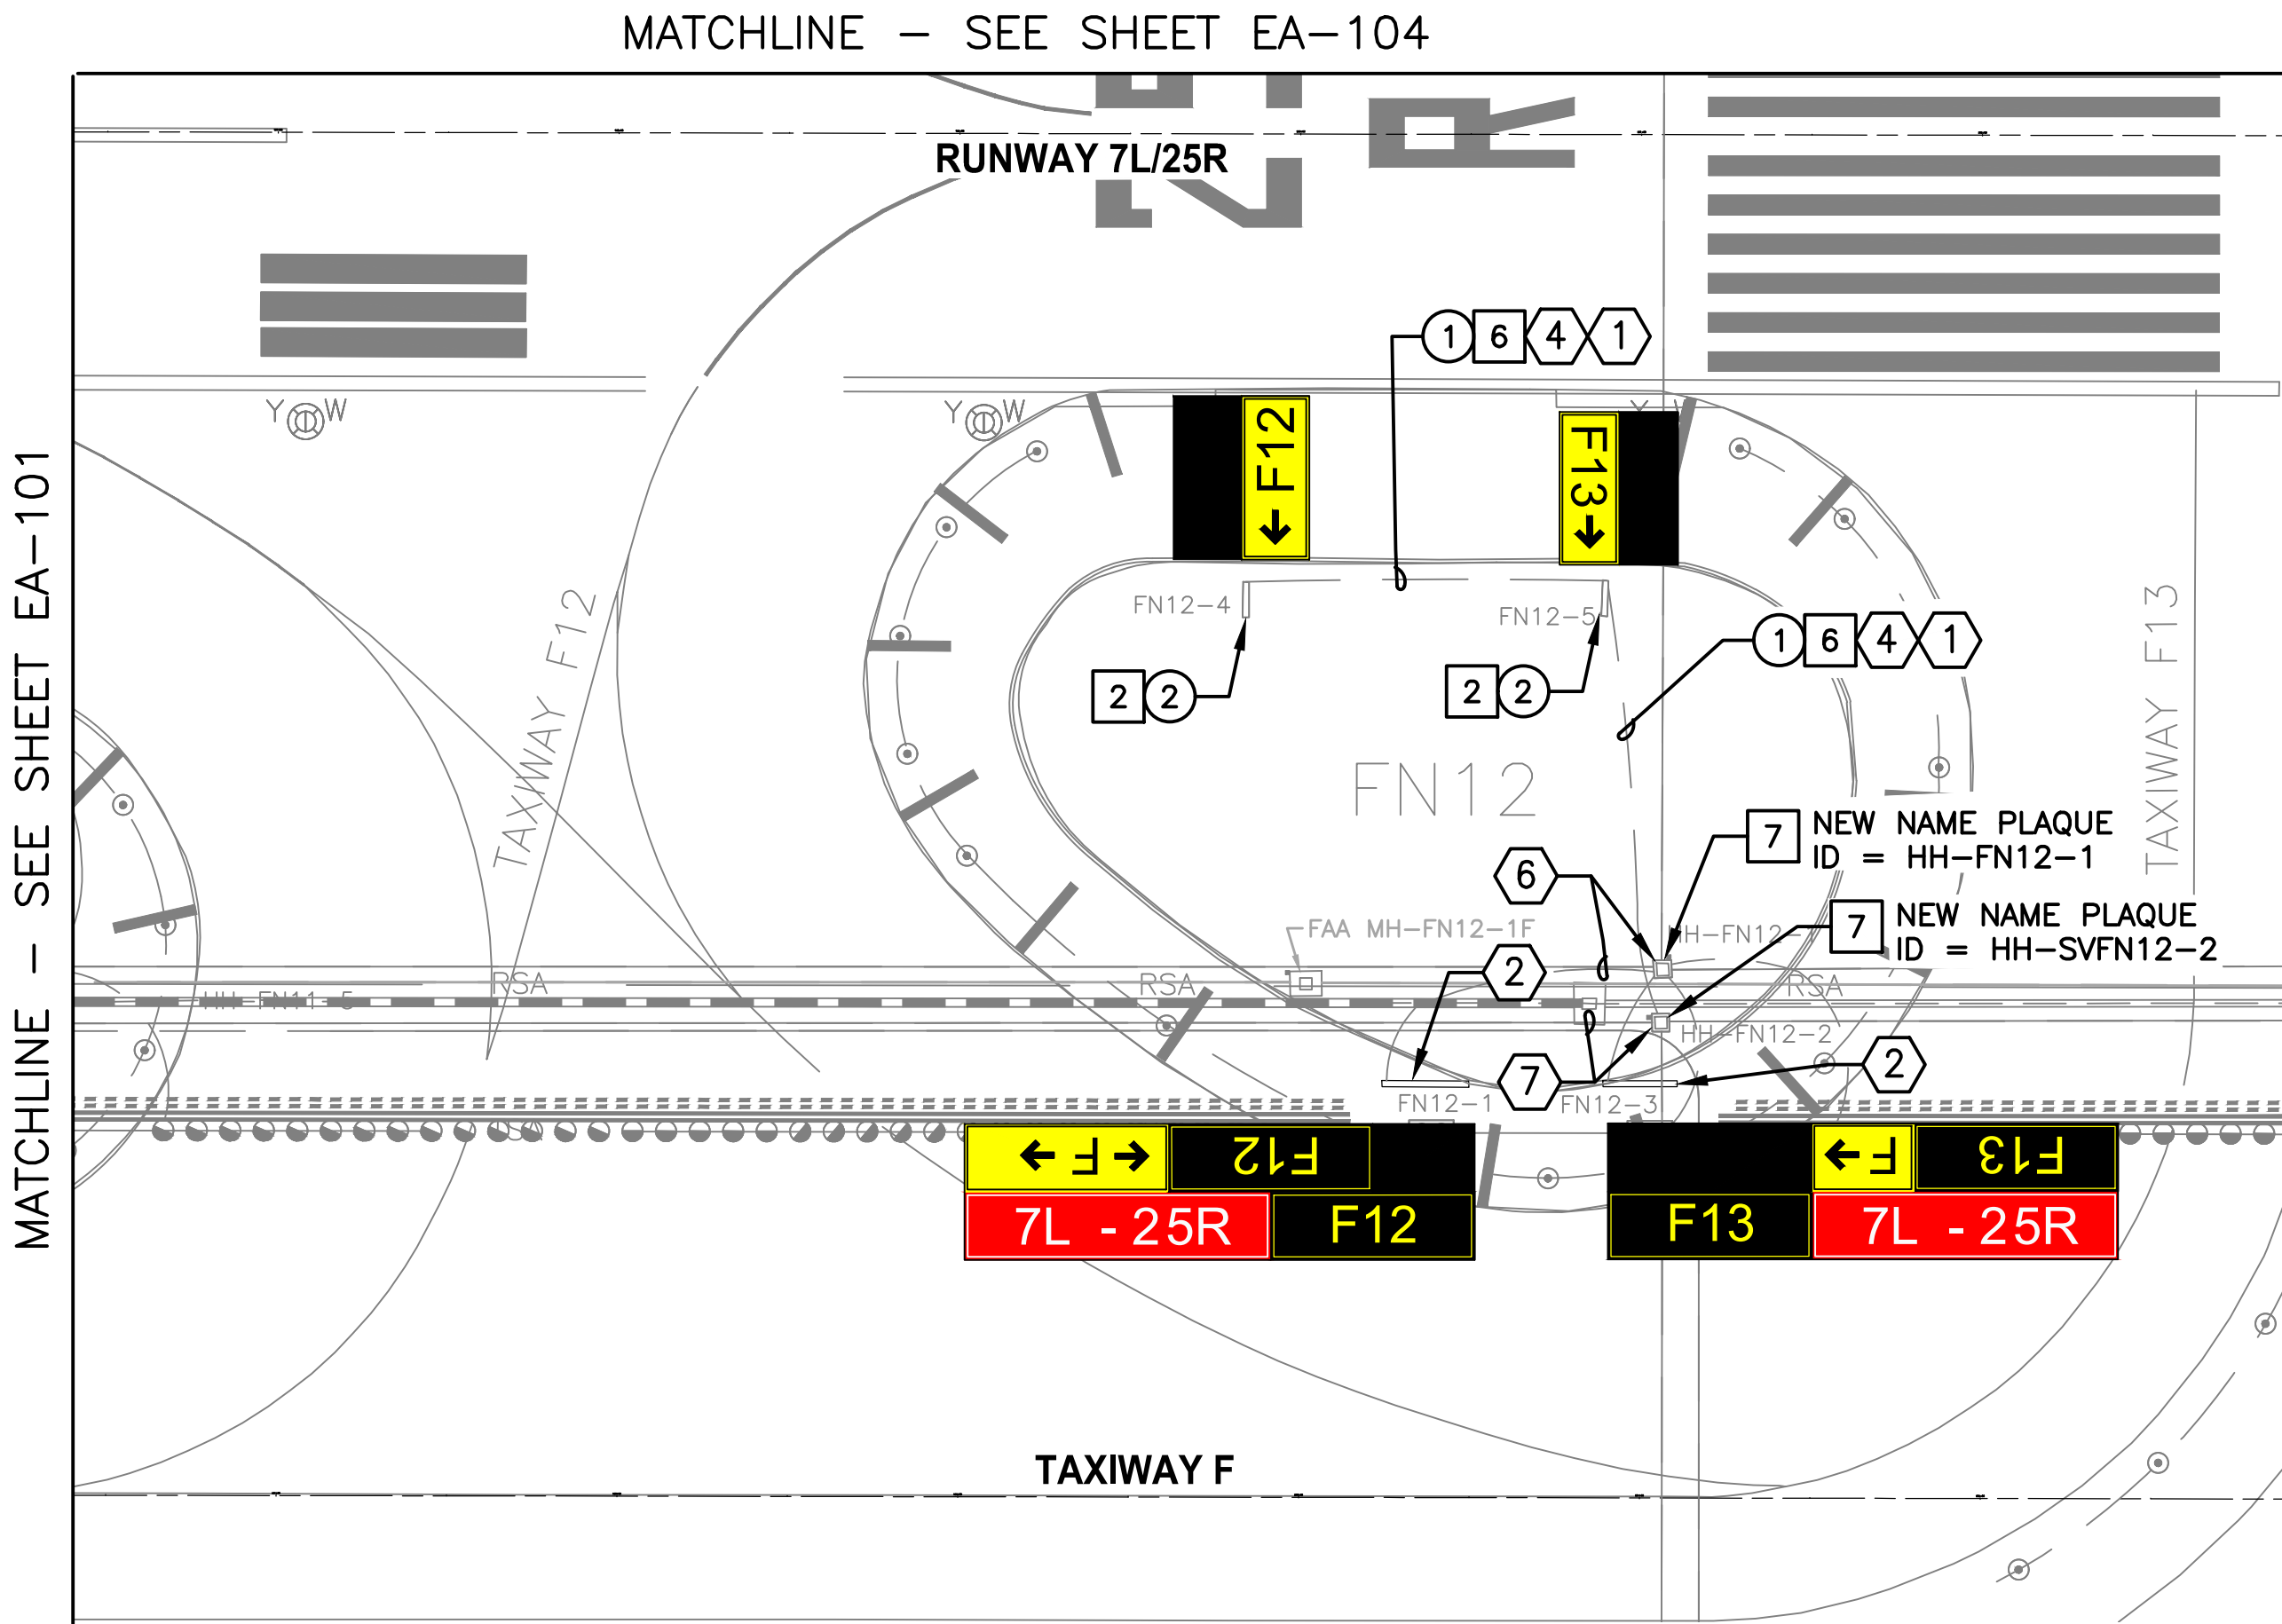


MATCHLINE - SEE SHEET EA-101

MATCHLINE - SEE SHEET EA-104

<u>ADJUSTMENT & REMOVAL NOTES</u>		
ITEM	DESCRIPTION	QTY
①	REMOVE EXISTING CABLE BACK TO HANDHOLE AND RECONNECT TO MAINTAIN CIRCUIT, EXISTING CONDUIT TO REMAIN.	240 LF
②	REMOVE AND SALVAGE EXISTING SIGN AND ISOLATION TRANSFORMER, REMOVE CONCRETE SIGN BASE.	2 EA


CONSTRUCTION NOTES		
ITEM	DESCRIPTION	QTY
2	CONSTRUCT NEW CONCRETE AIRFIELD SIGN BASE FOR 2-MODULE SIGN (PER DETAIL 919, SHEET EA-501) AND RECONNECT EXISTING CONDUIT. INSTALL SALVAGED AIRFIELD SIGN AND ISOLATION TRANSFORMER.	2 EA
6	NEW 2/C, #8, L-824 TYPE C AIRFIELD LIGHTING CABLE WITH #6 BCC GROUND	270 LF
7	INSTALL NEW MANHOLE/HANDHOLE ID PLAQUE PER DETAIL 576, SHEET EA-502	2 EA

REFERENCE NOTES	
ITEM	DESCRIPTION
1	EXISTING CONDUIT/DUCTBANK
2	EXISTING SIGN TO REMAIN
4	CKT R2S
6	NORTHERN DUCTBANK AND MANHOLES FOR CENTER RUNWAY (R2) FROM CENTER AIRFIELD LIGHTING VAULT.
7	SOUTHERN DUCTBANK AND MANHOLES FOR TAXIWAY F FROM SOUTH AIRFIELD LIGHTING VAULT.

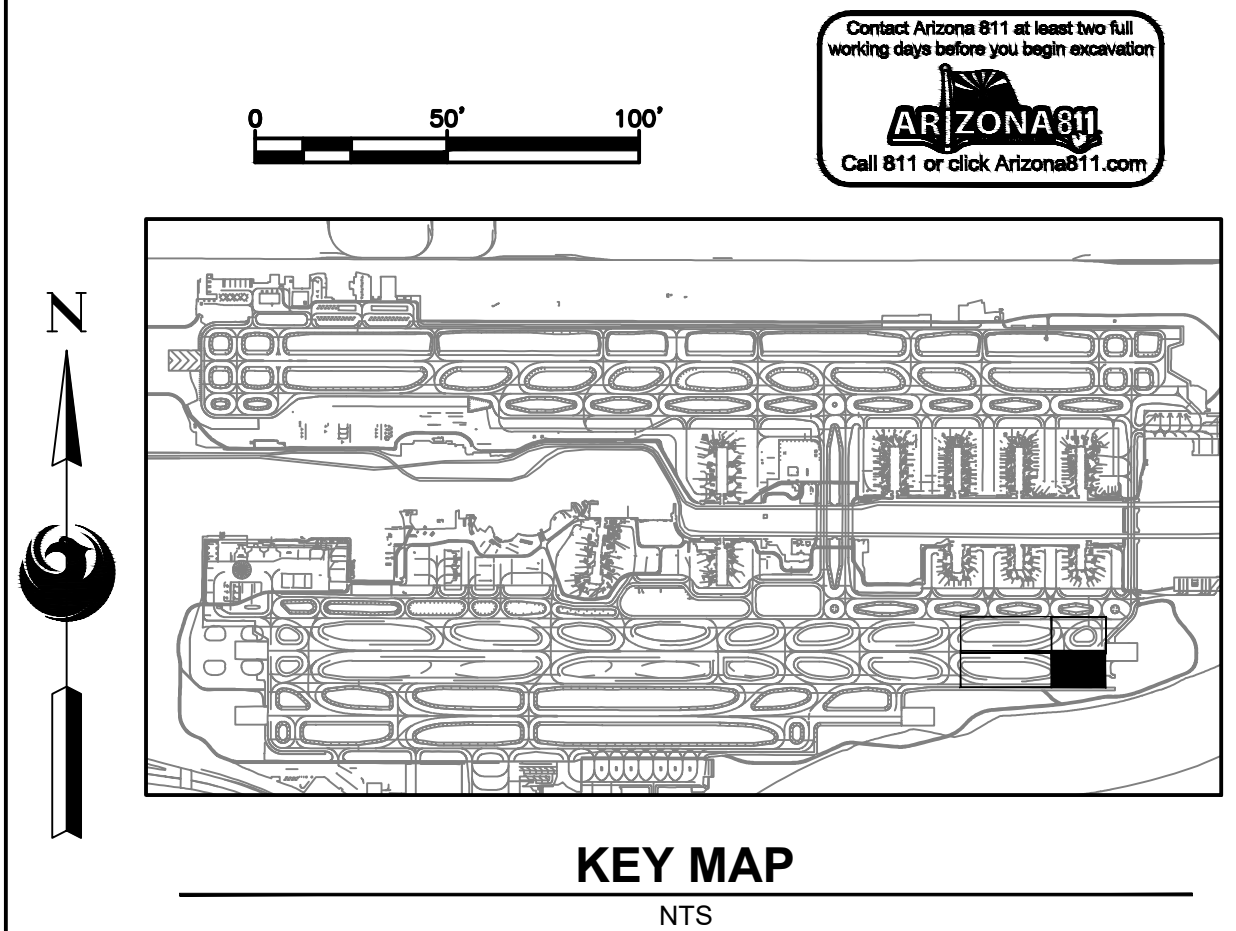

SHEET OVERVIEW TITLE	PARTIAL AIRFIELD ELECTRICAL SITE PLAN	
	SHEET REFERENCE NUMBER: EA-102	
Designed by: SW	14710 East Palisades Blvd., Suite 202 Fountain Hills, AZ 85208 Phone: (480) 816-5541 Fax: (480) 816-5540 www.creng.com	
Drawn by: JBW	15701 E. Jefferson St. (Suite 3) Phoenix, AZ 85024	
Checked by: CA	PRIME CONSULTANT	
Date: 05/31/2023	SUB CONSULTANT	
Dwg scale: 1"=50'	CR engineers	
PER CITY OF PHOENIX CITY CODE CHAPTER 2, SECTION 2-28, THESE PLANS ARE FOR OFFICIAL USE ONLY AND MAY NOT BE SHARED WITH OTHERS EXCEPT AS REQUIRED TO FULFILL THE OBLIGATIONS OF CONTRACTOR'S CONTRACT WITH THE CITY OF PHOENIX		
PHX DVI BYR CITY OF PHOENIX AVIATION DEPARTMENT PSHIA INFIELD UTILITY ACCESS UPGRADES AND PAVING AV 08000074 ADOT ADOT GRANT NO.: XXXXXXXX		
NO REVISIONS / SUBMISSIONS DATE		

G:\PROJECTS\14000\14069 PSHIA Infield Utility Access Upgrades and Paving\CAD\SHETS\Phase 3_CAD sheets\GMP5 100% SUBMITTAL CAD FILES\GMP5 EA-101.dwg -- May 30, 2023, 10:29am

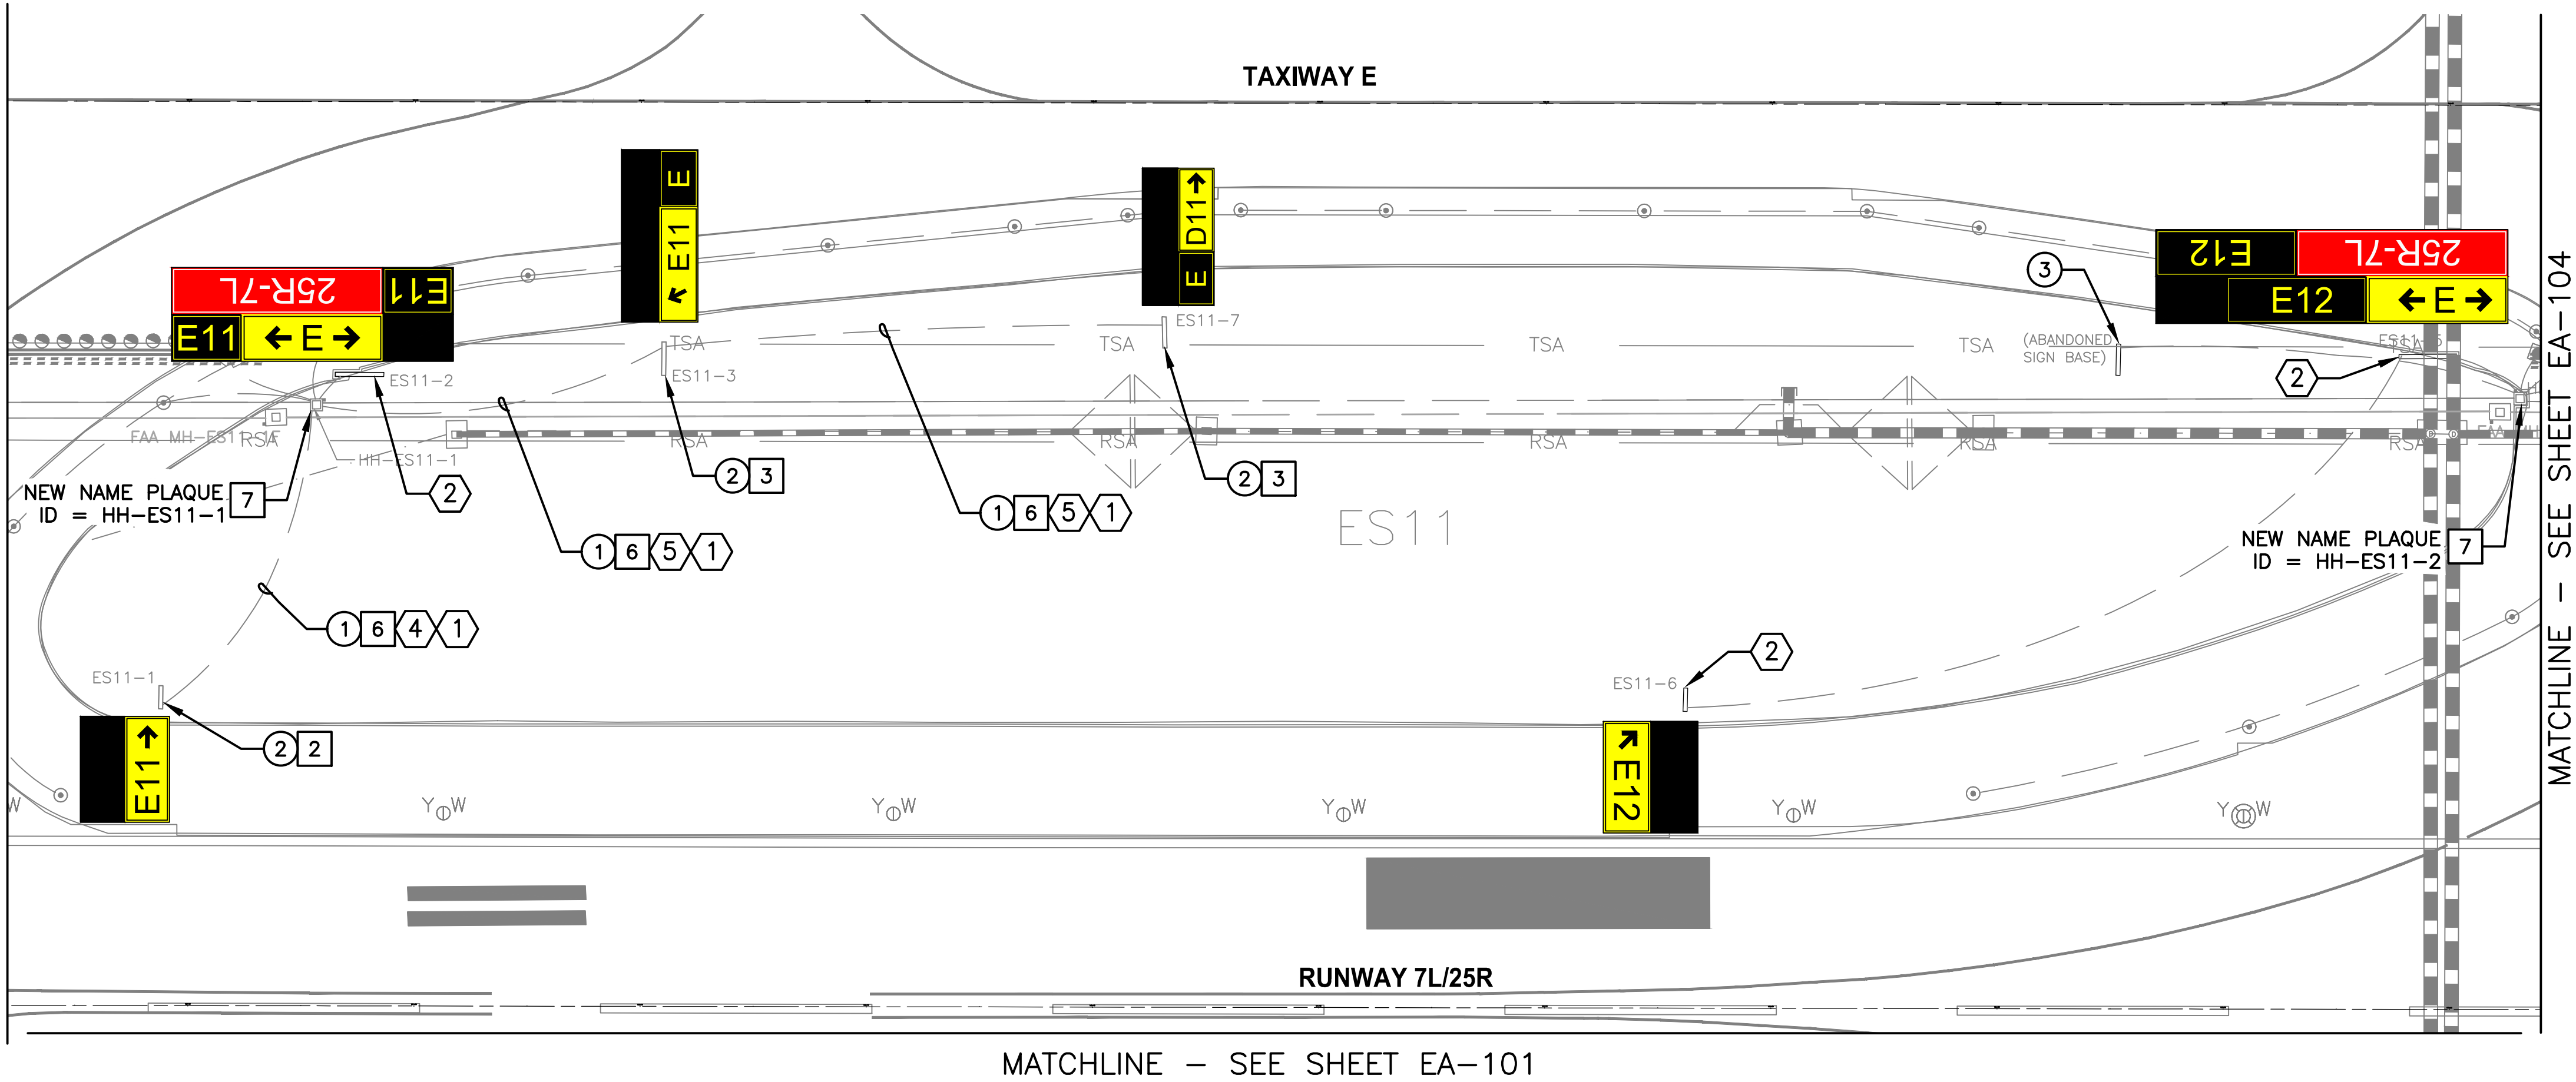

ADJUSTMENT & REMOVAL NOTES

ITEM	DESCRIPTION	QTY
①	REMOVE EXISTING CABLE BACK TO HANDHOLE AND RECONNECT TO MAINTAIN CIRCUIT, EXISTING CONDUIT TO REMAIN.	535 LF
②	REMOVE AND SALVAGE EXISTING SIGN AND ISOLATION TRANSFORMER, REMOVE CONCRETE SIGN BASE.	3 EA
③	REMOVE EXISTING ABANDONED SIGN BASE, RECONNECT EXISTING CONDUIT.	1 EA

CONSTRUCTION NOTES

ITEM	DESCRIPTION	QTY
②	CONSTRUCT NEW CONCRETE AIRFIELD SIGN BASE FOR 2-MODULE SIGN (PER DETAIL 919, SHEET EA-501) AND RECONNECT EXISTING CONDUIT. INSTALL SALVAGED AIRFIELD SIGN AND ISOLATION TRANSFORMER.	1 EA
③	CONSTRUCT NEW CONCRETE AIRFIELD SIGN BASE FOR 3-MODULE SIGN (PER DETAIL 919, SHEET EA-501) AND RECONNECT EXISTING CONDUIT. INSTALL SALVAGED AIRFIELD SIGN AND ISOLATION TRANSFORMER.	2 EA
⑥	NEW 2/C, #8, L-824 TYPE C AIRFIELD LIGHTING CABLE WITH #6 BCC GROUND	595 LF
⑦	INSTALL NEW MANHOLE/HANDHOLE ID PLAQUE PER DETAIL 576, SHEET EA-502	2 EA

REFERENCE NOTES

①	EXISTING CONDUIT/DUCTBANK
②	EXISTING SIGN TO REMAIN
④	CKT R2S
⑤	CKT TES

PRIME CONSULTANT

TRAGE CONSULTING

1071 E. Jefferson St., Suite 31 Phoenix, AZ 85004

SUB CONSULTANT

CR engineers

16719 East Palisades Blvd., Suite 202 Fountain Hills, AZ 85268
Phone: (480) 816-5541
Fax: (480) 816-5540
www.creg.com

PER CITY OF PHOENIX CITY CODE CHAPTER 2, SECTION 2-2-28, THESE PLANS ARE FOR OFFICIAL USE ONLY AND MAY NOT BE SHARED WITH OTHERS EXCEPT AS REQUIRED TO FULFILL THE OBLIGATIONS OF CONTRACTOR'S CONTRACT WITH THE CITY OF PHOENIX.

NO	REVISIONS / SUBMISSIONS	DATE

PHX PWT BYR

CITY OF PHOENIX AVIATION DEPARTMENT

PSHIA INFIELD UTILITY ACCESS UPGRADES AND PAVING

AV 08000074 ADOT

ADOT GRANT NO.: XXXXXXXX

Designed by: SW

Drawn by: JBW

Checked by: CA

Date: 05/31/2023

Dwg scale: 1"=50'

SHEET OVERVIEW TITLE

PARTIAL AIRFIELD ELECTRICAL SITE PLAN

SHEET REFERENCE NUMBER: EA-103

SHEET 19 OF 23

0 50' 100'

ARIZONA811




Contact Arizona 811 at least two full working days before you begin excavation

Call 811 or click Arizona811.com

KEY MAP

NTS

G:\PROJECTS\14000\14069_PSHIA Infield Utility Access Upgrades and Paving\CAD\CAD SHEETS\Phase 3_CAD sheets\GMP5_100% SUBMITTAL CAD FILES\ GMP5 EA-101.dwg -- Mod: 23/2023 8:19am

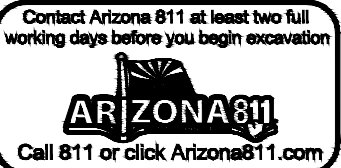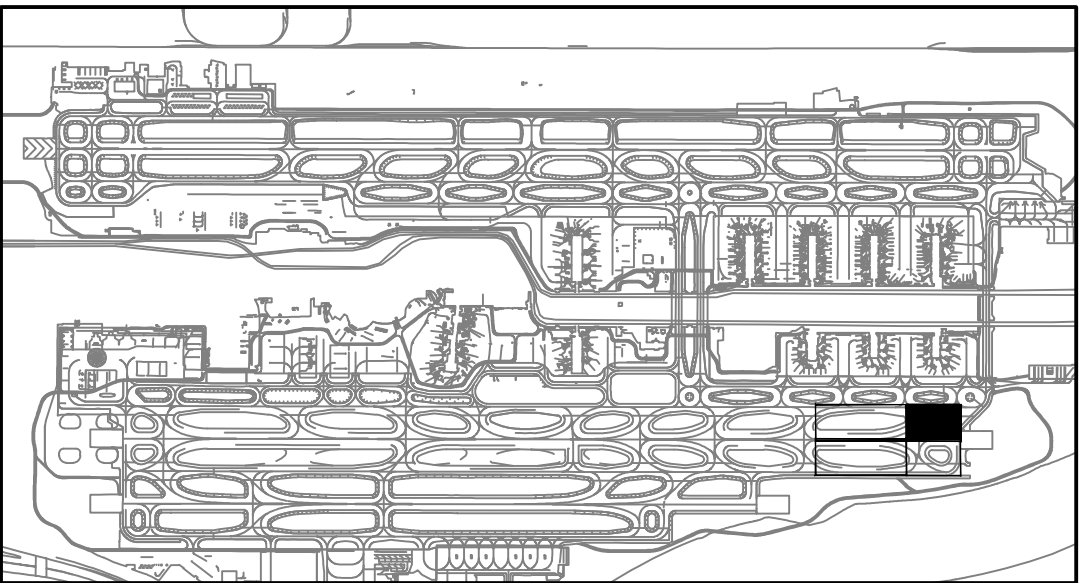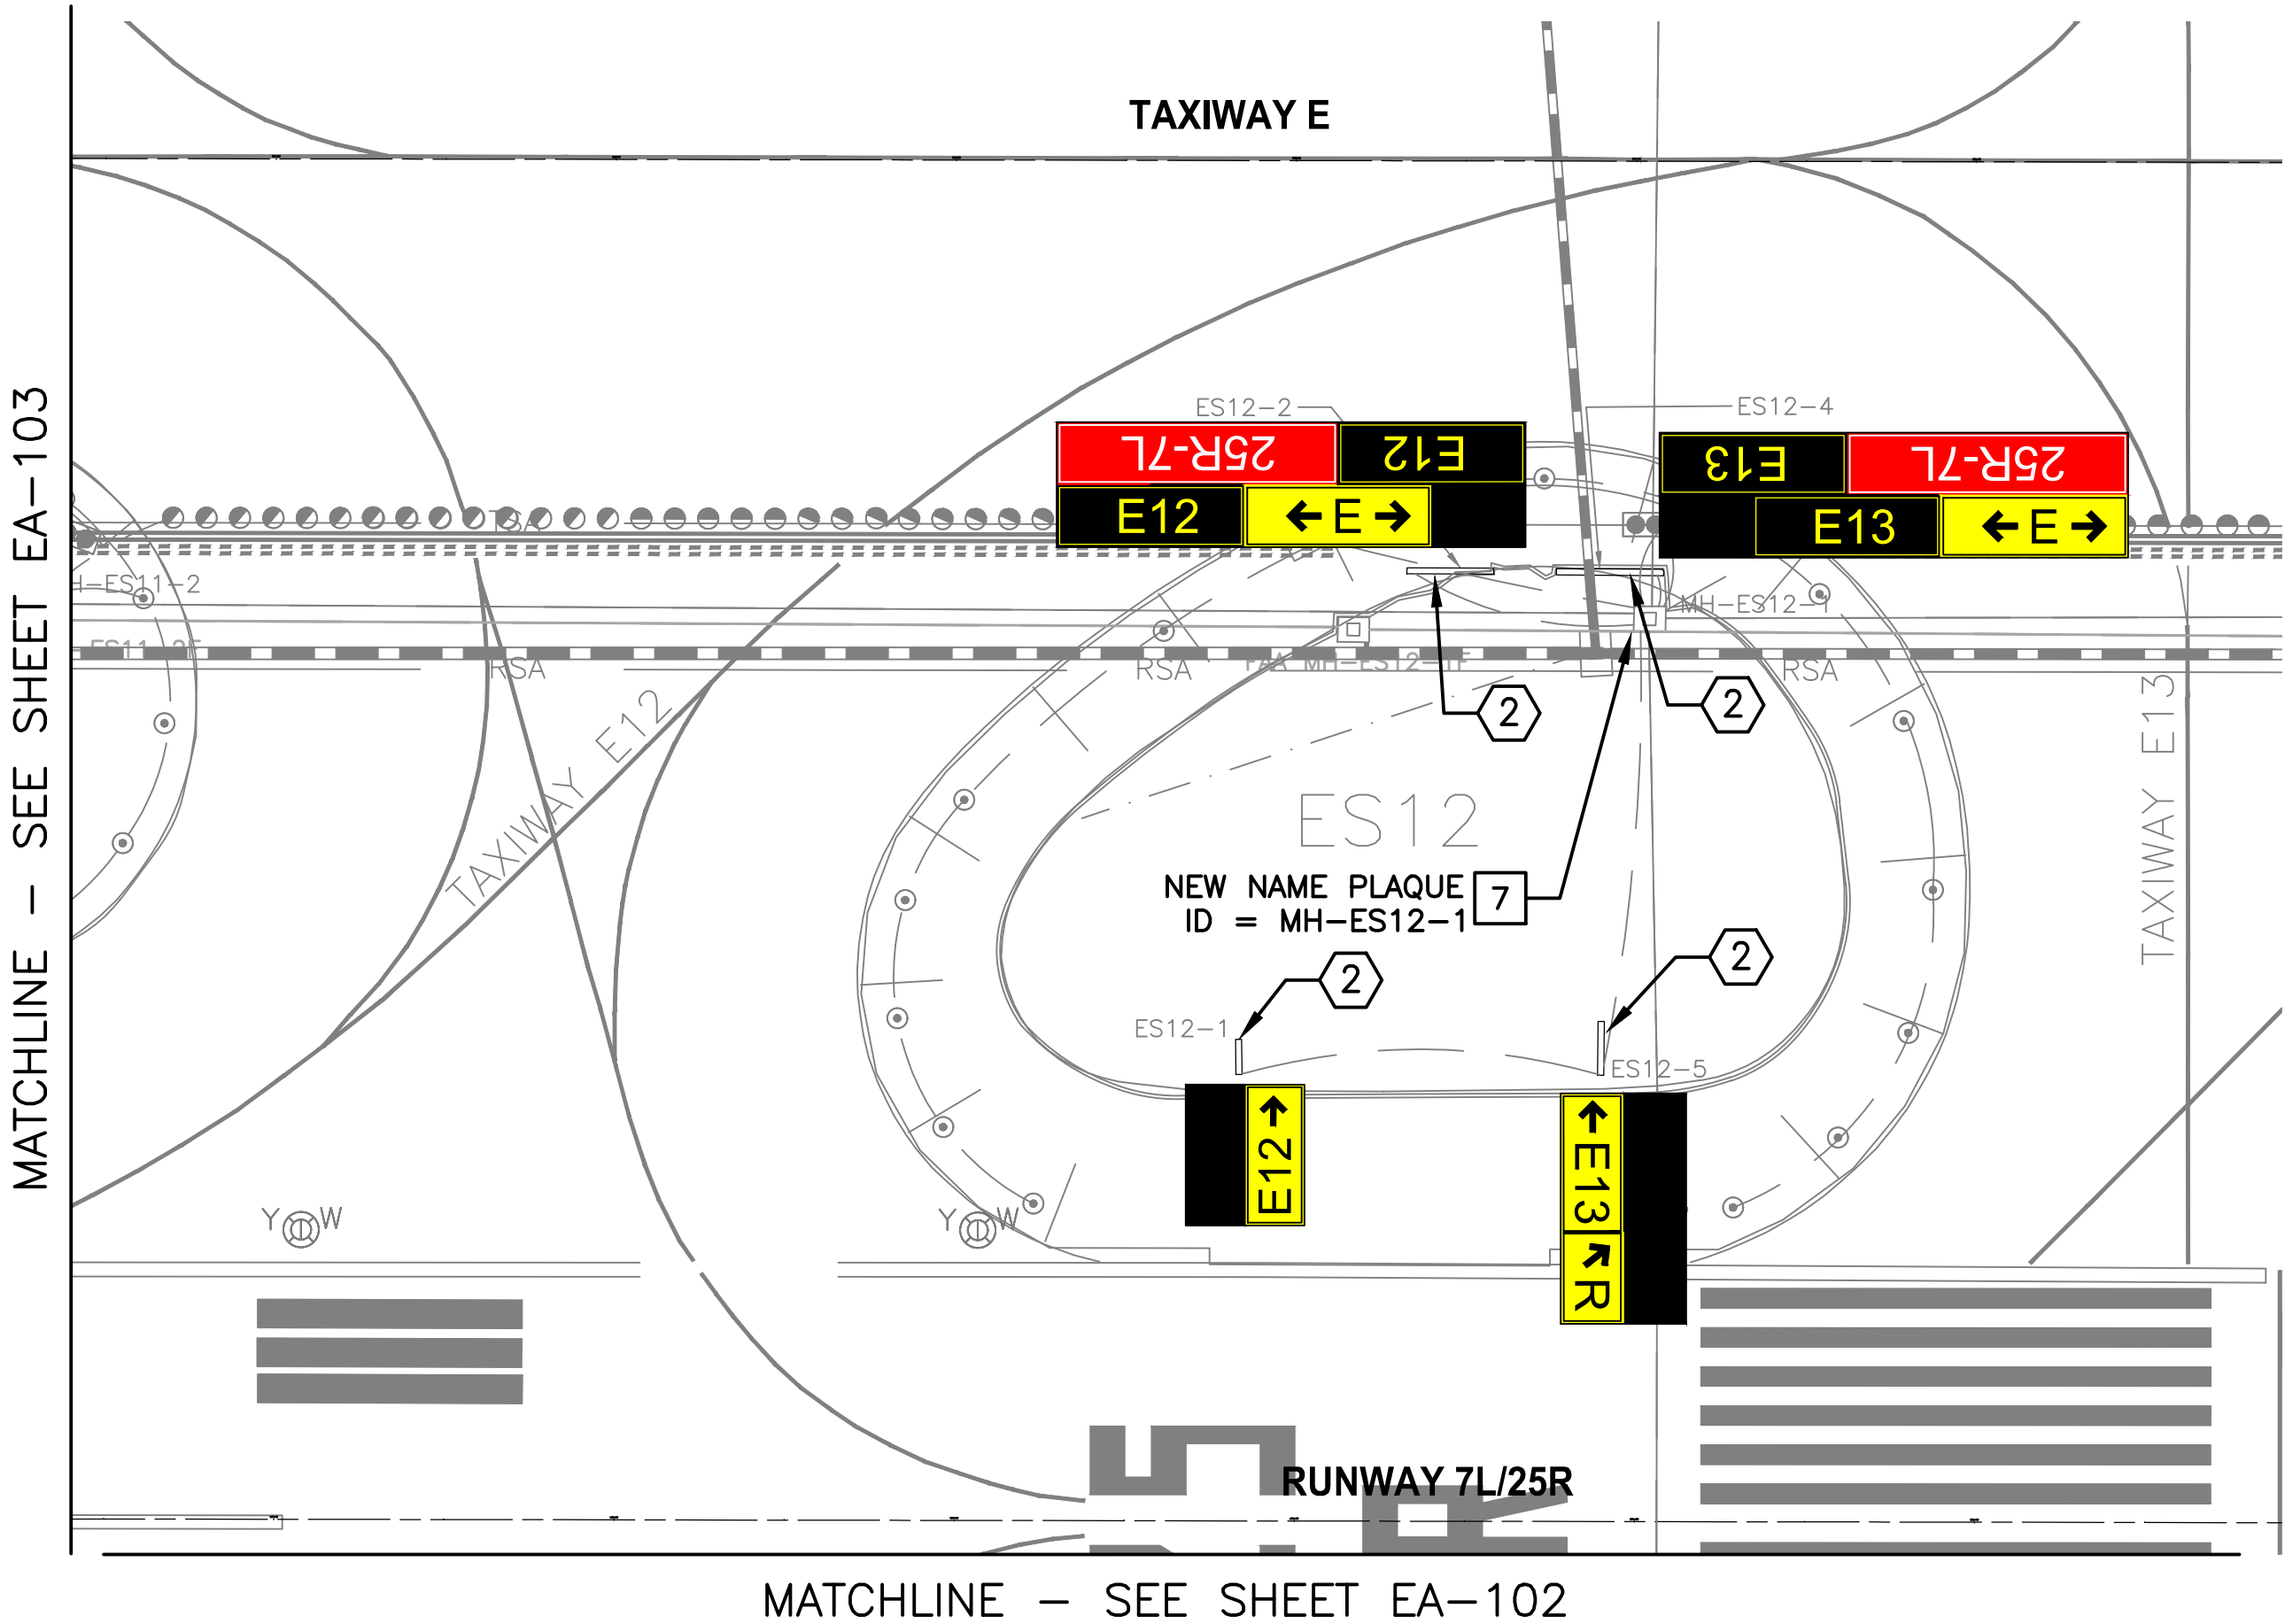

CONSTRUCTION NOTES

ITEM	DESCRIPTION	QTY
7	INSTALL NEW MANHOLE/HANDHOLE ID PLAQUE PER DETAIL 576, SHEET EA-502	1 EA

REFERENCE NOTES

ITEM	DESCRIPTION
2	EXISTING SIGN TO REMAIN


SHEET
REFERENCE
NUMBER:
EA-104
SHEET 20 OF 23

SHEET OVERVIEW TITLE
**PARTIAL AIRFIELD
ELECTRICAL SITE PLAN**

Designed by: SW
Drawn by: JBW
Checked by: CA
Date: 05/31/2023
Dwg scale: 1"=50'


PHX **PHX** **PHX**
CITY OF PHOENIX AVIATION DEPARTMENT
**PSHIA INFIELD
UTILITY ACCESS UPGRADES
AND PAVING**
AV 08000074 ADOT
ADOT GRANT NO.: XXXXXXXX

*PER CITY OF PHOENIX CITY CODE CHAPTER 2,
SECTION 2-2-28, THESE PLANS ARE FOR OFFICIAL
USE ONLY AND MAY NOT BE SHARED WITH
OTHERS EXCEPT AS REQUIRED TO FULFILL THE
OBLIGATIONS OF CONTRACTOR'S CONTRACT WITH
THE CITY OF PHOENIX*

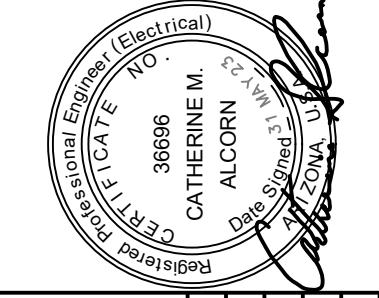


PRIME CONSULTANT
TRAGE
CONSULTING
1207 E. Jefferson St., Suite 31 Phoenix, AZ 85004

SUB CONSULTANT
CR **engineers**
16719 East Palisades Blvd., Suite 202
Fountain Hills, AZ 85268
Phone: (480) 816-5541
Fax: (480) 816-5540
www.creng.com

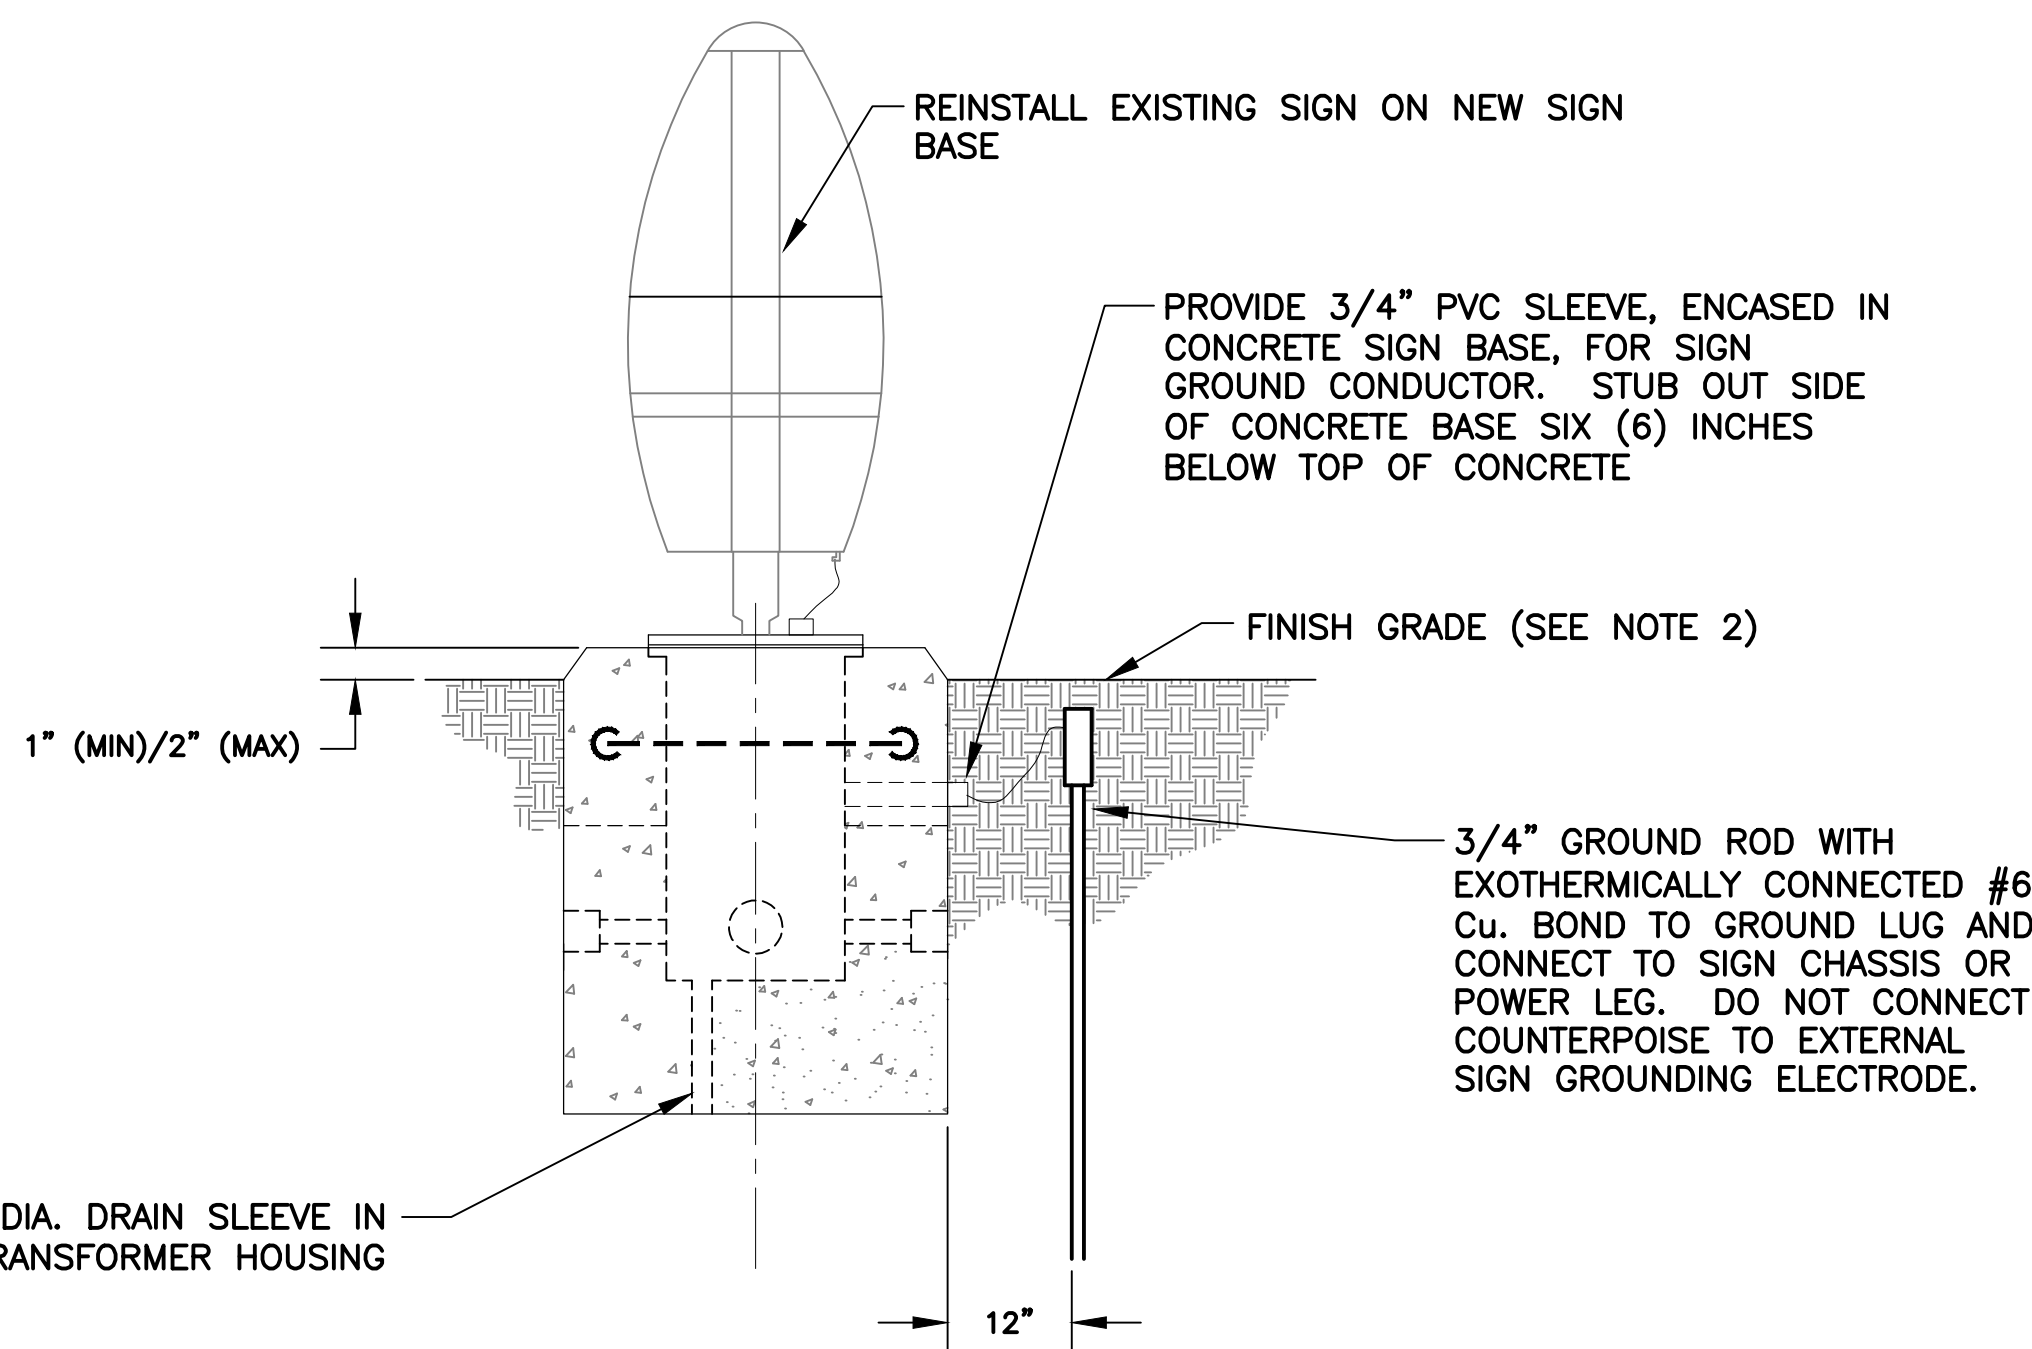

# OF MODULES	BASE LENGTH (A)
1	7' / 84"
2	10.5' / 126"
3	14' / 168"
4	17.5' / 210"
5	21' / 252"

SIZE 4 RDR	BASE LENGTH = 7.5' / 90"
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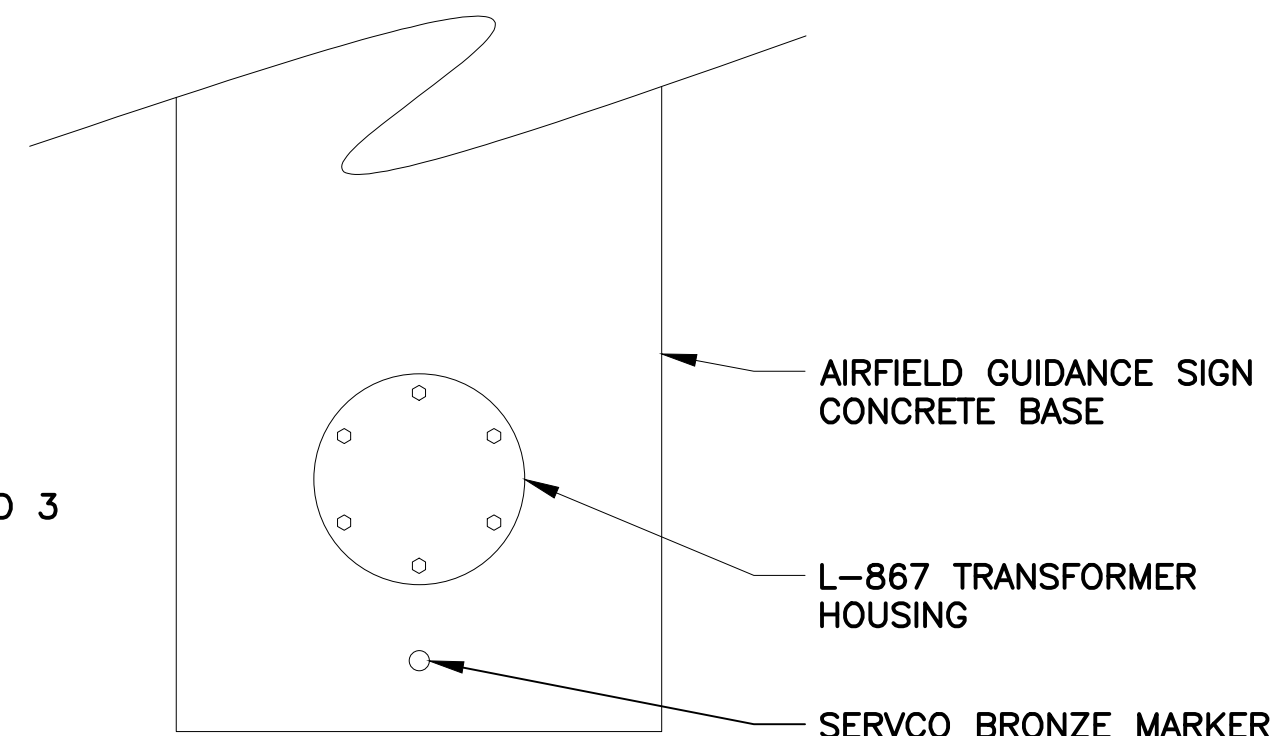


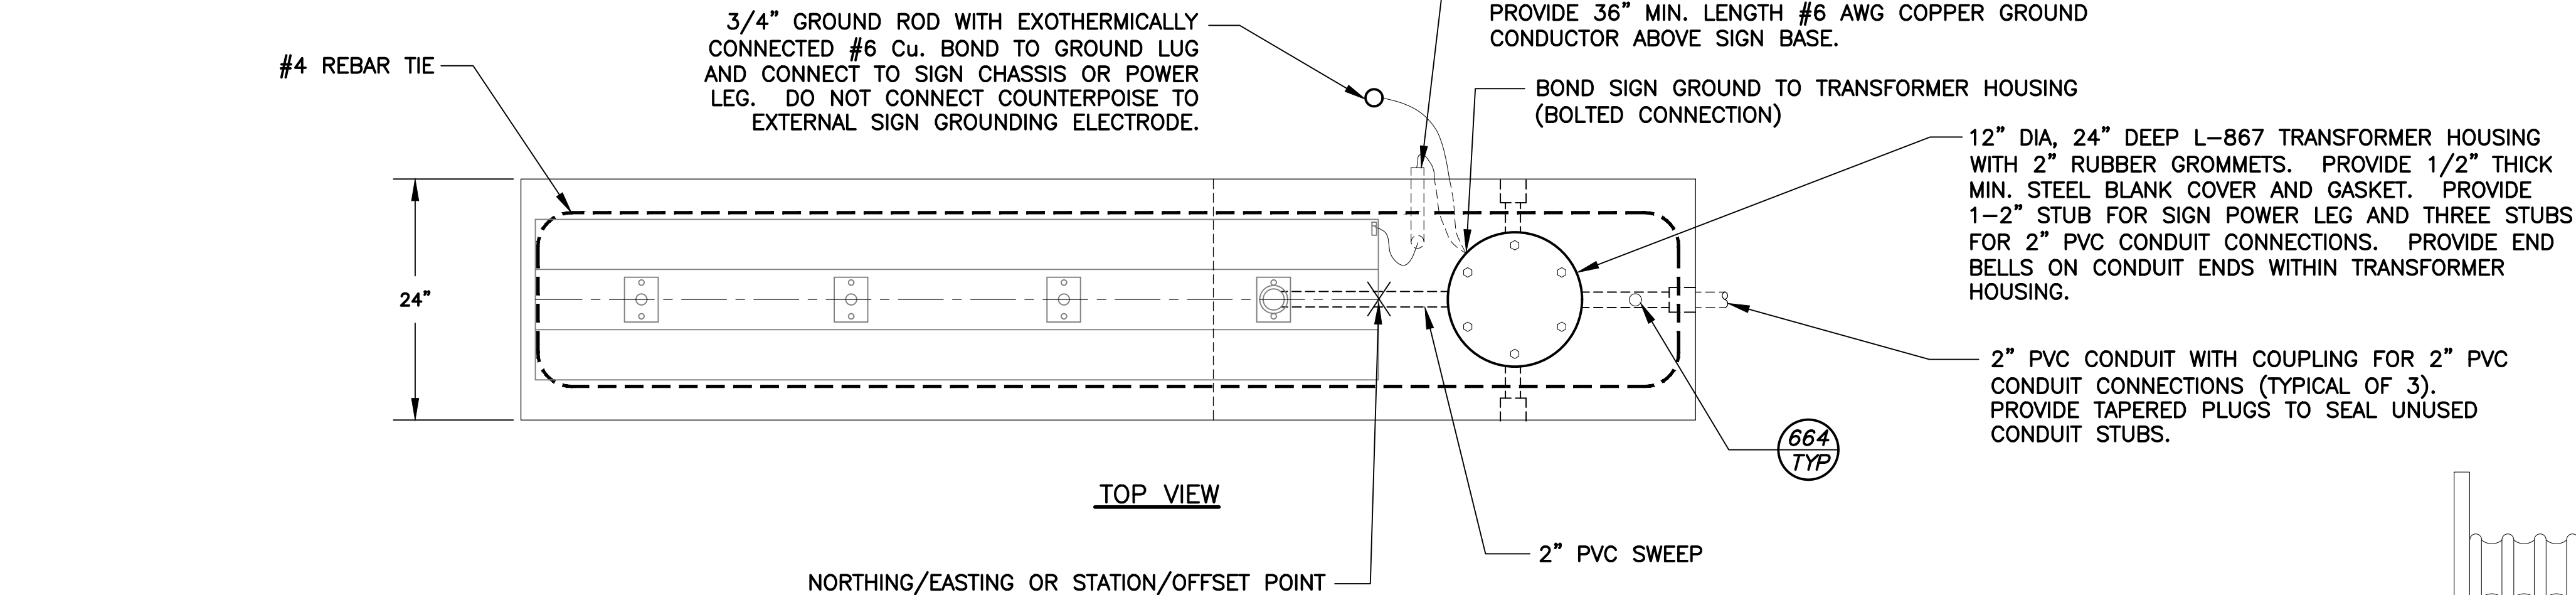SIGN #	ELEVATION	NORTHING	EASTING
ES11-1	1125.00	884632.47	674995.92
ES11-3	1124.29	884791.81	675218.50
ES11-7	1124.96	884802.87	675439.65
FN12-4	1128.44	884364.41	676391.88
FN12-5	1128.68	884364.81	676497.46
FN11-1	1124.95	884367.20	674995.57
FN11-6	1126.76	884365.96	675673.86
R2DR9	1125.60	884351.32	675407.60

1. NEW CAST-IN-PLACE TAXIWAY GUIDANCE SIGN BASE DETAIL SHOWN WITH A TWO MODULE SIGN FOR ILLUSTRATIVE PURPOSES ONLY. SEE FIGURE 1.1 FOR ACTUAL LENGTH OF BASE NEEDED FOR MULTIPLE MODULE SIGNS.
2. BASE SHALL BE LEVEL CONSTRUCTED 1" ABOVE HIGHEST POINT OF SURROUNDING GRADE OR EDGE OF TAXIWAY SHOULDER PAVEMENT AS APPLICABLE.
3. TRANSFORMER HOUSING SHALL BE ORIENTED AT RUNWAY/TAXIWAY EDGE PER PSIA STANDARDS, UNLESS OTHERWISE NOTED.
4. 4000 PSI MINIMUM STRENGTH CONCRETE AT 28 DAYS.


SIGN SIZE	LEGEND HEIGHT	LEGEND PANEL HEIGHT	INSTALLED * (MAX.)	PERPENDICULAR DISTANCE FROM DEFINED PAVMENT EDGE TO NEAR SIDE OF SIGN
1	12"	18"	30"	10' – 20'
2	15"	24"	36"	20' – 35'
3	18"	30"	42"	35' – 60'

- NOTE:**
1. STAMP CIRCUIT IDENTIFICATION INTO BASE MARKER WITH 1/2" CHARACTERS.
 2. PROVIDE CIRCUIT ID MARKERS AT NEW SIGN BASES.
 3. TES/TFS = TAXIWAY ECHO/FOXTROT SIGNS
R2S = RUNWAY 2 SIGNS



SHEET OVERVIEW TITLE AIRFIELD GUIDANCE SIGN BASE INSTALLATION DETAIL	SHEET REFERENCE NUMBER: EA-501	SHEET 21 OF 23																																	
	Designed by: SW Drawn by: JBW Checked by: CA Date: 05/31/2023 Dwg scale: NTS	 <p> PHX DVI BYR CITY OF PHOENIX AVIATION DEPARTMENT PSHIA INFIELD UTILITY ACCESS UPGRADES AND PAVING AV 08000074 ADOT ADOT GRANT NO.: XXXXXXXX </p>	"PER CITY OF PHOENIX CITY CODE CHAPTER 2, SECTION 2-28, THESE PLANS ARE FOR OFFICIAL USE ONLY AND MAY NOT BE SHARED WITH OTHERS EXCEPT AS REQUIRED TO FULFILL THE OBLIGATIONS OF CONTRACTOR'S CONTRACT WITH THE CITY OF PHOENIX"																																
<table border="1"> <thead> <tr> <th>NO</th> <th>REVISIONS / SUBMISSIONS</th> <th>DATE</th> </tr> </thead> <tbody> <tr><td> </td><td> </td><td> </td></tr> <tr><td> </td><td> </td><td> </td></tr> <tr><td> </td><td> </td><td> </td></tr> <tr><td> </td><td> </td><td> </td></tr> <tr><td> </td><td> </td><td> </td></tr> <tr><td> </td><td> </td><td> </td></tr> <tr><td> </td><td> </td><td> </td></tr> <tr><td> </td><td> </td><td> </td></tr> <tr><td> </td><td> </td><td> </td></tr> <tr><td> </td><td> </td><td> </td></tr> </tbody> </table>			NO	REVISIONS / SUBMISSIONS	DATE																														
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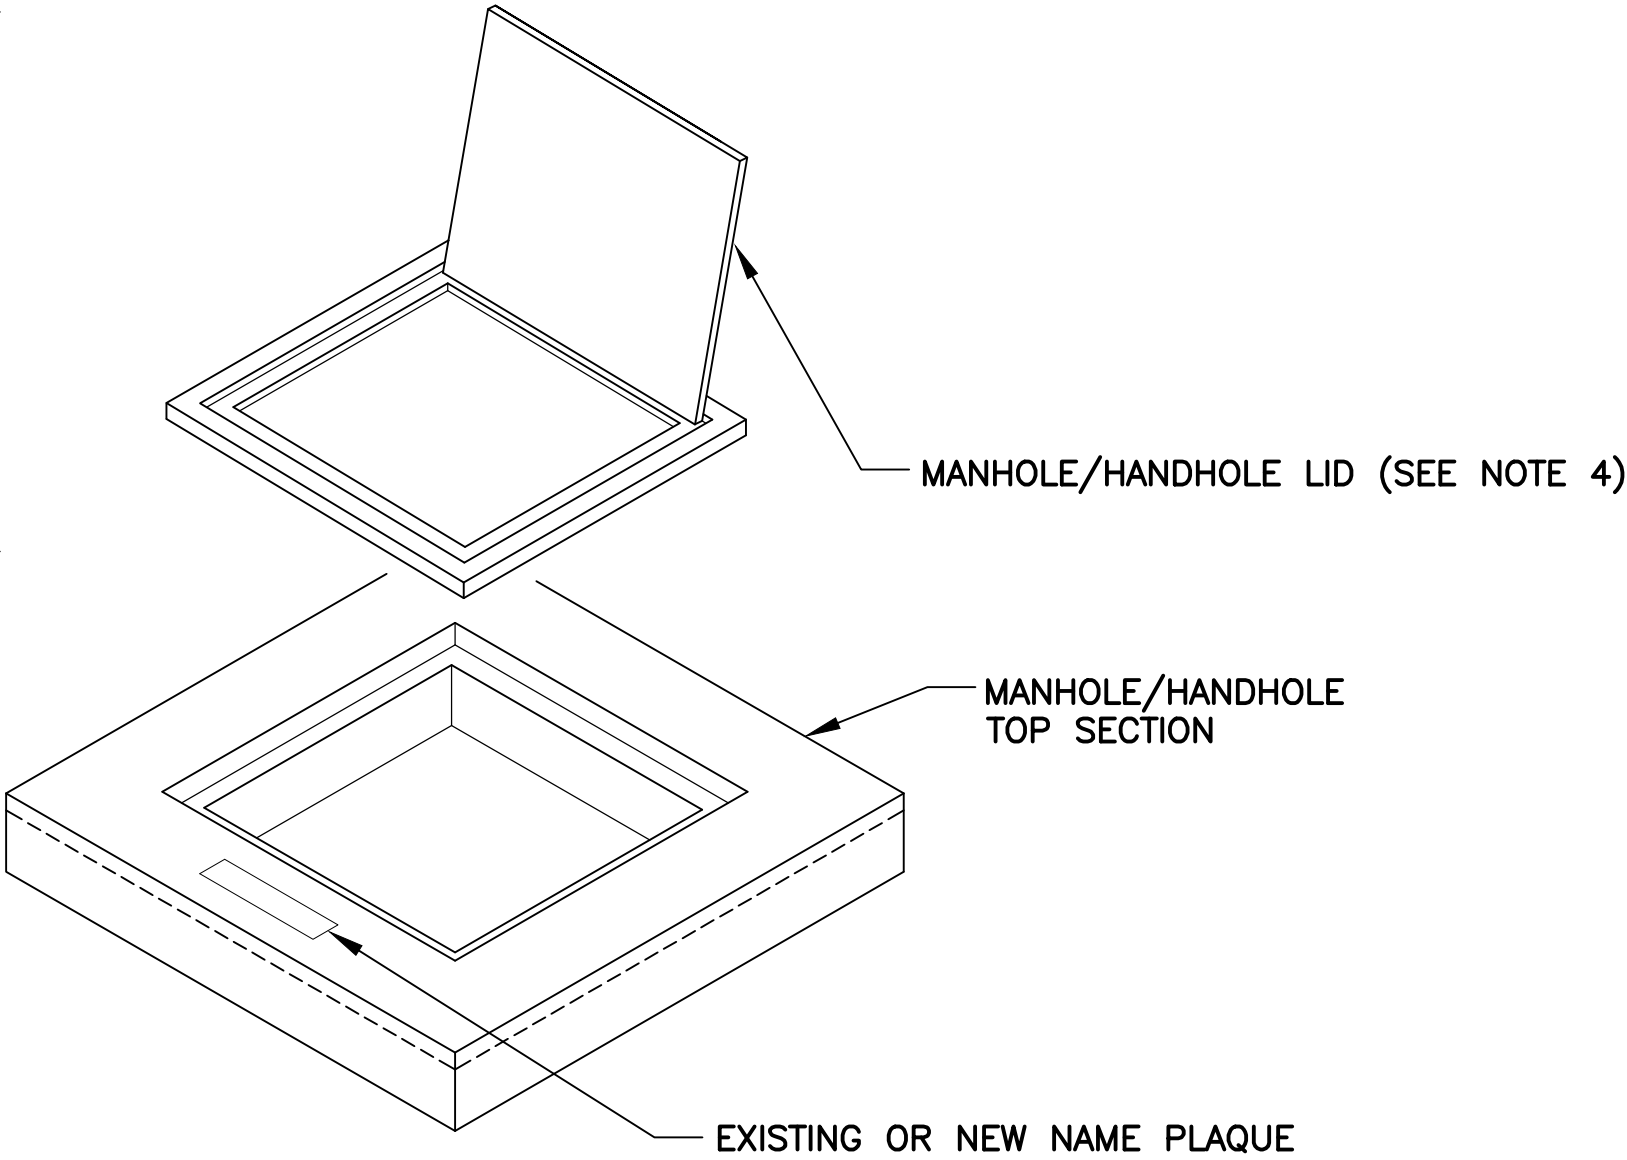
G:\PROJECTS\14000\14069 PSHA Infield Access Upgrades and Paving\CAD\SHEETS\Phase 3 CAD sheets\GMP5 100% SUBMITTAL CAD FILES\ GMP5 EA-502.dwg -- Mod: 23/2023 8:21 am

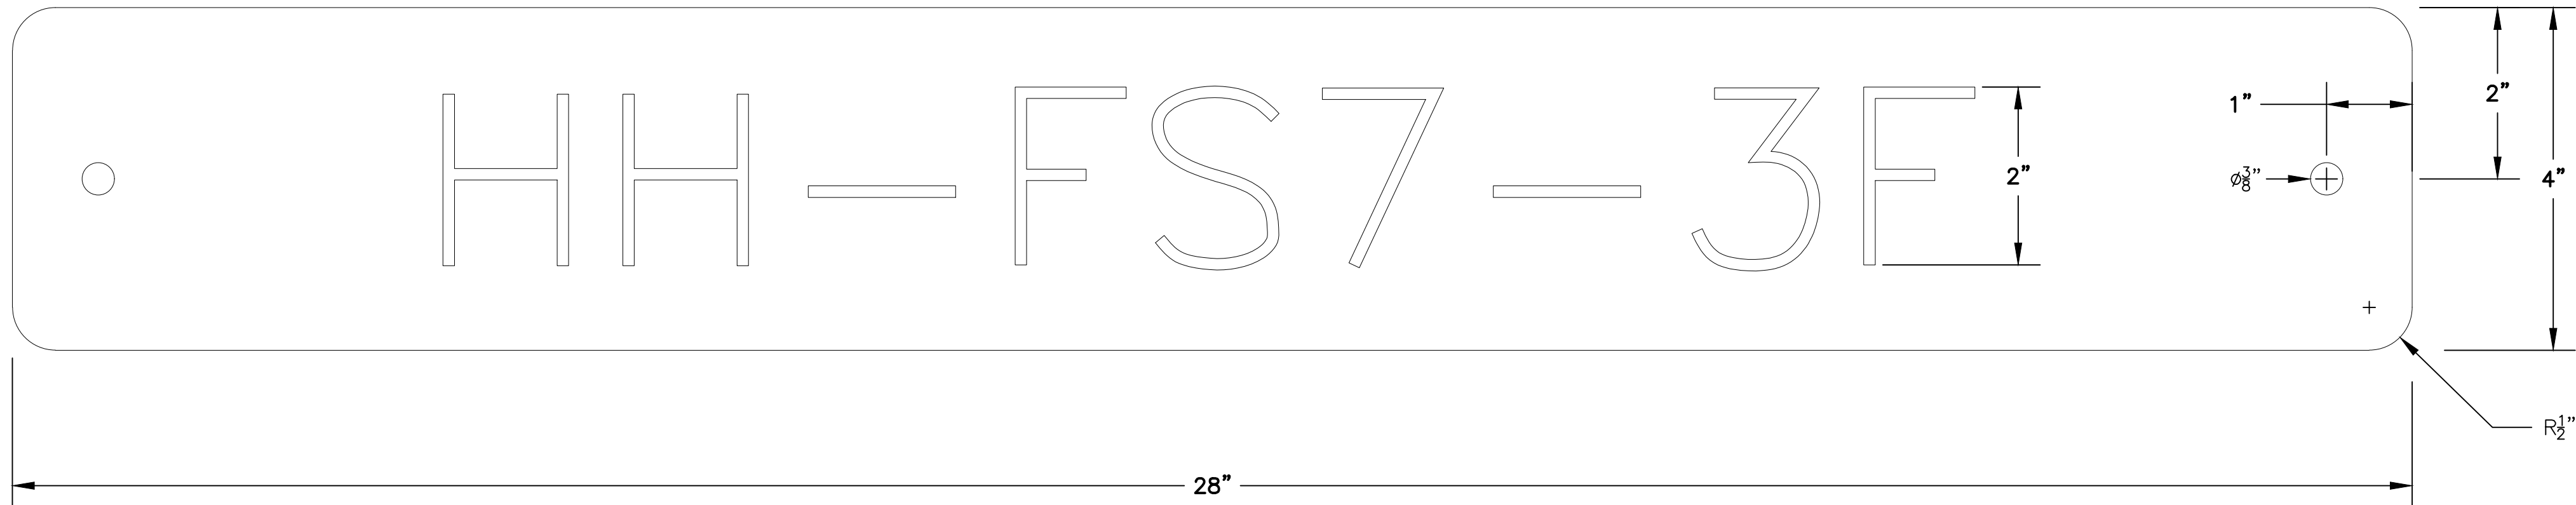

576
TYP NAME PLAQUE
NTS

NOTES:


1. NAME PLAQUE IS TO BE 4" IN HEIGHT, 28" IN WIDTH, AND 1/8" THICK. THE NAME PLAQUE SHALL BE ALUMINUM.
2. LETTERING IS TO BE 2" IN HEIGHT, AND 1 1/4" IN WIDTH. LETTERING IS TO BE CENTERED VERTICALLY AND HORIZONTALLY ON THE PLAQUE.
3. LETTERING SHOULD BE CUT BY A COMPUTER-AIDED PLASMA CUTTER, OR SIMILAR DEVICE, TO INSURE THE EDGES ARE STRAIGHT AND CLEAN.
4. 3/8" DIA. HOLES WILL BE PROVIDED ON BOTH ENDS, TO ALLOW THE USE OF CONCRETE ANCHOR SCREWS, TO ATTACH TO THE CONCRETE TOP SECTION OF THE MANHOLE/HANDHOLE.
5. EXISTING AIRFIELD ELECTRICAL MANHOLE/HANDHOLE ID NAME PLAQUES SHALL BE REMOVED FROM EXISTING LIDS FOR REINSTALLATION ON NEW MANHOLE/HANDHOLE LIDS
6. NEW NAME PLAQUES ARE REQUIRED WHERE NEW MANHOLE/HANDHOLE DESIGNATIONS HAVE BEEN ASSIGNED.
7. REFER TO CIVIL PLAN SHEETS FOR MANHOLE/HANDHOLE LOCATIONS AND ELEVATIONS.



NAME PLAQUE PLACEMENT
NTS

NOTES:


1. PLACE NAME PLAQUE ON THE FRONT OF THE MANHOLE/HANDHOLE, AS THE LID OPENS.
2. NAME PLAQUE IS TO BE CENTERED HORIZONTALLY AND VERTICALLY, AS SHOWN.
3. REMOVAL AND REINSTALLATION OF NAME PLAQUES IS CONSIDERED INCIDENTAL TO THE INSTALLATION OF NEW HAND HOLE LIDS.
4. ALL HATCH/LID HINGES SHALL BE ORIENTED ON RUNWAY OR TAXIWAY SIDE OF STRUCTURE.

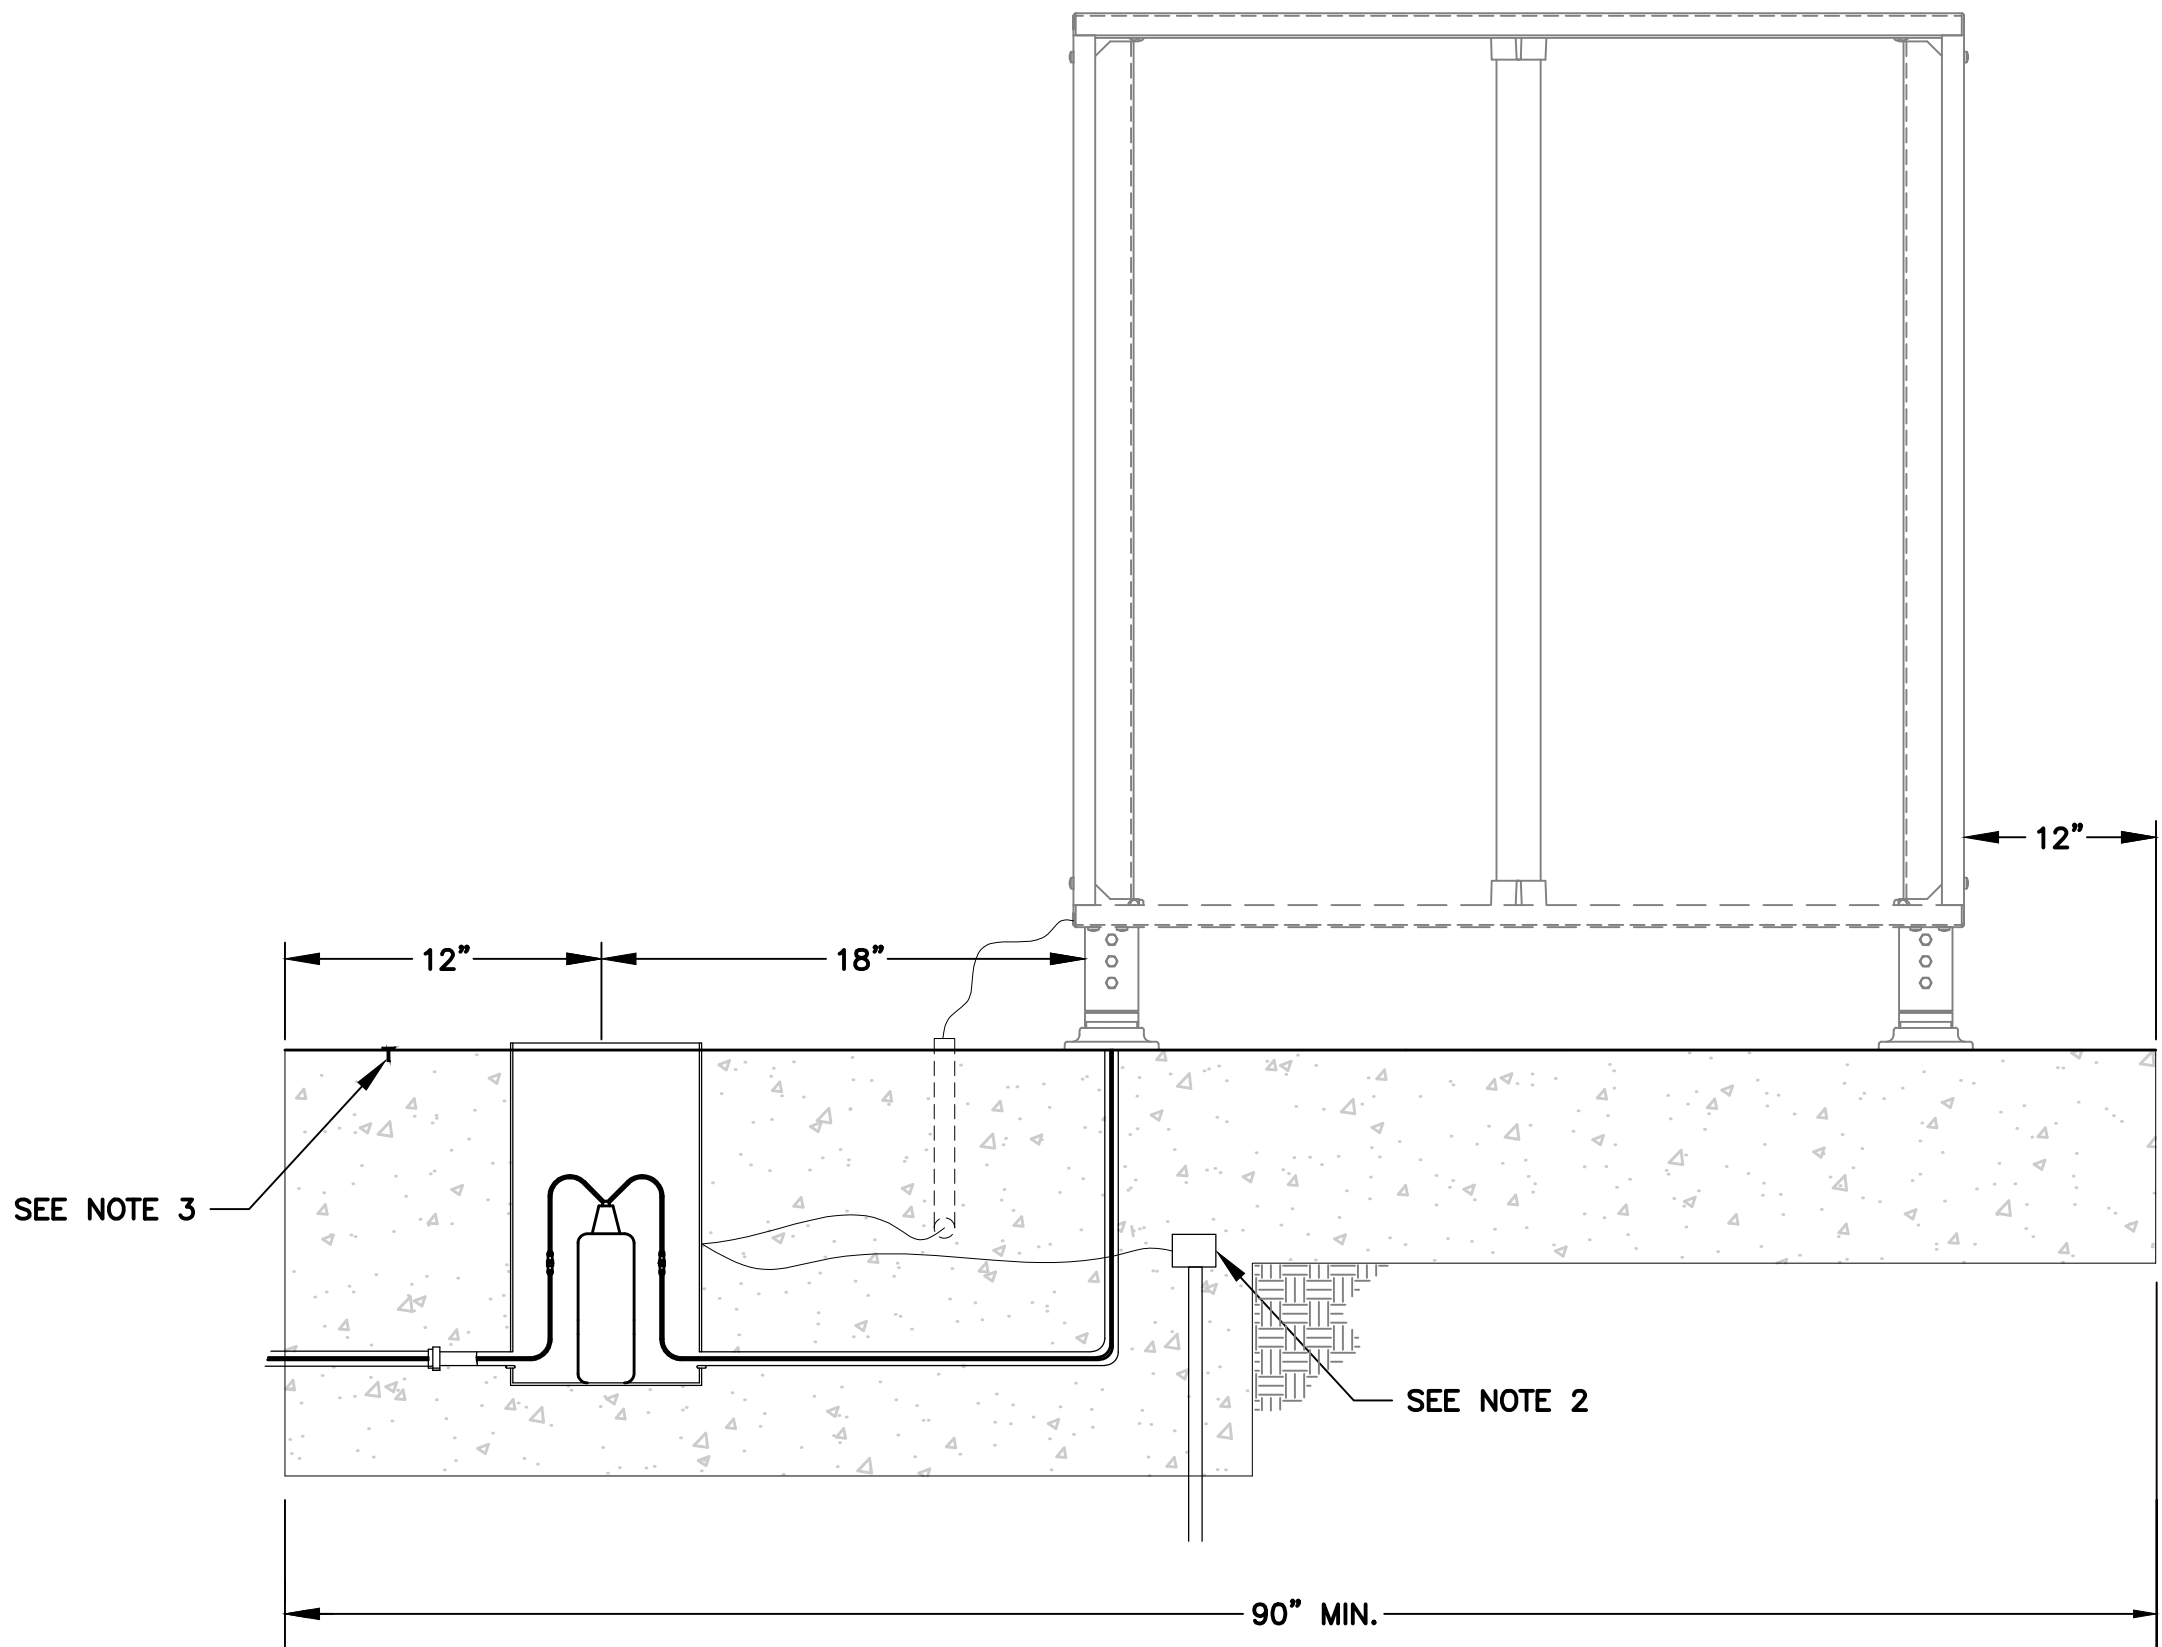

920
TYP RUNWAY DISTANCE REMAINING SIGN - REMOTE MOUNT
NTS

NOTES:

1. REINSTALL EXISTING RUNWAY DISTANCE REMAINING SIGN ON NEW CONCRETE SIGN BASE.
2. PROVIDE AND INSTALL NEW GROUND ROD WITH #6 COPPER GROUND AT SIGN. BOND TO TRANSFORMER HOUSING AND SIGN.
3. STAMP CIRCUIT IDENTIFICATION INTO MARKER WITH 1/2" CHARACTERS.

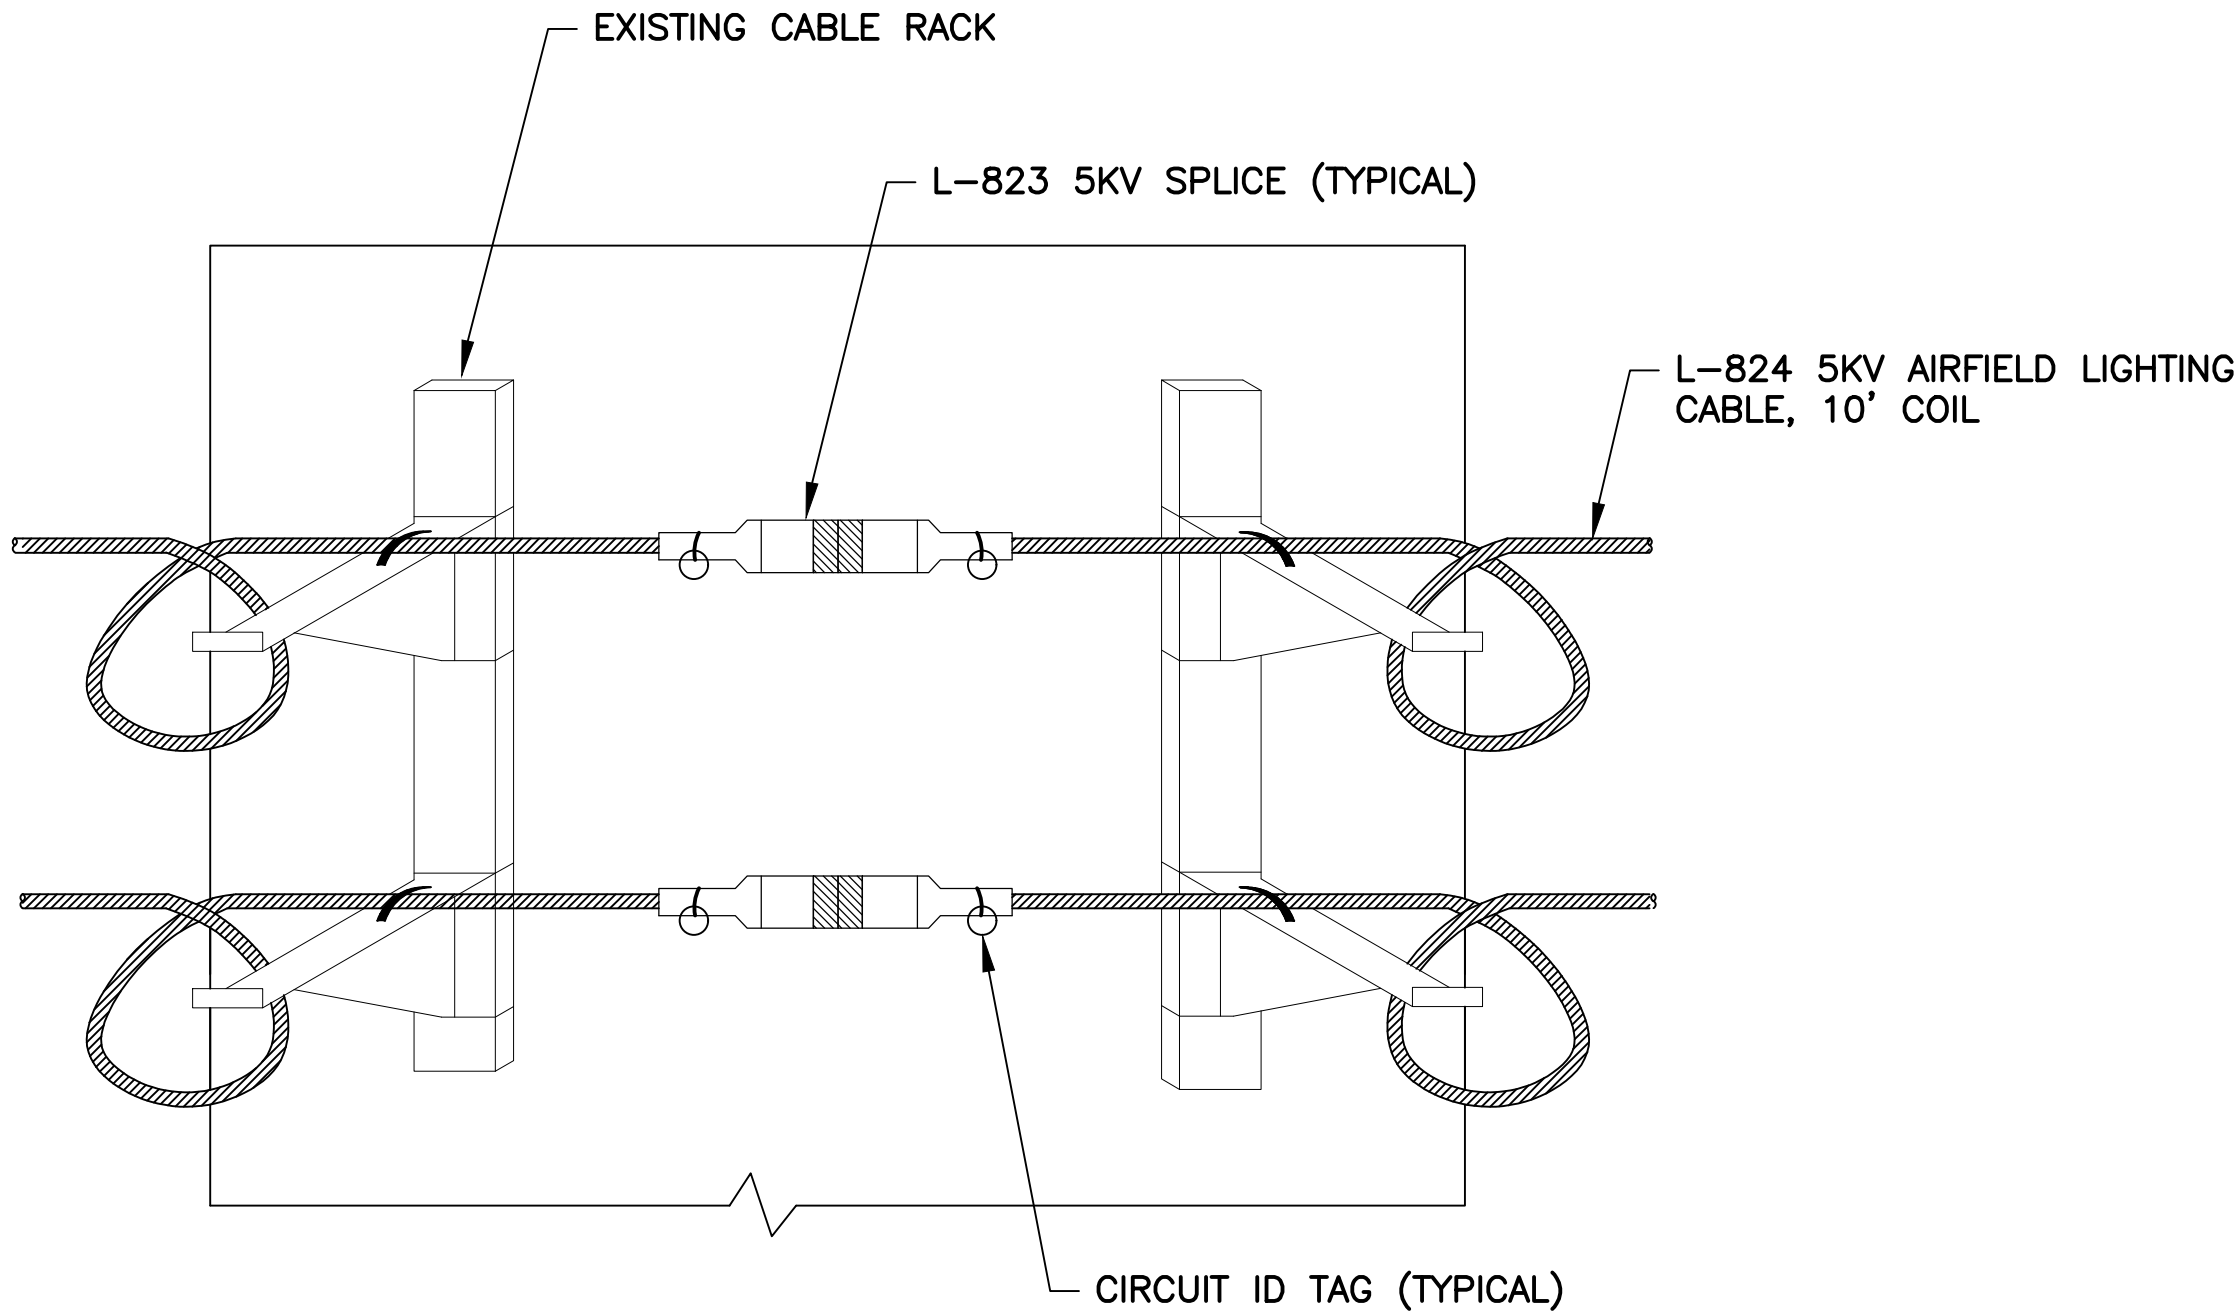




CABLE RACKING DETAIL

NOTES:

1. CONTRACTOR SHALL RACK NEW CABLES IN EXISTING HANDHOLES. PROVIDE CIRCUIT ID TAGS AND COLOR IDENTIFICATION TO MATCH EXISTING.
2. PROVIDE NEW L-823, PRIMARY CONNECTOR KITS FOR NEW CABLES.

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			NO	REVISIONS / SUBMISSIONS	DATE		
PHX AVI BYR CITY OF PHOENIX AVIATION DEPARTMENT PSHIA INFIELD UTILITY ACCESS UPGRADES AND PAVING AV 08000074 ADOT ADOT GRANT NO.: XXXXXXXX			Designed by: SW	Drawn by: JBW	Checked by: CA	Date: 05/31/2023	Dwg scale: NTS
RDR SIGN BASE INSTALLATION AND MANHOLE DETAILS			SHEET REFERENCE NUMBER: EA-502				
SHEET OVERVIEW TITLE			SHEET 22 OF 23				

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- NOTES**
1. PROVIDE MALE AND FEMALE L-823 CONNECTORS AS REQUIRED ON EACH CONDUCTOR IN EACH BASE, HANDHOLE, OR MANHOLE TO ALLOW ISOLATION OF HOMERUN CIRCUIT, NO STRAIGHT-THROUGH ALLOWED.
 2. ALL CABLE ENDS SHALL BE PREPARED WITH THE USE OF A TAPERING TOOL SPECIFICALLY DESIGNED FOR USE WITH L-824 CABLES.
 3. PLUG AND RECEPTACLE END FITTINGS SHALL BE CRIMPED ONTO THE CONDUCTOR BY USE OF AN AIRPORT PERSONNEL ACCEPTED RATCHETING TYPE CRIMPING TOOL.
 4. AT THE POINT OF CONNECTION WITH THE EXISTING FIELD CIRCUITS, INSTALL NEW L-823 PLUGS ON BOTH THE NEW AND EXISTING CABLES. VERIFY INSULATION TYPES OF BOTH NEW & EXISTING CABLES AND COORDINATE WITH TERMINATION KITS TO ASSURE PROPER AND WATERPROOF FIT.
 5. INSTALL THREE (3) TAPE LAYERS OVER L-823 CONNECTIONS AFTER PULLING SLEEVE OVER COMPLETE KIT (SCOTCH OR EQUAL):
1ST LAYER - 33+ VINYL ELECTRICAL TAPE
2ND LAYER - 130C RUBBER SPLICING TAPE
3RD LAYER - 33+ VINYL ELECTRICAL TAPE
 6. THERE SHALL BE NO SPLICES BETWEEN LIGHTS, ONLY IN BASES OR HANDHOLES.
 7. PROVIDE AND INSTALL NON-CONDUCTIVE CIRCUIT IDENTIFICATION TAGS ATTACHED TO EACH SIDE OF ALL CONNECTOR KITS.
 8. ON THE CABLES FOR THE RUNWAY AND SIGNAGE CIRCUITS, TAPE FROM THE BACK END OF THE CONNECTOR KIT ONTO CABLE FOR 3" EACH, RED THEN WHITE PHASE TAPE FOR SIGNS, RED ONLY PHASE TAPE FOR RUNWAY EDGE LIGHTS, FOR FASTER IDENTIFICATION AND MATCH EXISTING MANHOLE LAYOUTS.
 9. ON THE CABLES FOR THE TAXIWAY AND SIGNAGE CIRCUITS, TAPE FROM THE BACK END OF THE CONNECTOR KIT ONTO CABLE FOR 3" EACH, BLUE THEN WHITE PHASE TAPE FOR SIGNS, BLUE ONLY PHASE TAPE FOR TAXIWAY EDGE LIGHTS, FOR FASTER IDENTIFICATION AND MATCH EXISTING MANHOLE LAYOUTS.

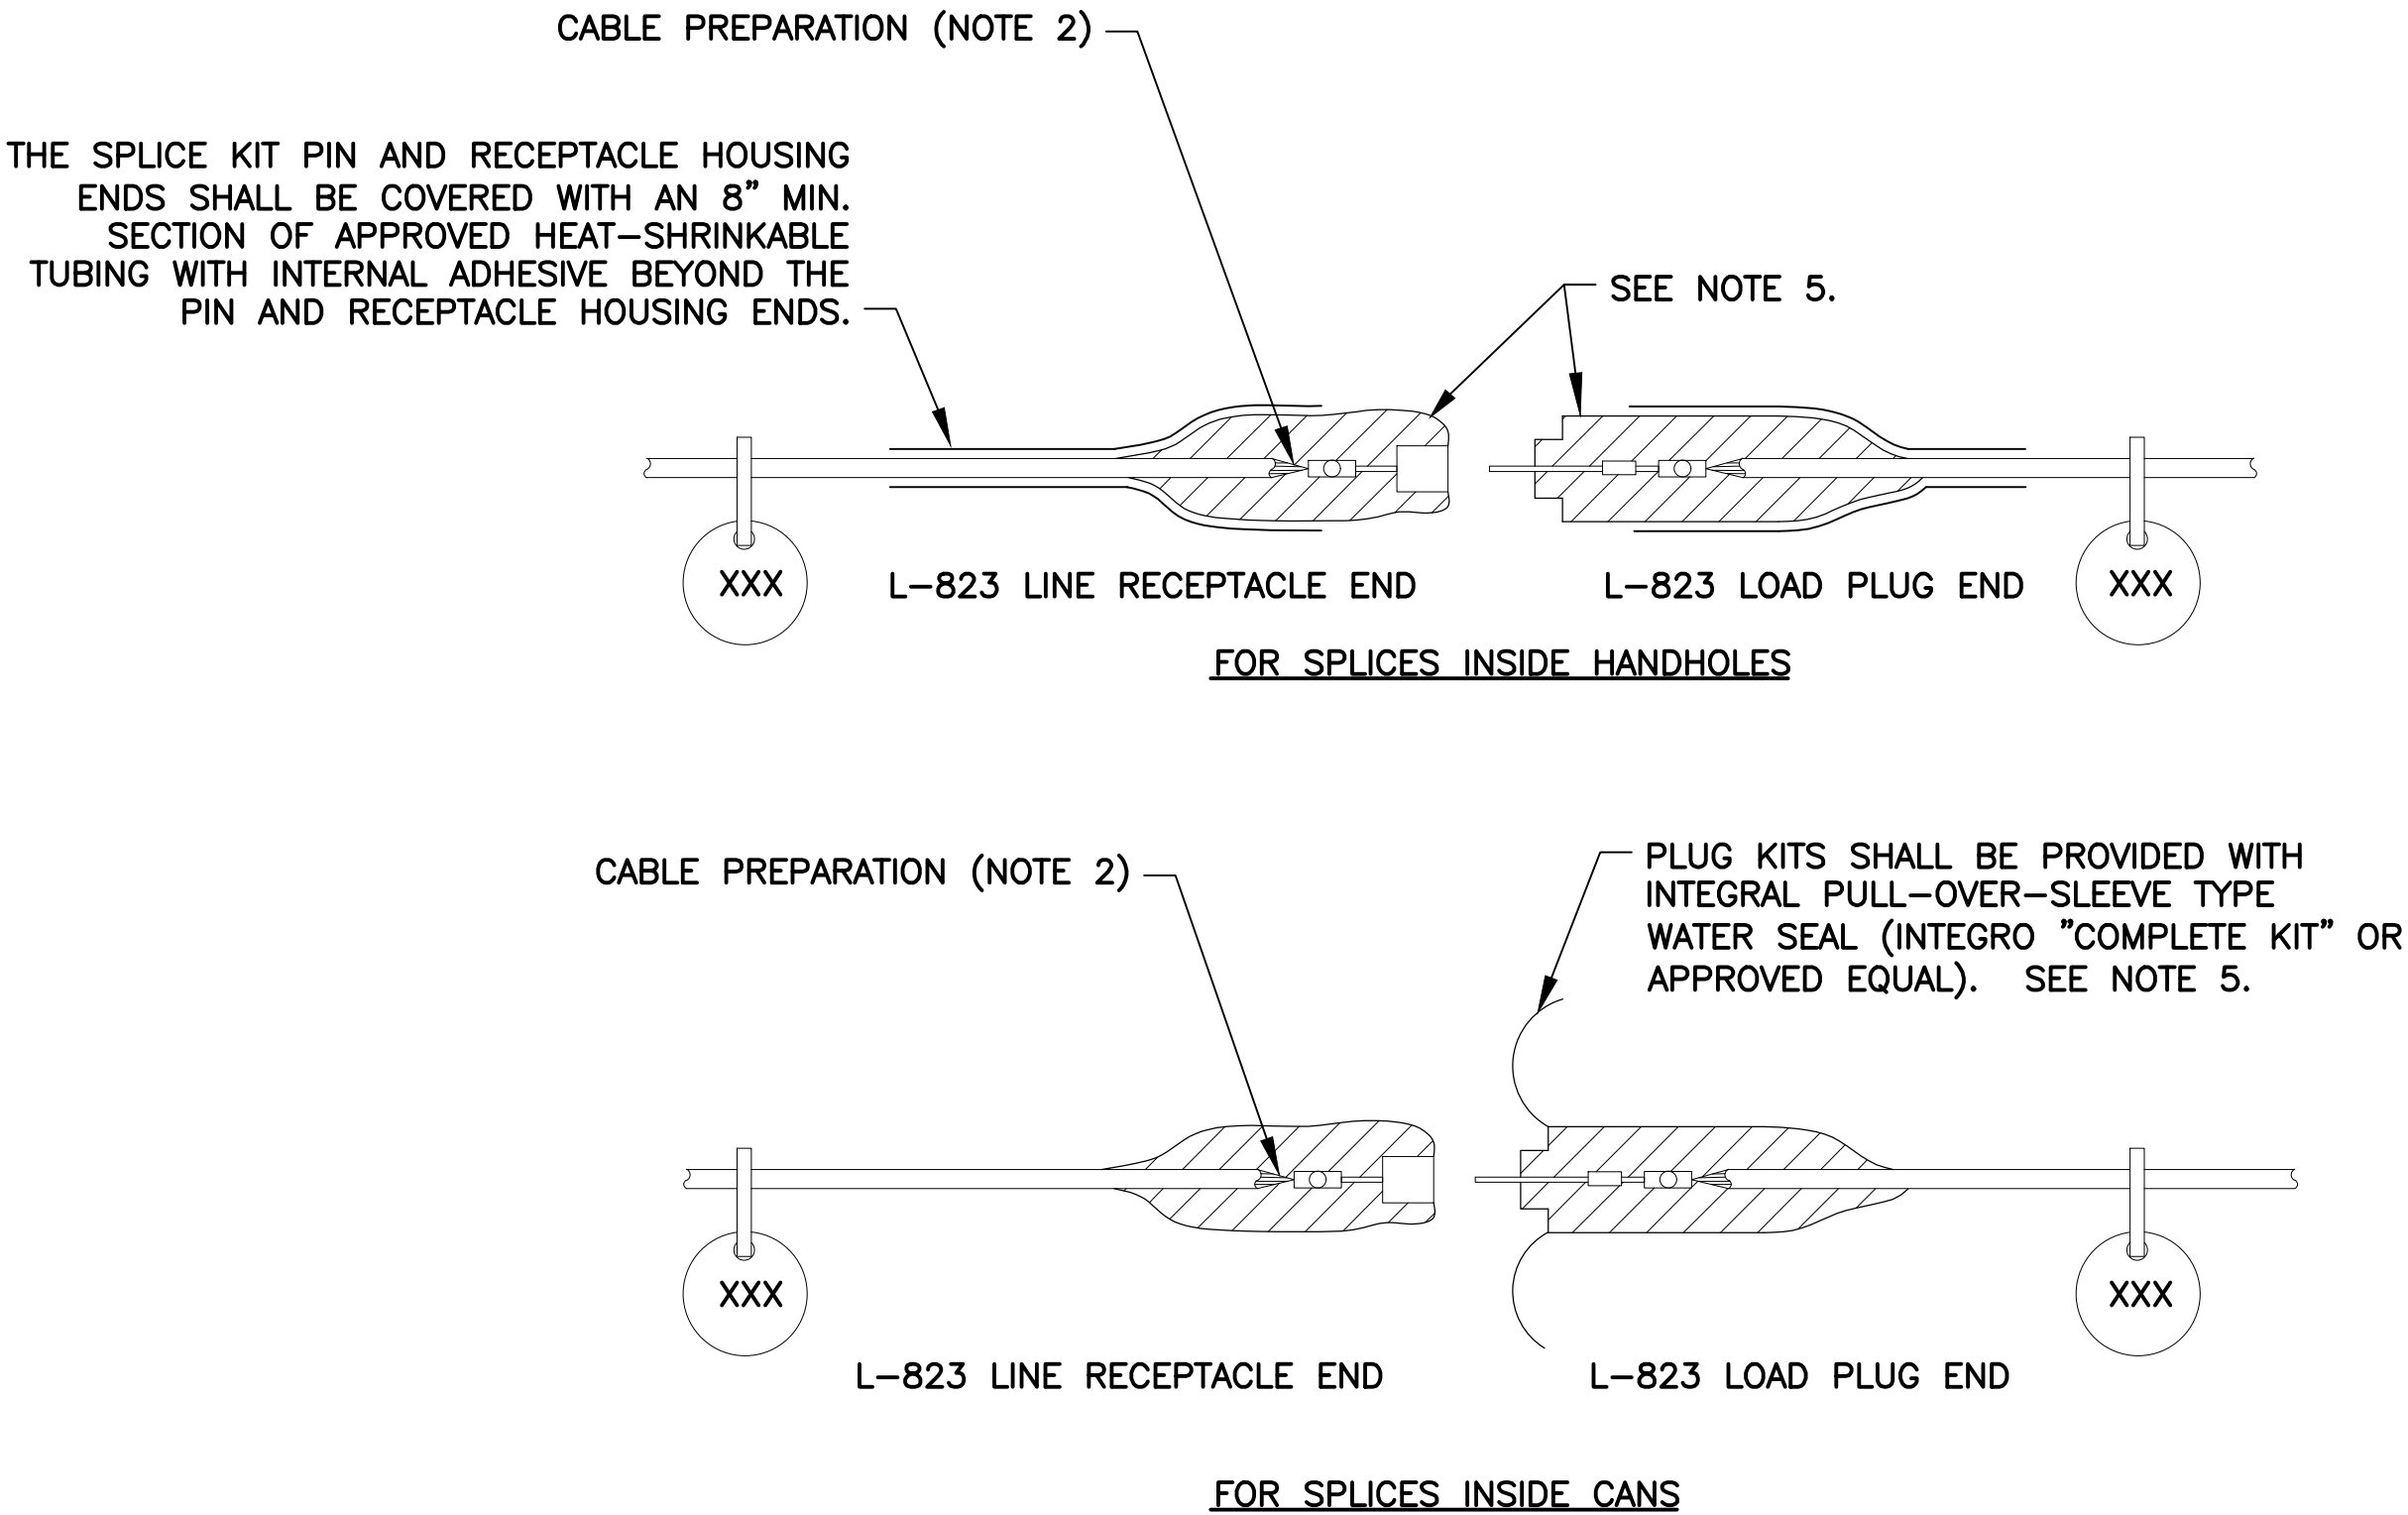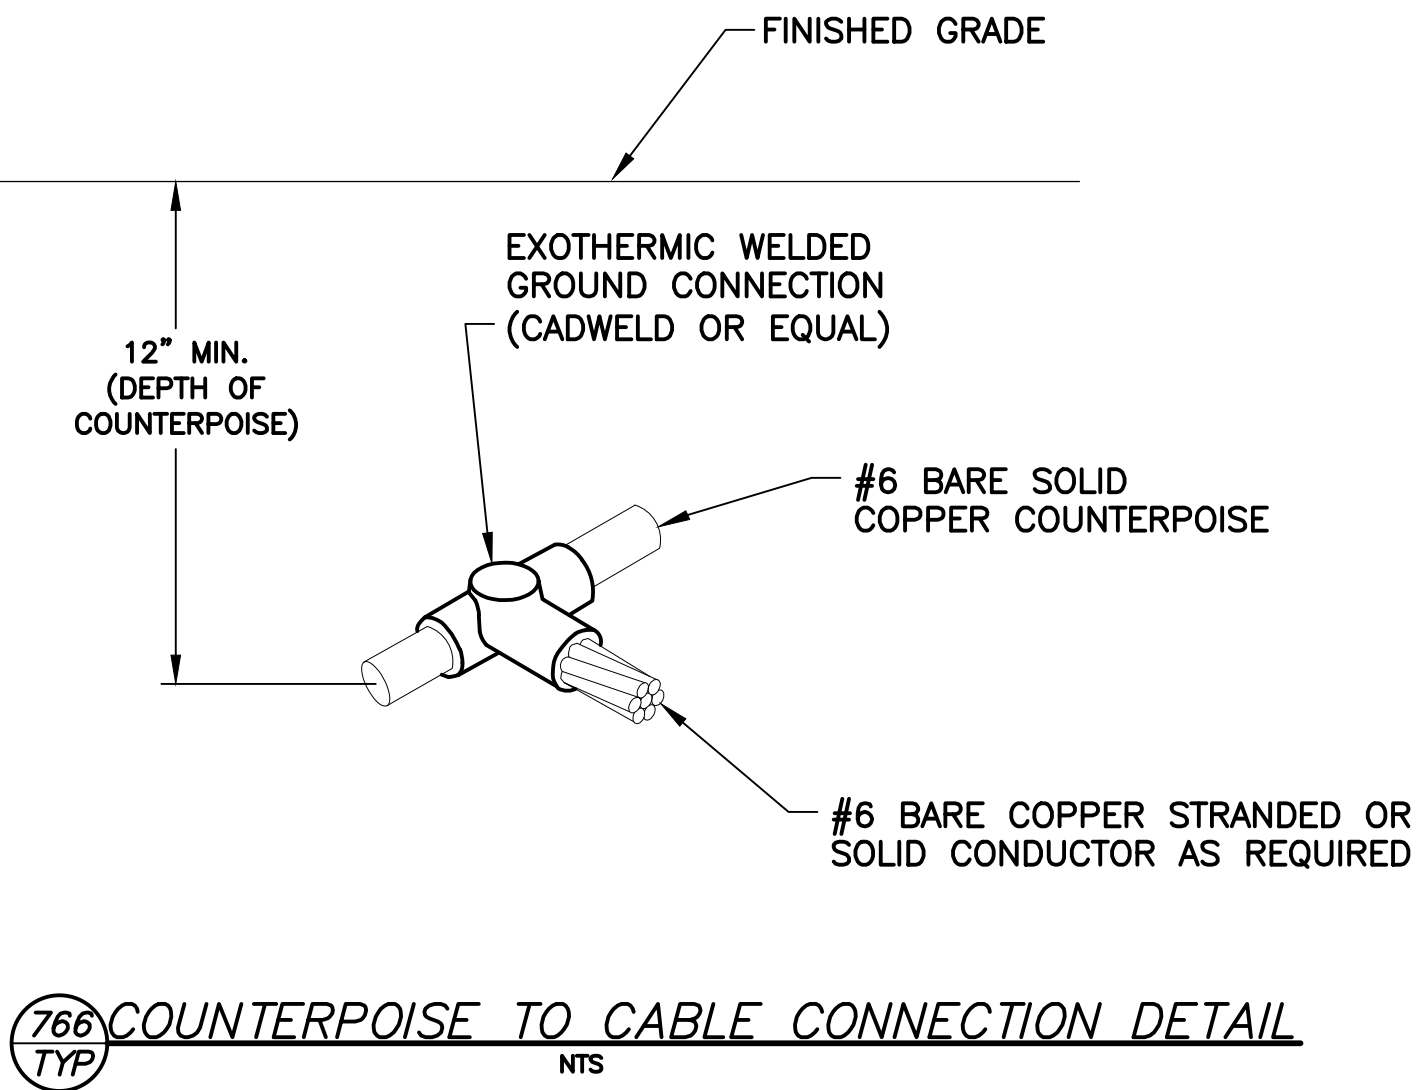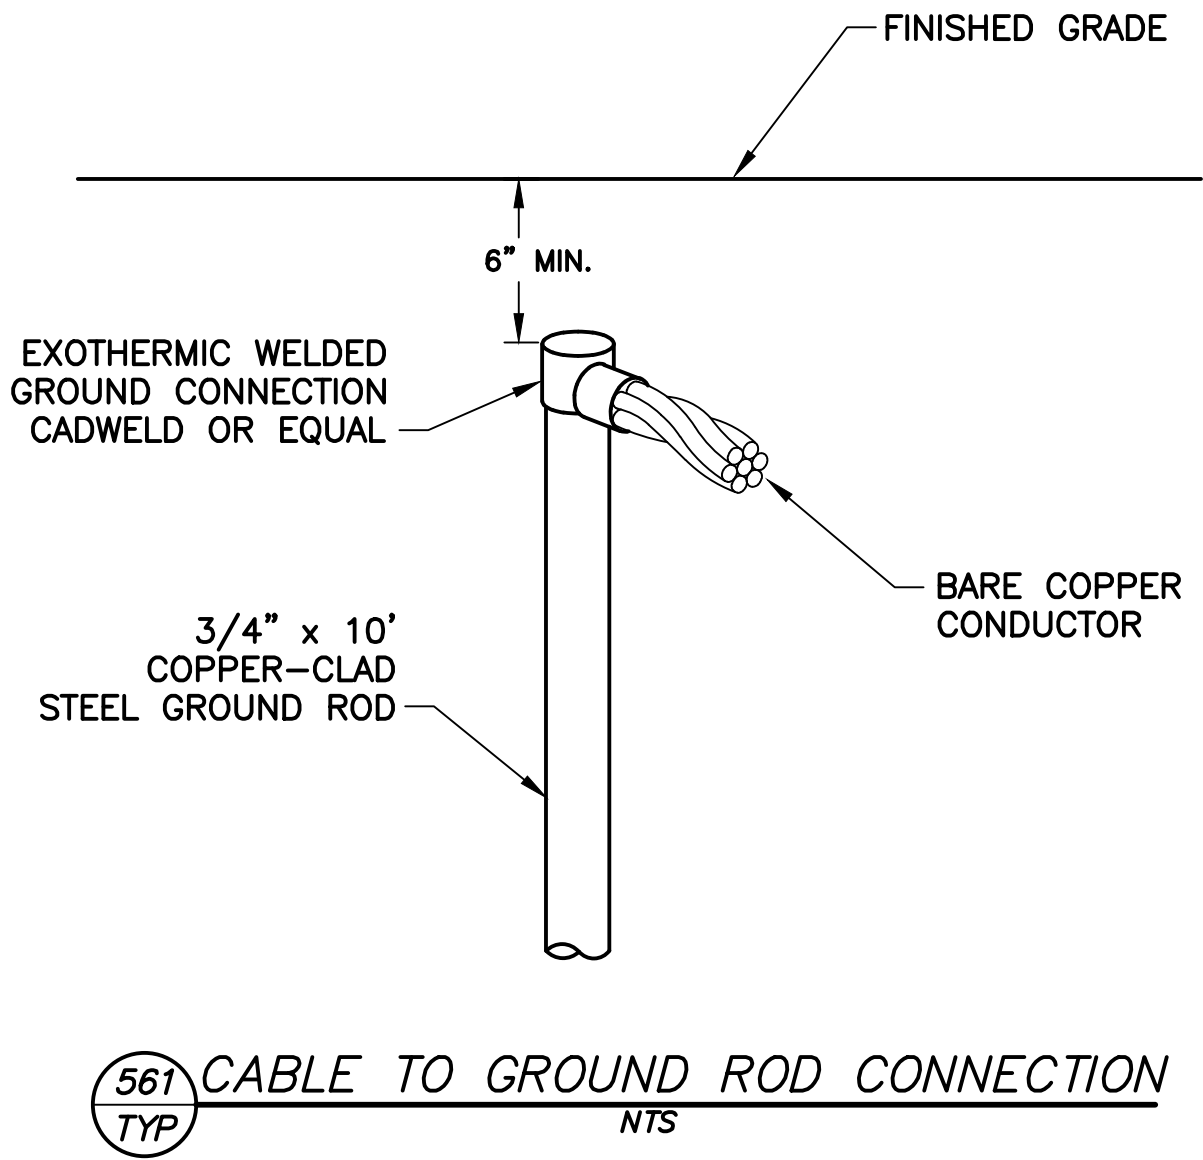SHEET OVERVIEW TITLE	DESIGNED BY: SW	JBW
	DRAWN BY: CA	CA
SHEET REFERENCE NUMBER: EA-503	CHECKED BY: NTS	05/31/2023
	DATE: NTS	
SHEET 23 OF 23	PSHIA INFIELD UTILITY ACCESS UPGRADES AND PAVING AV 08000074 ADOT ADOT GRANT NO.: XXXXXXXX	
	PHX INFLIGHT BYR CITY OF PHOENIX AVIATION DEPARTMENT PSHIA INFLIGHT UTILITY ACCESS UPGRADES AND PAVING AV 08000074 ADOT ADOT GRANT NO.: XXXXXXXX	
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SUB CONSULTANT CR engineers 16719 East Palisades Blvd., Suite 202 Fountain Hills, AZ 85268 Phone: (480) 816-5541 Fax: (480) 816-5540 www.cr-eng.com		
REGISTERED PROFESSIONAL ENGINEER (Electrical) CATHYERNE M. ALCON 36686 12/11/2019		
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