PROJECT

TOWN OF QUEEN CREEK C.I.P PROJECT NO. A1405

BASIS OF BEARING

WEST LINE OF NORTHWEST QUARTER OF SECTION 30, T,2 S., R.7E. GILA AND SALT RIVER BASE AND MERIDIAN, MARICOPA COUNTY, AZ BEARING = N00°01'15.22"E, A DISTANCE OF 2711.87'

BENCHMARKS

BRASS CAP IN HANDHOLE AT INTERSECTION OF OCOTILLO ROAD AND POWER ROAD, SOUTHWEST CORNER OF SECTION 18. TOWNSHIP 2 SOUTH. RANGE 7 EAST. ELEVATION = 1354.40' NAVD 88 VERTICAL DATUM

UTILITY COORDINATION AND CONTACT LIST

KNOWN CONFLICTS WITH THEIR FACILITIES. THE UTILITY SIZES AND LOCATIONS SHOWN HEREIN IS IN AGREEMENT WITH PROVIDED UTILITY COMPANY RECORDS. IDENTIFIED CONFLICTING UTILITY FACILITIES HAVE BEEN MOVED AND NO LONGER CONFLICT UNFORESEEN OR UNIDENTIFIED CONFLICTS DISCOVERED IN THE FIELD SHALL BE REPORTED IMMEDIATELY TO THE APPROPRIATE UTILITY COMPANY REPRESENTATIVE AND BLUE STAKE CENTER. ALL SUCH UNKNOWN CONFLICTS SHALL BE RESOLVED BY THE DESIGN TEAM AND UTILITY PRIOR TO CONSTRUCTION CONTINUING IN THE LOCATION

UTILITY	REPRESENTATIVE	PHONE	E-MAIL
S.R.P.	KAYE BOCKMANN	602-236-3129	KAYE.BOCKMANN@SRPNET.COM
SW GAS	GENE FLOREZ	480-730-3841	GENE.FLOREZ@SWGAS.COM
CENTURYLINK	KEVIN WAGNER	815-245-9640	KWAGNER@TERRATECHLLC.NET
COX COMM.	JEFF KRAUSE	520-955-0084	JEFF.KRAUSE@COX.COM
TOQC WATER	MIKE HUBER	480-358-3482	MIKE.HUBER@QUEENCREEKAZ.GOV
TOQC SEWER	MIKE HUBER	480-358-3482	MIKE.HUBER@QUEENCREEKAZ.GOV
TOQC TRAFFIC ITS	CLINTON MCCLEVE	480-358-3476	CLINTON.MCCLEVE
			@QUEENCREEKAZ.GOV
SAN TAN IRRIGATION	TODD ANGLE	480-988-3385	TODD@SANTANID.COM
RANCHOS JARDINES	JIM MILLSPAUGH	480-570-2643	JMRJID@GMAIL.COM
CITRUS IRRIGATION	GREGORY DUNNAN	480-254-0983	GDUNNAN@DKGCIVIL.COM

UNDERGROUND UTILITIES

- THE EXISTENCE AND LOCATION OF ANY UNDERGROUND UTILITY OR STRUCTURE DEPICTED HEREIN IS BASED UPON THE BEST AVAILABLE INFORMATION FURNISHED BY THE UTILITY OR STRUCTURE OWNER AT THE TIME OF THE SURVEY.
- 2. TO THE BEST OF OUR KNOWLEDGE, THERE ARE NO OTHER EXISTING UTILITIES WITHIN THE PROJECT LIMITS EXCEPT AS SHOWN ON THESE DRAWINGS.
- 3. THE ENGINEER AND TOWN ASSUME NO RESPONSIBILITY FOR THE ACCURACY OF THE UTILITY LOCATIONS DEPICTED IN THESE DRAWINGS.
- 4. THE CONTRACTOR SHALL CALL BLUE STAKE AT (602) 263-1100 OR 811 AT LEAST 48 HOURS PRIOR TO ANY CONSTRUCTION ACTIVITY. IT IS THE CONTRACTOR'S RESPONSIBILITY TO CONTACT ALL INVOLVED UTILITIES AND FIELD VERIFY THE LOCATION(S) OF ALL UTILITIES.
- 5. IF DISCREPANCIES IN UTILITY LOCATIONS ARE FOUND, THE CONTRACTOR SHALL NOTIFY THE TOWN'S PROJECT REPRESENTATIVE IMMEDIATELY.
- ALL MATERIAL THAT COMES INTO CONTACT WITH WATER SHALL CONFORM TO ANSI/NSF STANDARD 61.




NOTE: THE EXISTING RETENTION AND DRAINAGE FACILITIES ON THIS SITE WILL NOT BE REMOVED FROM SERVICE UNTIL THE PERMANENT RETENTION AND DRAINAGE FACILITIES ARE FUNCTIONAL



3133 West Frye Road Chandler, Arizona 85226 Tel. 480.687.6100 www.stantec.com

POWER ROAD: RIGGS ROAD TO CHANDLER HEIGHTS ROAD ROADWAY AND DRAINAGE IMPROVEMENTS

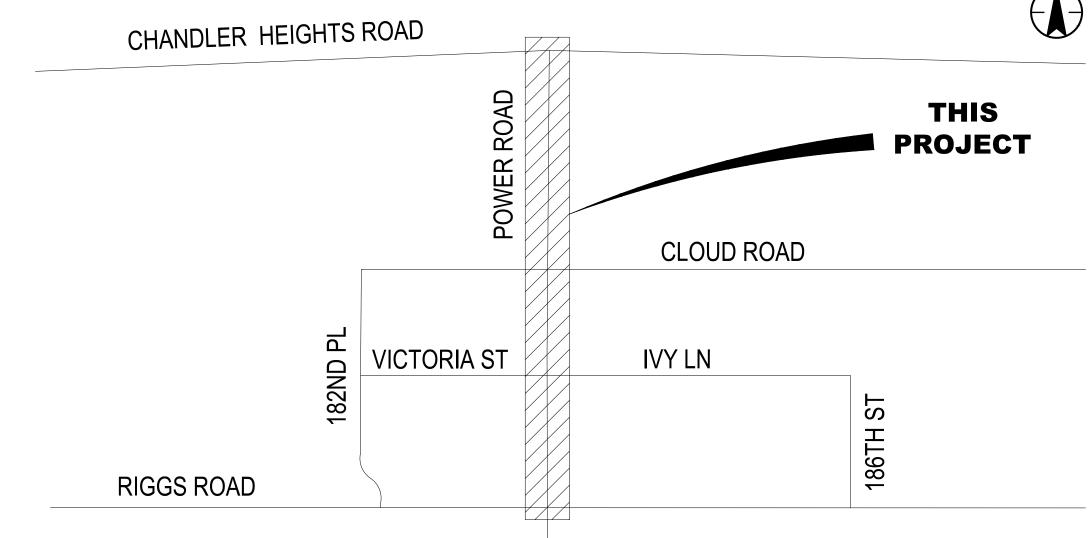

LOCATION MAP

SHEET INDEX

(REFER TO SHEET 2)

SHEET TITLE	DRAWING NO.	SHEET NO.
COVER SHEET	CS001	1
SHEET INDEX	CS002	2
KEY MAP	KM001	3
GENERAL NOTES AND LEGEND	GN001 - GN002	4-5
GEOMETRIC CONTROL MAP	GC001	6
TYPICAL SECTIONS & STRUCTURAL SECTIONS	TY001 - TY006	7-12
ROADWAY DETAIL SHEETS	DT001-DT006	13-18
DEMOLITION PLAN SHEETS	DM001 - DM007	19-25
PAVING PLAN AND PROFILE SHEETS	PP001 - PP014	26-39
INTERSECTION GRADING SHEETS	PP101-PP102	40-41
DRIVEWAY PROFILES	DW001	42
GRADING AND DRAINAGE SHEETS	DR001-DR008	43-50
PIPE PROFILES	DR101-DR102	51-52
SCUPPER PROFILES	DR201	53
WATER COVER SHEET AND SHEET INDEX	CS003	54
WATER PLAN KEY MAP	KM002	55
WATER PLAN SHEETS	UW001-UW006	56-61
WATER DETAIL SHEETS	UW101-UW102	62-63
SIGNING & STRIPING GENERAL SHEETS	SG001-SG005	64-68
SIGNING PLAN SHEETS	SN001-SN004	69-72
STRIPING PLAN SHEETS	SS001-SS004	73-76
TRAFFIC SIGNAL PLAN SHEETS	TS001-TS008	77-87
STREET LIGHT PLAN SHEETS	SL001-SL010	88-97
IRRIGATION NOTES AND SCHEDULES	IR101	98
IRRIGATION SHEETS	IR001-IR014	99-112
IRRIGATION DETAIL SHEETS	IR501-IR502	113-114
LANDSCAPING NOTES AND SCHEDULES	PL101	115
LANDSCAPING SHEETS	PL001-PL014	116-129
LANDSCAPING DETAIL SHEET	PL501	130
BORING LOG SHEETS	BL001-BL003	131-133



TOWN COUNCIL

VICE-MAYOR - LEAH MARTINEAU COUNCIL MEMBERS ROBIN BENNING JEFF BROWN BRYAN MCCLURE

MAYOR - JULIA WHEATLEY

DAWN OLIPHANT TRAVIS PADILLA

TOWN OF QUEEN CREEK

19715 S. 220TH ST QUEEN CREEK, AZ 85142 TELEPHONE (480) 358-3140 FAX (480) 358-3105 **CONTACT:** Bob Coulthard E-MAIL: bob.coulthard@queencreekaz.gov

ENGINEER

STANTEC CONSULTING INC. 3133 WEST FRYE ROAD SUITE 300 CHANDLER, AZ 85226 PHONE: (480) 687-6100 FAX: (480) 431-9562 **CONTACT: Chris Eggers** EMAIL: chris.eggers@stantec.com

APPROVALS

THE AUTHORIZED REPRESENTATIVES OF THE FOLLOWING AGENCIES HEREBY ACKNOWLEDGE OR HAVE ACKNOWLEDGED THAT THEY HAVE REVIEWED AND APPROVED THE DESIGN SHOWN HEREIN. CONSTRUCTION MAY BEGIN AFTER ALL APPROPRIATE PERMITS HAVE BEEN OBTAINED.

OWN CIP GROUP DIRECTOR	
OWN TRAFFIC ENGINEER	

AS-BUILT CERTIFICATION

TOWN OF QUEEN CREEK UTILITY ENGINEER

I HEREBY CERTIFY THAT THE "RECORD-DRAWING" MEASUREMENTS AS SHOWN HEREON WERE MADE UNDER MY SUPERVISION, OR AS NOTED, AND ARE CORRECT TO THE BEST OF MY KNOWLEDGE AND BELIEF.

REGISTERED ENGINEER/ LAND SURVEYOR SEAL &

CUEETNO	DDAMINGNO	CLIEFT NIANAF
SHEET NO.	DRAWING NO.	SHEET NAME
1	CS001	COVER SHEET
3	CS002 KM001	SHEET INDEX KEY MAP
4	GN001	GENERAL NOTES AND LEGEND
5	GN001 GN002	GENERAL NOTES AND LEGEND
6	GC001	GEOMETRIC CONTROL MAP
7	TY001	TYPICAL SECTION POWER ROAD
8	TY002	TYPICAL SECTION POWER ROAD
9	TY003	TYPICAL SECTION POWER ROAD
10	TY004	TYPICAL SECTION POWER ROAD
11	TY005	TYPICAL SECTION POWER ROAD
12	TY006	TYPICAL SECTION POWER ROAD
13	DT001	ROADWAY DETAIL SHEETS
14	DT002	ROADWAY DETAIL SHEETS
15	DT003	ROADWAY DETAIL SHEETS
16	DT004	ROADWAY DETAIL SHEETS
17	DT005	ROADWAY DETAIL SHEETS
18	DT006	ROADWAY DETAIL SHEETS
19	DM001	DEMOLITION PLANS SHEETS
20	DM002	DEMOLITION PLANS SHEETS
21	DM003	DEMOLITION PLANS SHEETS
22	DM004	DEMOLITION PLANS SHEETS
23	DM005	DEMOLITION PLANS SHEETS
24	DM006	DEMOLITION PLANS SHEETS
25	DM007	DEMOLITION PLANS SHEETS
26	PP001	PAVING PLAN AND PROFILE SHEETS
27	PP002	PAVING PLAN AND PROFILE SHEETS
28	PP003	PAVING PLAN AND PROFILE SHEETS
29	PP004	PAVING PLAN AND PROFILE SHEETS
30	PP005	PAVING PLAN AND PROFILE SHEETS
31	PP006	PAVING PLAN AND PROFILE SHEETS
32	PP007	PAVING PLAN AND PROFILE SHEETS
33	PP008	PAVING PLAN AND PROFILE SHEETS
34	PP009	PAVING PLAN AND PROFILE SHEETS
35	PP010	PAVING PLAN AND PROFILE SHEETS
36	PP011	PAVING PLAN AND PROFILE SHEETS
37	PP012	PAVING PLAN AND PROFILE SHEETS
38	PP013	PAVING PLAN AND PROFILE SHEETS
39	PP014	PAVING PLAN AND PROFILE SHEETS
40	PP101	INTERSECTION GRADING SHEET
41	PP102	INTERSECTION GRADING SHEET
42	DW001	DRIVEWAY PROFILES
43	DR001	GRADING & DRAINAGE SHEETS
44	DR002	GRADING & DRAINAGE SHEETS
45	DR003	GRADING & DRAINAGE SHEETS
46	DR004	GRADING & DRAINAGE SHEETS
47	DR005	GRADING & DRAINAGE SHEETS
48	DR006	GRADING & DRAINAGE SHEETS
49	DR007	GRADING & DRAINAGE SHEETS
50	DR008	GRADING & DRAINAGE SHEETS
51	DR101	PIPE PROFILES
52	DR102	PIPE PROFILES
53	DR201	SCUPPER PROFILES
54	CS003	WATER COVER SHEET AND SHEET INDEX
55	KM002	WATER PLAN KEY MAP
56	UW001	WATER PLAN SHEETS
57	UW002	WATER PLAN SHEETS
58	UW003	WATER PLAN SHEETS
59	UW004	WATER PLAN SHEETS
60	UW005	WATER PLAN SHEETS
61	UW006	WATER PLAN SHEETS
62	UW101	WATER DETAIL SHEETS
-	UW102	WATER DETAIL SHEETS
63	O VV 102	
63 64	SG001	SIGNING & STRIPING GENERAL SHEETS
		SIGNING & STRIPING GENERAL SHEETS SIGNING & STRIPING GENERAL SHEETS
64	SG001	

SHEET NO.	DRAWING NO.	SHEET NAME
68	SG005	SIGNING & STRIPING GENERAL SHEETS
69	SN001	SIGNING SHEETS
70	SN002	SIGNING SHEETS
71	SN003	SIGNING SHEETS
72	SN004	SIGNING SHEETS
73	SS001	STRIPING PLANS
74	SS002	STRIPING PLANS
75	SS003	STRIPING PLANS
76	SS004	STRIPING PLANS
77	TS001	TRAFFIC SIGNAL PLAN SHEETS
78	TS002	TRAFFIC SIGNAL PLAN SHEETS
79	TS003	TRAFFIC SIGNAL PLAN SHEETS
80	TS004	TRAFFIC SIGNAL PLAN SHEETS
81	TS004a	TRAFFIC SIGNAL PLAN SHEETS
82	TS004b	TRAFFIC SIGNAL PLAN SHEETS
83	TS004b	TRAFFIC SIGNAL PLAN SHEETS
84	TS004C	TRAFFIC SIGNAL PLAN SHEETS TRAFFIC SIGNAL PLAN SHEETS
85		
	TS006	TRAFFIC SIGNAL PLAN SHEETS
86	TS007	TRAFFIC SIGNAL PLAN SHEETS
87	TS008	TRAFFIC SIGNAL PLAN SHEETS
88	SL001	STREETLIGHT SHEETS
89	SL002	STREETLIGHT SHEETS
90	SL003	STREETLIGHT SHEETS
91	SL004	STREETLIGHT SHEETS
92	SL005	STREETLIGHT SHEETS
93	SL006	STREETLIGHT SHEETS
94	SL007	STREETLIGHT SHEETS
95	SL008	STREETLIGHT SHEETS
96	SL009	STREETLIGHT SHEETS
97	SL010	STREETLIGHT SHEETS
98	IR101	IRRIGATION NOTES AND SCHEDULES
99	IR001	IRRIGATION PLAN 1
100	IR002	IRRIGATION PLAN 2
101	IR003	IRRIGATION PLAN 3
102	IR004	IRRIGATION PLAN 4
103	IR005	IRRIGATION PLAN 5
104	IR006	IRRIGATION PLAN 6
105	IR007	IRRIGATION PLAN 7
106	IR008	IRRIGATION PLAN 8
107	IR009	IRRIGATION PLAN 9
108	IR010	IRRIGATION PLAN 10
109	IR011	IRRIGATION PLAN 11
110	IR012	IRRIGATION PLAN 12
111	IR013	IRRIGATION PLAN 13
112	IR014	IRRIGATION PLAN 14
113	IR501	IRRIGATION DETAILS 1
114	IR502	IRRIGATION DETAILS 2
115	PL101	LANDSCAPING NOTES AND SCHEDULES
116	PL001	LANDSCAPING PLAN 1
117	PL002	LANDSCAPING PLAN 2
110	DI 002	LANDSCADING DI ANI 3

PL003

LANDSCAPING PLAN 3

118

SHEET NO.	DRAWING NO.	SHEET NAME
119	PL004	LANDSCAPING PLAN 4
120	PL005	LANDSCAPING PLAN 5
121	PL006	LANDSCAPING PLAN 6
122	PL007	LANDSCAPING PLAN 7
123	PL008	LANDSCAPING PLAN 8
124	PL009	LANDSCAPING PLAN 9
125	PL010	LANDSCAPING PLAN 10
126	PL011	LANDSCAPING PLAN 11
127	PL012	LANDSCAPING PLAN 12
128	PL013	LANDSCAPING PLAN 13
129	PL014	LANDSCAPING PLAN 14
130	PL501	LANDSCAPING DETAILS
131	BL001	BORING LOG SHEETS
132	BL002	BORING LOG SHEETS
133	BL003	BORING LOG SHEETS





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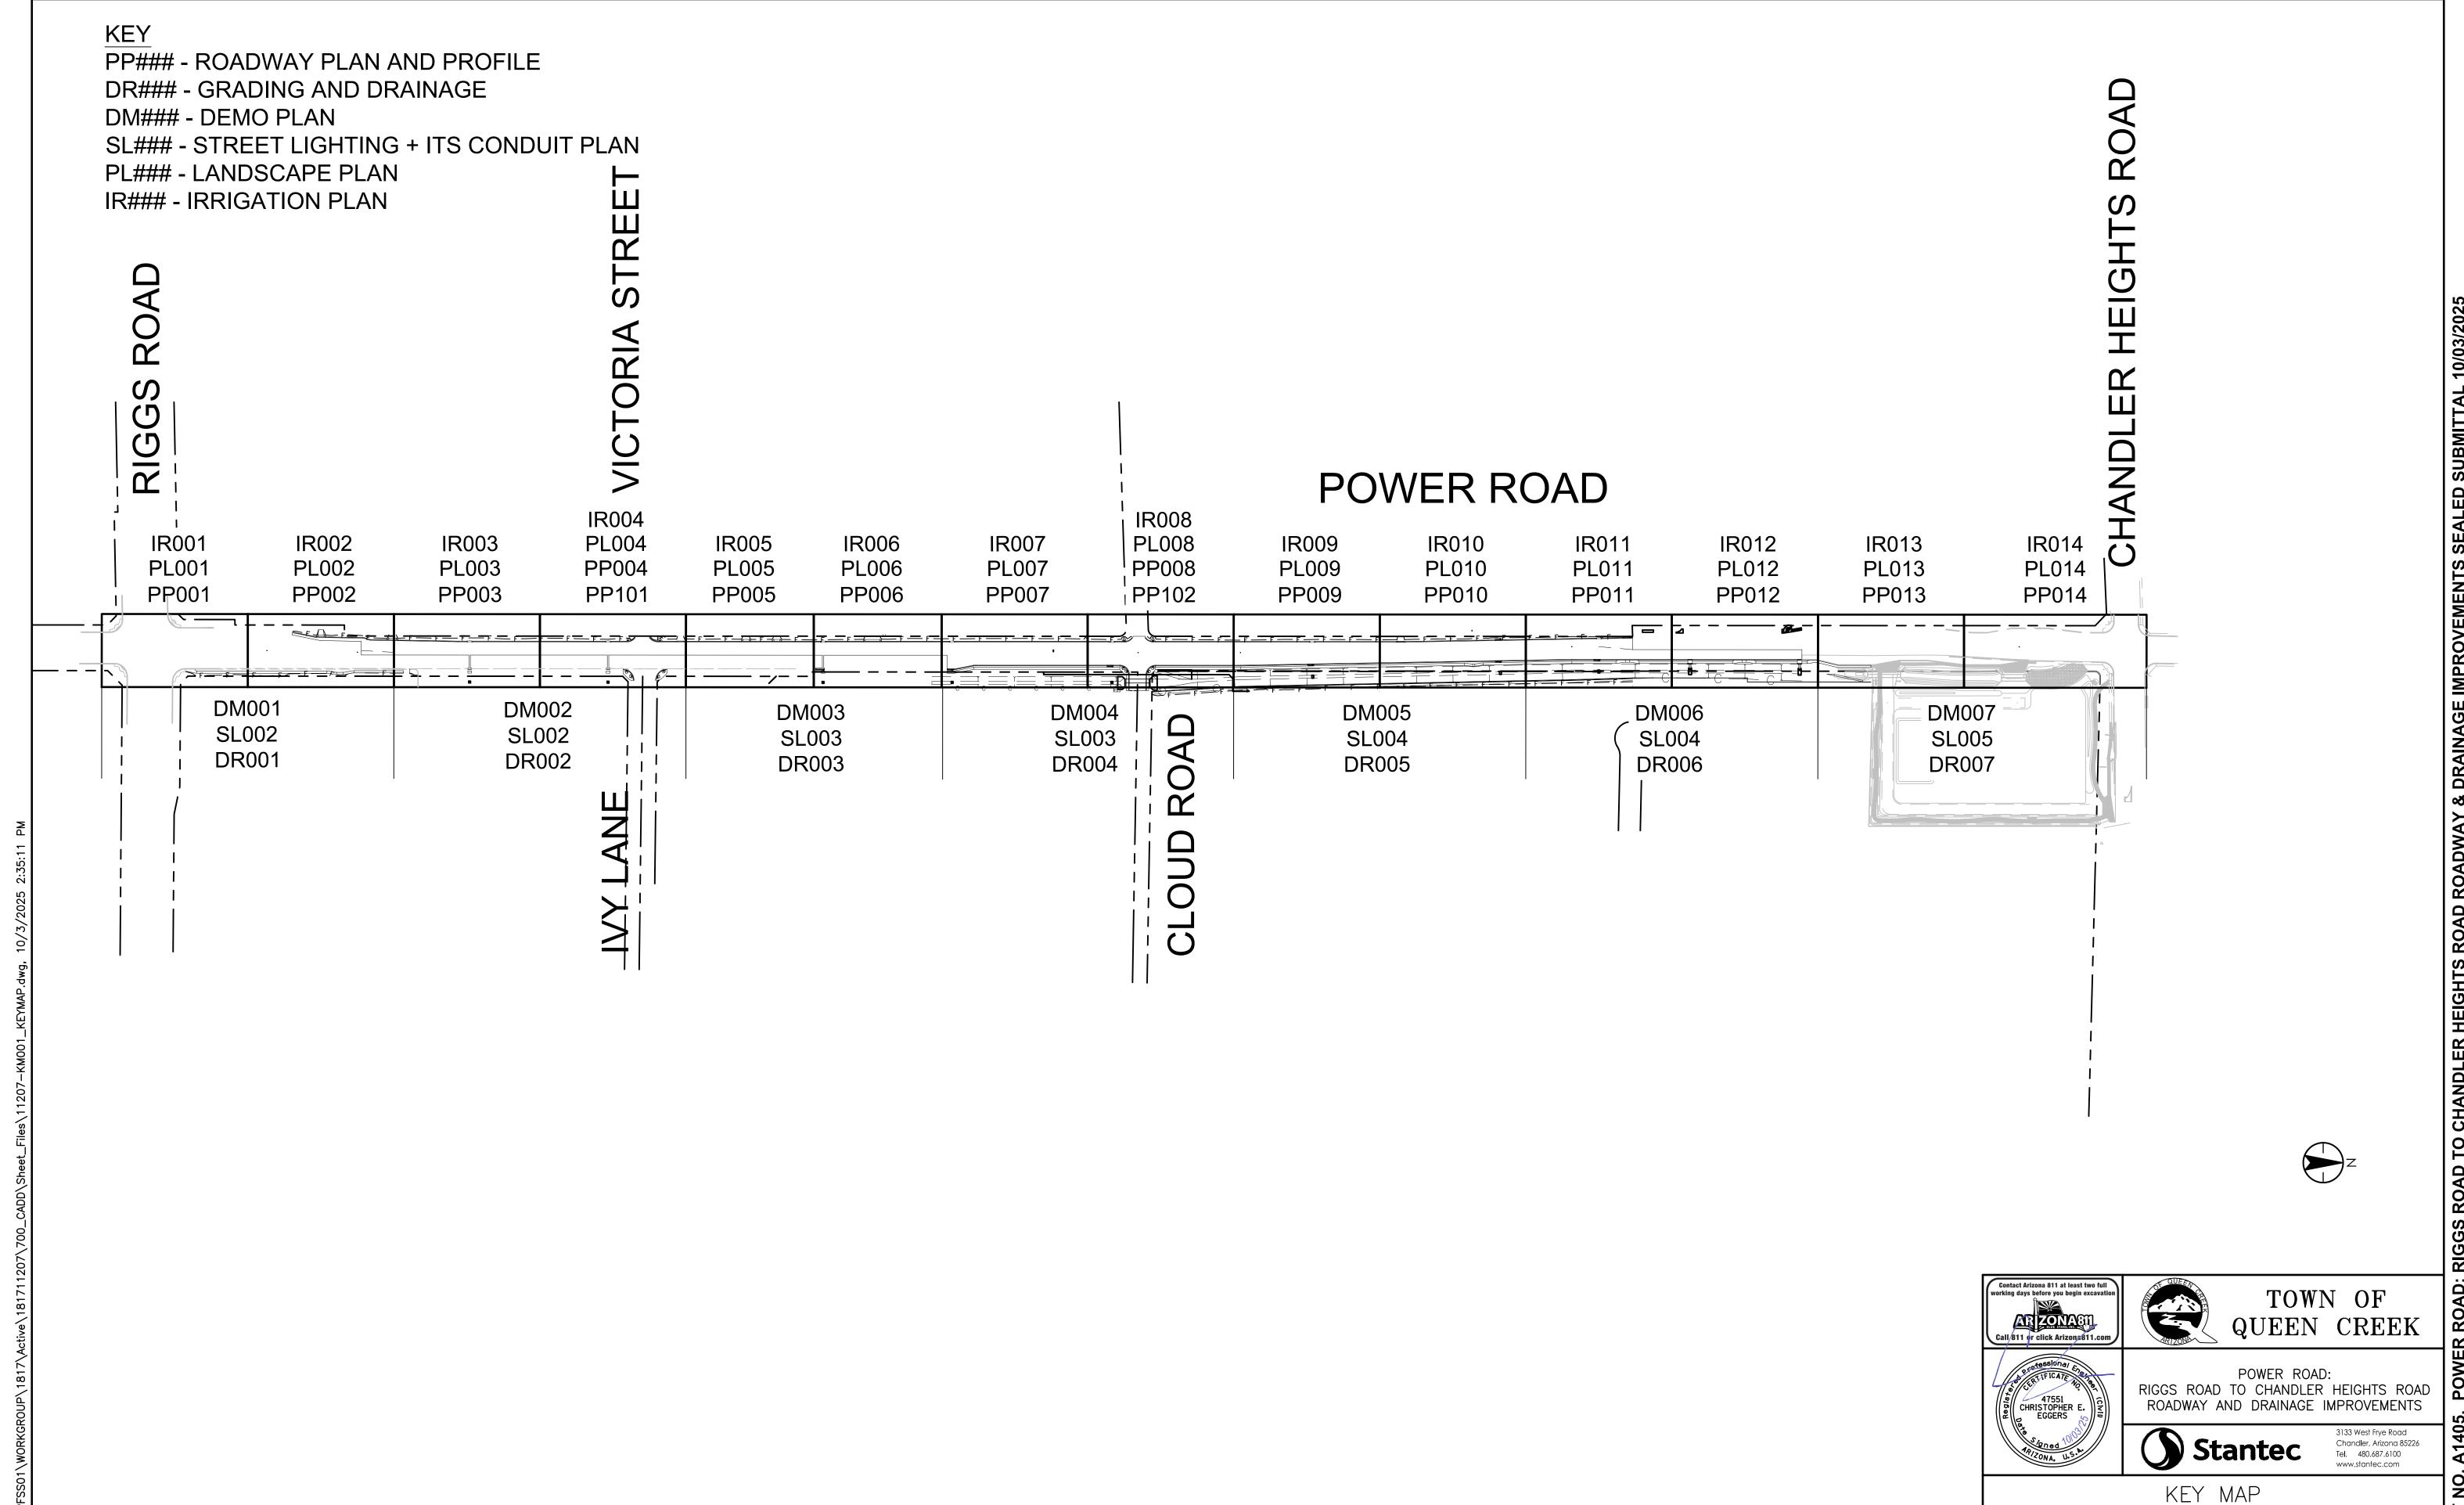
SHEET INDEX

DESIGNED BY MH
DRAWN BY BE CIP PROJ NO. A1405

DRAWING NO.

CS002

SHEET 2 OF 133



DESIGNED BY MH

DRAWING NO.

CIP PROJ NO. A1405

KM001

SHEET 3 OF 133

- ALL IMPROVEMENTS INCLUDED HEREIN REQUIRE TOWN ISSUED CONSTRUCTION AND ENCROACHMENT PERMITS AND SHALL BE CONSTRUCTED WITH THE INSPECTION AND SUBSEQUENT APPROVAL OF THE TOWN CIP DEPARTMENT. TOWN PERMITS ARE PROVIDED AT NO COST TO THE CONTRACTOR FOR CIP PROJECTS. THE WORK MAY ALSO REQUIRE ADDITIONAL PERMITS FROM OTHER ENTITIES AND PERMITTING AUTHORITIES AND HAVE COSTS ASSOCIATED WITH THEM. CONSTRUCTION SHALL NOT BEGIN UNTIL SUCH NECESSARY PERMITS HAVE BEEN ISSUED AND COPIES OF THE PERMITS PROVIDED TO THE ASSIGNED TOWN PROJECT MANAGER. THE CONTRACTOR SHALL BE RESPONSIBLE FOR VERIFICATION AND RENEWAL OF EXPIRING OR LAPSED PERMITS.
- ALL CONSTRUCTION IMPROVEMENTS WORK, TESTING, AND MATERIALS SHALL CONFORM TO THE LATEST EDITIONS OF THE TOWN OF QUEEN CREEK DESIGN STANDARDS AND PROCEDURES MANUAL; THE TOWN OF QUEEN CREEK DESIGN AND CONSTRUCTION STANDARDS MANUAL FOR WATER, WASTEWATER. AND IRRIGATION SYSTEMS; THE MAG UNIFORM STANDARD SPECIFICATIONS AND DETAILS FOR PUBLIC WORKS CONSTRUCTION: ISSUED TOWN OF QUEEN CREEK SUPPLEMENTS TO THE MAG STANDARD SPECIFICATIONS AND DETAIL; AND REFERENCED TOWN OF QUEEN CREEK STANDARD DRAWINGS, INCLUDING ANY REFERENCED SUPPLEMENTS THERETO, IN EFFECT AT THE TIME OF PERMITTING UNLESS OTHERWISE NOTED. CERTAIN IMPROVEMENTS MAY BE REQUIRED TO CONFORM TO ALTERNATIVE OR ADDITIONAL STANDARDS, SPECIFICATIONS AND DETAILS AS NOTED ELSEWHERE IN THE PLANS AND/OR SPECIFICATIONS.
- ALL WORK AND MATERIALS NOT IN CONFORMANCE WITH THE NOTED STANDARDS AND DETAILS ARE SUBJECT TO REMOVAL AND REPLACEMENT AT THE CONTRACTOR'S EXPENSE.
- AN APPROVED (SIGNED-OFF) COMPLETE SET OF IMPROVEMENT PLANS SHALL BE ON THE JOB SITE AT ALL TIMES. DEVIATIONS FROM THE PLANS, UNLESS OTHERWISE SPECIFICALLY DIRECTED BY THE TOWN'S REPRESENTATIVE, MUST BE PRECEDED BY AN APPROVED PLAN REVISION OR SHALL BE SUBJECT TO A "STOP WORK ORDER" BY THE TOWN'S REPRESENTATIVE TO REMOVE ANY WORK THAT DOES NOT REFLECT THE APPROVED IMPROVEMENT PLANS.
- ALL PRECONSTRUCTION MEETINGS SHALL BE SCHEDULED THROUGH THE TOWN CIP DEPARTMENT.
- THE CONTRACTOR SHALL REQUEST AND THE TOWN SHALL PERFORM PERIODIC INSPECTIONS THROUGHOUT THE COURSE OF CONSTRUCTION. THE CONTRACTOR SHALL PROVIDE FOR A TOWN CONSTRUCTION INSPECTOR TO BE SUFFICIENTLY SCHEDULED AND PRESENT ON SITE TO ASSESS COMPLIANCE WITH THE PLANS AND SPECIFICATIONS FOR EACH CONSTRUCTION ELEMENT AND STAGE WHEN CONSTRUCTION IS IN PROGRESS BY PROVIDING THE TOWN APPROPRIATE NOTIFICATION. THE CONTRACTOR SHALL SIMILARLY COORDINATE, REQUEST AND PROVIDE FOR REQUIRED INSPECTIONS FROM OTHER AGENCIES OR UTILITIES FOR THE WORK AS NECESSARY.
- THE TOWN CIP INSPECTOR SHALL BE NOTIFIED A MINIMUM OF 48 HOURS PRIOR TO THE START OR RESUMPTION OF ANY CONSTRUCTION ON THE PROJECT SITE FOR SCHEDULING INSPECTIONS. THIS NOTIFICATION REQUIREMENT INCLUDES PRIOR TO STARTING DIFFERENT STAGES OF THE WORK. IF PROJECT WORK IS DISCONTINUED FOR MORE THAN 72 HOURS FOR UNSCHEDULED WORK STOPPAGES, IT SHALL NOT RESUME UNTIL AFTER NOTIFYING THE TOWN CIP INSPECTOR.
- PROGRESS INSPECTIONS AND ANY INTERIM APPROVALS, VERBAL OR WRITTEN, DO NOT CONSTITUTE TOWN ACCEPTANCE OR APPROVAL OF ANY IMPROVEMENTS FOR MAINTENANCE.
- THE DESIGN ENGINEER CERTIFIES THAT ALL APPLICABLE UTILITY COMPANIES HAVE BEEN CONTACTED AS NOTED AND ALL UTILITY PROVIDED EXISTING AND/OR PROPOSED UTILITY INFORMATION, AS LABELED, IS SHOWN ON THESE PLANS TO THE BEST OF THEIR KNOWLEDGE AND BELIEF. NO HORIZONTAL OR VERTICAL LOCATION ACCURACY OR COMPLETENESS WARRANTY IS IMPLIED OR GIVEN.
- 10. THE CONTRACTOR SHALL LOCATE IN ADVANCE OF CONSTRUCTION ALL EXISTING UNDERGROUND PIPELINES, STORM DRAINS, CULVERTS, TELECOMMUNICATIONS AND ELECTRICAL CONDUITS, TRAFFIC SIGNAL INTER-TIES, ASSOCIATED APPURTENANCES AND STRUCTURES AND WILL OBSERVE ALL POSSIBLE PRECAUTIONS TO AVOID DAMAGE TO SAME DURING CONSTRUCTION.
- 11. THE CONTRACTOR IS RESPONSIBLE FOR NOTIFYING INDIVIDUAL UTILITY COMPANIES AND FOR CALLING ARIZONA 811 (FORMERLY BLUE STAKE), DIAL 811, 602-263-1100 (IN MARICOPA COUNTY) OR 1-800-782-5348 (1-800-STAKE-IT), TO MARK AND LOCATE ALL UNDERGROUND UTILITIES AT LEAST TWO WORKING DAYS PRIOR TO ANY EXCAVATION.
- 12. THE CONTRACTOR SHALL UNCOVER AND FIELD VERIFY THE CONNECTION POINT LOCATION AND ELEVATION OF ALL EXISTING UTILITY LINES, CULVERTS, STUB OUTS, MANHOLES AND STORM DRAINS BEING EXTENDED FROM OR CONNECTED TO IN ADVANCE OF SUBSTANTIAL CONSTRUCTION ACTIVITIES.
- 13. THE LOCATION OF ALL WATER VALVES, FIRE HYDRANTS, SEWER MANHOLES AND CLEANOUTS, AND UTILITY VALVES AND VAULTS MUST BE KNOWN AND REFERENCED AT ALL TIMES DURING CONSTRUCTION. ACCESS TO SUCH FACILITIES SHALL BE AVAILABLE TO THE APPROPRIATE UTILITY COMPANIES, TOWN UTILITY DEPARTMENT, PUBLIC SAFETY PROVIDERS AND THE TOWN PUBLIC WORKS DEPARTMENT AT ALL TIMES.
- 14 EXISTING FACILITIES WHICH ARE NOT SPECIFICALLY LOCATED WITH ACTUAL VERTICAL AND /OR HORIZONTAL CONTROL INFORMATION ARE LOCATED ONLY APPROXIMATELY AND TO THE BEST AVAILABLE KNOWLEDGE.
- 15. UNDERGROUND UTILITY LOCATING POTHOLES SHALL BE BACKFILLED AND REPAIRED IN ACCORDANCE WITH MAG STANDARD DETAIL 212 USING THE ½ SACK CLSM OPTION. ALL LOOSE MATERIALS SHALL BE CONDITIONED, PLACED AND COMPACTED IN ACCORDANCE WITH THE NOTED SPECIFICATIONS.
- 16. THE CONTRACTOR SHALL PROMPTLY NOTIFY THE TOWN CIP INSPECTOR OF ANY OBSERVED OR DISCOVERED VARIANCES BETWEEN THESE PLANS AND ACTUAL FIELD CONDITIONS. THIS INCLUDES OBSTRUCTIONS TO THE PROPOSED IMPROVEMENTS. ANY EXISTING IMPROVEMENTS REMOVED TO FACILITATE CONSTRUCTION SHALL BE REPLACED IN THE SAME OR BETTER CONDITION AS PART OF THE WORK UNLESS OTHERWISE NOTED OR AGREED.
- 17. THE CONSTRUCTION LIMITS SHALL BE ADEQUATELY STAKED, FENCED, MARKED, AND SIGNED PRIOR TO AND DURING CONSTRUCTION. THE CONTRACTOR SHALL VERIFY PROPERTY LINE, RIGHT-OF-WAY AND EASEMENT LOCATIONS PRIOR TO PROCEEDING WITH SUBSTANTIAL WORK ACTIVITIES.
- 18. ALL UTILITIES MUST BE INSTALLED EITHER WITHIN DEDICATED PUBLIC RIGHTS-OF-WAY OR IN PUBLIC OR SPECIFIC UTILITY EASEMENTS DEDICATED BY A LANDOWNER FOR SUCH USAGE AND MAINTENANCE.
- 19. ALL EARTHWORK, TRENCHING AND PAVEMENT CONSTRUCTION SHALL BE PERFORMED IN ACCORDANCE WITH THE GEOTECHNICAL REPORT FINDINGS AND RECOMMENDATIONS PREPARED BY TERRACON CONSULTING DATED AUGUST 2022. ALL COMPACTION UNDER PAVEMENT AREAS SHALL BE PERFORMED ACCORDING TO THE GEOTECHNICAL REPORT RECOMMENDATIONS AND THE APPLICABLE MAG SPECIFICATIONS AND DETAILS.
- 20. ALL TRENCH EXCAVATIONS SHALL COMPLY WITH OSHA EXCAVATION STANDARDS REQUIREMENTS (29 CFR. PART 1926, SUBPART P). CONTRACTORS SHALL NOT WORK IN A TRENCH LOCATED WITHIN THE TOWN'S RIGHT-OF-WAY OR UTILITY EASEMENTS WITHOUT PROPER SHORING OR EXCAVATION METHODS.
- 21. THE CONTRACTOR IS RESPONSIBLE FOR TRAFFIC CONTROL ON AND AROUND THE CONSTRUCTION SITE. AT LEAST TEN (10) WORKING DAYS PRIOR TO CONSTRUCTION OR A NEW TASK REQUIRING TRAFFIC RESTRICTION, A TRAFFIC CONTROL PLAN FOR WORK WITHIN THE PUBLIC RIGHT-OF-WAY AND EASEMENTS SHALL BE PROVIDED TO THE TOWN TRAFFIC ENGINEER FOR REVIEW AND APPROVAL
- 22. WORK ZONE PLANNING AND TEMPORARY TRAFFIC CONTROL SHALL ACCOUNT FOR PAVEMENT EDGE DROP-OFFS IF THEY WILL BE PRESENT DURING THE WORK. PAVEMENT EDGE DROP-OFFS OF 2 INCHES OR LESS SHALL HAVE A 3:1 SLOPE CONSTRUCTED AT THE DROP OFF EDGE AND UNEVEN LANES (W8-11) OR SHOULDER DROP OFF (W8-17) WARNING SIGNS MAY BE ERECTED. VERTICAL PAVEMENT EDGE DROP OFFS GREATER THAN 2 INCHES SHALL HAVE CONCRETE OR WATER FILLED BARRIERS AND UNEVEN LANES (W8-11) OR SHOULDER DROP OFF (W8-17) WARNING SIGNS ERECTED OR OTHER MEASURES AS DIRECTED BY THE TOWN TRAFFIC ENGINEER.
- 23. NEITHER THE DESIGN ENGINEER NOR THE TOWN WILL BE RESPONSIBLE FOR JOB-SITE SAFETY PROCEDURES OR CONDITIONS.
- CONSTRUCTION MATERIALS AND PROCEDURE TESTING FOR EACH ELEMENT AND STAGE OF THE PROJECT SHALL BE PERFORMED DURING THE CONSTRUCTION BY A QUALIFIED TESTING FIRM RETAINED AND COMPENSATED BY THE CONTRACTOR. TEST METHODS AND FREQUENCIES SHALL BE IN ACCORDANCE WITH THE PROJECT PLANS AND SPECIFICATIONS AND OF SUFFICIENT NUMBER TO DEMONSTRATE THE

CONSTRUCTION COMPLETENESS AND ADEQUACY WITH REGARD TO MEETING OR EXCEEDING THE APPROPRIATE PLAN REQUIREMENTS AND SPECIFICATIONS. THE CONTRACTOR SHALL FURNISH COPIES OF THE TEST RESULTS TO THE TOWN IN A TIMELY MANNER TO ALLOW FOR TOWN REVIEW AND TIMELY ACTION REGARDING THE RESULTS. THE TOWN RESERVES THE RIGHT TO CONDUCT ITS OWN TESTING TO VERIFY AND ASSURE THE RESULTING CONSTRUCTION MEETS OR EXCEEDS THE DESIGN PLAN REQUIREMENTS AND SPECIFICATIONS.

- 25. THE CONTRACTOR SHALL NOTIFY THE TOWN PUBLIC WORKS DEPARTMENT OF COMPLETION OF ALL UNDERGROUND UTILITIES WITHIN THE STREET RIGHTS-OF-WAY PRIOR TO ANY STREET SUBGRADE PREPARATION WORK. INTERIM UTILITY AS-BUILT PLANS AND ALL TEST RESULTS SHALL BE SUBMITTED FOR TOWN REVIEW. UPON REVIEW AND APPROVAL OF THE SUPPLIED INFORMATION, THE CONTRACTOR MAY PROCEED WITH THE STREET IMPROVEMENTS INSTALLATION.
- 26. THE CONTRACTOR SHALL SUBMIT WEEKLY PROGRESS REPORTS TO THE TOWN PUBLIC WORKS DEPARTMENT THROUGHOUT THE CONSTRUCTION UNLESS OTHERWISE NOTED. THE PROGRESS REPORTS SHALL INCLUDE THE RESULTS OF ALL TESTS TAKEN DURING THAT WEEK AND ANY PREVIOUS TEST RESULTS THAT HAVE BECOME AVAILABLE.
- 27. IMPROVEMENT PLANS SHALL BE PREPARED UPON 22" X 34" PLAN SHEETS TO ALLOW FOR SCALABLE 11" X 17" REDUCED SIZE PLAN SETS.
- ACCEPTANCE OF THE COMPLETED IMPROVEMENTS WILL NOT BE GIVEN UNTIL AS-BUILT RECORD DRAWINGS IN ADOBE® PDF ELECTRONIC FORMAT IMAGES AND AUTOCAD FILES ON CD OR DVD ARE SUBMITTED TO AND
- THIS SET OF PLANS HAS BEEN REVIEWED FOR COMPLIANCE WITH TOWN REQUIREMENTS PRIOR TO APPROVAL AND ISSUANCE OF CONSTRUCTION PERMITS. HOWEVER, SUCH REVIEW SHALL NOT PREVENT THE TOWN FROM REQUIRING CORRECTION OF PLAN ERRORS OR OVERSIGHTS FOUND TO BE IN VIOLATION OF ANY LAW

ENVIRONMENTAL QUALITY NOTES

- THE CONTRACTOR SHALL PREPARE THE STORMWATER POLLUTION PREVENTION PLAN (SWPPP), FILE THE NOTICE OF INTENT (N.O.I.) WITH THE ARIZONA DEPARTMENT OF ENVIRONMENTAL QUALITY (ADEQ) AND SHALL BE THE PERMITTEE AND OPERATOR FOR THE PROJECT.
- 2. THE ARIZONA CONSTRUCTION GENERAL PERMIT, ASSOCIATED CONDITIONS AND RELATED FORMS AND NOTICES ARE AVAILABLE ONLINE AT WWF.ADEQ.GOV IN THE WATER QUALITY DIVISION.
- 3. A COPY OF THE APPROVED IMPROVEMENT PLANS FOR THIS PROJECT, TOGETHER WITH COPIES OF THE NOTICE OF INTENT (N.O.I.), THE ARIZONA GENERAL CONSTRUCTION PERMIT OR INDIVIDUAL PERMIT AND ASSOCIATED CONDITIONS, THE STORM WATER POLLUTION PREVENTION PLAN (SWPPP) AND THE POLLUTION CONTROL MEASURE MAINTENANCE AND STORM EVENT RECORDS SHALL BE MAINTAINED ON THE SITE AND
- 4. POLLUTION PREVENTION AND CONTROL MEASURES MAY BE MOVED, REMOVED OR INSTALLED IN PHASES THROUGHOUT AND DURING CONSTRUCTION AS PART OF THE SWPPP.
- 5. WHEREVER POSSIBLE, THE CONTRACTOR IS ENCOURAGED TO MAINTAIN EXISTING VEGETATION AND SURFACING FOR EROSION / SILT CONTROL.
- 6. THE STORM WATER POLLUTION PREVENTION MEASURES AND FACILITIES SHOWN WITHIN AND ON THE SWPPP MUST BE INSTALLED OR CONSTRUCTED PRIOR TO OR IN CONJUNCTION WITH ANY LAND SURFACE DISTURBANCE CONSTRUCTION ACTIVITIES TO ENSURE THAT SEDIMENT OR POLLUTION -LADEN RUNOFF DOES NOT LEAVE THE CONSTRUCTION SITE OR ENTER THE MUNICIPAL DRAINAGE SYSTEM IN VIOLATION OF APPLICABLE WATER STANDARDS.
- 7. THE CONTRACTOR / PERMITTEE / OPERATOR, IN ACCORDANCE WITH THE ARIZONA CONSTRUCTION GENERAL PERMIT REQUIREMENTS, SHALL PERFORM, AT A MINIMUM, A VISUAL INSPECTION OF AN ACTIVE CONSTRUCTION SITE ONCE EVERY 14 DAYS AND WITHIN 24 HOURS OF PRECIPITATION EVENTS AT THE SITE EQUAL TO OR GREATER THAN ONE HALF INCH OR MORE. EVERY 7 DAYS IF WITHIN A $\frac{1}{4}$ MILE OF AN IMPAIRED WATERWAY. THE OPERATOR SHALL PREPARE A REPORT DOCUMENTING HIS/HER FINDINGS ON THE CONDITIONS OF THE SWPPP CONTROLS AND NOTE ANY EROSION OR SEDIMENT PROBLEM AREAS. A COPY OF SUCH REPORTS SHALL BE SUBMITTED TO THE CIP INSPECTOR FOR REVIEW WITHIN 48 HOURS OF THE EVENT.
- THE CONTRACTOR / PERMITTEE / OPERATOR SHALL AMEND THE SWPPP PLAN AS NECESSARY DURING THE COURSE OF CONSTRUCTION TO RESOLVE ISSUES WITH ANY PROBLEM AREAS THAT BECOME EVIDENT DURING THE CONSTRUCTION AND/OR DURING RUNOFF EVENTS.
- STORM WATER POLLUTION PREVENTION MEASURES AND FACILITIES SHALL BE MAINTAINED AS NECESSARY TO ENSURE CONTINUED FUNCTIONING DURING PRECIPITATION EVENTS. ALL TEMPORARY EROSION AND SILTATION CONTROL MEASURES SHALL REMAIN IN PLACE AND BE MAINTAINED IN A SATISFACTORY CONDITION UNTIL CONSTRUCTION AND FINAL SURFACE STABILIZATION IS COMPLETED.
- 10. THE OPERATOR SHALL FILE A NOTICE OF TERMINATION (N.O.T.) AFTER COMPLETION OF CONSTRUCTION AND PLACEMENT OF FINAL LANDSCAPE MATERIALS (FINAL SURFACE STABILIZATION). A COPY OF THE N.O.T. SHALL BE SUBMITTED TO THE TOWN PUBLIC WORKS DEPARTMENT TO CLOSE OUT THE ENCROACHMENT PERMIT.
- 11. THE OPERATOR SHALL SAVE ALL SWPPP RELATED RECORDS, INCLUDING THE PERMIT COPY, N.O.I., SWPPP DOCUMENTS, N.O.T., AND THE INSPECTION/EVENT/ MAINTENANCE REPORTS ON FILE FOR A MINIMUM OF THREE YEARS FROM THE N.O.T. FILING DATE.
- 12. THE CONTRACTOR / OPERATOR SHALL NOTIFY THE CIP INSPECTOR WITHIN 24 HOURS OF ANY ADEQ / USEPA INSPECTIONS.
- 13. THE CONTRACTOR / OPERATOR SHALL FURNISH A COPY OF THE SWPPP DOCUMENTS AND N.O.I. AND REQUEST A TOWN INSPECTION OF THE POLLUTION PREVENTION MEASURES, IN ACCORDANCE WITH ESTABLISHED TOWN PROCEDURES, AT THE BEGINNING OF EACH PROPOSED SWPPP / CONSTRUCTION PHASE OR STAGE TO ASCERTAIN COMPLIANCE WITH THE PLAN
- 14. THE CONTRACTOR SHALL OBTAIN A DUST CONTROL PERMIT AND PROVIDE ADEQUATE AND APPROPRIATE DUST CONTROL MEASURES AS REQUIRED BY THE PERMIT TO PREVENT EXCESS AND FUGITIVE DUST. THE CONTRACTOR SHALL POST THE REQUIRED AIR QUALITY NOTICE SIGN AT AN AGREED UPON LOCATION WITHIN THE PROJECT LIMITS.

PROJECT PAVING NOTES

- 1. ALL UNDERGROUND UTILITY AND STORM DRAIN INSTALLATION IN STREETS, PUBLIC ACCESS WAYS OR SURFACED EASEMENTS SHALL BE CONSTRUCTED PRIOR TO SURFACING SUCH STREETS, ACCESS WAYS OR EASEMENTS.
- PAVEMENT BASE COURSE MATERIALS SHALL NOT BE PLACED ON SUBGRADE UNTIL SUBGRADE IMPROVEMENTS HAVE BEEN COMPLETED, TESTED AND AUTHORIZATION TO PROCEED HAS BEEN GIVEN BY THE CIP INSPECTOR.
- NO PAVEMENT, CURB OR SIDEWALK CONSTRUCTION SHALL BE STARTED UNTIL ALL UNDERGROUND UTILITY CONSTRUCTION WITHIN THE RIGHT-OF-WAY AND ADJACENT EASEMENTS IS COMPLETED UNLESS OTHERWISE AGREED TO BY THE TOWN.
- 4. EXACT POINT OF MATCHING, TERMINATION, MILLING AND OVERLAY, IF NECESSARY, SHALL BE DETERMINED IN THE FIELD BY THE CIP INSPECTOR. VARIANCES FROM THE PLAN SO MADE SHALL BE NOTED BY THE CONTRACTOR ON THE AS-BUILT RECORD DRAWINGS.
- 5. CONSTRUCTION STAKING SHALL INCLUDE:
 - RIGHT-OF-WAY LINES AT 100' INTERVALS,
 - PRE-GRADE AND REFERENCE CONTROL AS NECESSARY,
- CULVERT, STORM DRAIN AND DITCH INVERTS AT 50' INTERVALS, STRUCTURES, BRANCHES, CHANGES IN
- PIPE DIAMETERS AND BREAKS IN GRADE,
- STRUCTURE LOCATION, ELEVATIONS AND GRADES AS NECESSARY TO ACCURATELY CONSTRUCT, BLUE TOP SUBGRADE AT CENTERLINE AND UNCURBED EDGE OF PAVEMENT AT 50' INTERVALS,
- BLUE TOP A.B.C. AT CENTERLINE AND UNCURBED EDGE OF PAVEMENT AT 50' INTERVALS AND AT CURB
- RETURN 1/4 POINTS,

- CONCRETE CURB AND GUTTER AT 50' INTERVALS MAXIMUM IN TANGENT SECTIONS; 25' MAXIMUM INTERVALS IN HORIZONTAL OR VERTICAL CURVES AND ALL LONGITUDINAL GRADES LESS THAN 0.5%; AND AT THE P.C. AND 1/4 POINTS OF CURB RETURNS,
- PROVIDING STRADDLE POINTS FOR ALL PERMANENT SURVEY MONUMENTS, PUNCHING ALL SURVEY MONUMENT CAPS AFTER SETTING.
- CURB GUTTERS AND VALLEY GUTTERS SHALL BE WATER TESTED IN THE PRESENCE OF THE CIP INSPECTOR.
- BLUE REFLECTIVE PAVEMENT MARKERS SHALL BE INSTALLED IN ACCORDANCE WITH TOWN OF QUEEN CREEK SUPPLEMENTAL STANDARD DETAIL R-130 ON THE COMPLETED STREET PAVEMENT AT ALL FIRE HYDRANT
- STREET NAME SIGNS SHALL BE INSTALLED AS NOTED IN THE SIGNING AND MARKING PLANS.
- NO PROJECT WILL BE CONSIDERED COMPLETE UNTIL ALL CURBS, PAVEMENT AND SIDEWALKS HAVE BEEN SWEPT CLEAN OF ALL DIRT AND DEBRIS AND ALL SURVEY MONUMENTS ARE INSTALLED ACCORDING TO THE PLANS AND SPECIFICATIONS.
- DETECTABLE WARNINGS ON SIDEWALK RAMPS AND PATHWAYS SHALL BE PROVIDED USING NEENAH FOUNDRY DETECTABLE WARNING PLATES, CATALOG NUMBER 4984. VARIOUS SIZES AND SHAPES ARE AVAILABLE TO FIT MULTIPLE SITUATIONS. PAINTING IS NOT REQUIRED.

QUEEN CREEK GRADING AND DRAINAGE NOTES

- THE CONTRACTOR SHALL PROVIDE GRADING FOR POSITIVE DRAINAGE IN ALL RETENTION BASINS AT THE ELEVATIONS AS SHOWN ON THE PLANS. BASINS SHALL BE GRADED TO DRAIN TOWARD DRYWELLS (WHEN USED) OR OUTLETS. MAXIMUM BASIN SIDE SLOPES SHOWN ON PLANS.
- DRYWELL INLET GRATES SHALL BE AT FINISH GRADE AT THE BOTTOM OF THE RETENTION BASIN.
- DRILLING LOGS FOR DRY WELLS SHALL BE FURNISHED TO THE PROJECT MANAGER AND DESIGNATED INSPECTOR PRIOR TO FINAL ACCEPTANCE.
- PERCOLATION TESTS FOR COMPLETED RETENTION BASINS ARE REQUIRED PRIOR TO ACCEPTANCE. IF INSUFFICIENT PERCOLATION RATE SOILS ARE ENCOUNTERED, ADDITIONAL DRYWELLS OR AN ALTERNATIVE METHOD OF STORM WATER RUN-OFF DISPOSAL MAY BE REQUIRED.
- DRYWELL CONSTRUCTION SHALL BE DONE ONLY BY CONTRACTORS LICENSED BY THE ARIZONA DEPARTMENT OF ENVIRONMENTAL QUALITY FOR SUCH WORK.
- ALL DRYWELLS ARE REQUIRED TO BE REGISTERED WITH THE ARIZONA DEPARTMENT OF ENVIRONMENTAL QUALITY. THE APPROVED DRYWELL REGISTRATION SHALL BE SUBMITTED TO THE TOWN PUBLIC WORKS REPRESENTATIVE AND DESIGNATED INSPECTOR BY THE CONTRACTOR AT THE TIME AS-BUILT DRAWINGS ARE
- A PAD COMPACTION CERTIFICATION SHALL BE SUBMITTED TO THE PROJECT MANAGER AND CIP INSPECTOR PRIOR TO ANY BUILDING CONSTRUCTION ASSOCIATED WITH THESE IMPROVEMENT PLANS.
- SURVEYOR CERTIFICATION OF BUILDING PAD ELEVATIONS ASSOCIATED WITH THIS PROJECT (IF ANY) SHALL BE SUBMITTED PRIOR TO PLACING CONCRETE FLOORS.
- ALL DRAINAGE PROTECTIVE DEVICES SUCH AS SWALES, PIPES, OR OTHER MEASURES DESIGNED TO PROTECT BUILDINGS OR PROPERTY FROM STORMWATER RUNOFF MUST BE COMPLETED PRIOR TO ANY STRUCTURE BEING BUILT.
- PROJECT AREAS OVER WHICH FILLS ARE TO BE PLACED SHALL BE CLEARED OF ALL TRASH, TREES, STUMPS, DEBRIS OR OTHER DELETERIOUS MATERIAL NOT SUITABLE AS A FOUNDATION FOR FILL.
- DISTURBED GROUND AREAS SHALL BE RE-VEGETATED, SURFACED OR MULCHED AS DIRECTED HEREIN OR BY THE ASSOCIATED LANDSCAPE PLANS UNLESS OTHERWISE NOTED. EXISTING VEGETATION DISTURBED BY CONSTRUCTION SHALL BE SALVAGED AND RELOCATED IF SO NOTED.
- ALL DRAINAGE SWALES SHALL BE FREE OF TRASH, DELETERIOUS MATERIAL, SILT, UNSPECIFIED VEGETATION. AND DEBRIS UPON COMPLETION AND ACCEPTANCE.
- DROPS IN ELEVATION OF 30 INCHES OR MORE AT GRADES STEEPER THAN 4:1 WITHIN THREE FEET ADJACENT TO TRAILS OR SIDEWALKS SHALL BE PROTECTED BY SAFETY RAIL THAT IS AASHTO AND ADA COMPLIANT.

ABBREVIATIONS AGGREGATE BASE COURSE ASPHALT CONCRETE ANGLE POINT BARHH FD REBAR FOUND IN HAND HOLE BCH FD BRASS CAP FOUND BCHH FD BRASS CAP IN HAND HOLE FOUND BEGIN CURB RETURN CATV CABLE TV CAPITAL IMPROVEMENT PROJECT CL CENTERLINE CMU CONCRETE MASONRY UNIT CTL CENTURY LINK CONC CONCRETE CST CONSTRUCTION DE DRAINAGE EASEMENT DET/DTL DETAIL DECOMPOSED GRANITE DG D/W DRIVEWAY DW L TCE DRIVEWAY LETTER TEMP CONSTRUCTION EASEMENT **END CURB RETURN** ENT ENTRANCE EP **EDGE OF PAVEMENT EXIST EXISTING** F/C FACE OF CURE FΗ FIRE HYDRANT FT FEET **GUTTER** GB **GRADE BREAK** GB-HP GRADE BREAK-HIGH POINT GB-LP **GRADE BREAK-LOW POINT** GV GATE VALVE IRR IRRIGATION ITS INTELLIGENT TRANSPORTATION SYSTEM LT MAG MARICOPA ASSOCIATION OF GOVERNMENTS MOD MODIFIED NAVD NORTH AMERICAN VERTICAL DATUM NPI **NON-PAY ITEM** NTS NOT TO SCALE OT OVERHEAD TELEPHONE PAVEMENT PC POINT OF CURVE Ы POINT OF TANGENT INTERSECTION PIP PROTECT IN PLACE PRC POINT OF REVERSE CURVE PΤ POINT OF TANGENT PUE PUBLIC UTILITY EASEMENT PVC POINT OF VERTICAL CURVE R/W RIGHT OF WAY RBF HH REBAR FOUND IN HAND HOLE RGRCP RUBBER GASKET REINFORCED CONCRETE PIPE RT RIGHT RTL RIGHT TURN LANE SW S/W SIDEWALK SDR STANDARD DIMENSION RATIO SRP SALT RIVER PROJECT STA STATION STD STANDARD STID SAN TAN IRRIGATION DISTRICT TOP OF CURB TCE TEMPORARY CONSTRUCTION EASEMENT TOQC TOWN OF QUEEN CREEK

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TOWN OF



POWER ROAD: RIGGS ROAD TO CHANDLER HEIGHTS ROAD ROADWAY AND DRAINAGE IMPROVEMENTS

GENERAL NOTES AND LEGEND

DESIGNED BY MH CIP PROJ NO. A1405 DRAWN BY

> GN001 DRAWING NO.

SHEET 4 OF 133 €

Tel. 480.687.6100

NOTE: CONFLICTS BETWEEN NOTES SHALL

FOLLOW THE MORE STRINGENT REQUIREMENTS

TRUE SLOPE

WATER METER

UE

W/

WM

UNO

VNAE

TWO-WAY LEFT TURN LANE

UNDERGROUND ELECTRIC

UNLESS NOTED OTHERWISE

VEHICULAR NON-ACCESS EASEMENT

Chandler, Arizona 85226

- THIS SET OF PLANS HAS BEEN REVIEWED FOR COMPLIANCE WITH DEPARTMENT REQUIREMENTS PRIOR TO ISSUANCE OF CONSTRUCTION PERMITS. HOWEVER, SUCH REVIEW SHALL NOT PREVENT THE DEPARTMENT FROM REQUIRING CORRECTION OF ERRORS IN PLANS SOUND TO BE IN VIOLATION OF ANY LAW OR
- THE CONTRACTOR SHALL OBTAIN ALL NECESSARY PERMITS PRIOR TO BEGINNING CONSTRUCTION.
- THE CONTRACTOR IS RESPONSIBLE FOR VERIFICATION OF EXISTING PERMITS AND RENEWAL OF LAPSED
- THE WATER DEPARTMENT APPROVAL IS VALID FOR A PERIOD OF ONE YEAR. CONSTRUCTION PERMITS SHALL BE OBTAINED DURING THIS PERIOD OF THE PLANS SHALL BE RESUBMITTED FOR REVIEW AND APPROVAL.
- AN APPROVED SET OF PLANS SHALL BE AVAILABLE ON THE JOB SITE AT ALL TIMES.
- 7. DEVELOPER IS RESPONSIBLE FOR OBTAINING ALL PERMANENT AND TEMPORARY EASEMENTS PRIOR TO
- BEGINNING CONSTRUCTION. PRIVATE ON-SITE WATER LINES SHALL BE CONSTRUCTED IN ACCORDANCE WITH THE LATEST REVISION OD
- THE UNIFORM PLUMBING CODE AND THE LATEST REVISION OF THE UNIFORM FIRE CODE. ENGINEER CERTIFIES THAT HE HAS CONTACTED ALL INTERESTED UTILITY COMPANIES AND HAS TRANSFERRED ALL EXISTING AND/OR PROPOSED UTILITY LINES AND RELATED INFORMATION ONTO THESE
- 10. THE ENGINEER SHALL CERTIFY THAT ALL WATER IMPROVEMENTS HAVE BEEN INSTALLED AT THE LOCATIONS
- AND ELEVATIONS SHOWN ON THE APPROVED PLANS. 11. THE ENGINEER SHALL CERTIFY THAT THE MINIMUM HORIZONTAL AND VERTICAL SEPARATION BETWEEN
- UTILITIES HAS BEEN MAINTAINED AS REQUIRED BY LAW OR POLICY. 12. THE CONTRACTOR SHALL ARRANGE TO PROVIDE ALL CONSTRUCTION STAKING REQUIRED FOR THE PROJECT.
- 13. THE CONTRACTOR IS RESPONSIBLE FOR COORDINATING THE RELOCATION OF ALL UTILITIES, POWER POLES, IRRIGATION DRY-UPS, REMOVALS BY OTHERS, ETC.
- 14. ALL FRAMES, COVERS, VALVE BOXES, MANHOLES, ETC. SHALL BE INSTALLED TO FINISH GRADE OR SHALL BE ADJUSTED TO FINISH GRADE PRIOR TO PLACING OF ASPHALT SURFACE COURSE BY THE CONTRACTOR AS PER MAG STANDARD DETAIL 270 AND 422.
- 15. IT IS THE CONTRACTOR'S RESPONSIBILITY TO LOCATE ALL UTILITIES PRIOR TO EXCAVATION AND AVOID DAMAGE TO SAME. CALL 602-263-1100 FOR BLUE STAKE TWO WORKING DAYS PRIOR TO DIGGING.
- 16. CONTRACTOR WILL EXPOSE ALL TIE-IN POINTS TO BEGINNING SUBSTANTIAL CONSTRUCTION ACTIVITIES.
- 17. THE TOWN OF QUEEN CREEK WATER DEPARTMENT IS NOT LIABLE FOR DELAYS NOR DAMAGES TO UTILITIES RELATED TO THIS CONSTRUCTION; NEITHER WILL THE WATER DEPARTMENT PARTICIPATE IN THE COST OF UTILITY RECONSTRUCTION OR RELOCATION.
- THE CONTRACTOR IS RESPONSIBLE FOR MAKING ARRANGEMENTS FOR INSPECTION AND TESTING. INSPECTIONS SHOULD BE COORDINATED WITH THE CIP INSPECTOR. INSPECTIONS ARE ON A DAY TO DAY FIRST COME FIRST SERVE BASIS. CONSTRUCTION CONCEALED WITHOUT THE REQUIRED INSPECTION SHALL BE SUBJECT TO EXPOSURE AT THE CONTRACTOR'S EXPENSE.
- THE CONTRACTOR WILL FOLLOW GUIDELINES AND REGULATIONS SET FORTH BY OSHA. NEITHER THE ENGINEER OR THE TOWN WILL BE RESPONSIBLE FOR JOB-SITE SAFETY PROCEDURES OR CONDITIONS.
- THE CONTRACTOR IS RESPONSIBLE FOR HIS OWN TAKEOFF QUANTITIES. QUANTITIES SHOWN HEREON ARE ESTIMATES ONLY AND AS SUCH ARE NOT TO BE USED FOR BID PURPOSES.
- THE CONTRACTOR IS RESPONSIBLE FOR THE NOTIFICATION OF THE PROPER AUTHORITY(S) IF THERE ARE OBSTRUCTIONS TO PROPOSED IMPROVEMENTS AS SHOWN ON THE CONSTRUCTION DRAWINGS. ANY EXISTING ITEM REMOVED TO FACILITATE CONSTRUCTION SHALL BE REPLACED IN THE SAME OR BETTER CONDITION AT THE CONTRACTOR'S EXPENSE.
- 22. THE CONTRACTOR IS RESPONSIBLE FOR TRAFFIC CONTROL ON AND AROUND THE CONSTRUCTION SITE.
- 23. ALL WATER LINES SHALL HAVE 48" MINIMUM COVER AS SPECIFIED IN THE TOWN OF QUEEN CREEK WATER
- DEPARTMENT DESIGN STANDARDS AND CONSTRUCTION MANUAL. 24. CONTRACTOR MUST MAINTAIN SLOPE OF WATER LINES TO HIGH POINTS AT COMBINATION AIR VALVES OR LOW
- POINTS AT BLOW OFFS OR FIRE HYDRANTS. 25. IN ACCORDANCE WITH AAC R18-4-213, ALL MATERIALS ADDED AFTER JANUARY 1, 1993 WHICH MAY COME INTO CONTACT WITH DRINKING WATER SHALL CONFORM TO NATIONAL SANITATION FOUNDATION STANDARDS 60
- 26. DUCTILE IRON PIPE WHEN REQUIRED SHALL BE THICKNESS CLASS 350.
- SERVICE CONNECTION BACK-FLOWS PREVENTORS SHALL BE FURNISHED AND INSTALLED BY THE CONTRACTOR.
- 28. FIRE HYDRANTS SHALL RECEIVE 2 FIELD COATS FOR YELLOW(PUBLIC) OR RED(PRIVATE) PAINT PRIOR TO ACCEPTANCE OF WORK BY THE WATER DEPARTMENT.
- 29. DEVELOPER IS TO INSTALL ALL TAPS AND METER BOXES. REFER TO THE WATER DEPARTMENT DESIGN AND CONSTRUCTION STANDARDS MANUAL FOR CLARIFICATION ON METER BOX LOCATION AND REQUIRED
- METERS SHALL BE FURNISHED AND INSTALLED BY THE DEPARTMENT.
- 31. PAVEMENT REPLACEMENT AND TRENCH REPAIR SHALL BE DONE TO MAG STANDARD SPECIFICATIONS AND DETAILS.
- 32. ALL WATER SERVICES CONNECTIONS SHALL BE EXTENDED TO THE PROPOSED METER LOCATIONS AS INDICATED ON THE PLANS SUCH THAT ADDITIONAL EXTENSION WILL NOT BE REQUIRED.
- 33. IMPROVEMENTS SHALL NOT BE ACCEPTED UNTIL"AS-BUILT" PLANS HAVE BEEN SUBMITTED. REVIEWED AND APPROVED BY THE WATER DEPARTMENT.

TOWN OF QUEEN CREEK SEWER GENERAL NOTES:

- ALL WORK, TESTING AND MATERIALS SHALL CONFORM TO THE LATEST EDITION OF THE TOWN OF QUEEN CREEK DESIGN AND CONSTRUCTION STANDARDS MANUAL. ALL WORK AND MATERIALS NOT IN CONFORMANCE WITH STANDARDS AND DETAILS ARE SUBJECT TO REMOVAL AND REPLACEMENT AT THE CONTRACTOR'S EXPENSE. THE TOWN OF QUEEN CREEK WATER DEPARTMENT REPRESENTATIVE SHALL HAVE FINAL AUTHORITY ON ALL IMPROVEMENTS REGARDLESS OF THE PLANS AND/OR SPECIFICATIONS.
- THIS SET OF PLANS HAS BEEN REVIEWED FOR COMPLIANCE WITH DEPARTMENT REQUIREMENTS PRIOR TO ISSUANCE OF CONSTRUCTION PERMITS. HOWEVER, SUCH REVIEW SHALL NOT PREVENT THE DEPARTMENT FROM REQUIRING CORRECTION OF ERRORS IN PLANS SOUND TO BE IN VIOLATION OF ANY LAW OR
- THE CONTRACTOR SHALL OBTAIN ALL NECESSARY PERMITS PRIOR TO BEGINNING CONSTRUCTION.
- THE CONTRACTOR IS RESPONSIBLE FOR VERIFICATION OF EXISTING PERMITS AND RENEWAL OF LAPSED
- THE SEWER DEPARTMENT APPROVAL IS VALID FOR A PERIOD OF ONE YEAR. CONSTRUCTION PERMITS SHALL BE OBTAINED DURING THIS PERIOD OF THE PLANS SHALL BE RESUBMITTED FOR REVIEW AND APPROVAL.
- AN APPROVED SET OF PLANS SHALL BE AVAILABLE ON THE JOB SITE AT ALL TIMES.
- DEVELOPER IS RESPONSIBLE FOR OBTAINING ALL PERMANENT AND TEMPORARY EASEMENTS PRIOR TO BEGINNING CONSTRUCTION.
- PRIVATE ON-SITE SEWER LINES SHALL BE CONSTRUCTED IN ACCORDANCE WITH THE LATEST REVISION OF THE UNIFORM PLUMBING CODE.
- ENGINEER CERTIFIES THAT HE HAS CONTACTED ALL INTERESTED UTILITY COMPANIES AND HAS TRANSFERRED ALL EXISTING AND/OR PROPOSED UTILITY LINES AND RELATED INFORMATION ONTO THESE PLANS.
- THE ENGINEER SHALL CERTIFY THAT ALL SEWER IMPROVEMENTS HAVE BEEN INSTALLED AT THE LOCATIONS AND ELEVATIONS SHOWN ON THE APPROVED PLANS.
- THE ENGINEER SHALL CERTIFY THAT THE MINIMUM HORIZONTAL AND VERTICAL SEPARATION BETWEEN
- UTILITIES HAS BEEN MAINTAINED AS REQUIRED BY LAW OR POLICY. THE CONTRACTOR SHALL ARRANGE TO PROVIDE ALL CONSTRUCTION STAKING REQUIRED FOR THE PROJECT.
- THE CONTRACTOR IS RESPONSIBLE FOR COORDINATING THE RELOCATION OF ALL UTILITIES, POWER POLES, IRRIGATION DRY-UPS, REMOVALS BY OTHERS, ETC.
- ALL FRAMES, COVERS, VALVE BOXES, MANHOLES, ETC. SHALL BE INSTALLED TO FINISH GRADE OR SHALL BE ADJUSTED TO FINISH GRADE PRIOR TO PLACING OF ASPHALT SURFACE COURSE BY THE CONTRACTOR AS PER MAG STANDARD DETAIL 270 AND 422.
- 15. IT IS THE CONTRACTOR'S RESPONSIBILITY TO LOCATE ALL UTILITIES PRIOR TO EXCAVATION AND AVOID DAMAGE TO SAME. CALL 602-263-1100 FOR BLUE STAKE TWO WORKING DAYS PRIOR TO DIGGING.
- 16. CONTRACTOR WILL EXPOSE ALL TIE-IN POINTS TO BEGINNING SUBSTANTIAL CONSTRUCTION ACTIVITIES.

- 17. THE TOWN OF QUEEN CREEK WATER DEPARTMENT IS NOT LIABLE FOR DELAYS NOR DAMAGES TO UTILITIES RELATED TO THIS CONSTRUCTION; NEITHER WILL THE SEWER DEPARTMENT PARTICIPATE IN THE COST OF UTILITY RECONSTRUCTION OR RELOCATION.
- 18. THE CONTRACTOR IS RESPONSIBLE FOR MAKING ARRANGEMENTS FOR INSPECTION AND TESTING. INSPECTIONS SHOULD BE COORDINATED WITH DERRICK KIRKPATRICK (480) 204-3288. INSPECTIONS ARE ON A DAY TO DAY FIRST COME FIRST SERVE BASIS. CONSTRUCTION CONCEALED WITHOUT THE REQUIRED INSPECTION SHALL BE SUBJECT TO EXPOSURE AT THE CONTRACTOR'S EXPENSE.
- 19. THE CONTRACTOR WILL FOLLOW GUIDELINES AND REGULATIONS SET FORTH BY OSHA. NEITHER THE ENGINEER OR THE TOWN WILL BE RESPONSIBLE FOR JOB-SITE SAFETY PROCEDURES OR CONDITIONS.
- THE CONTRACTOR IS RESPONSIBLE FOR HIS OWN TAKEOFF QUANTITIES. QUANTITIES SHOWN HEREON ARE ESTIMATES ONLY AND AS SUCH ARE NOT TO BE USED FOR BID PURPOSES.
- THE CONTRACTOR IS RESPONSIBLE FOR THE NOTIFICATION OF THE PROPER AUTHORITY(S) IF THERE ARE OBSTRUCTIONS TO PROPOSED IMPROVEMENTS AS SHOWN ON THE CONSTRUCTION DRAWINGS. ANY EXISTING ITEM REMOVED TO FACILITATE CONSTRUCTION SHALL BE REPLACED IN THE SAME OR BETTER CONDITION AT THE CONTRACTOR'S EXPENSE
- 22. THE CONTRACTOR IS RESPONSIBLE FOR TRAFFIC CONTROL ON AND AROUND THE CONSTRUCTION SITE. 23. ALL WATER LINES SHALL HAVE 48" MINIMUM COVER AS SPECIFIED IN THE TOWN OF QUEEN CREEK WATER DEPARTMENT DESIGN STANDARDS AND CONSTRUCTION MANUAL.
- 24. PAVEMENT REPLACEMENT AND TRENCH REPAIR SHALL BE DONE TO MAG STANDARD SPECIFICATIONS AND
- IMPROVEMENTS SHALL NOT BE ACCEPTED UNTIL"AS-BUILT" PLANS HAVE BEEN SUBMITTED, REVIEWED AND APPROVED BY THE SEWER DEPARTMENT.
- ALL MANHOLES (PUBLIC AND PRIVATE) THAT ARE NOT REQUIRED TO BE POLYMER BY TOQC SHALL BE COATED PER SECTION 6.9.1 IN THE TOWN OF QUEEN CREEK DESIGN AND CONSTRUCTION STANDARDS MANUAL

SRP POWER NOTES

- PRIOR TO CONSTRUCTION THE CONTRACTOR SHALL CONTACT SRP SAFETY SERVICES TO ARRANGE FOR A SAFETY MEETING REGARDING WORKING UNDER TRANSMISSION LINES. THE CONTACT NUMBER FOR SRP SAFETY SERVICES IS 602-236-8117.
- NO STORING OF EQUIPMENT OR MATERIALS AT SRP POLE SETUP AREAS OR UNDER POWER LINES.
- PROVIDE 24/7 ACCESS FOR SRP EQUIPMENT FOR SETUP AND MAINTENANCE DURING THE DURATION OF CONSTRUCTION FOR THE PROJECT.
- CONTRACTOR SHALL PROTECT IN PLACE ALL EXISTING POWER POLES DURING CONSTRUCTION ACTIVITIES.

IRRIGATION DISTRICT GENERAL NOTES

- PRIOR TO CONSTRUCTION OF ANY STRUCTURE THAT ENCROACHES WITHIN A RECLAMATION PIPELINE OR CANAL ROW; AN ADVANCE WARNING OF AT LEAST 48 HOURS MUST BE GIVEN TO BOTH SANTAN OR RANCHO JARDINES FOR ALL CONSTRUCTION WITHIN THE IRRIGATION RIGHT-OF-WAY OR EASEMENT. PLEASE CONTACT THE FOLLOWING:
 - JIM MILLSPAUGH, RANCHO JARDINES DISTRICT MANAGER (480) 570-2643 TODD ANGLE, SAN TAN GENERAL MANAGER (480) 988-3385
- PRIOR TO CONSTRUCTION OF ANY STRUCTURE THAT ENCROACHES WITHIN A RECLAMATION PIPELINE OR CANAL ROW, OTHER THAN AN OVERHEAD CROSSING; A "POTHOLE EXCAVATION" SHOULD BE MADE TO DETERMINE THE LOCATIONS OF ANY EXISTING IRRIGATION FACILITIES AND THEIR APPURTENANT FEATURES THAT MAY BE AFFECTED. THE RESULTANT ELEVATION INFORMATION SHOULD BE DELINEATED ON THE PROFILE VIEW AND LABELED AS: POTHOLE ELEVATION XX.X SURFACE ELEVATION XX.X
- CONSTRUCTION ACTIVITIES WILL BE MONITORED BY SAN TAN AND RANCHO JARDINES IRRIGATION DISTRICT. DURING CONSTRUCTION. THE CONTRACTOR IS REQUIRED TO NOTIFY SAN TAN AND RANCHO JARDINES IRRIGATION DISTRICT AT LEAST 48 HOURS PRIOR; POTHOLE LOCATING OF THE EXISTING SAN TAN AND RANCHO JARDINES IRRIGATION DISTRICTS PIPE, THE START OF EXCAVATION ACROSS SAN TAN AND RANCHO JARDINES IRRIGATION DISTRICTS RIGHT-OF-WAY AND/OR SAN TAN AND RANCHO JARDINES IRRIGATION DISTRICTS JOINT USE EASEMENT, UTILITY INSTALLATIONS UNDER OR OVER SAN TAN AND RANCHO JARDINES IRRIGATION DISTRICTS RIGHT-OF-WAY AND CONNECTIONS BETWEEN SAN TAN AND RANCHO JARDINES IRRIGATION DISTRICTS AND THE NEWLY CONSTRUCTED FACILITIES.
- THE CONTRACTOR SHALL PROTECT ALL SAN TAN AND RANCHO JARDINES IRRIGATION DISTRICTS STRUCTURES, FACILITIES AND RESOURCES FROM DAMAGE DURING CONSTRUCTION ACTIVITIES OCCURRING NEAR OR WITHIN THE SAN TAN AND RANCHO JARDINES IRRIGATION DISTRICTS RIGHT-OF-WAY OR JOINT USE EASEMENT.
- A PRECONSTRUCTION SITE WALK SHALL BE SET UP WITH SAN TAN IRRIGATION TO DETERMINE AND DOCUMENT THE CONDITION OF THE PIPE AND AND ANY EXISTING LEAKS. ANY DAMAGE TO THE PIPES DURING CONSTRUCTION SHALL BE FIXED BY THE CONTRACTOR AT NO ADDITIONAL COST TO THE TOWN OR SAN TAN IRRIGATION DISTRICT.

COX COMMUNICATION NOTES

- EXISTING COX PEDESTALS, POLES, AND VAULTS ARE WITHIN THE CONSTRUCTION AREA. CONTRACTOR SHALL LOCATE AND PROTECT IN PLACE.
- FOR PROPOSED DEMOLITION AND GRADING ABOVE EXISTING COX FACILITIES. CONTRACTOR TO PROCEED WITH CAUTION AND PROTECT IN PLACE.
- EXISTING COX FACILITIES (VAULTS, HANDHOLE, MANHOLES, FIBER CABINET, POWER SUPPLY AND/OR SURFACE MOUNTS) WITHIN THE PROJECT VICINITY BUT OUTSIDE OF IMMEDIATE CONSTRUCTION AREA, CONTRACTOR SHALL PROTECT IN PLACE.
- WHEN CONSTRUCTION IS BELOW COX AERIAL FACILITIES, CONTRACTOR SHALL PROTECT IN PLACE.

LEGEND

PAVEMENT REPLACEMENT TEMPORARY PAVEMENT REPLACEMENT (WATER PLANS) NEW RIP-RAP NEW GRAVEL NEW CONCRETE CATCH BASIN, CURB & GUTTER INLET ——FO—— EXISTING UNDERGROUND FIBER OPTIC LINE —— ITS —— EXISTING ITS — 6" PE G — EXISTING GAS LINE

—6" STI G— EXISTING GAS LINE —15" IRR — EXISTING IRRIGATION LINE —— UE —— EXISTING UNDERGROUND ELECTRICAL LINE

NEW SURVEY MONUMENT - M.A.G. DETAIL 120-1 TYPE "B" NEW SURVEY MONUMENT - M.A.G. DETAIL 120-1 TYPE "A"

COMBINED CURB & GUTTER - M.A.G. DETAIL 220 TYPE "A" NEW CONCRETE SIDEWALK - STD. DETAIL P230 NEW DRIVEWAY WITH DETACHED SIDEWALK. PER

NEW DRIVEWAY WITH ATTACHED SIDEWALK. PER

NEW CONCRETE SIDEWALK RAMP PER DETAIL ON PLANS

NEW CONCRETE SCUPPER EXISTING IRRIGATION VALVE ——12" W—— EXISTING WATER LINE W/SIZE & TYPE (12" AND SMALLER)

EXISTING FIRE HYDRANT

EXISTING WATER METER

NEW OR RELOCATED FIRE HYDRANT BY CONTRACTOR

EXISTING WATER VALVE

NEW WATER VALVE

EXISTING TELEPHONE PEDESTAL — 6" STL G— EXISTING 6" STEEL GAS EXISTING TRAFFIC SIGNAL POLE W/MAST ARM **EXISTING TRAFFIC SIGNAL** EXISTING STREET LIGHT EXISTING STREET OR TRAFFIC SIGN EXISTING UTILITY POLE W/LINE INDICATING WIRE **EXISTING TRAFFIC SIGNAL PULLBOX** SIGN POST MAIL BOX EXISTING POWER POLE DOWN GUY ANCHOR NEW STREET LIGHT **EXISTING STREET LIGHT & POLE** EASEMENT LINE, SEE PLANS — — EXISTING R/W LINE —— — — NEW R/W LINE ——— — PAVEMENT CENTER LINE OR MONUMENT LINE —— FLOWLINE



EXISTING PALM TREE

EXISTING TREE

——12" SS—— EXISTING SANITARY SEWER LINE W/SIZE & TYPE

18" SS EXISTING SANITARY SEWER LINE W/SIZE & TYPE

EXISTING STORM DRAIN MANHOLE

EXISTING TELEPHONE MANHOLE

EXISTING ELECTRICAL JUNCTION BOX

EXISTING TRAFFIC JUNCTION BOX

EXISTING COMMUNICATION JUNCTION BOX

EXISTING SEWER MANHOLE

EXISTING COMM MANHOLE

(12" AND SMALLER)

(GREATER THAN 12")

— EXISTING FENCE

EXISTING DITCH

NEW PIPE FOR STORM DRAIN





TOWN OF QUEEN CREEK SUBMITT

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NOTE: CONFLICTS BETWEEN NOTES SHALL

FOLLOW THE MORE STRINGENT REQUIREMENTS

POWER ROAD: RIGGS ROAD TO CHANDLER HEIGHTS ROAD ROADWAY AND DRAINAGE IMPROVEMENTS

Stantec

GENERAL NOTES AND LEGEND

DESIGNED BY! MH CIP PROJ NO. A1405 DRAWN BY


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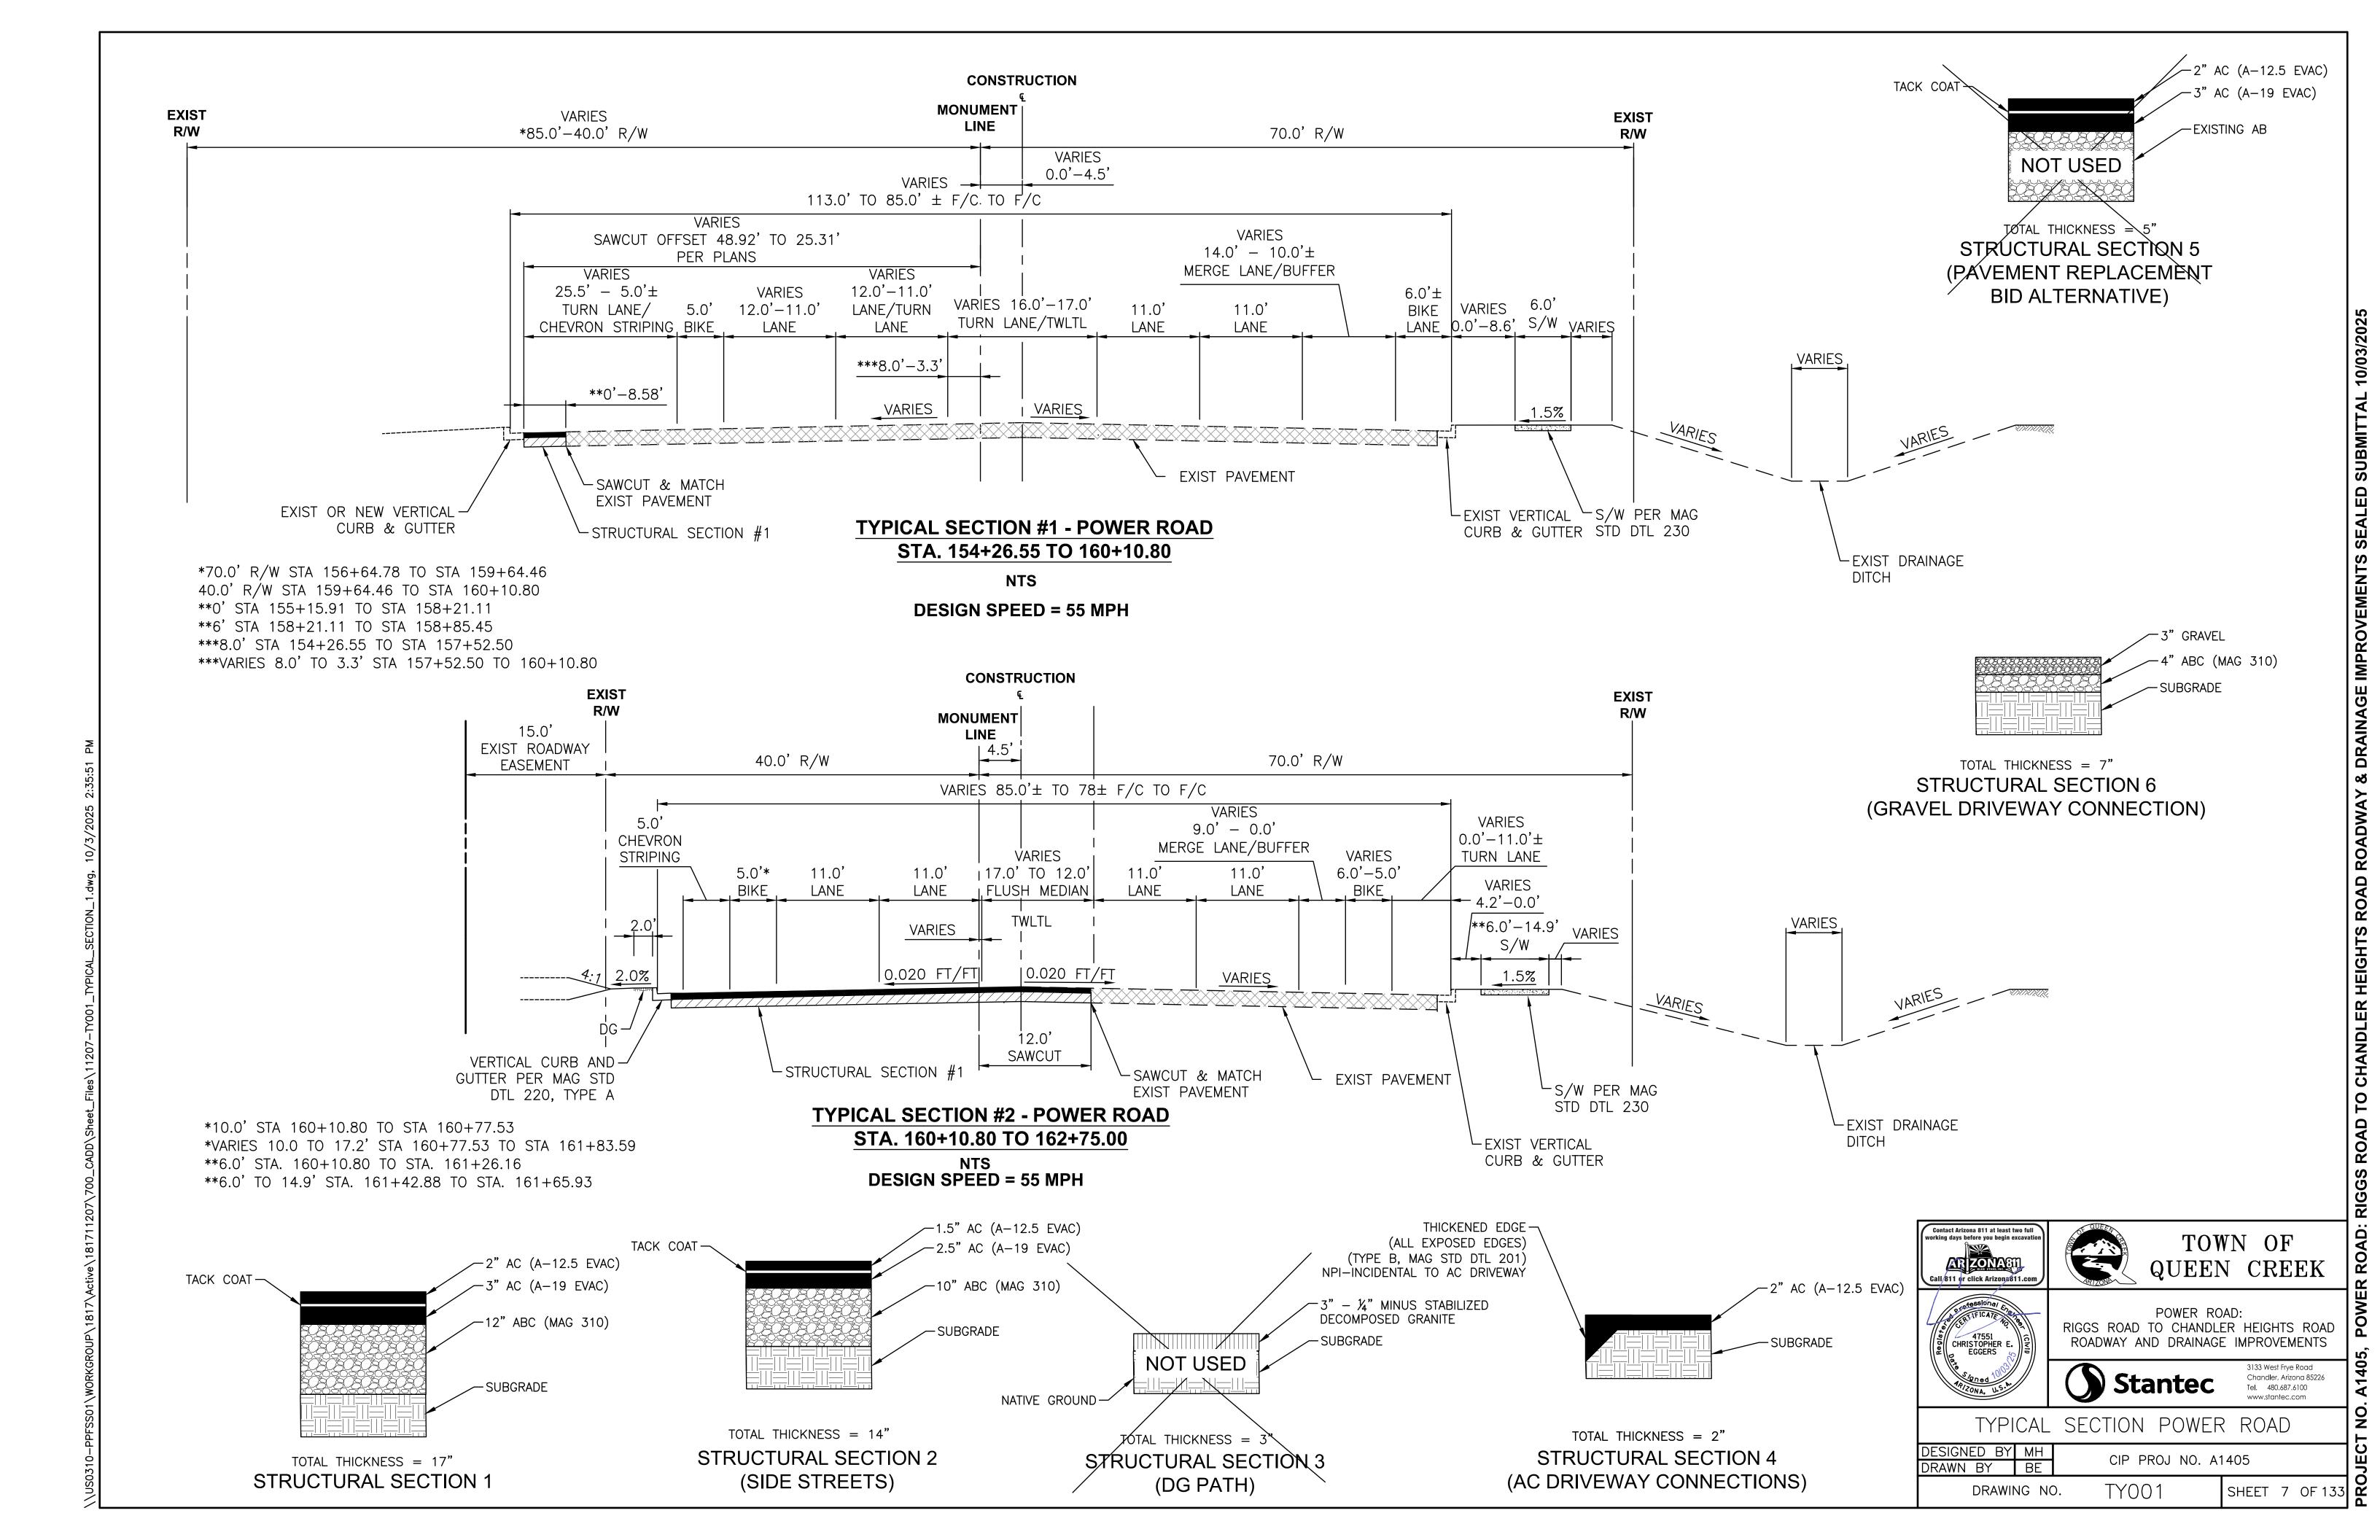
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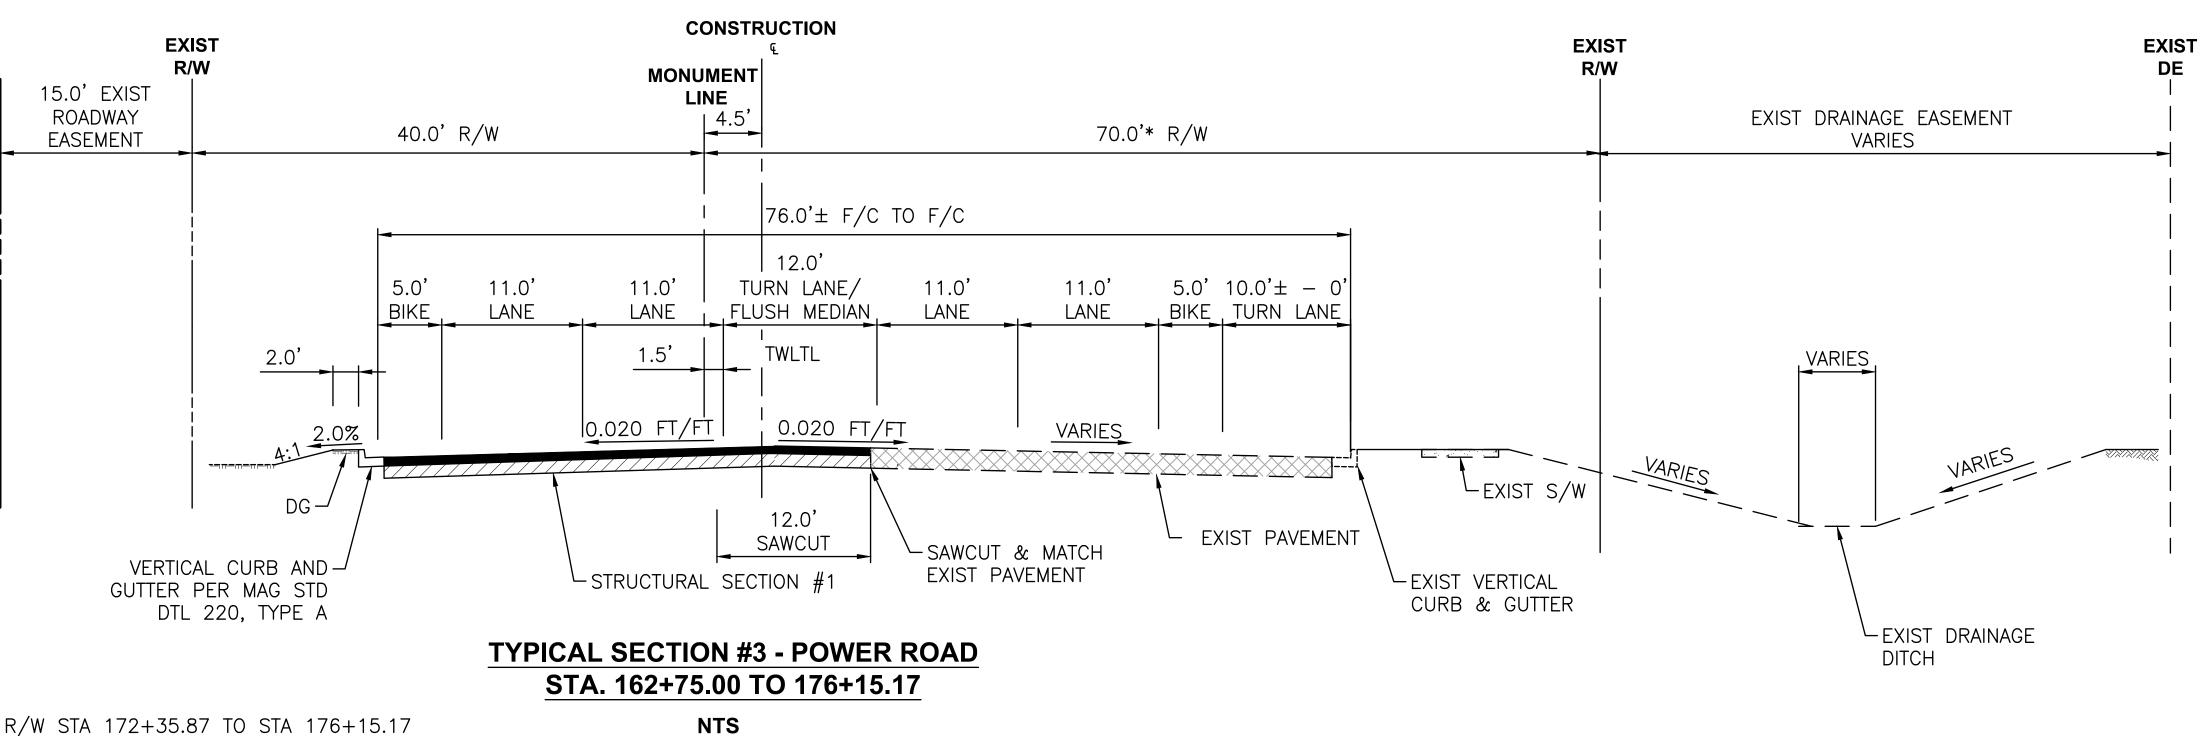
SHEET 5 OF 133 **△**

Chandler, Arizona 85226

Tel. 480.687.6100







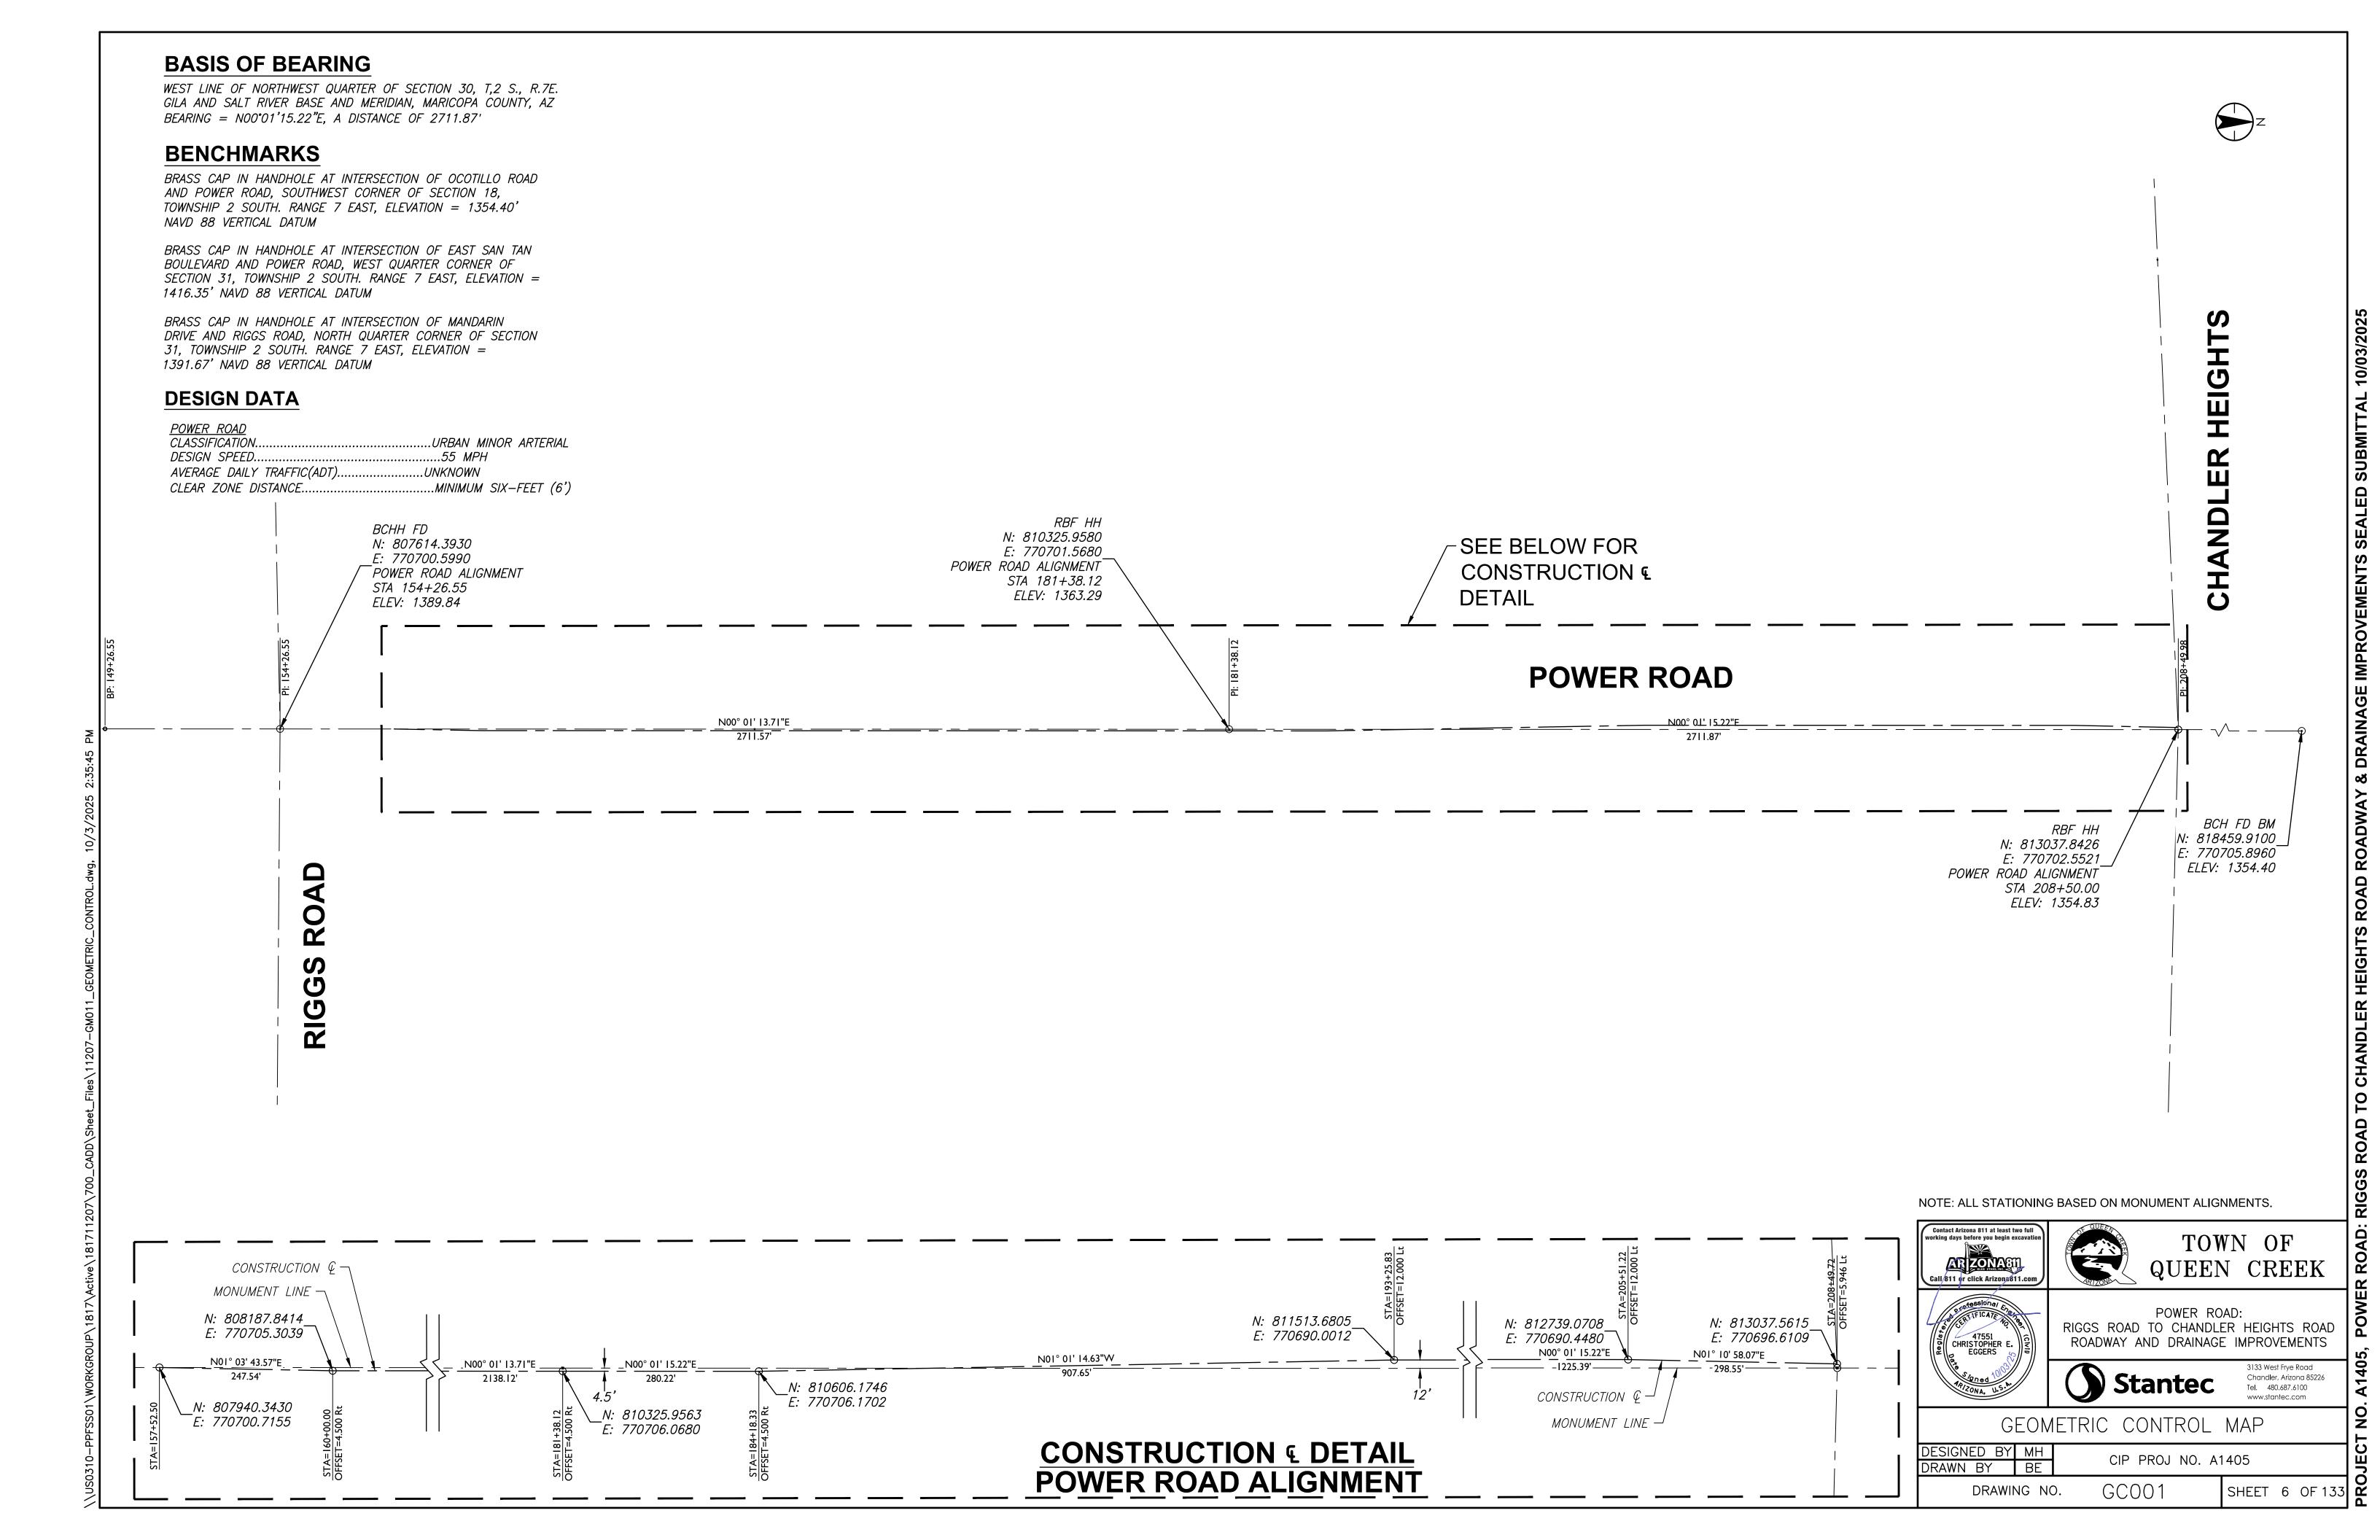

*58.0' R/W STA 172+35.87 TO STA 176+15.17

DESIGN SPEED = 55 MPH

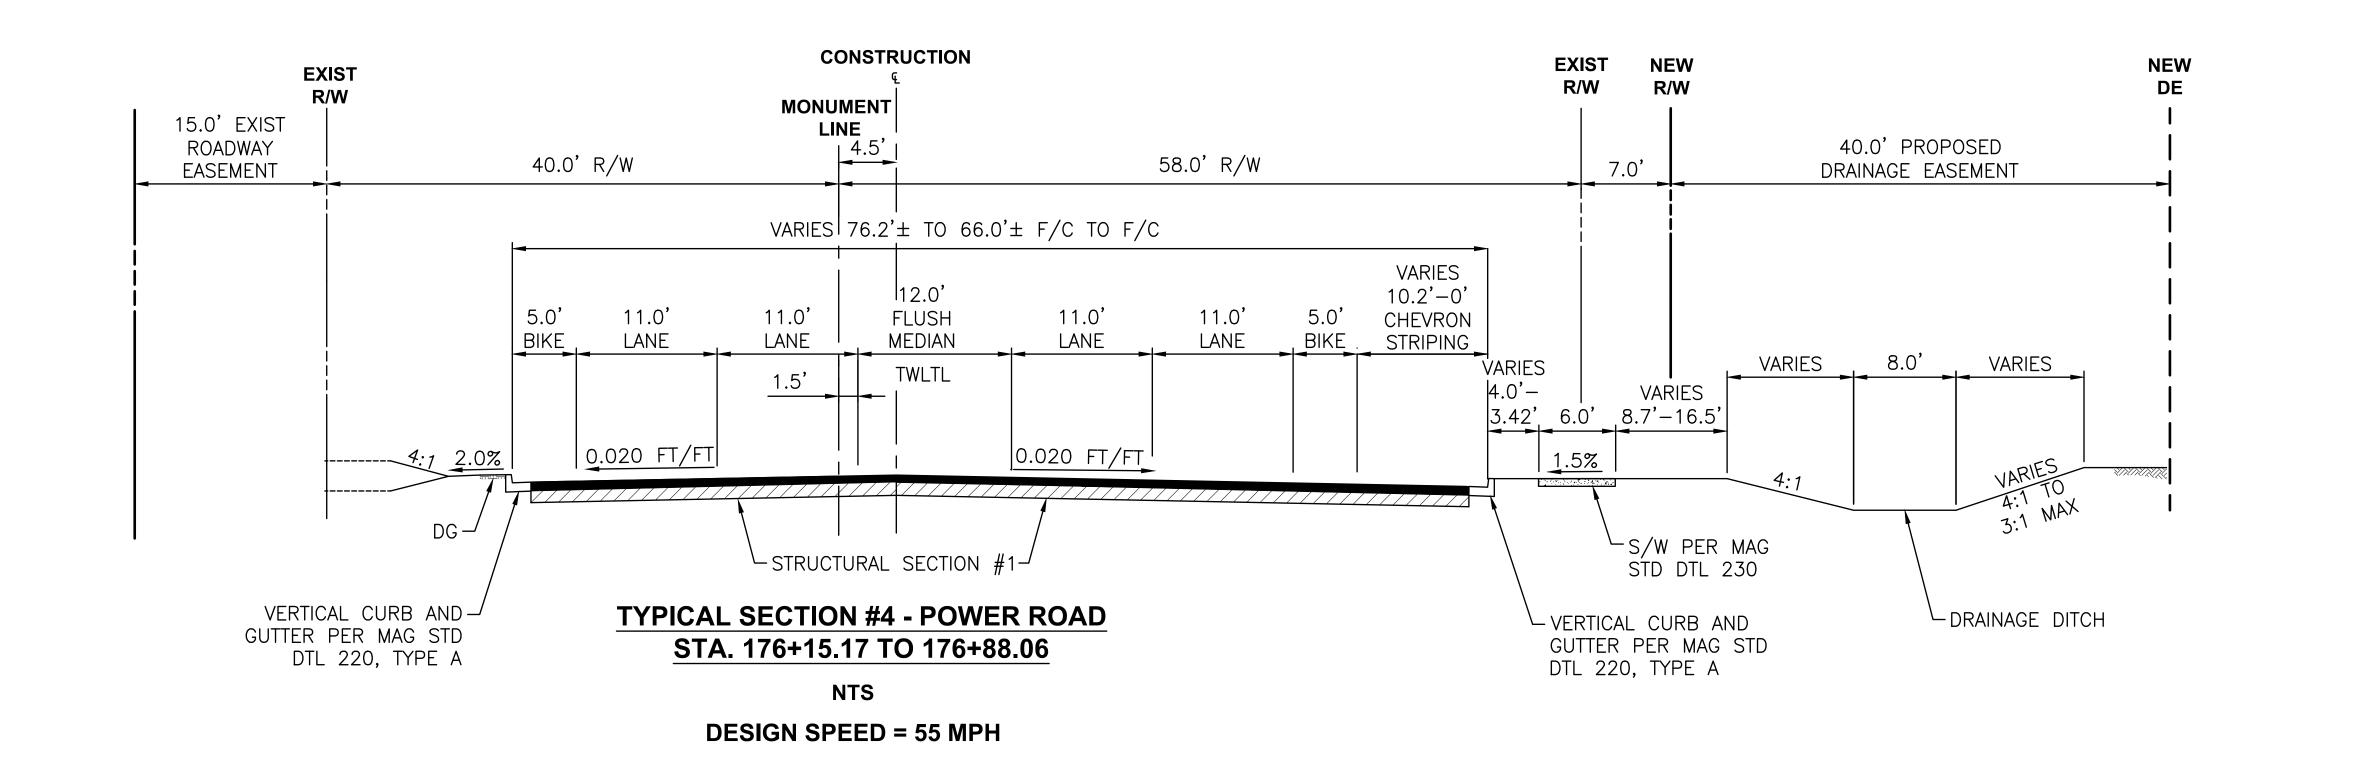

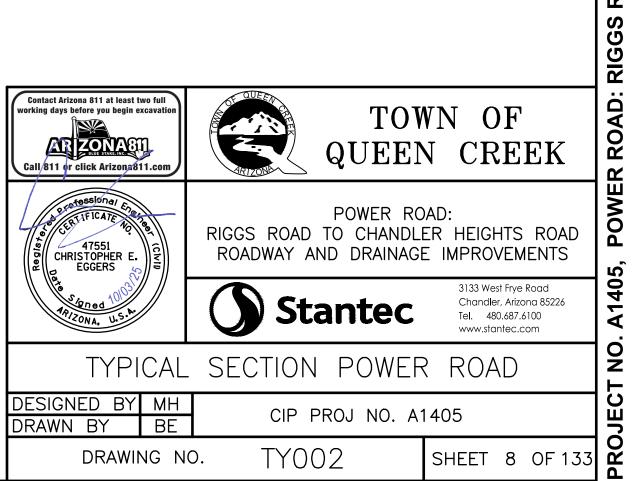

TY002

DRAWING NO.

Call/811 or click Arizona811.c


DESIGNED BY MH


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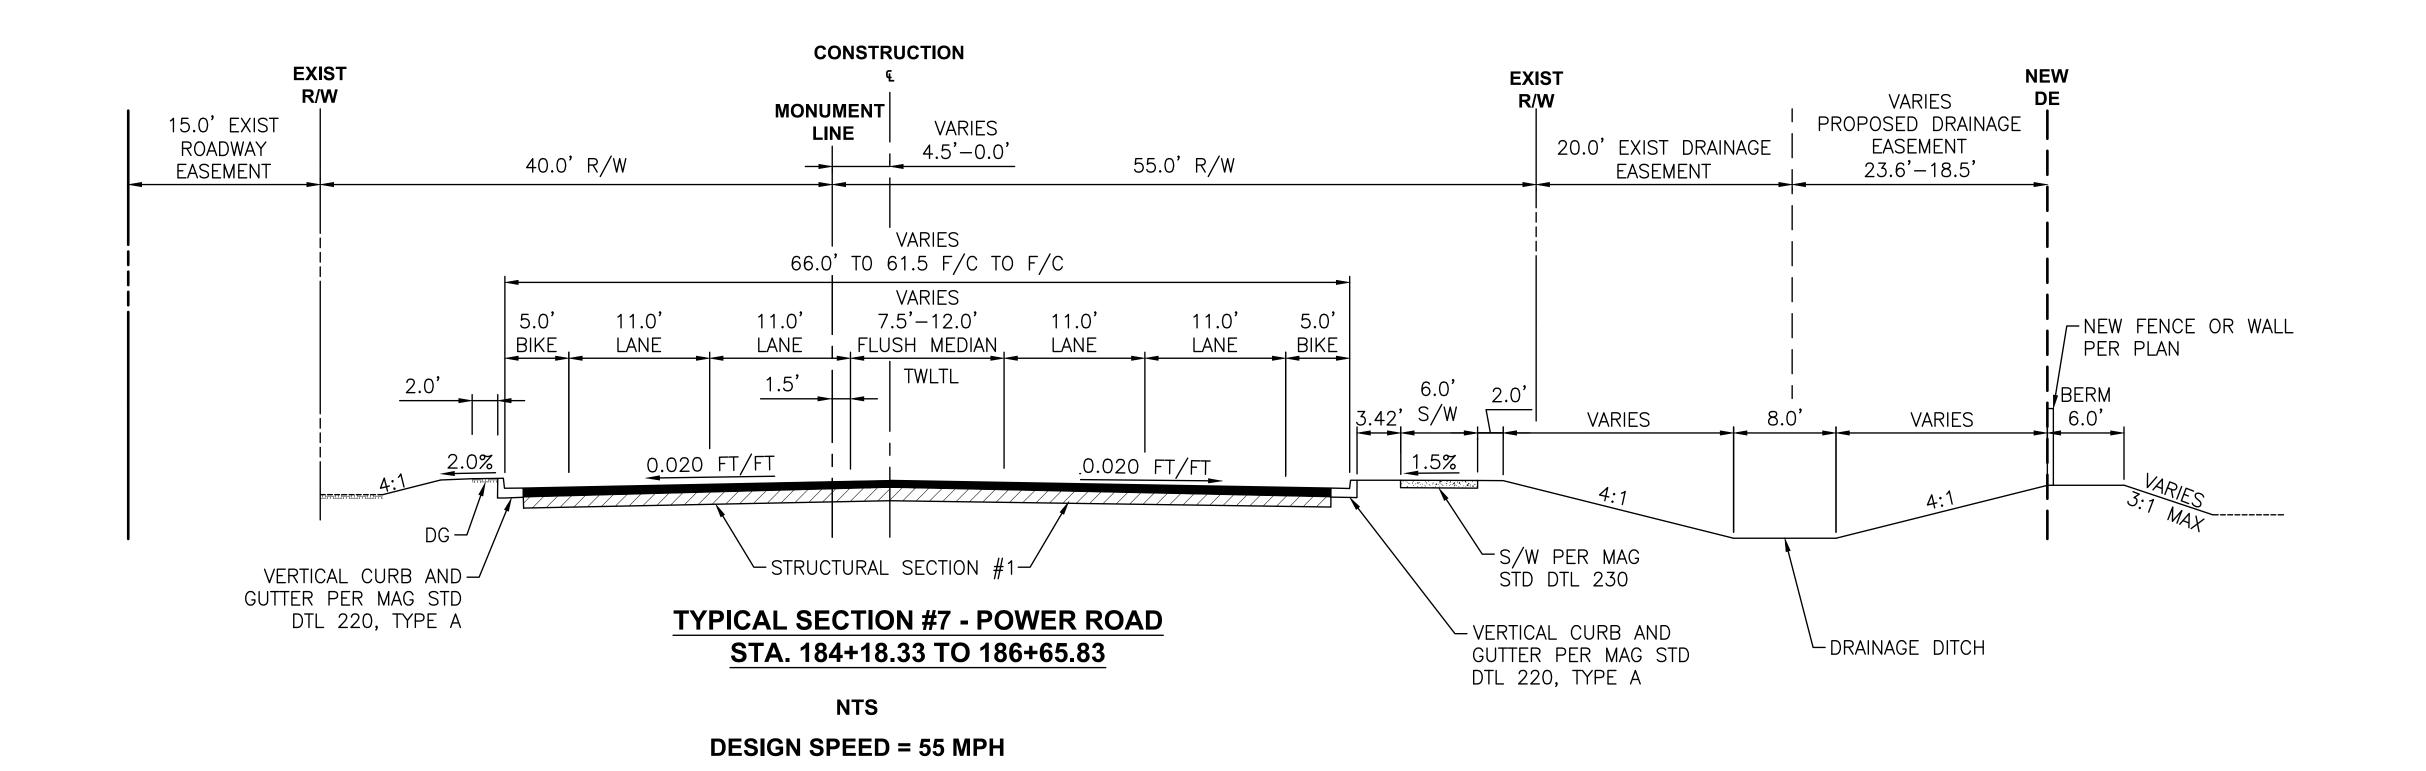
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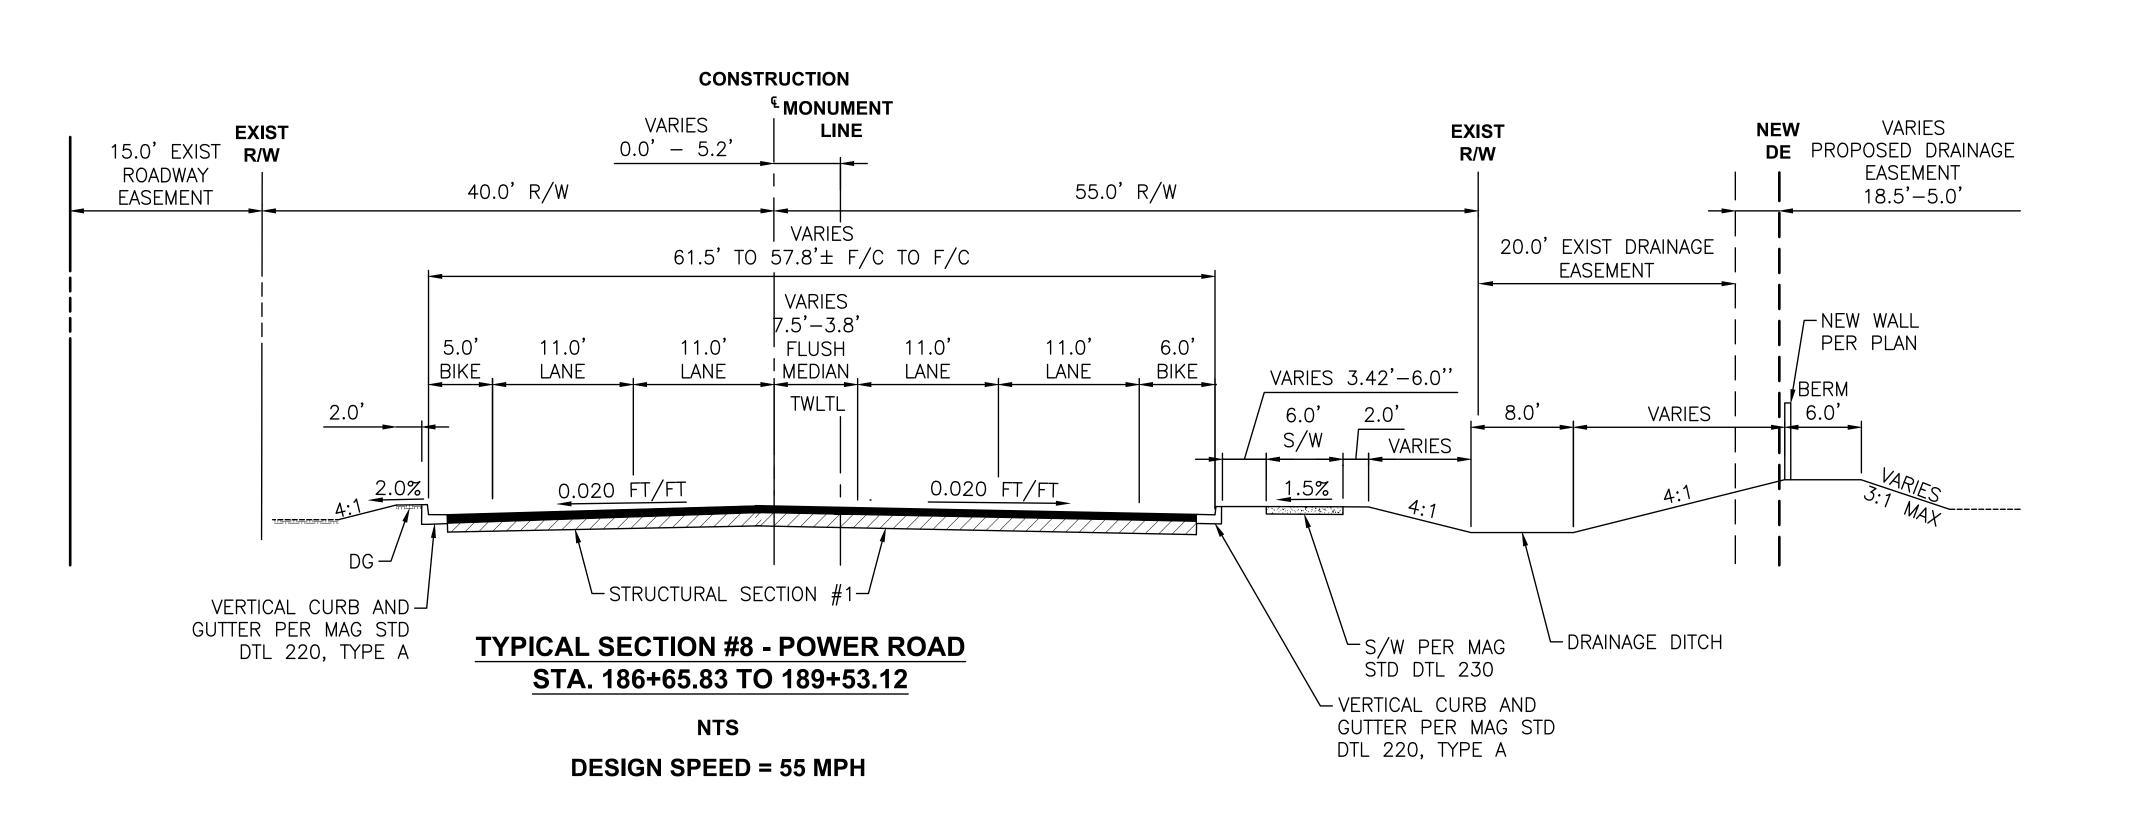
Stantec


TY003





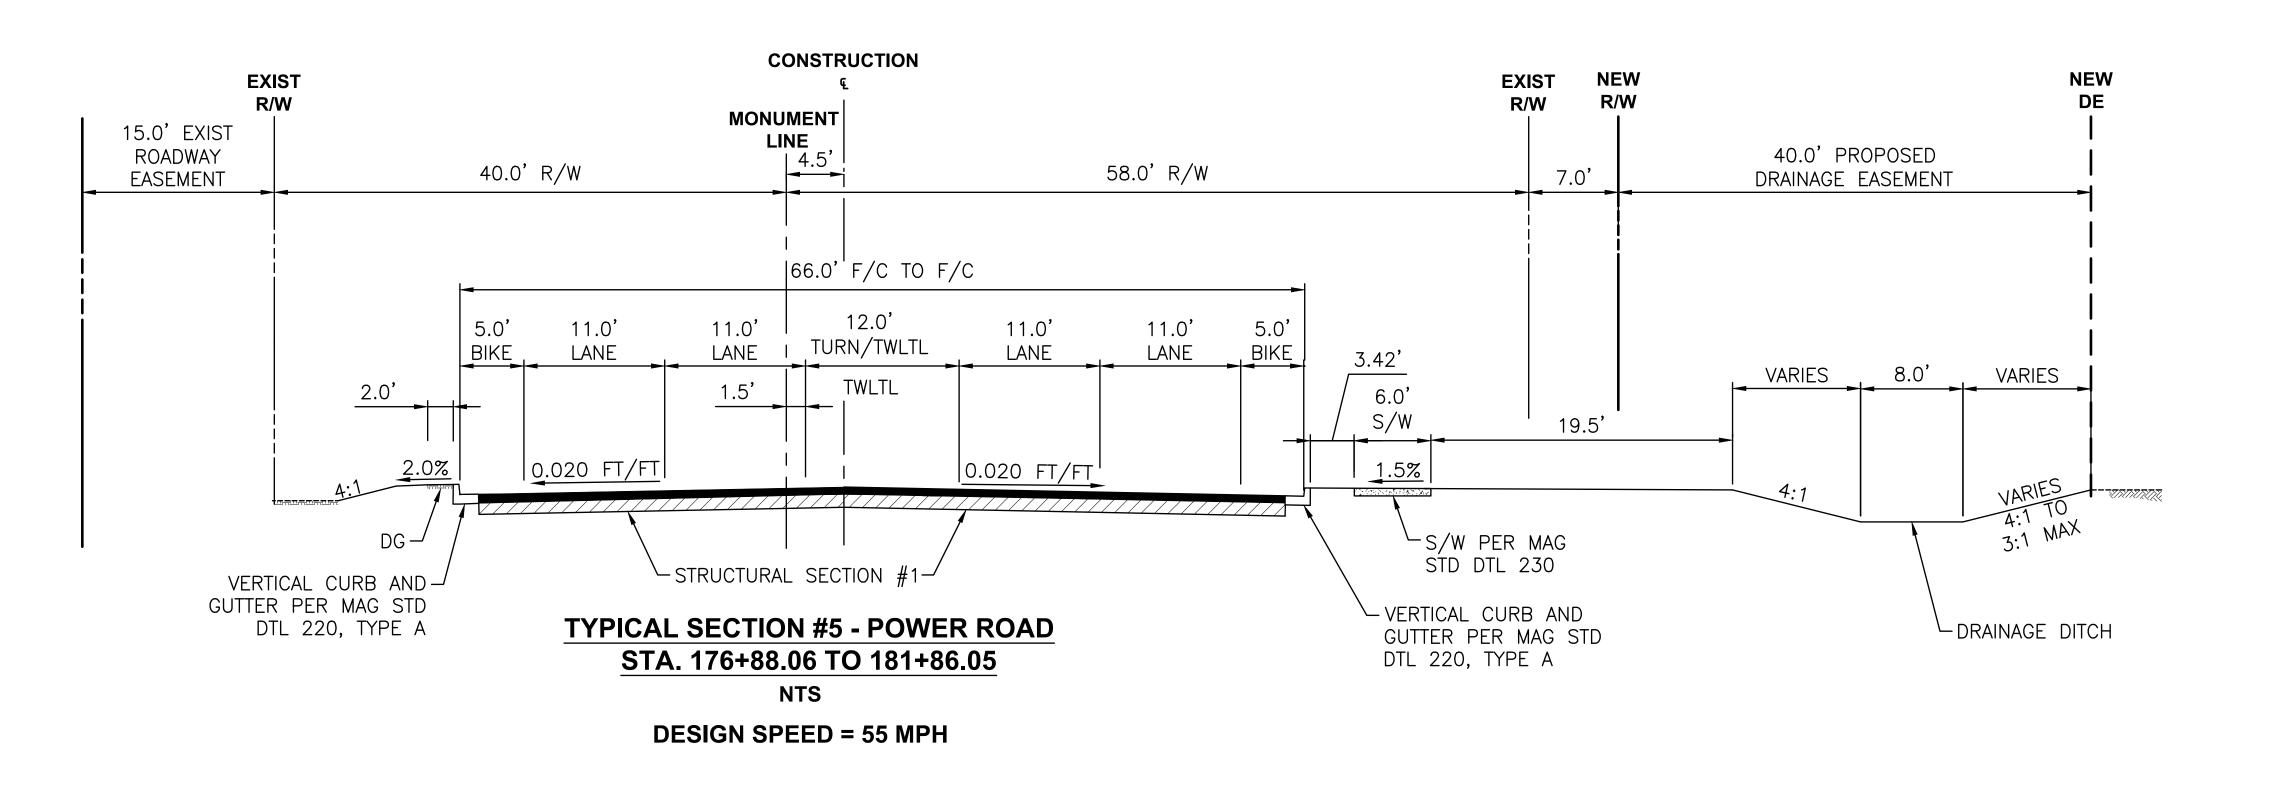

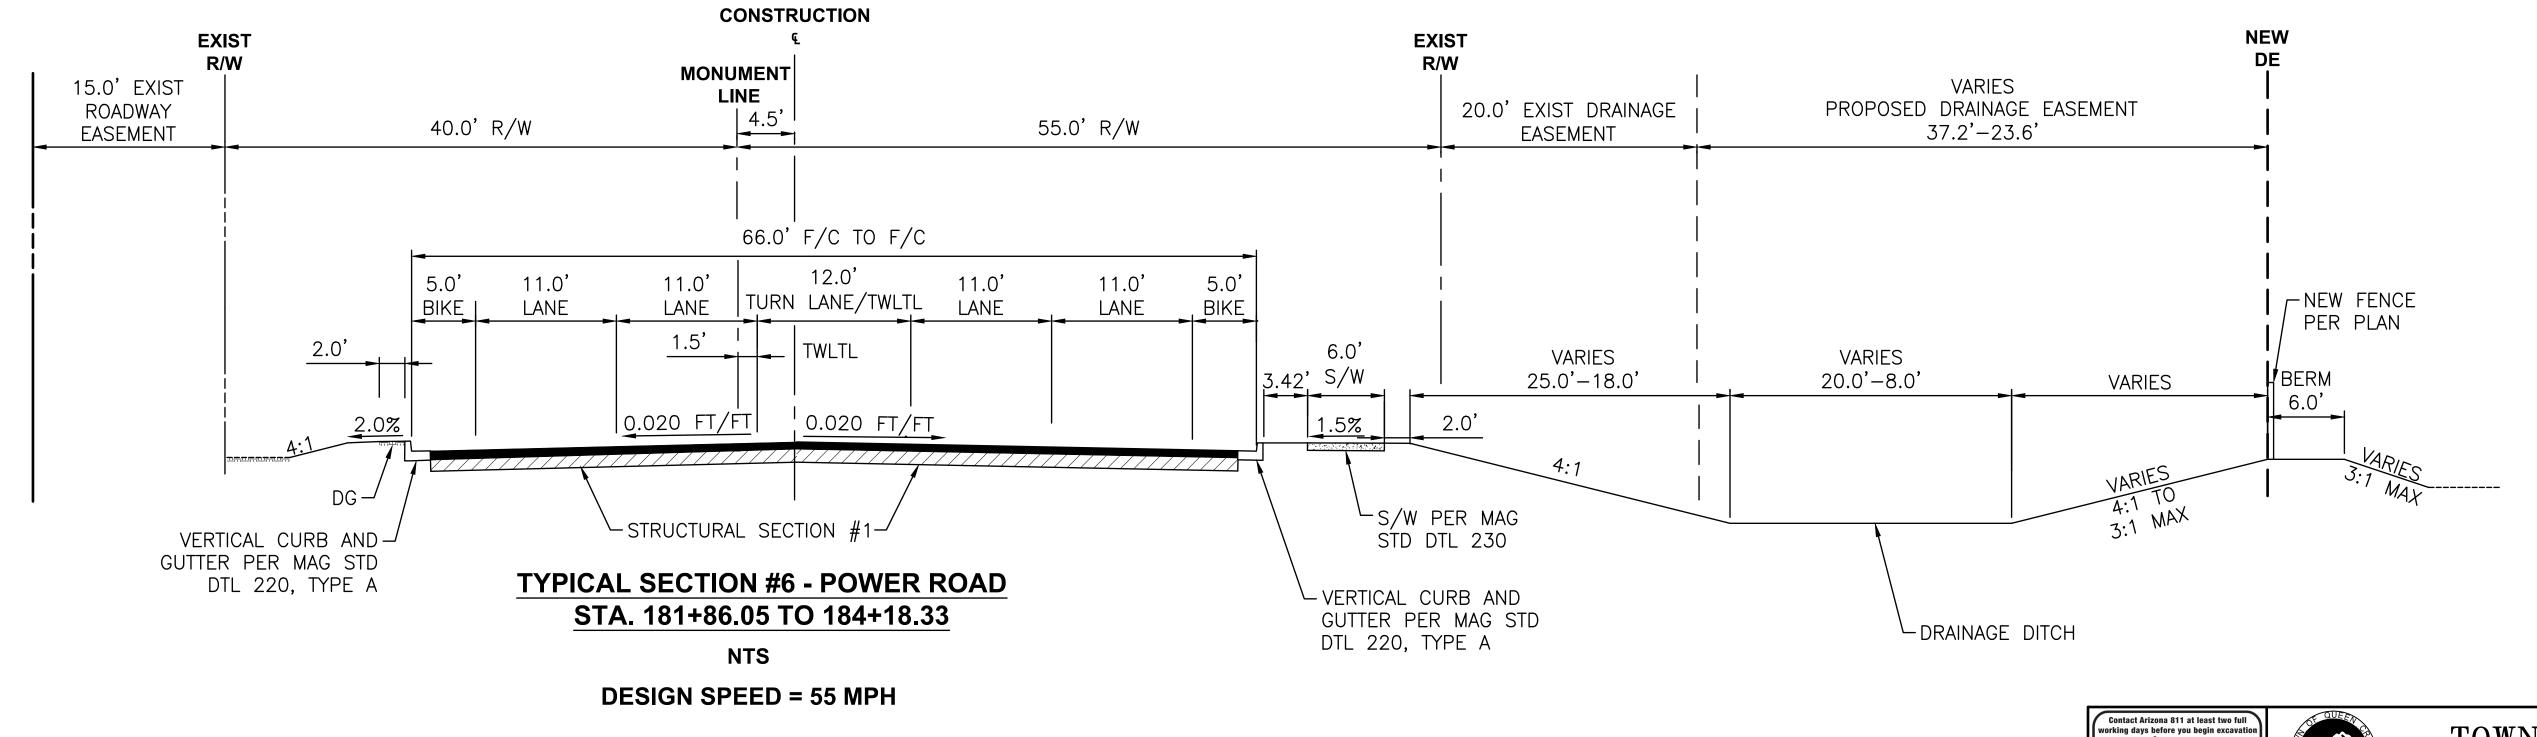

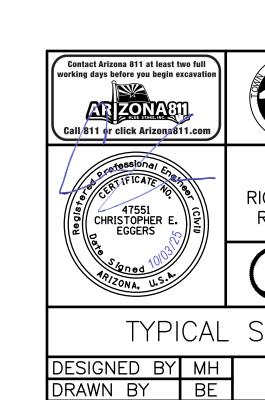

QUEEN CREEK

POWER ROAD: RIGGS ROAD TO CHANDLER HEIGHTS ROAD ROADWAY AND DRAINAGE IMPROVEMENTS


TOWN OF


Stantec

TYPICAL SECTION POWER ROAD

CIP PROJ NO. A1405


TY004 DRAWING NO.

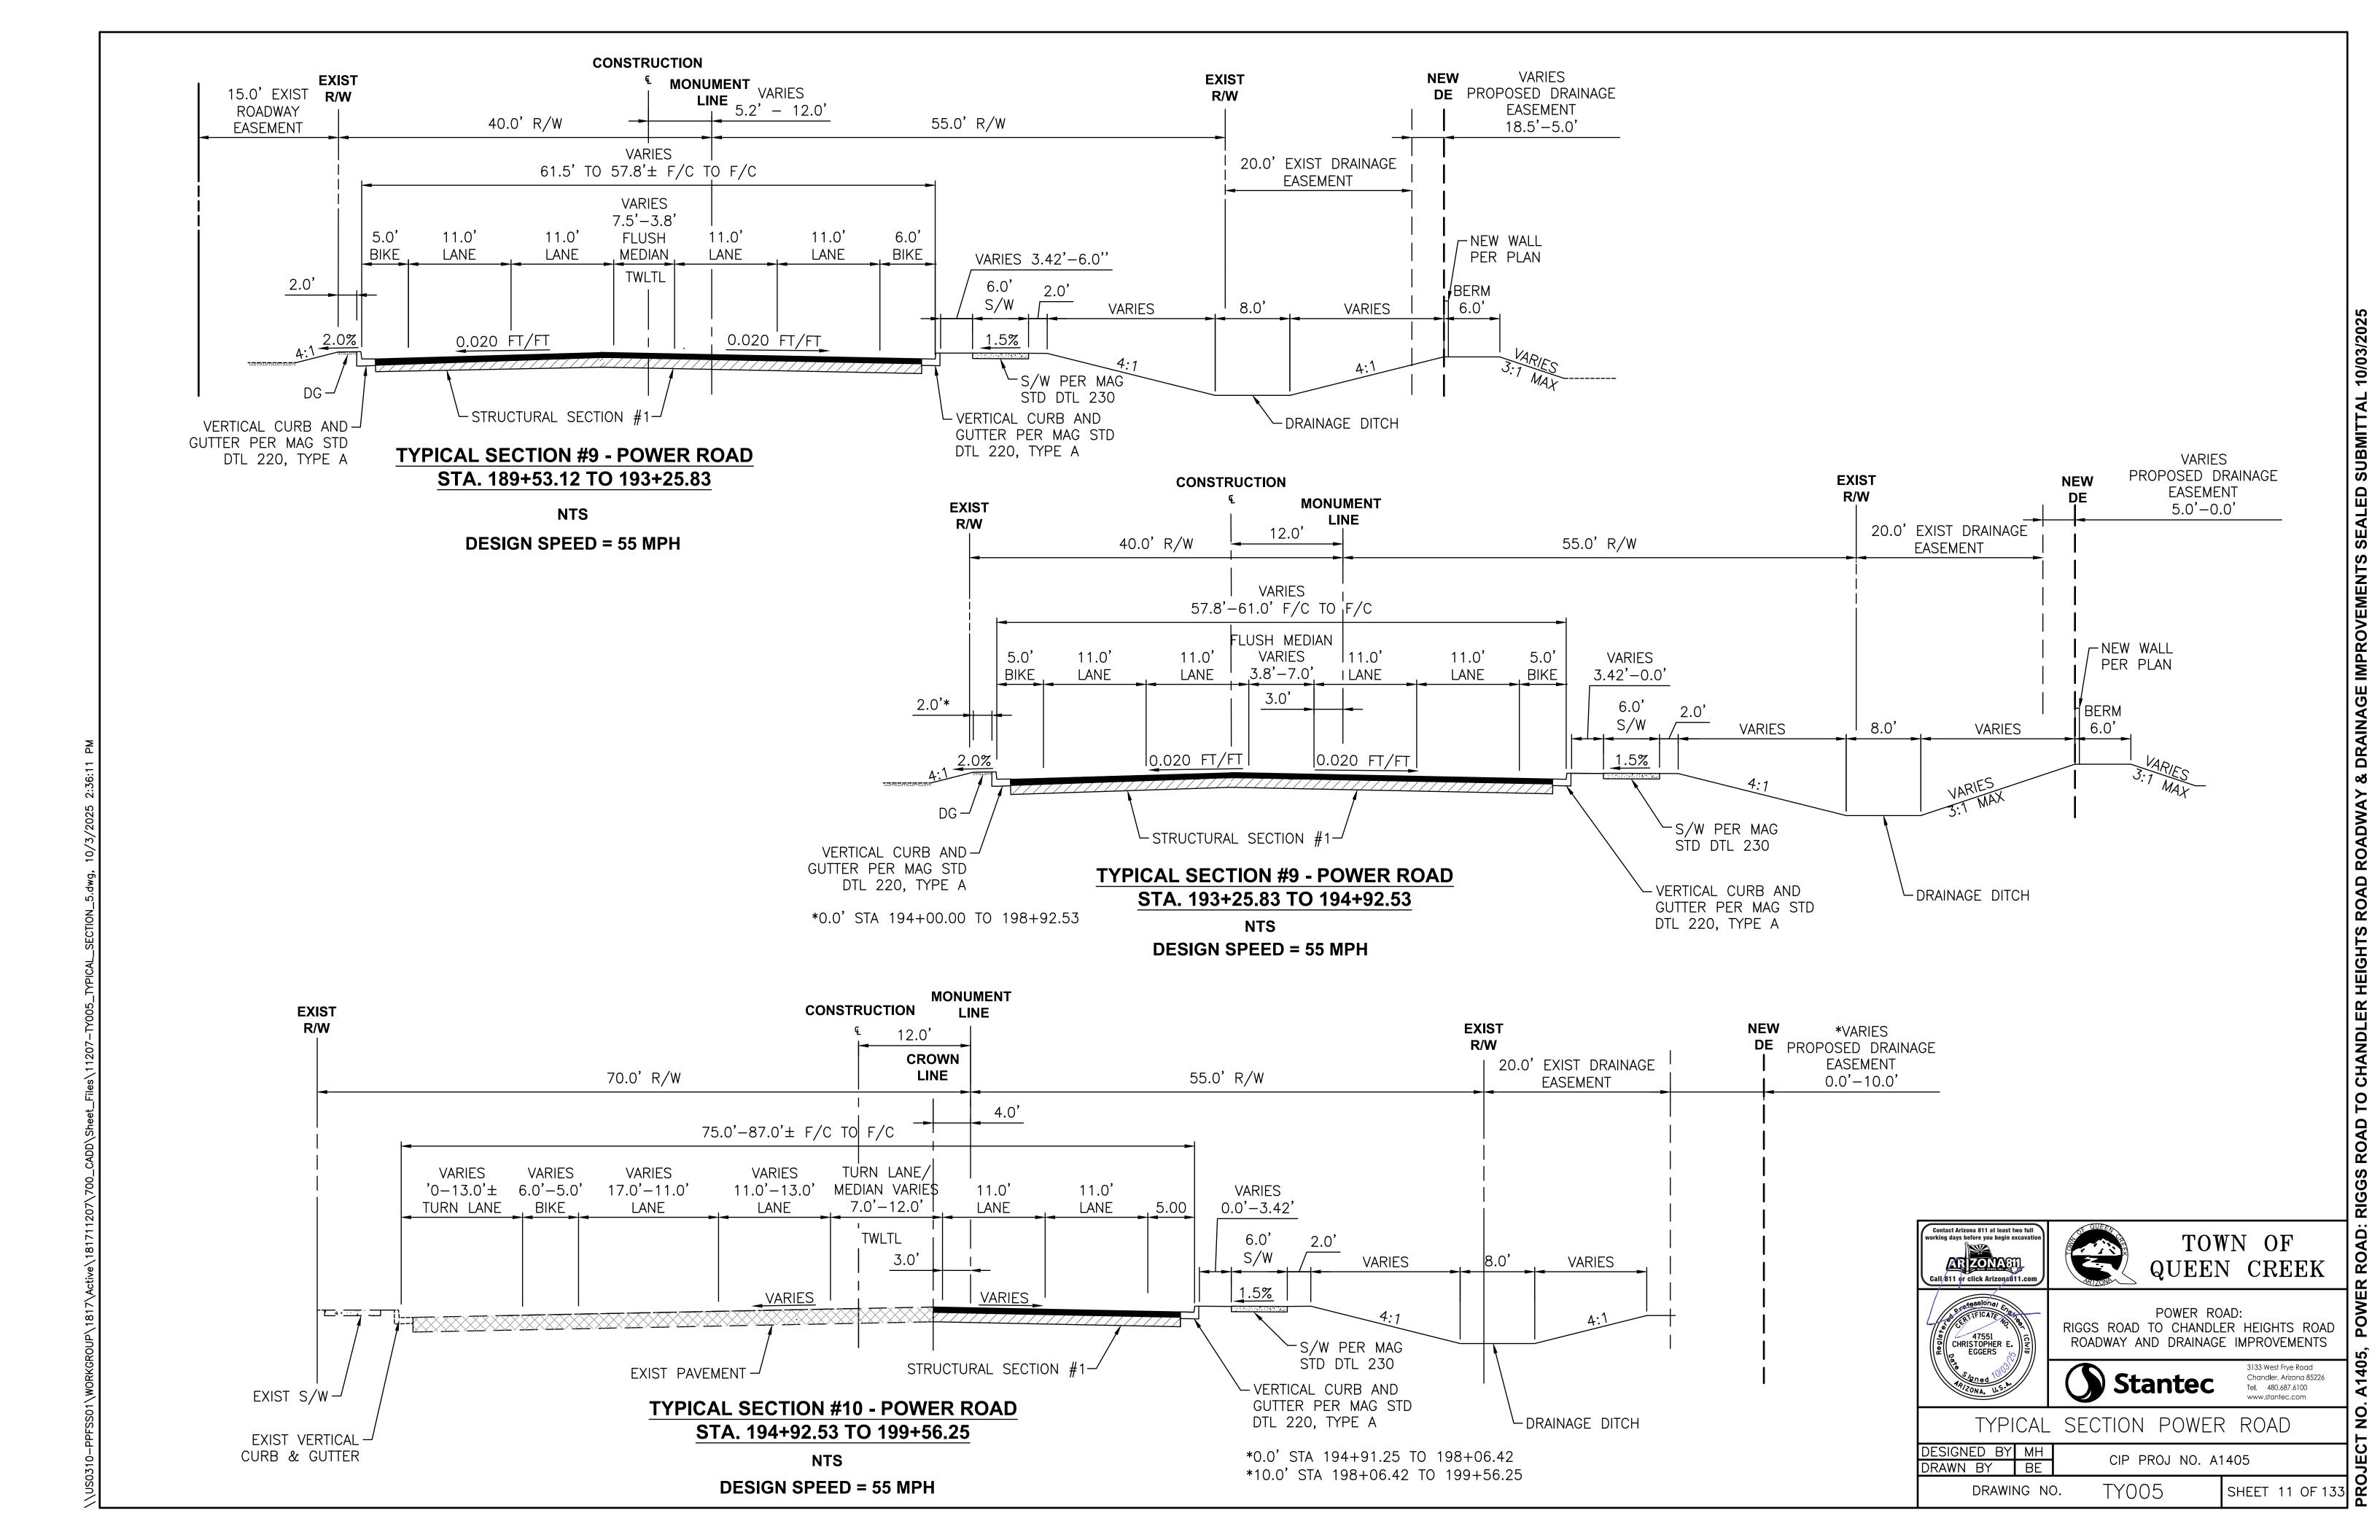

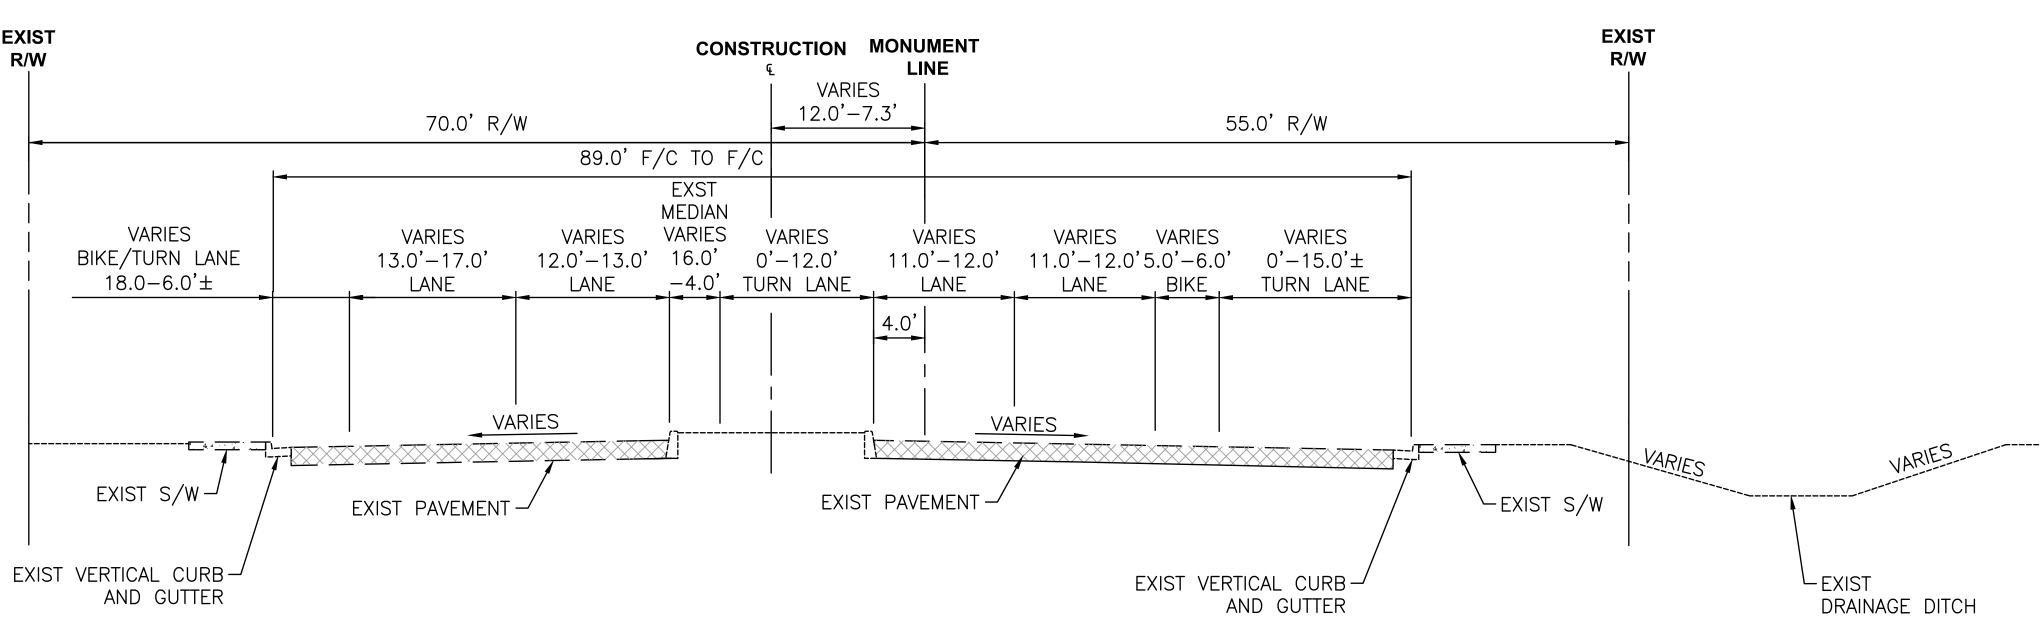

TYPICAL SECTION #12 - POWER ROAD STA. 204+13.06 TO 205+80.12

DESIGN SPEED = 55 MPH

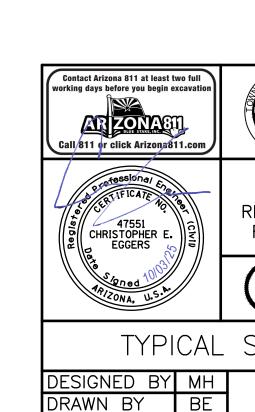

POWER ROAD:
RIGGS ROAD TO CHANDLER HEIGHTS ROAD
ROADWAY AND DRAINAGE IMPROVEMENTS

TOWN OF

ROADWAY & DRAINAGE IMPROVEMENTS SEALED SUBMITTAL 10/03/2025

ROADWAY AND DRAINAGE IMPROVEMENTS

3133 West Frye Road
Chandler, Arizona 85226
Tel. 480.687.6100


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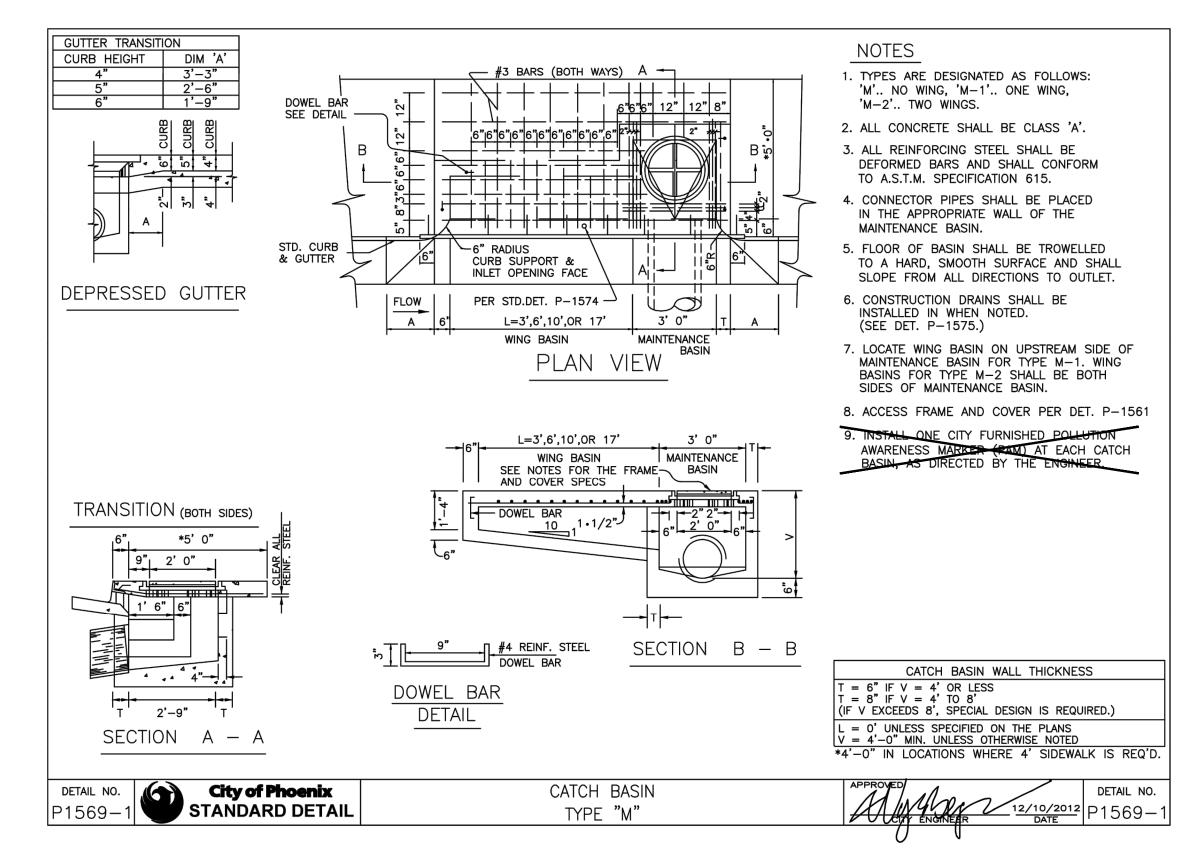
SIGNED BY MH
CIP PROJ NO. A1405


DRAWING NO. TYOO6 SHEET 12 OF 133

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10/03/2025





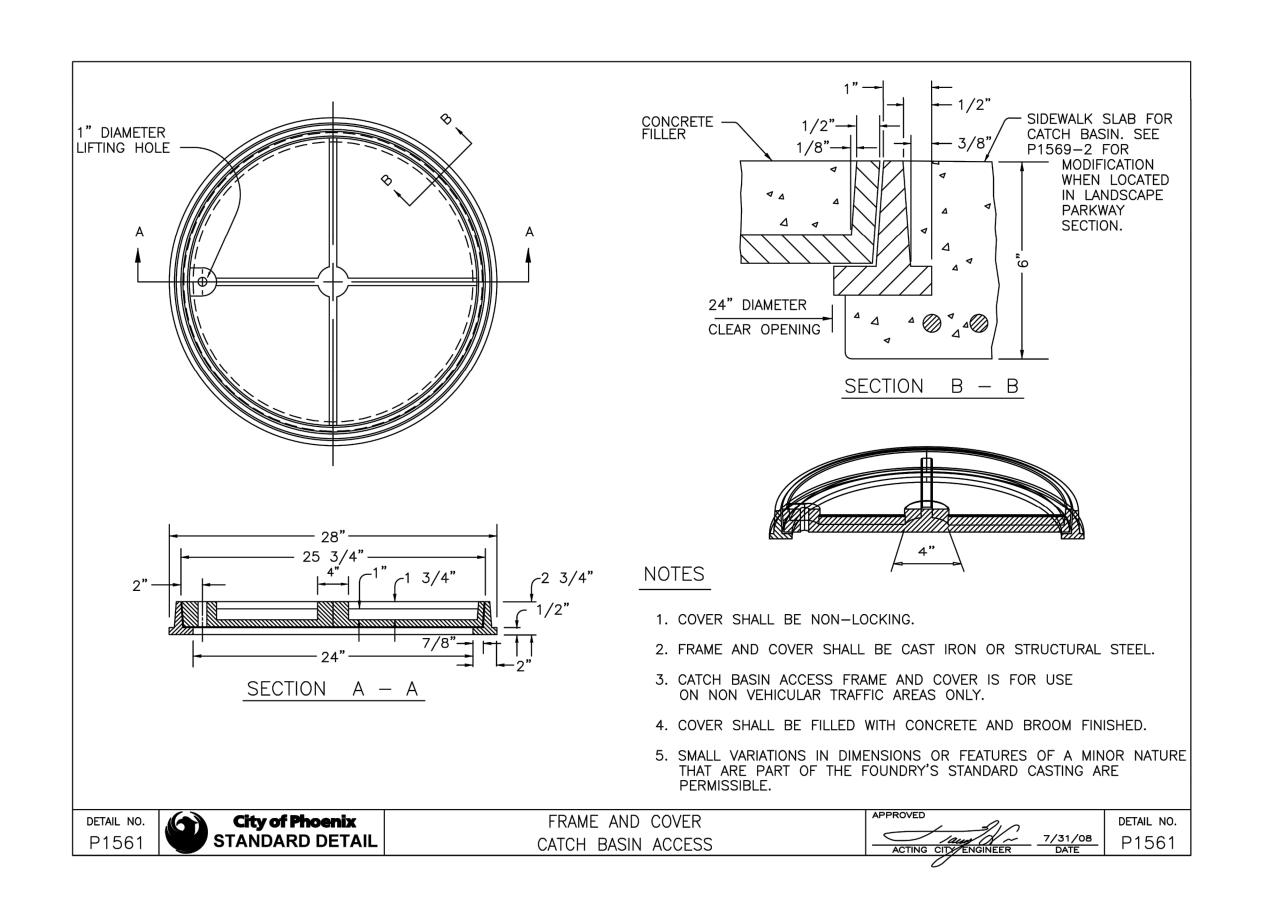


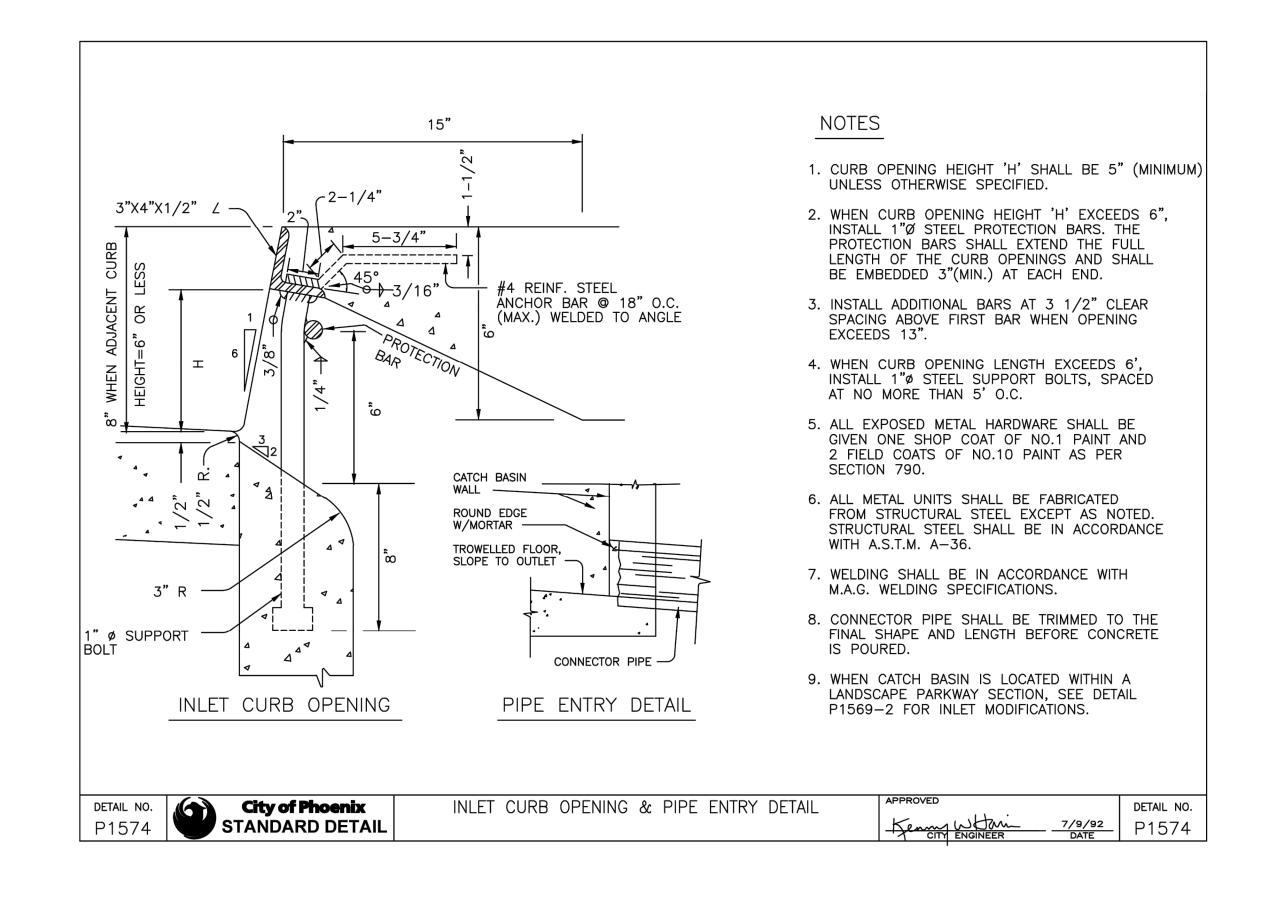



DRAWING NO.

TOWN OF QUEEN CREEK

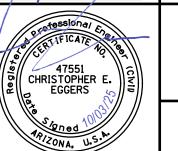

Contact Arizona 811 at least two full

orking days before you begin exc

POWER ROAD: RIGGS ROAD TO CHANDLER HEIGHTS ROAD ROADWAY AND DRAINAGE IMPROVEMENTS

Stantec


ROADWAY DETAILS


DESIGNED BY MH CIP PROJ NO. A1405 DRAWN BY

DT001

SHEET 13 OF 133

Chandler, Arizona 85226 Tel. 480.687.6100

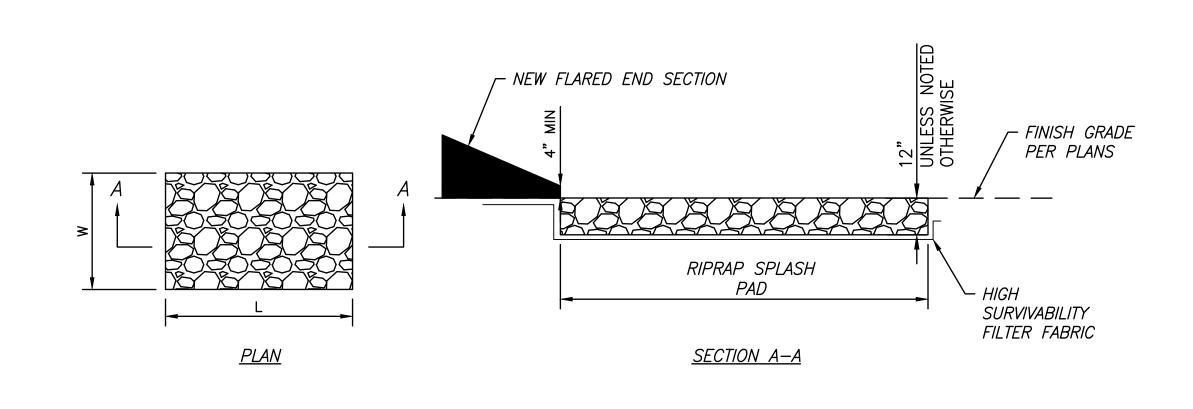

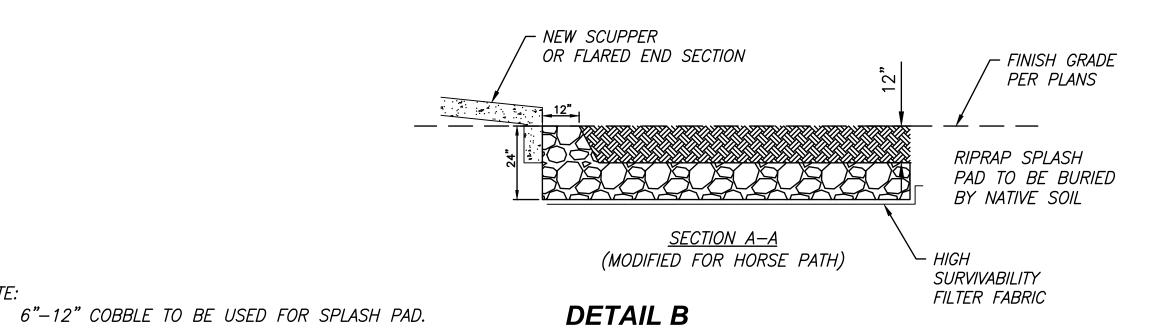


-1/2" MINUS LANDSCAPE ROCK TYPE, COLOR: 'SUPERIOR GOLD' SOURCE: KALAMAZOO MATERIALS INC. - GRADING PLAN FINISH GRADE - PRE-EMERGENT. SEE SPECIAL PROVISIONS - SOIL SUBGRADE—ROLL UNIFORM AND LEVEL

> LANDSCAPE GRAVEL MULCH (DECOMPOSED GRANITE)

> > **DETAIL C**


- GENERAL NOTES: 1. A PRE-EMERGENT SHALL BE APPLIED TO FINISH GRADE BEFORE AND AFTER INSTALLATION OF LANDSCAPE ROCK (DECOMPOSED GRANITE) — SEE SPECIFICATIONS
- 2. ALL LANDSCAPE ROCK TYPE SHALL BE PLACED ON PREPARED EXPOSED SOIL GRADES WHERE SHOWN ON THE
- 3. ALL SOIL GRADES SHALL BE UNIFORM IN APPEARANCE PRIOR TO ROCK INSTALLATION. REWORK SOIL GRADES AND COMPACT AS NEEDED TO ENSURE UNIFORMITY AND EVEN CONSISTENCY, NO RUTTING, DEPRESSIONS, HOLES, MOUNDS, ERODED AREAS, RILLS, ETC. WILL BE ACCEPTED. REPAIR AREAS AS NEEDED TO THE SATISFACTION OF THE LANDSCAPE ARCHITECT OR TOWN REPRESENTATIVE PRIOR TO PRE-EMERGENT AND ROCK INSTALLATION.
- 4. ROLL TO COMPACT AND WATER IN ALL ROCK MINUS MATERIAL AFTER INSTALLATION TO FORM CRUST.

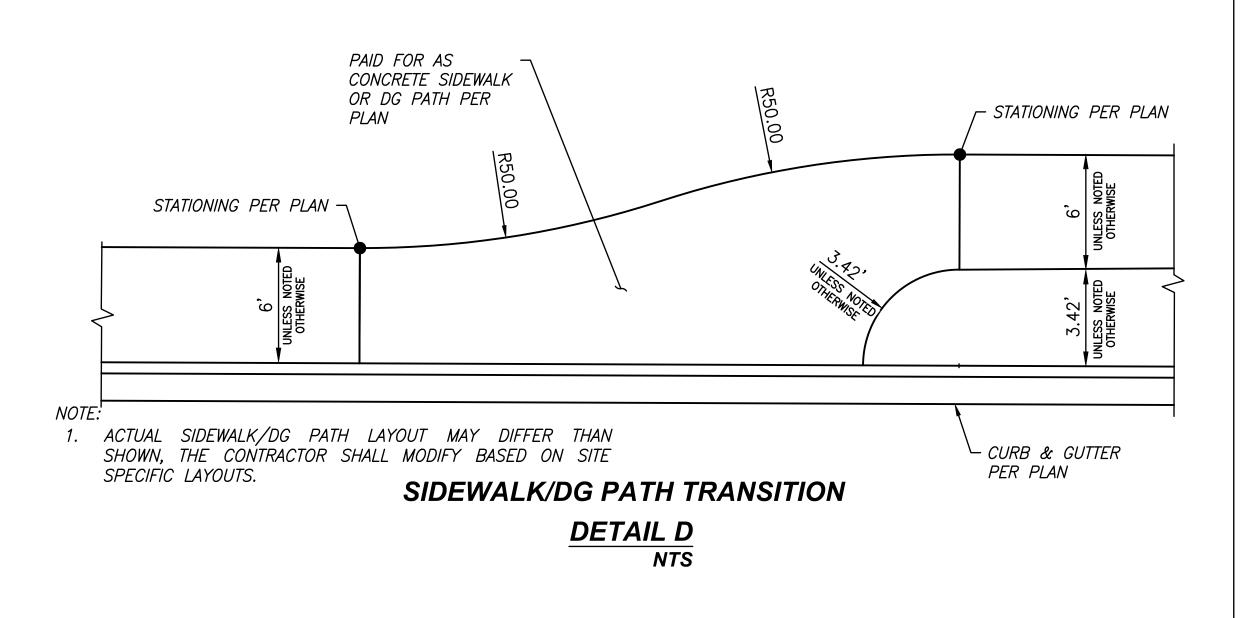

LENGTH (L) AND WIDTH (W) PER PLAN

RIPRAP SPLASH PAD

3. FILTER FABRIC SHALL BÈ INCIDENTAL TO THE COST OF

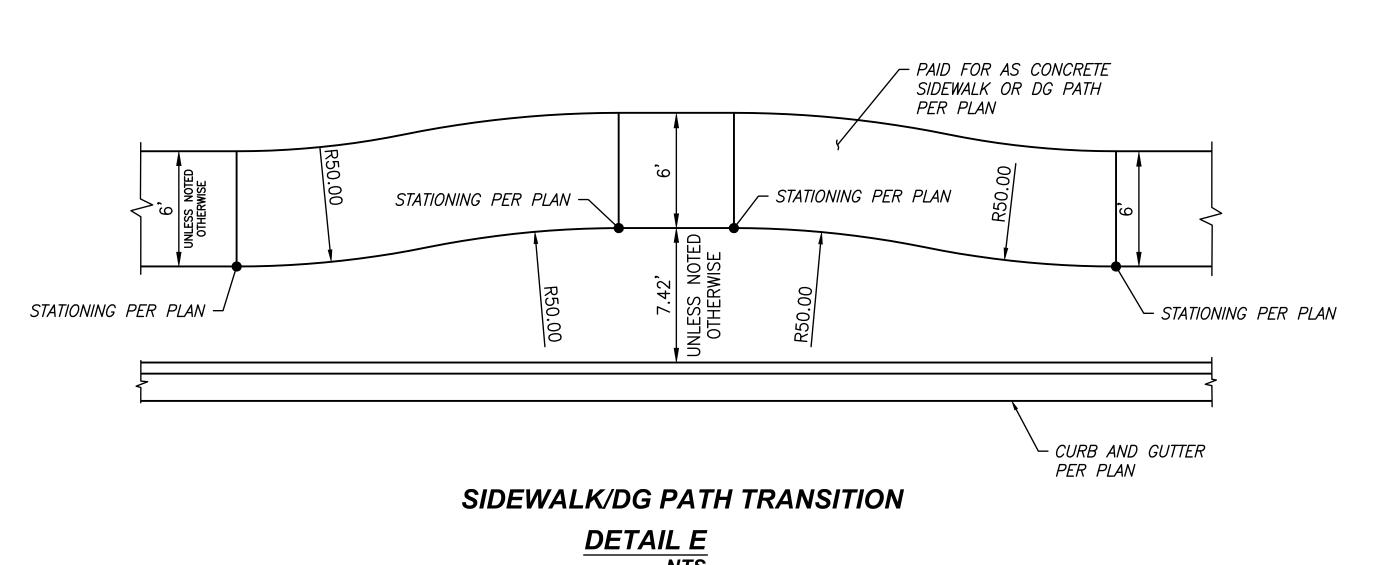





ROADWAY AND DRAINAGE IMPROVEMENTS

Stantec

Chandler, Arizona 85226


Tel. 480.687.6100


ROADWAY DETAILS

DESIGNED BY MH CIP PROJ NO. A1405 DRAWN BY


DRAWING NO.

SHEET 14 OF 133 DT002

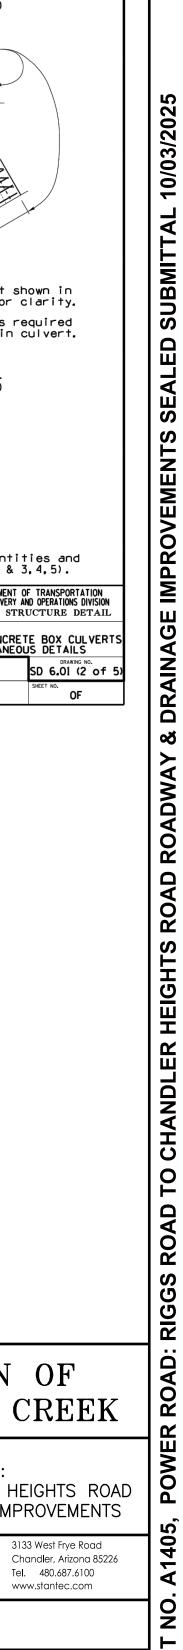

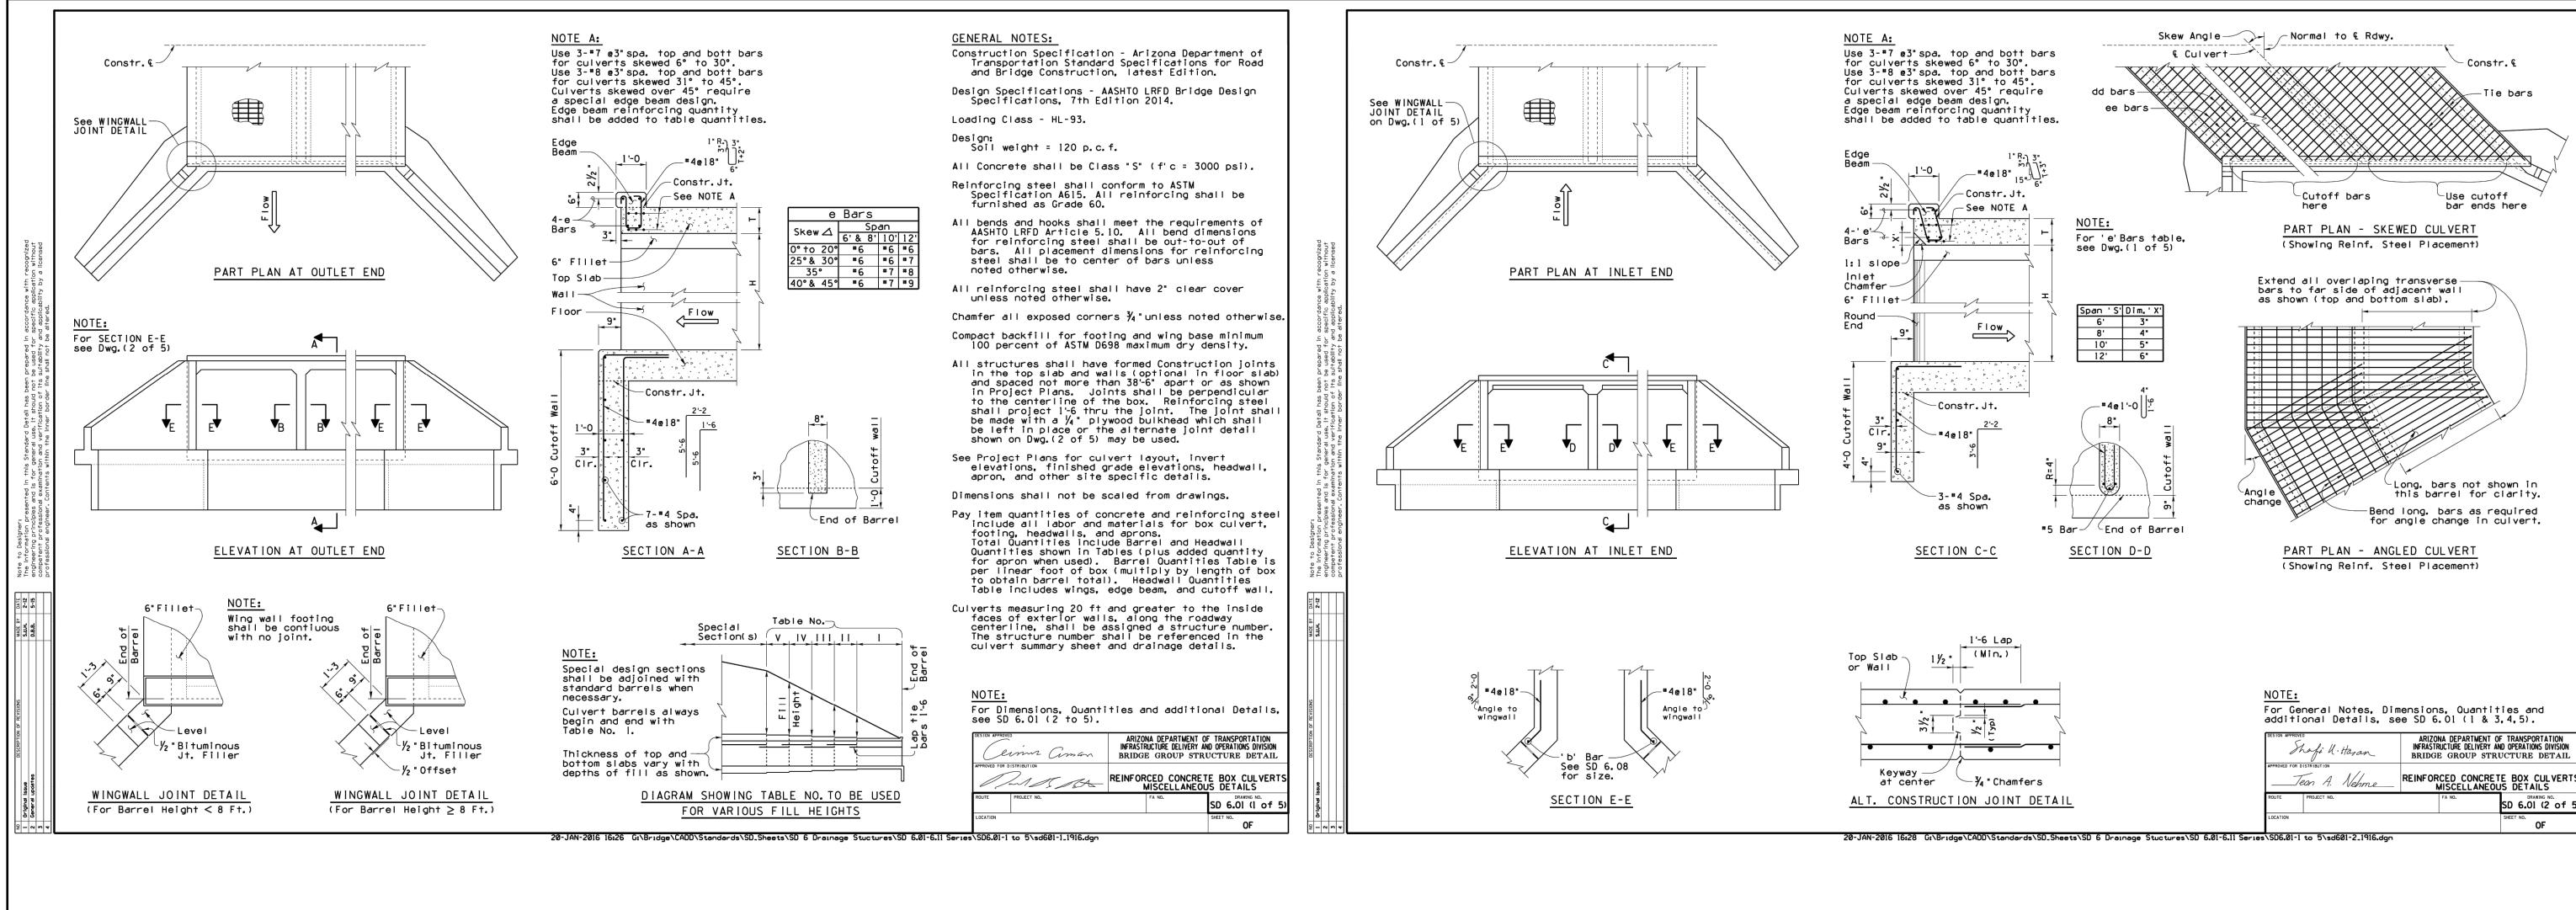




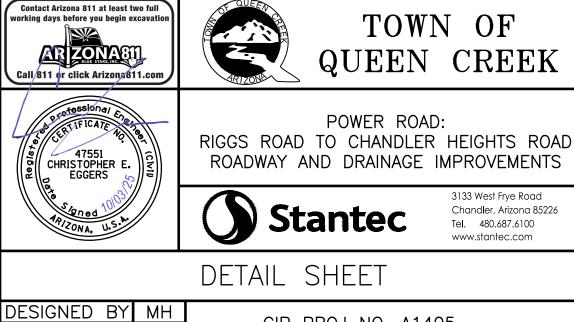

CIP PROJ NO. A1405

DT003 DRAWING NO.

SHEET 15 OF 133

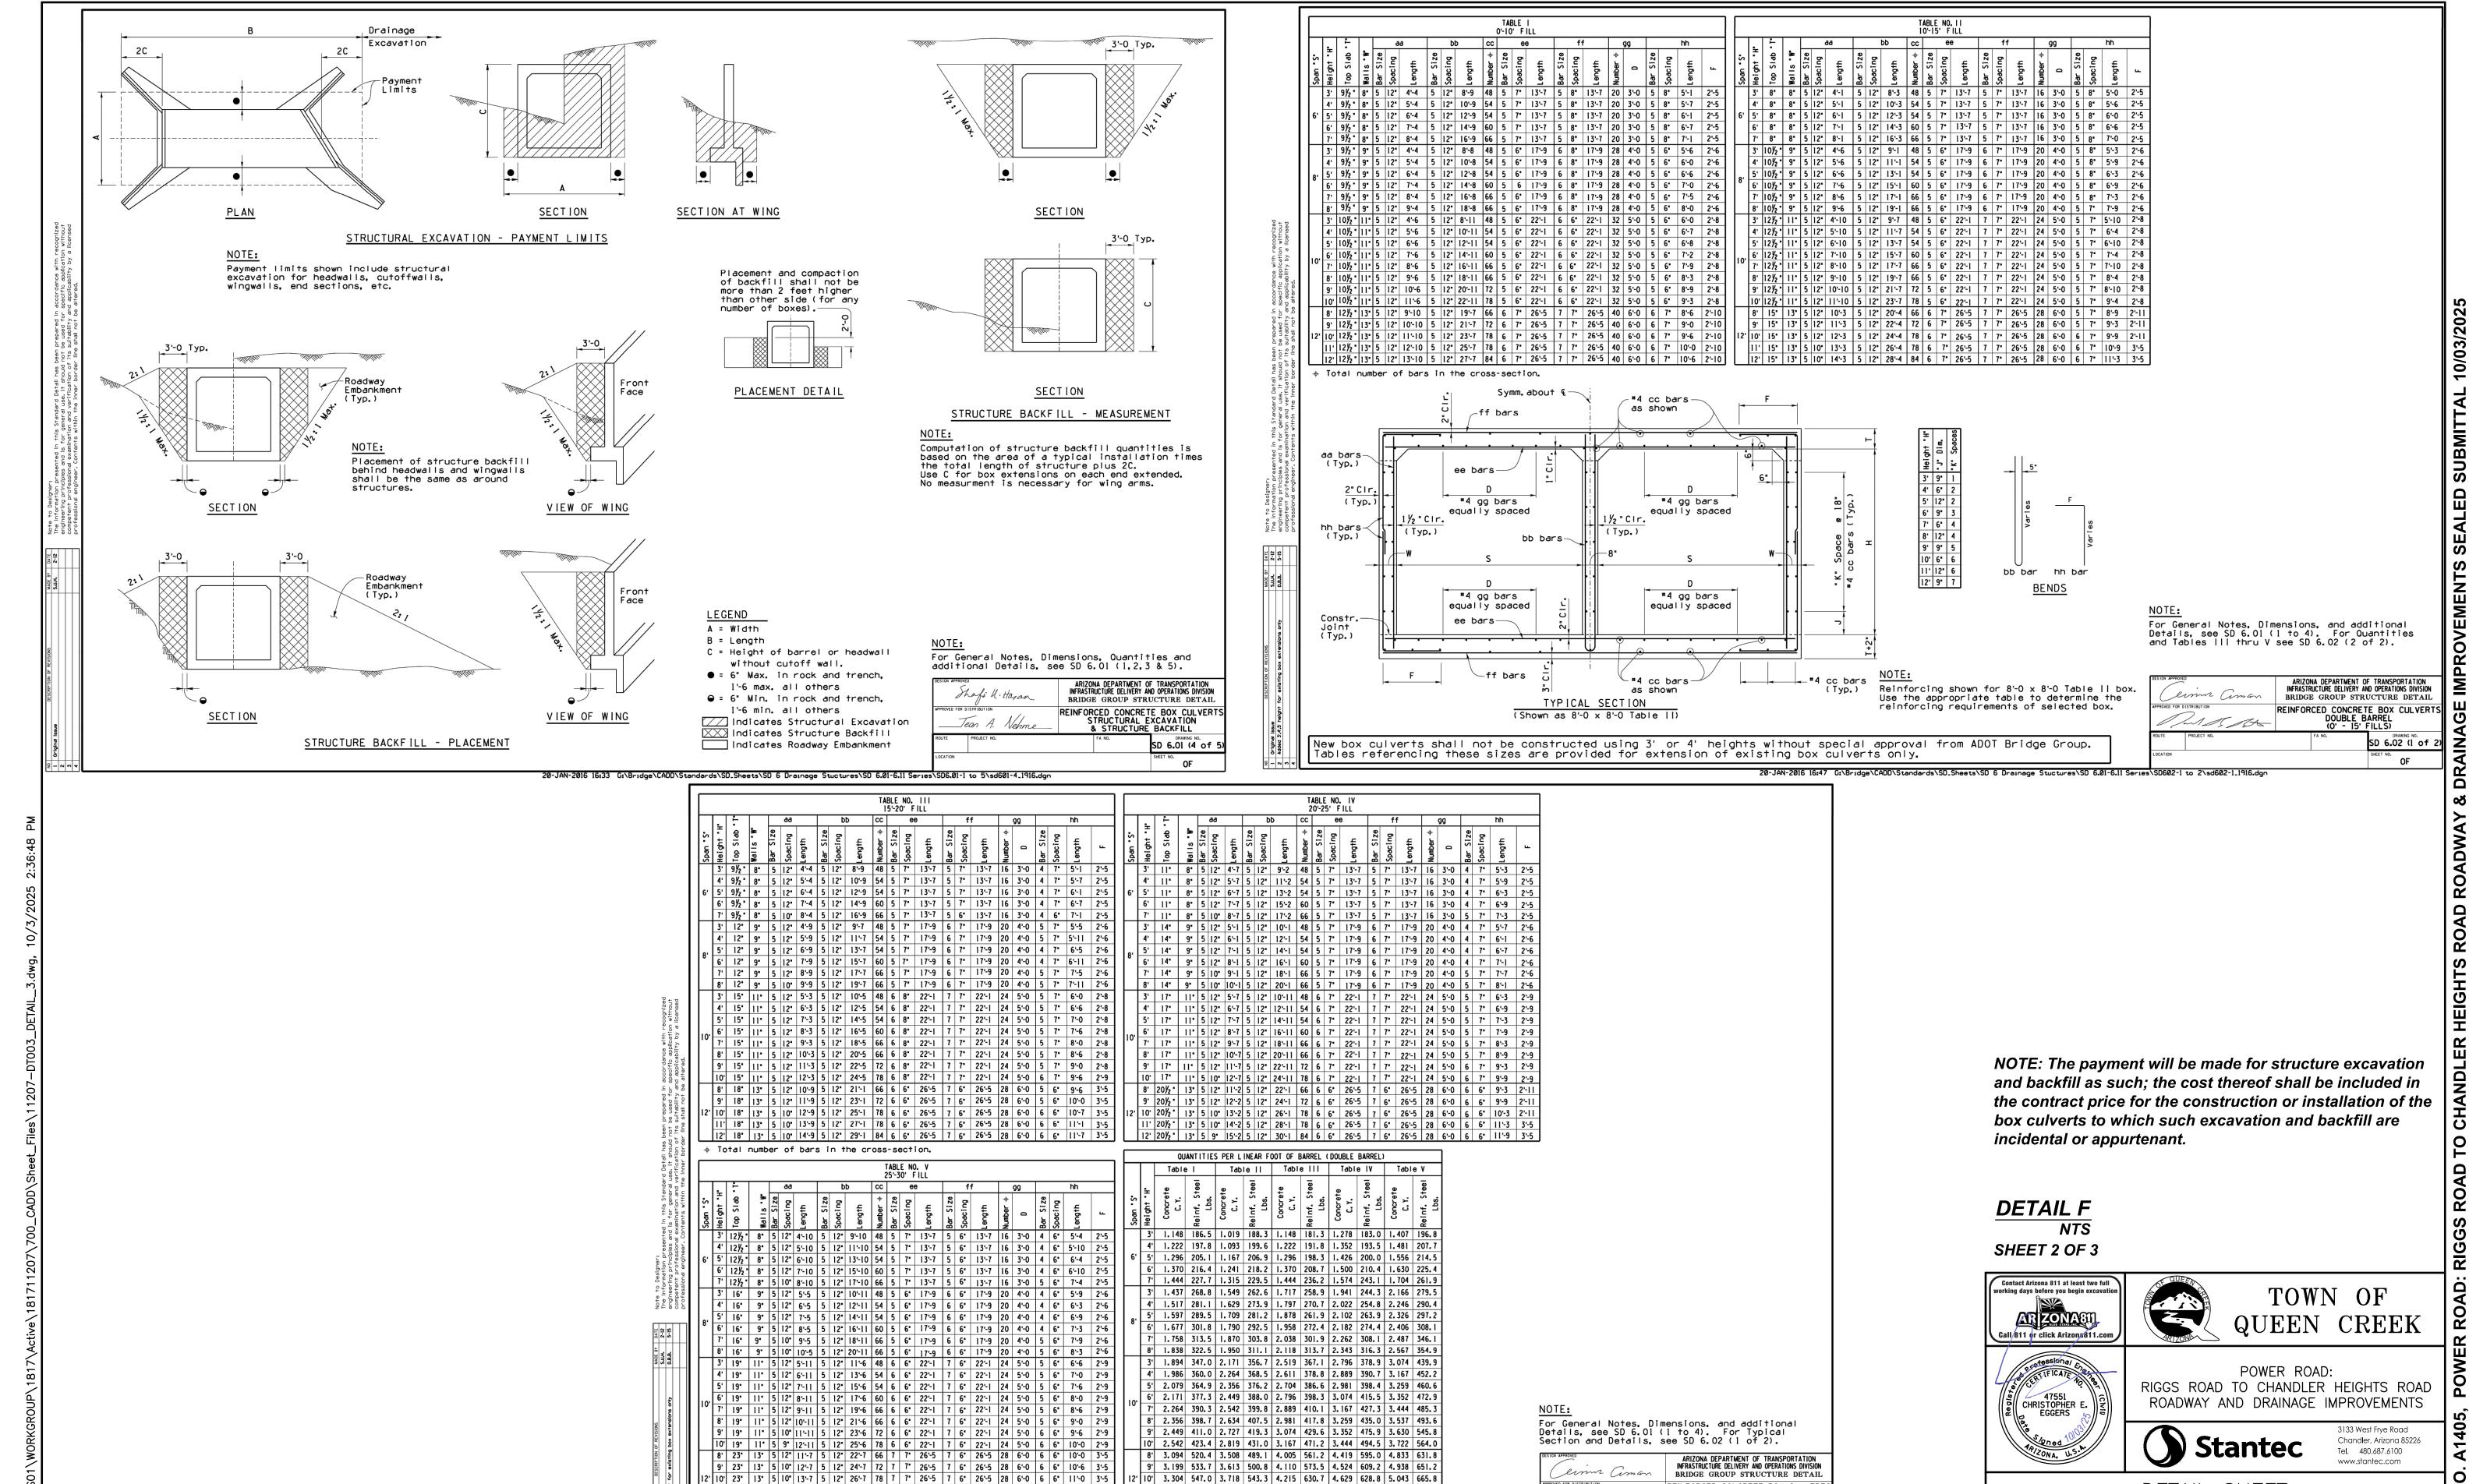

1' 3.409 556.4 3.823 563.3 4.320 641.3 4.734 645.4 5.148 676.4

20-JAN-2016 16:49 G:\Bridge\CADD\Standards\SD_Sheets\SD 6 Drainage Stuctures\SD 6.01-6.11 Series\SD602-1 to 2\sd602-2_1916.dgn

12' 3.514 569.7 3.928 577.0 4.425 656.0 4.839 664.3 5.253 707.7

1' 23' | 13' | 5 | 10' | 14'-7 | 5 | 12' | 28'-7 | 78 | 7 | 7' | 26'-5 | 7 | 6' | 26'-5 | 28 | 6'-0 | 6 | 6' | 11'-6 | 3'-5

12' 23' 13' 5 7' 15'-7 5 12' 30'-7 84 7 7' 26'-5 7 6' 26'-5 28 6'-0 6 6' 12'-0 3'-5

New box culverts shall not be constructed using 3' or 4' heights without special approval from ADOT Bridge Group. Tables referencing these sizes are provided for extension of existing box culverts only.

DETAIL SHEET

DT004

CIP PROJ NO. A1405

SHEET 16 OF 133


DESIGNED BY MH


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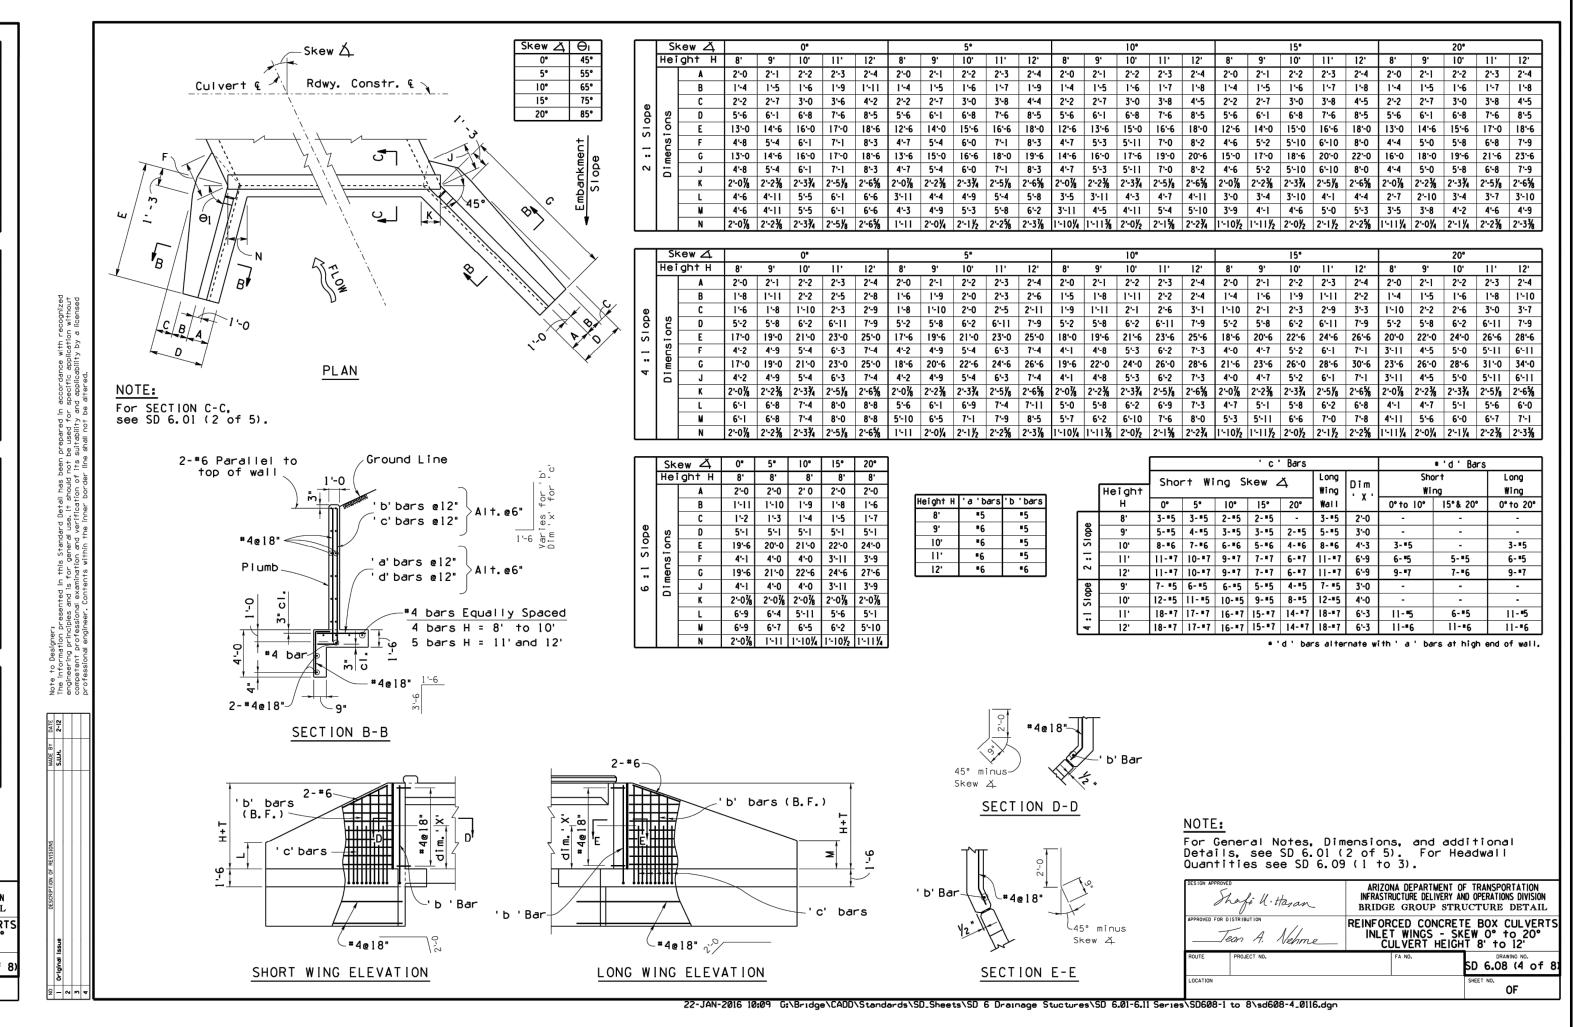
REINFORCED CONCRETE BOX CULVERTS

DOUBLE BARREL (15' - 30' FILLS)

SD 6.02 (2 of



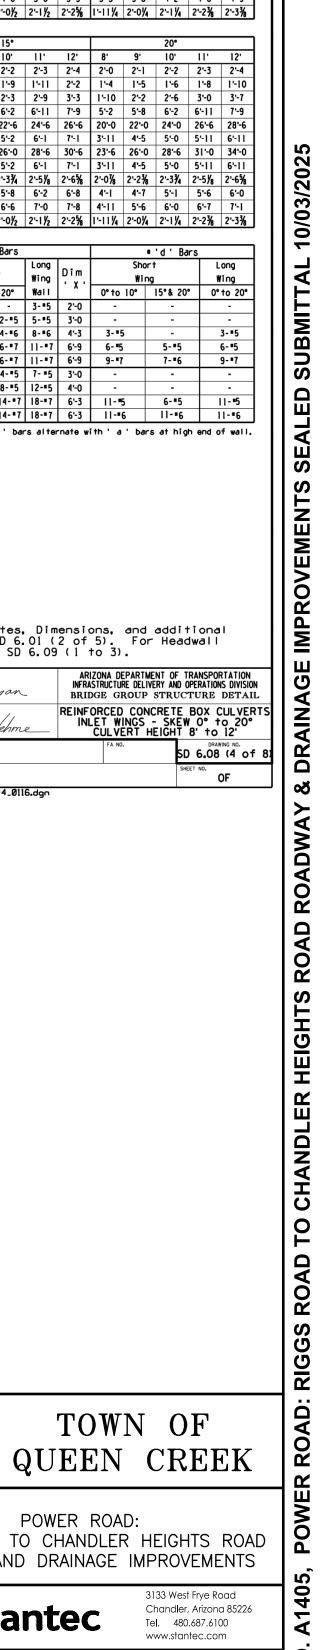

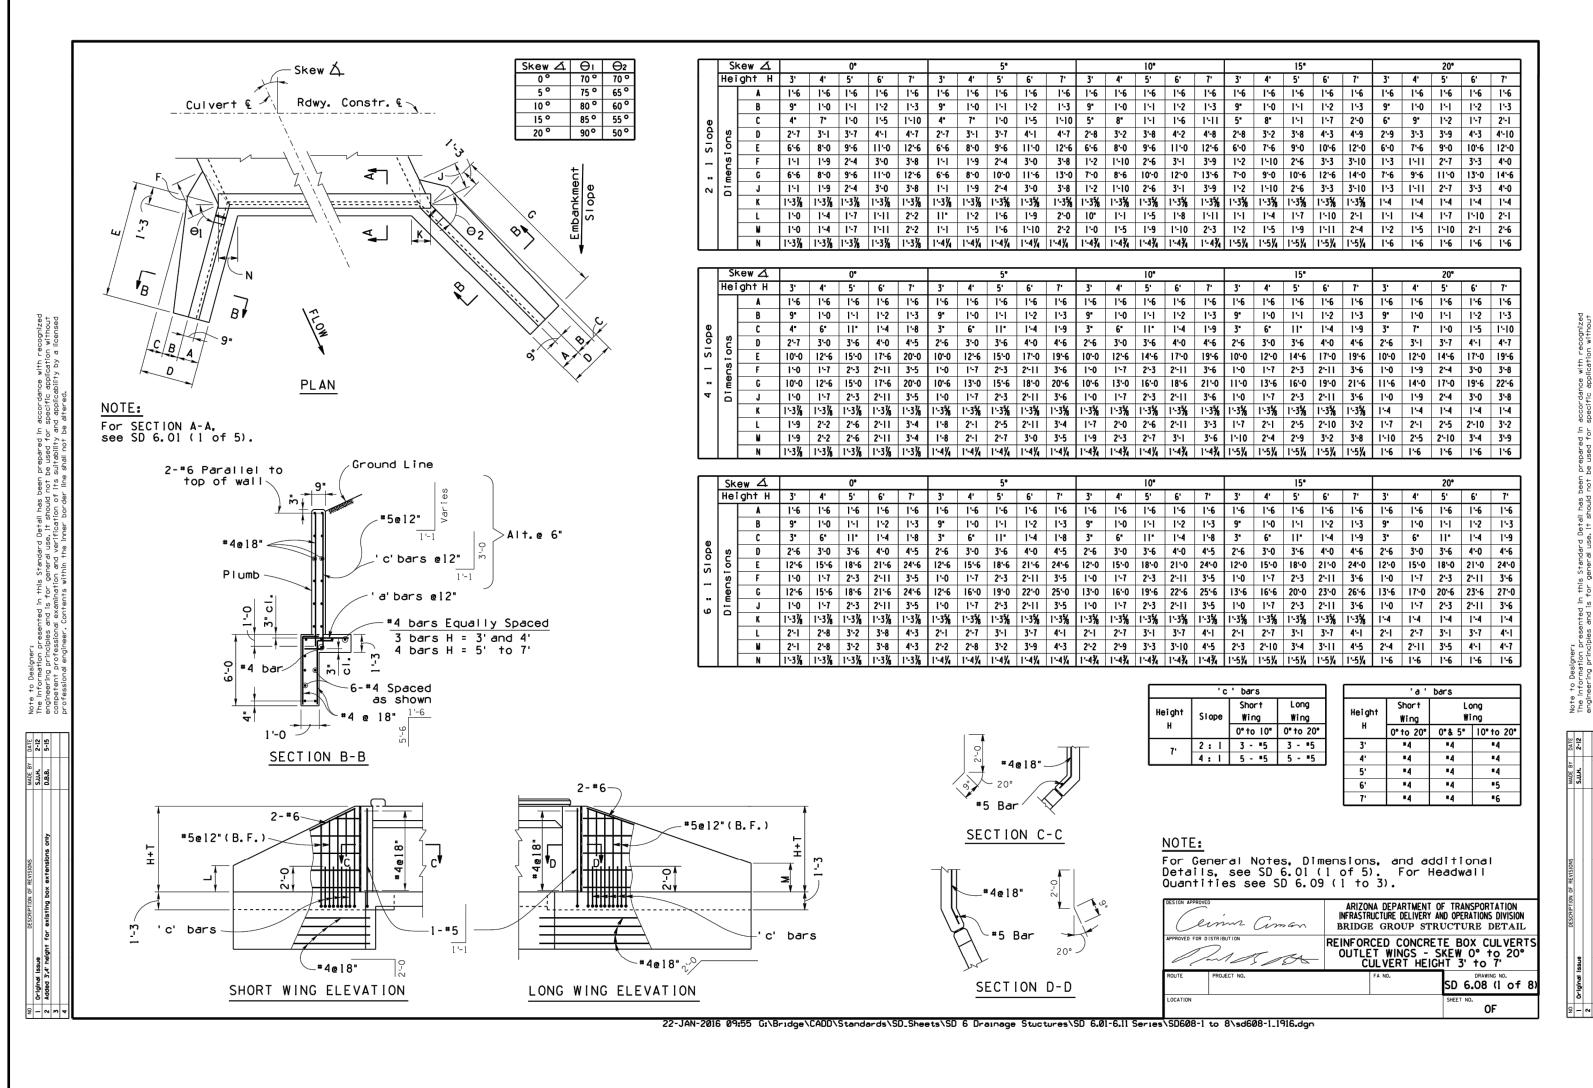



DESIGNED BY MH





POWER ROAD: RIGGS ROAD TO CHANDLER HEIGHTS ROAD ROADWAY AND DRAINAGE IMPROVEMENTS


Stantec


CIP PROJ NO. A1405

SHEET 17 OF 133 DT005 DRAWING NO.

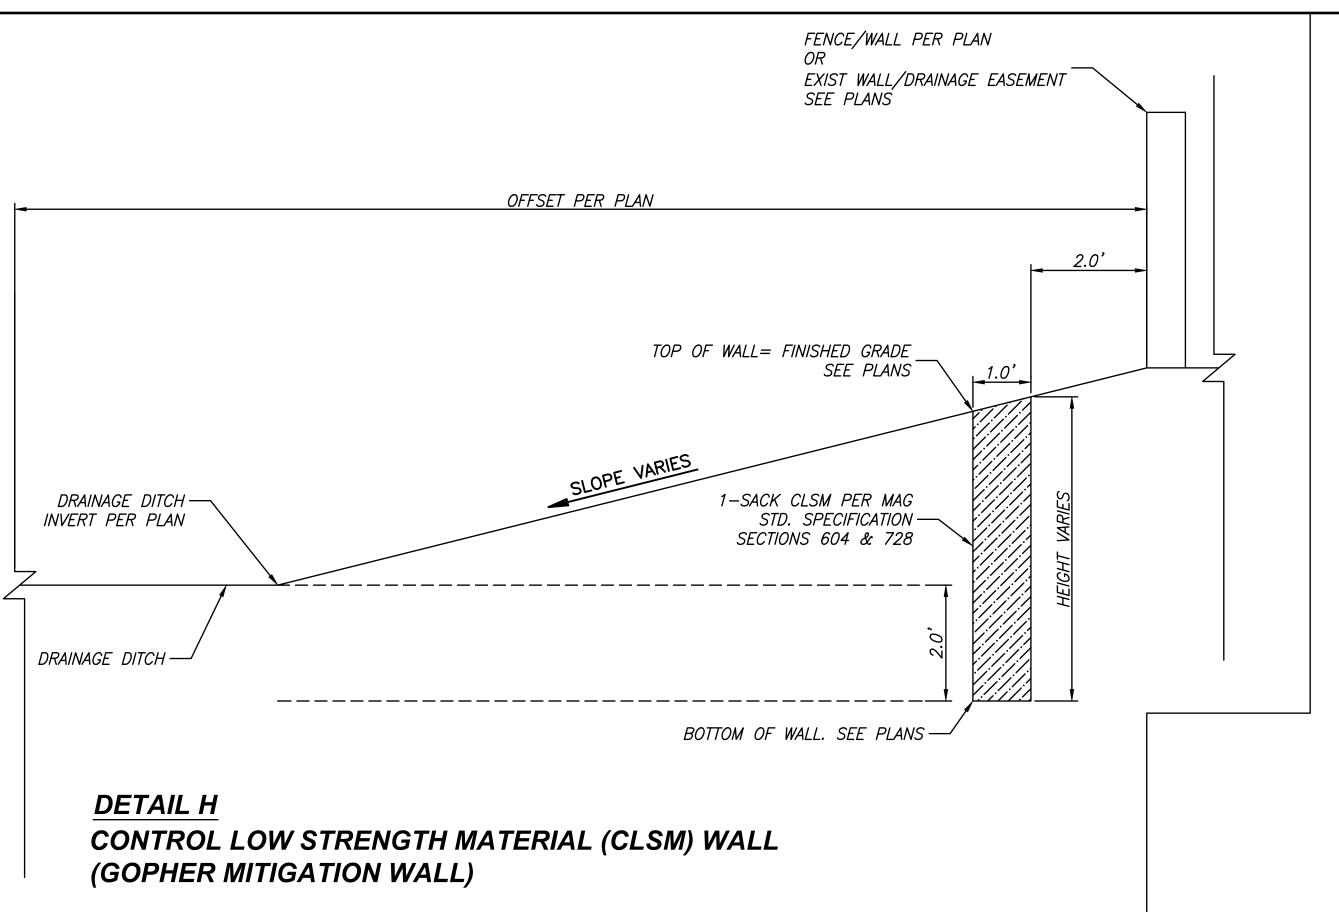

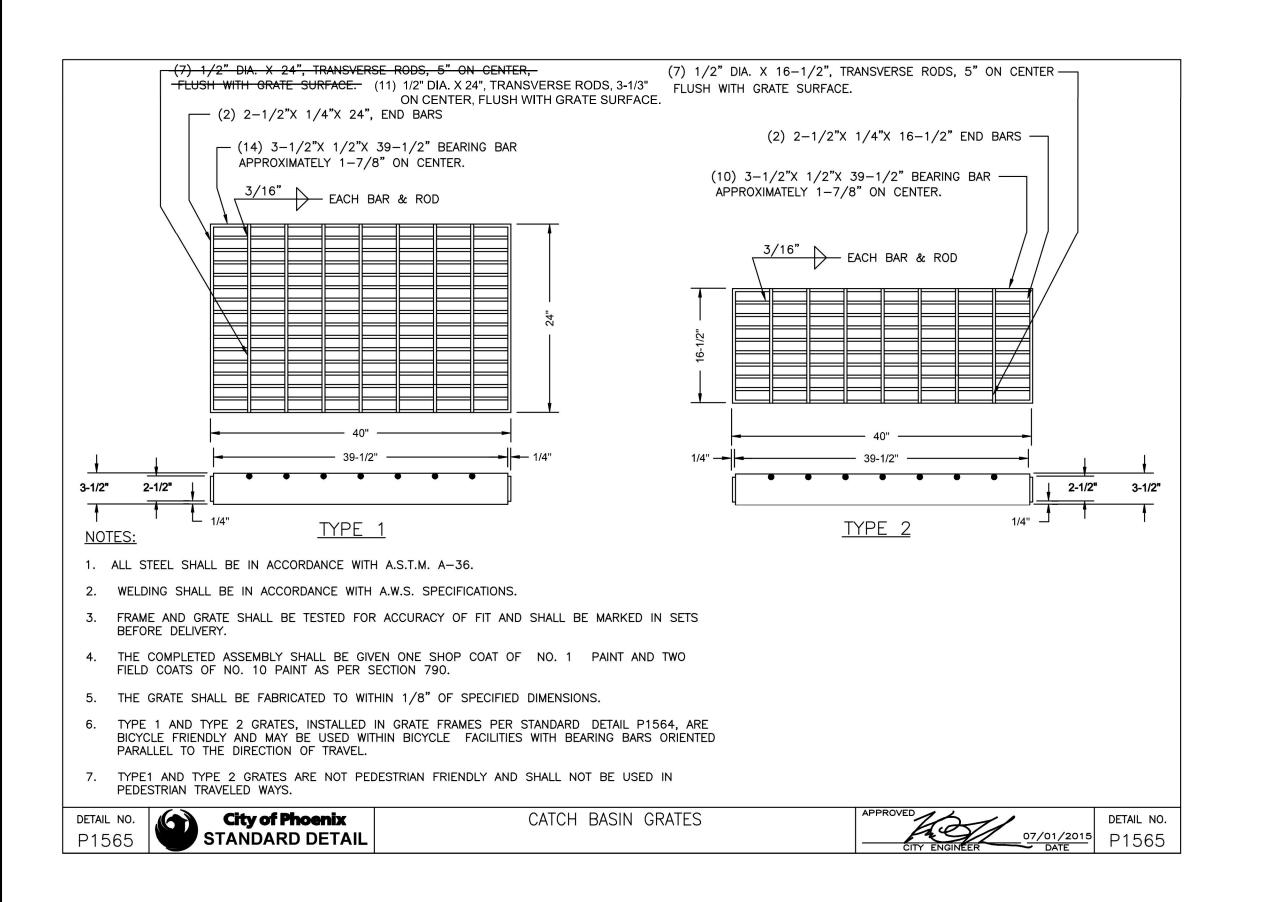

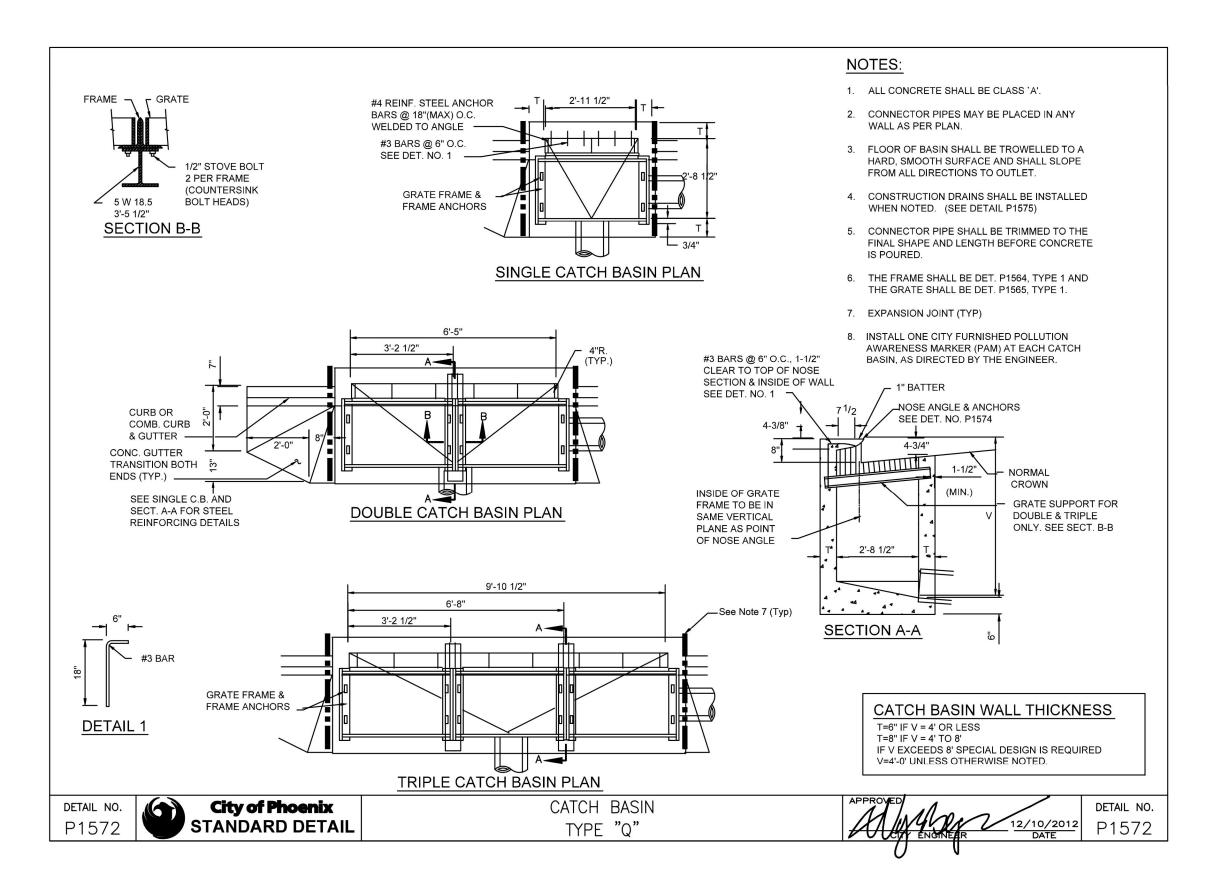

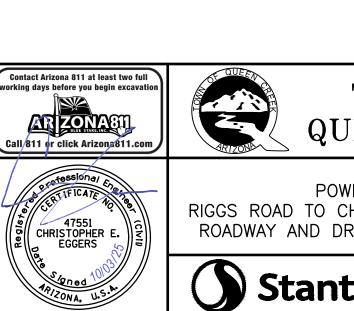

TOWN OF

SUBMITTAL

SEALED (

DRAINAGE IMPROVEMENTS

CHANDLER HEIGHTS

POWER ROAD: RIGGS ROAD TO CHANDLER HEIGHTS ROAD ROADWAY AND DRAINAGE IMPROVEMENTS

Chandler, Arizona 85226

Tel. 480.687.6100


ROADWAY DETAILS


DESIGNED BY MH CIP PROJ NO. A1405 SHEET 18 OF 133 DRAWING NO.


DETAIL G NTS


1. THE SPACING OF THE TRANSVERSE RODS HAS BEEN MODIFIED TO THE DIMENSIONS SHOWN ABOVE.

CONTRACTOR SHALL ADHERE TO THE SPECIAL PROVISION REQUIREMENTS FOR SAN TAN IRRIGATION DISTRICT (STID) CLEARANCES DURING THE CONSTRUCTION OF ALL CATCH BASINS ON THE WEST SIDE OF POWER ROAD NEAR THE STID FACILITIES.

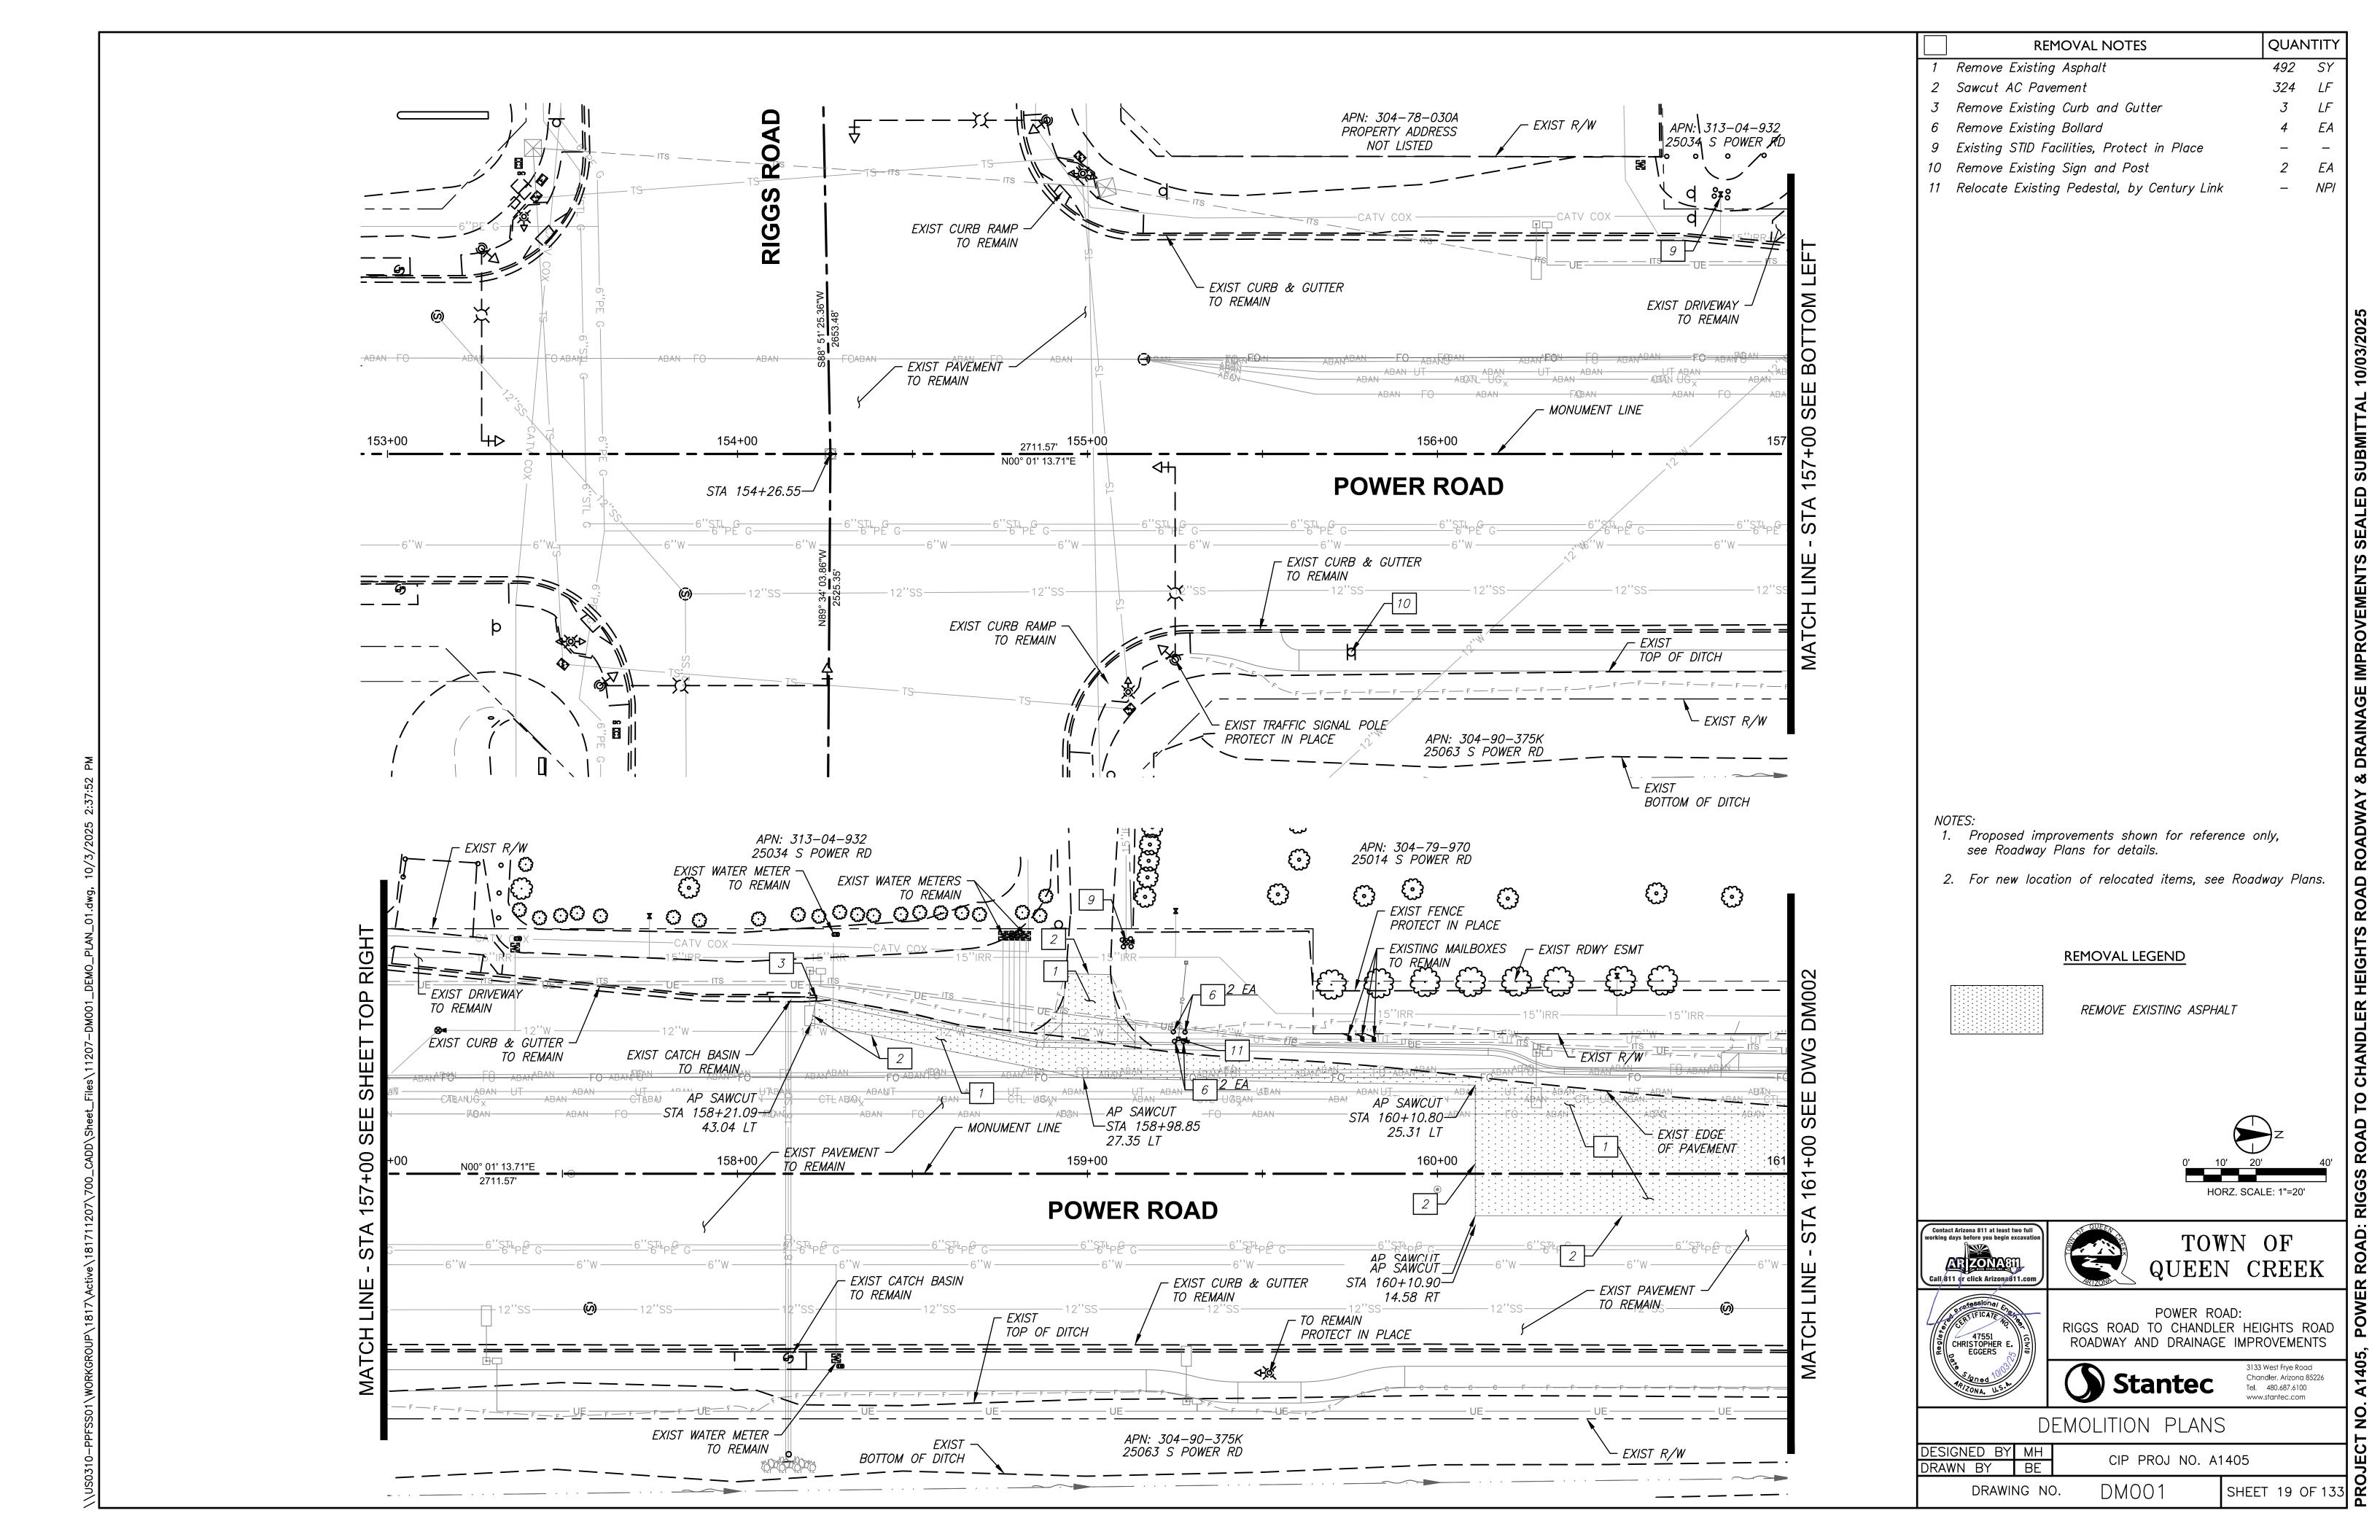

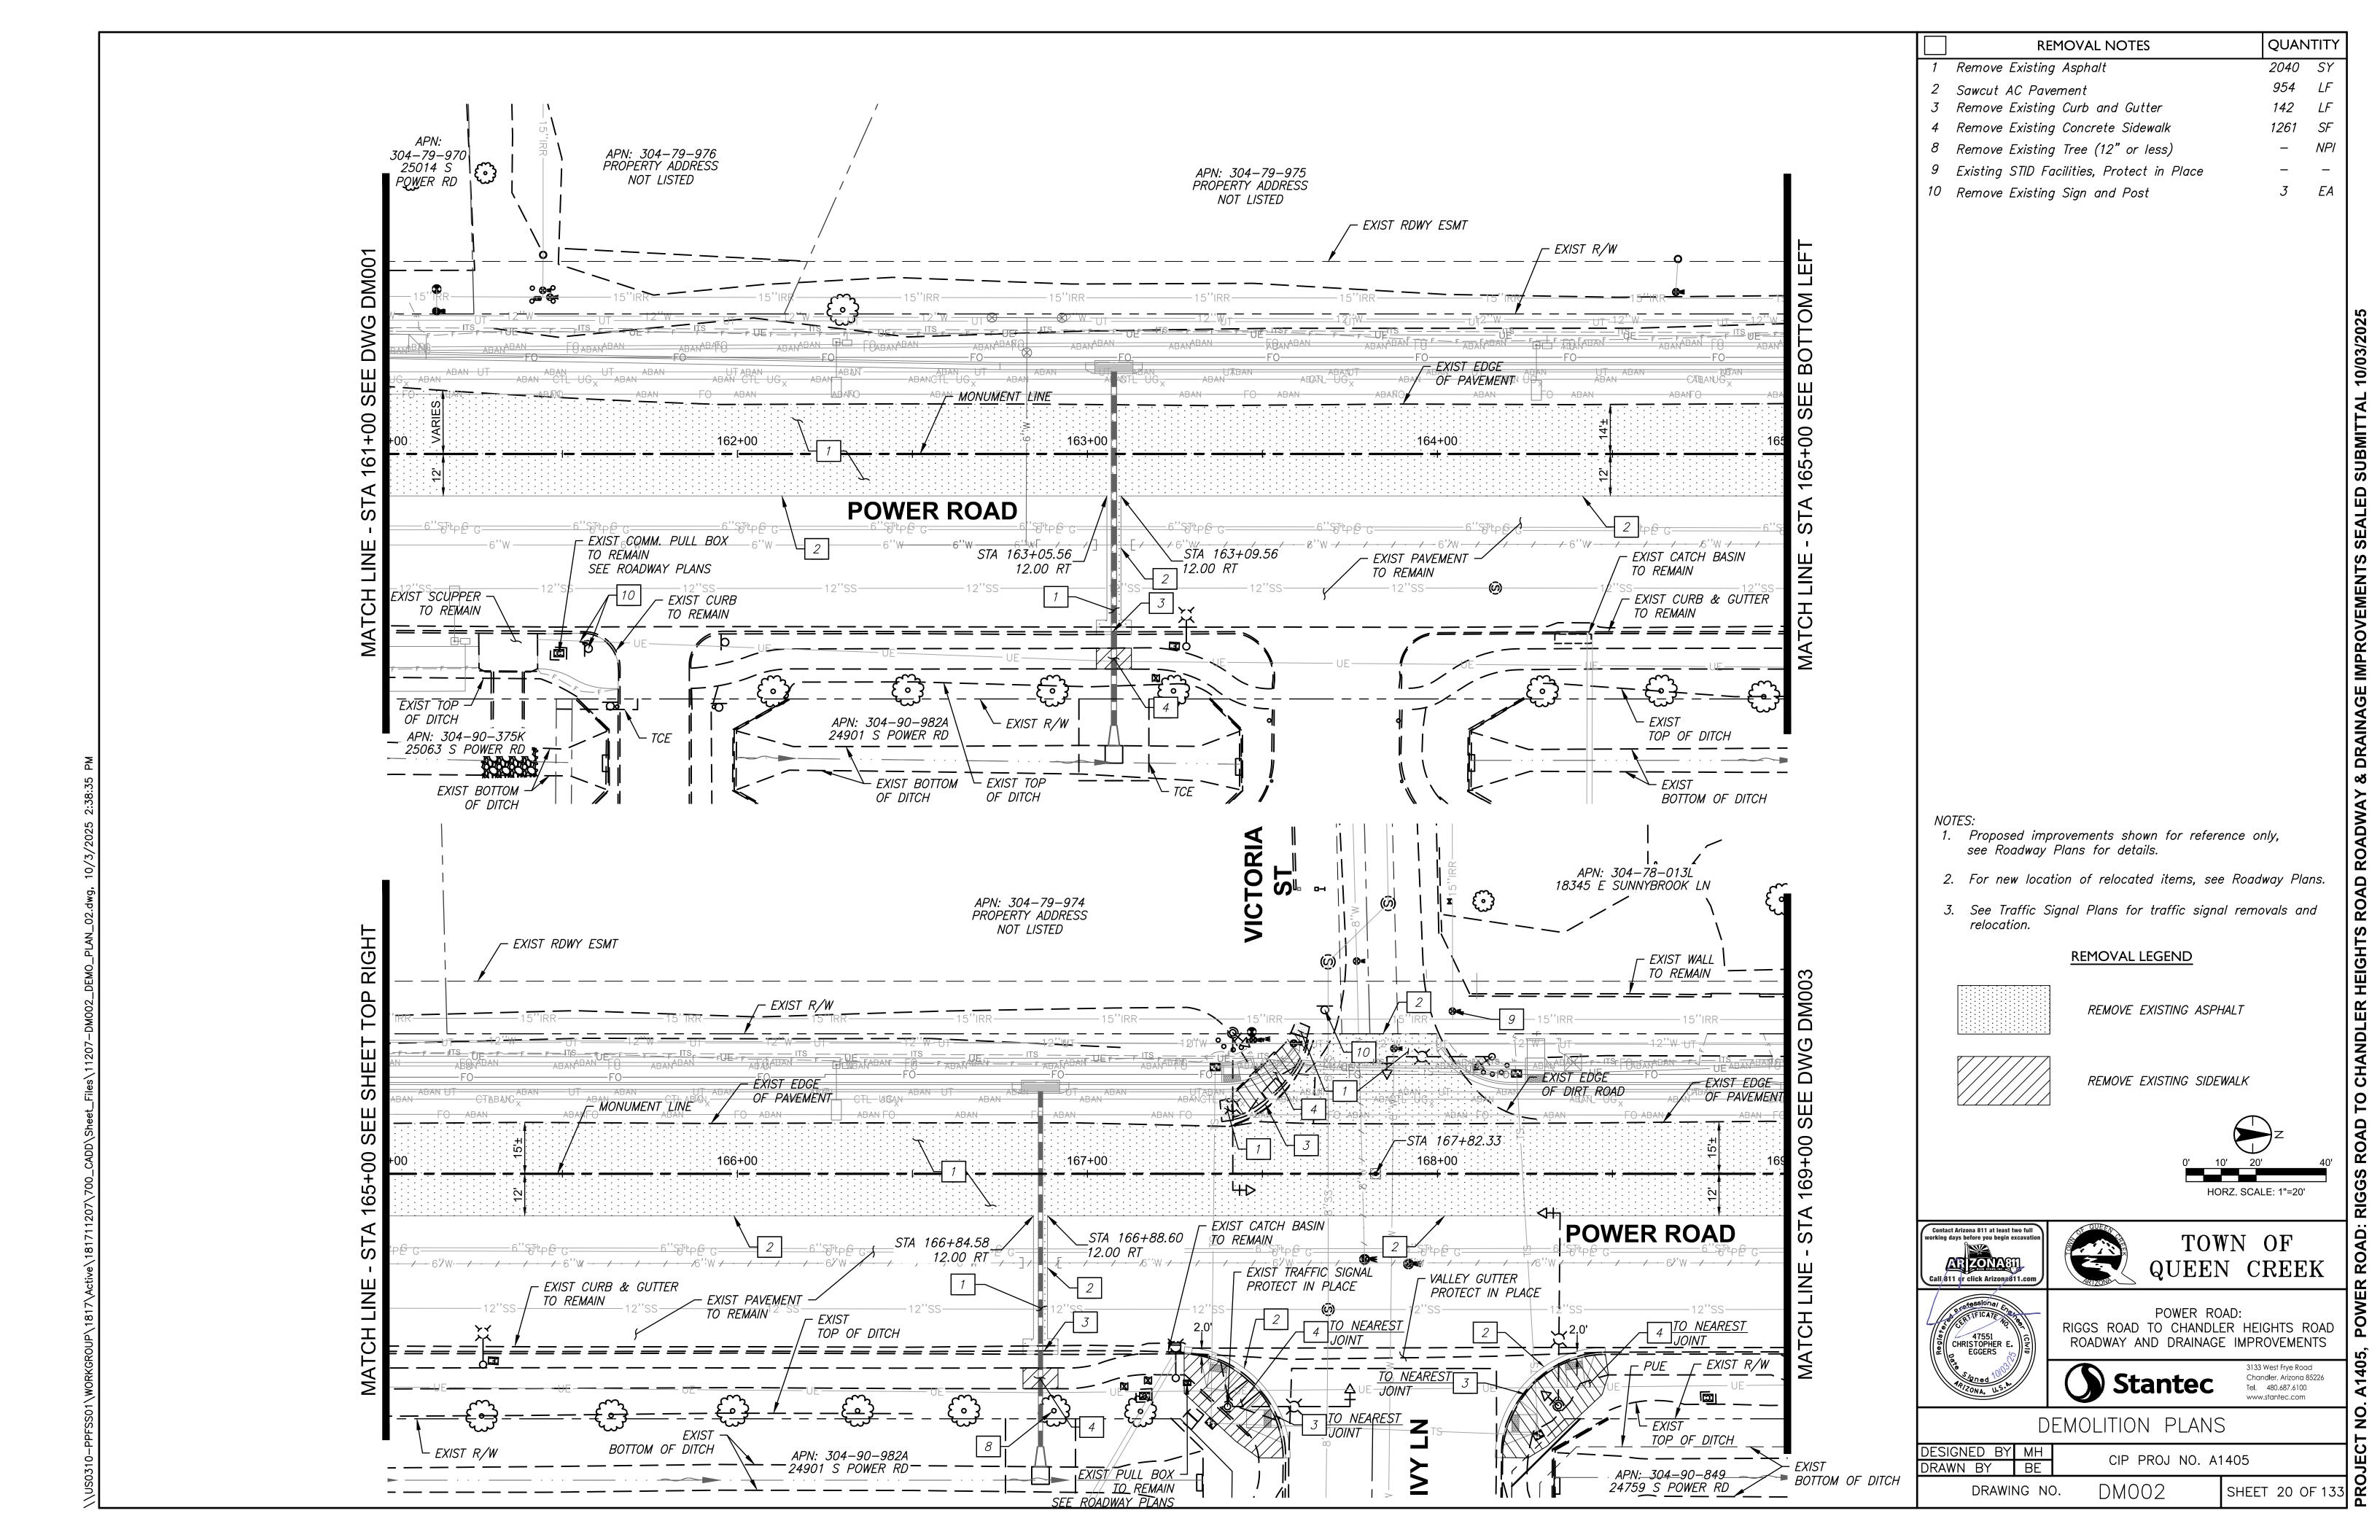


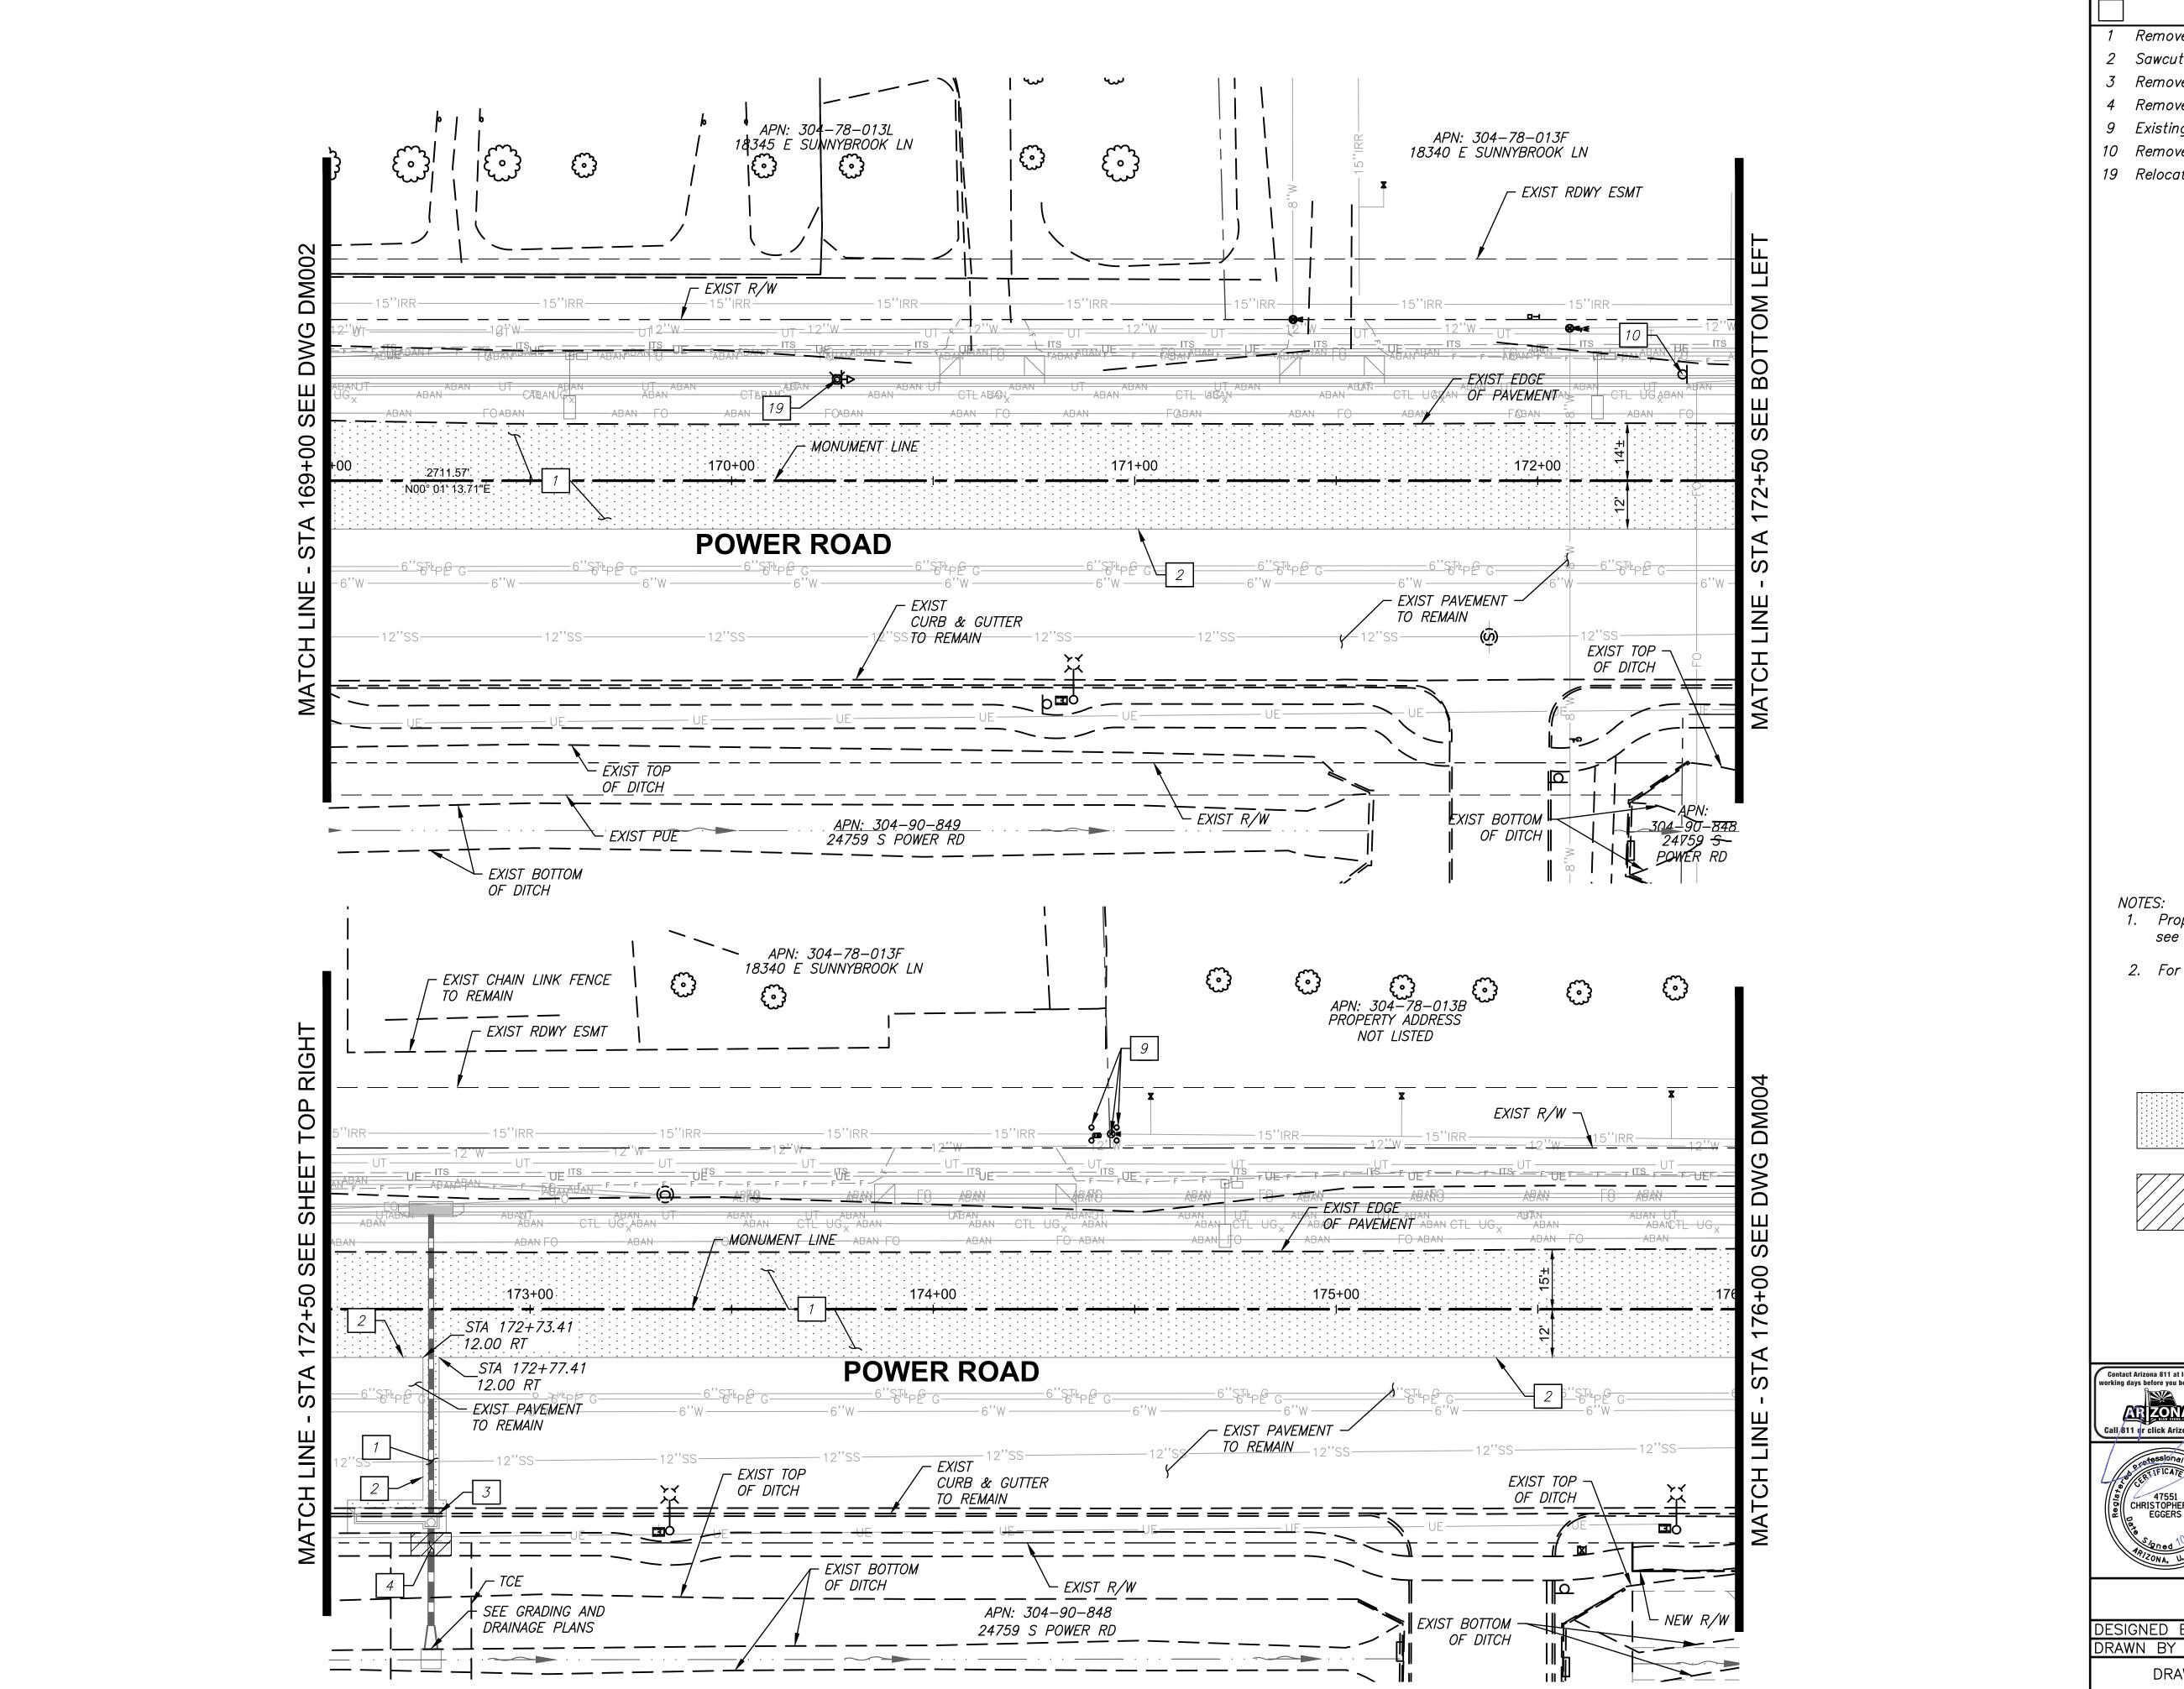

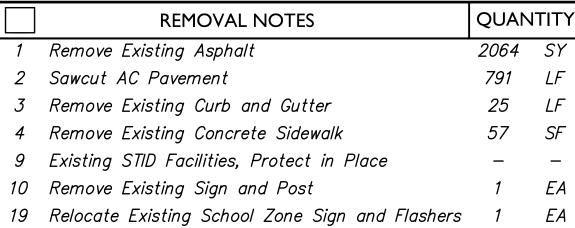


- 1. Proposed improvements shown for reference only, see Roadway Plans for details.
- 2. For new location of relocated items, see Roadway Plans.


REMOVAL LEGEND

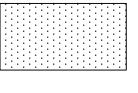

REMOVE EXISTING ASPHALT

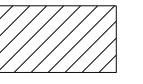

REMOVE EXISTING SIDEWALK

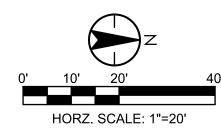





TOWN OF QUEEN CREEK




POWER ROAD: RIGGS ROAD TO CHANDLER HEIGHTS ROAD ROADWAY AND DRAINAGE IMPROVEMENTS





DEMOLITION PLANS


DESIGNED BY MH CIP PROJ NO. A1405 SHEET 21 OF 133 DM003 DRAWING NO.

Chandler, Arizona 85226 Tel. 480.687.6100

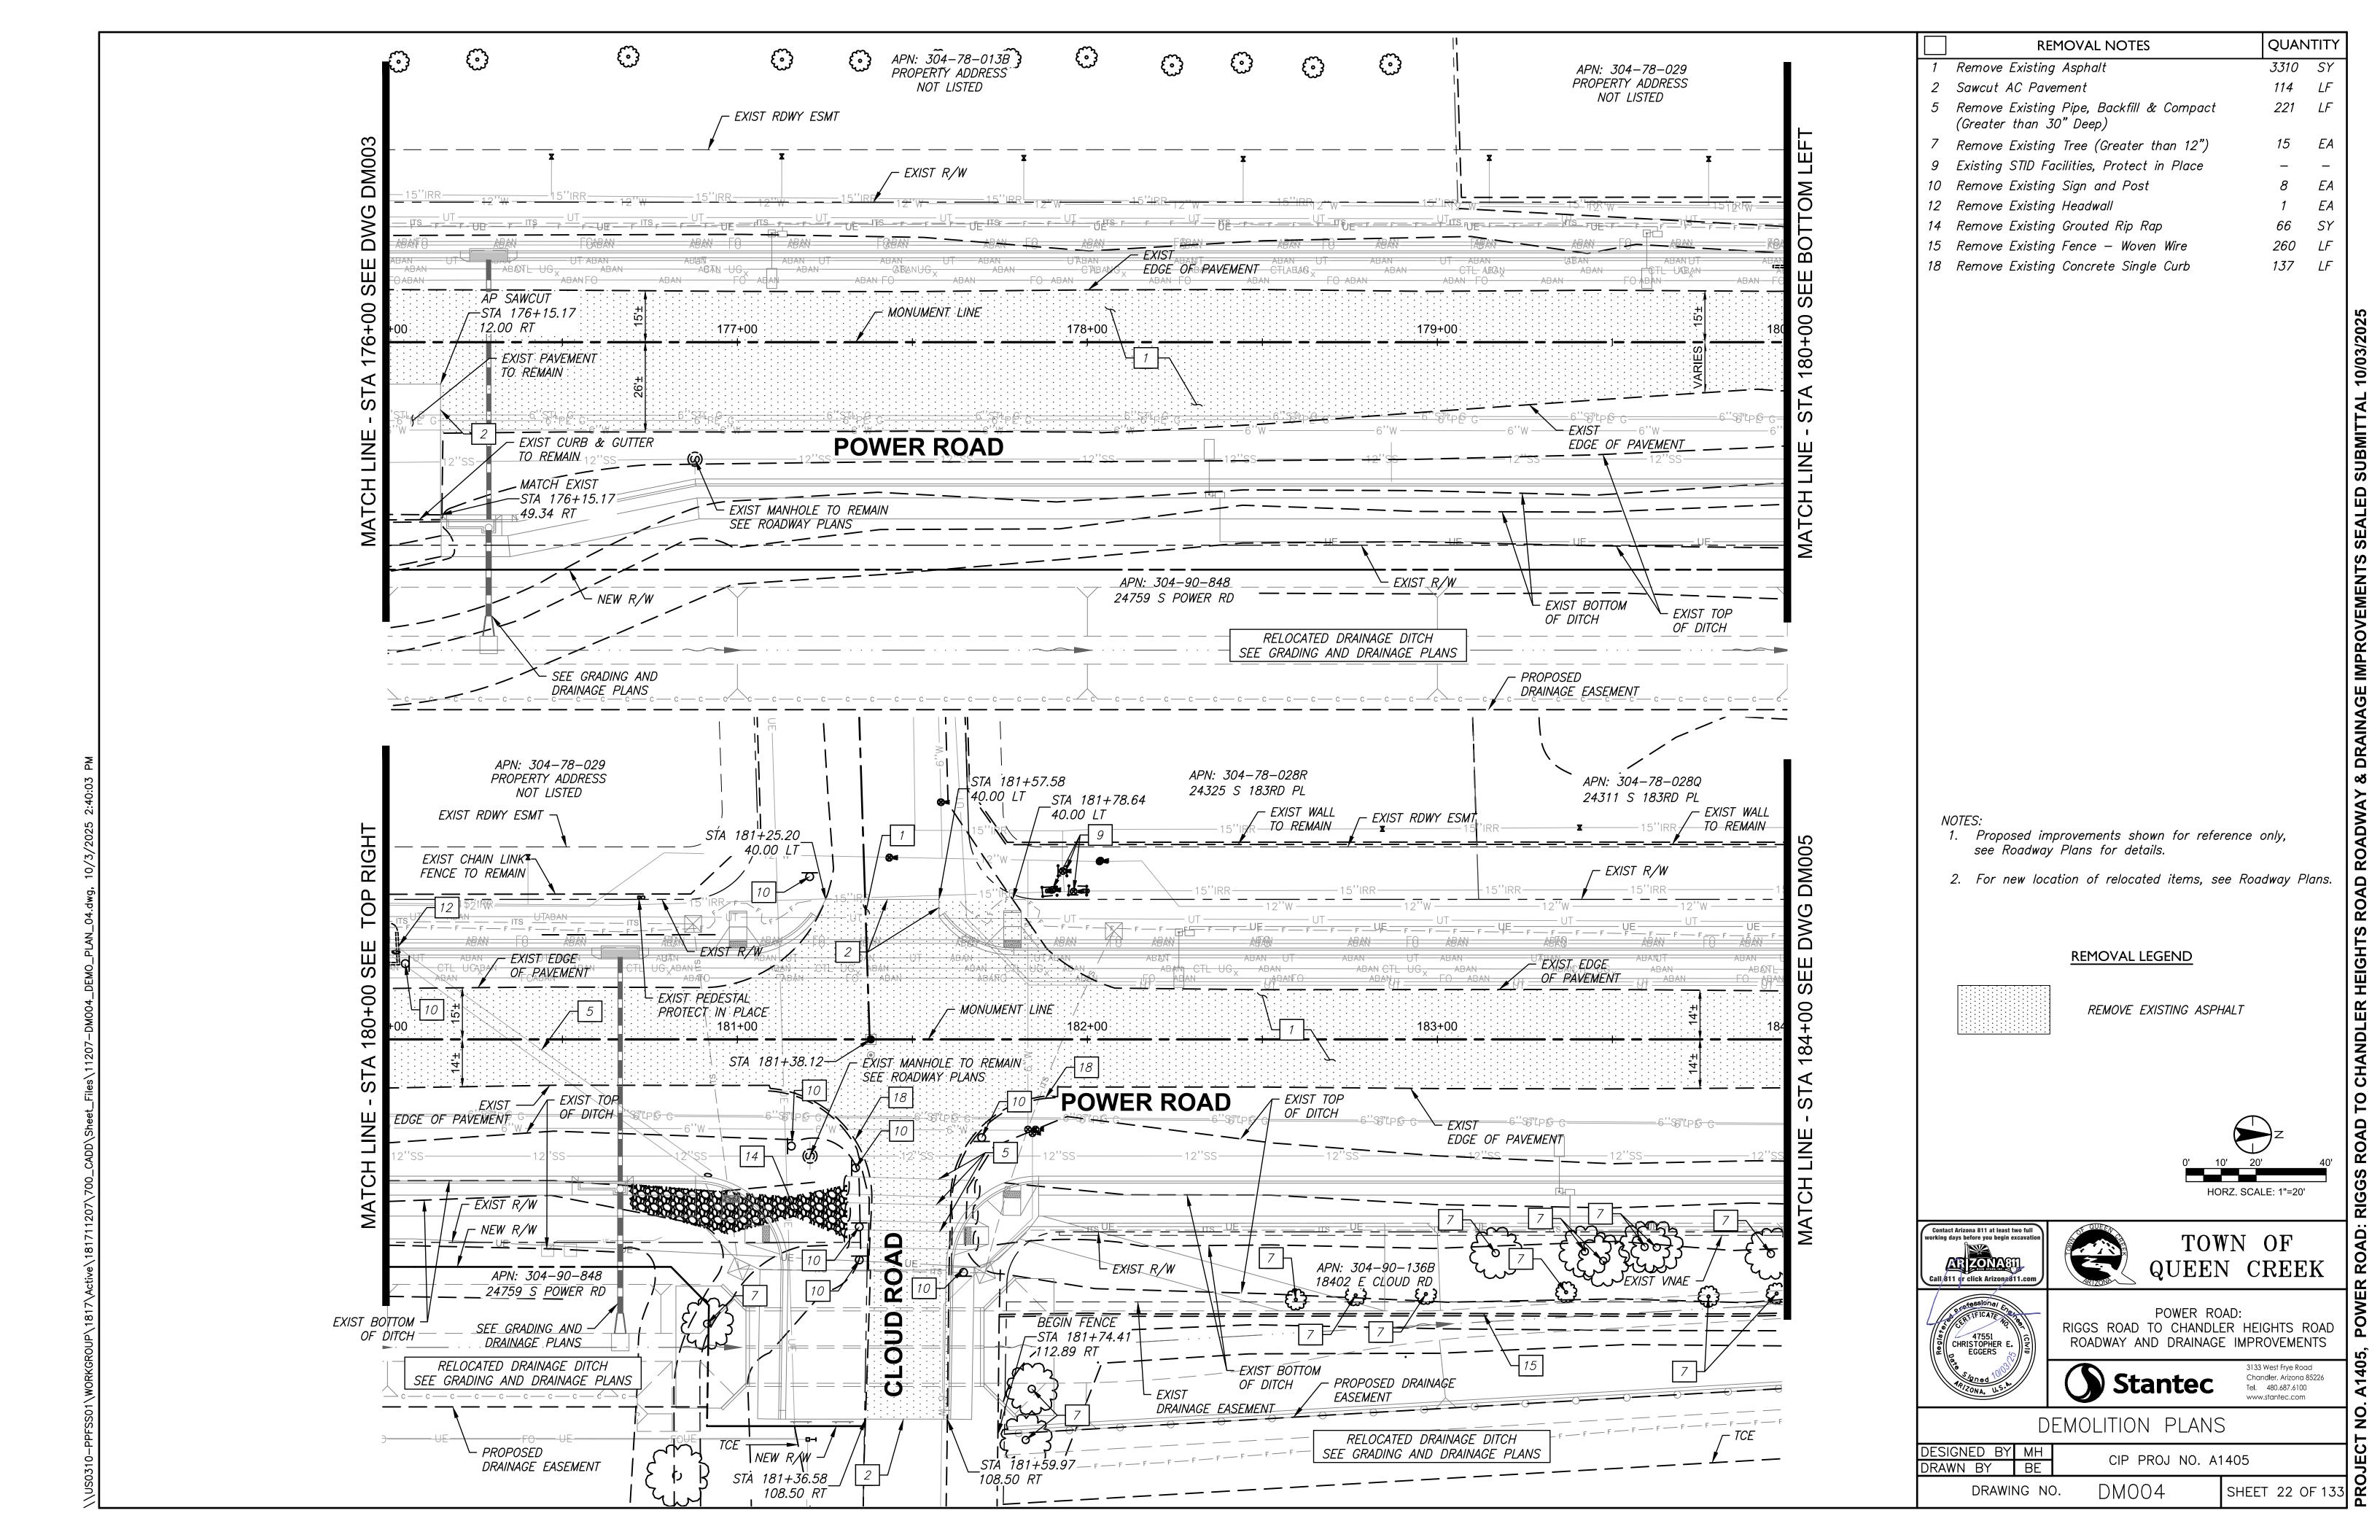

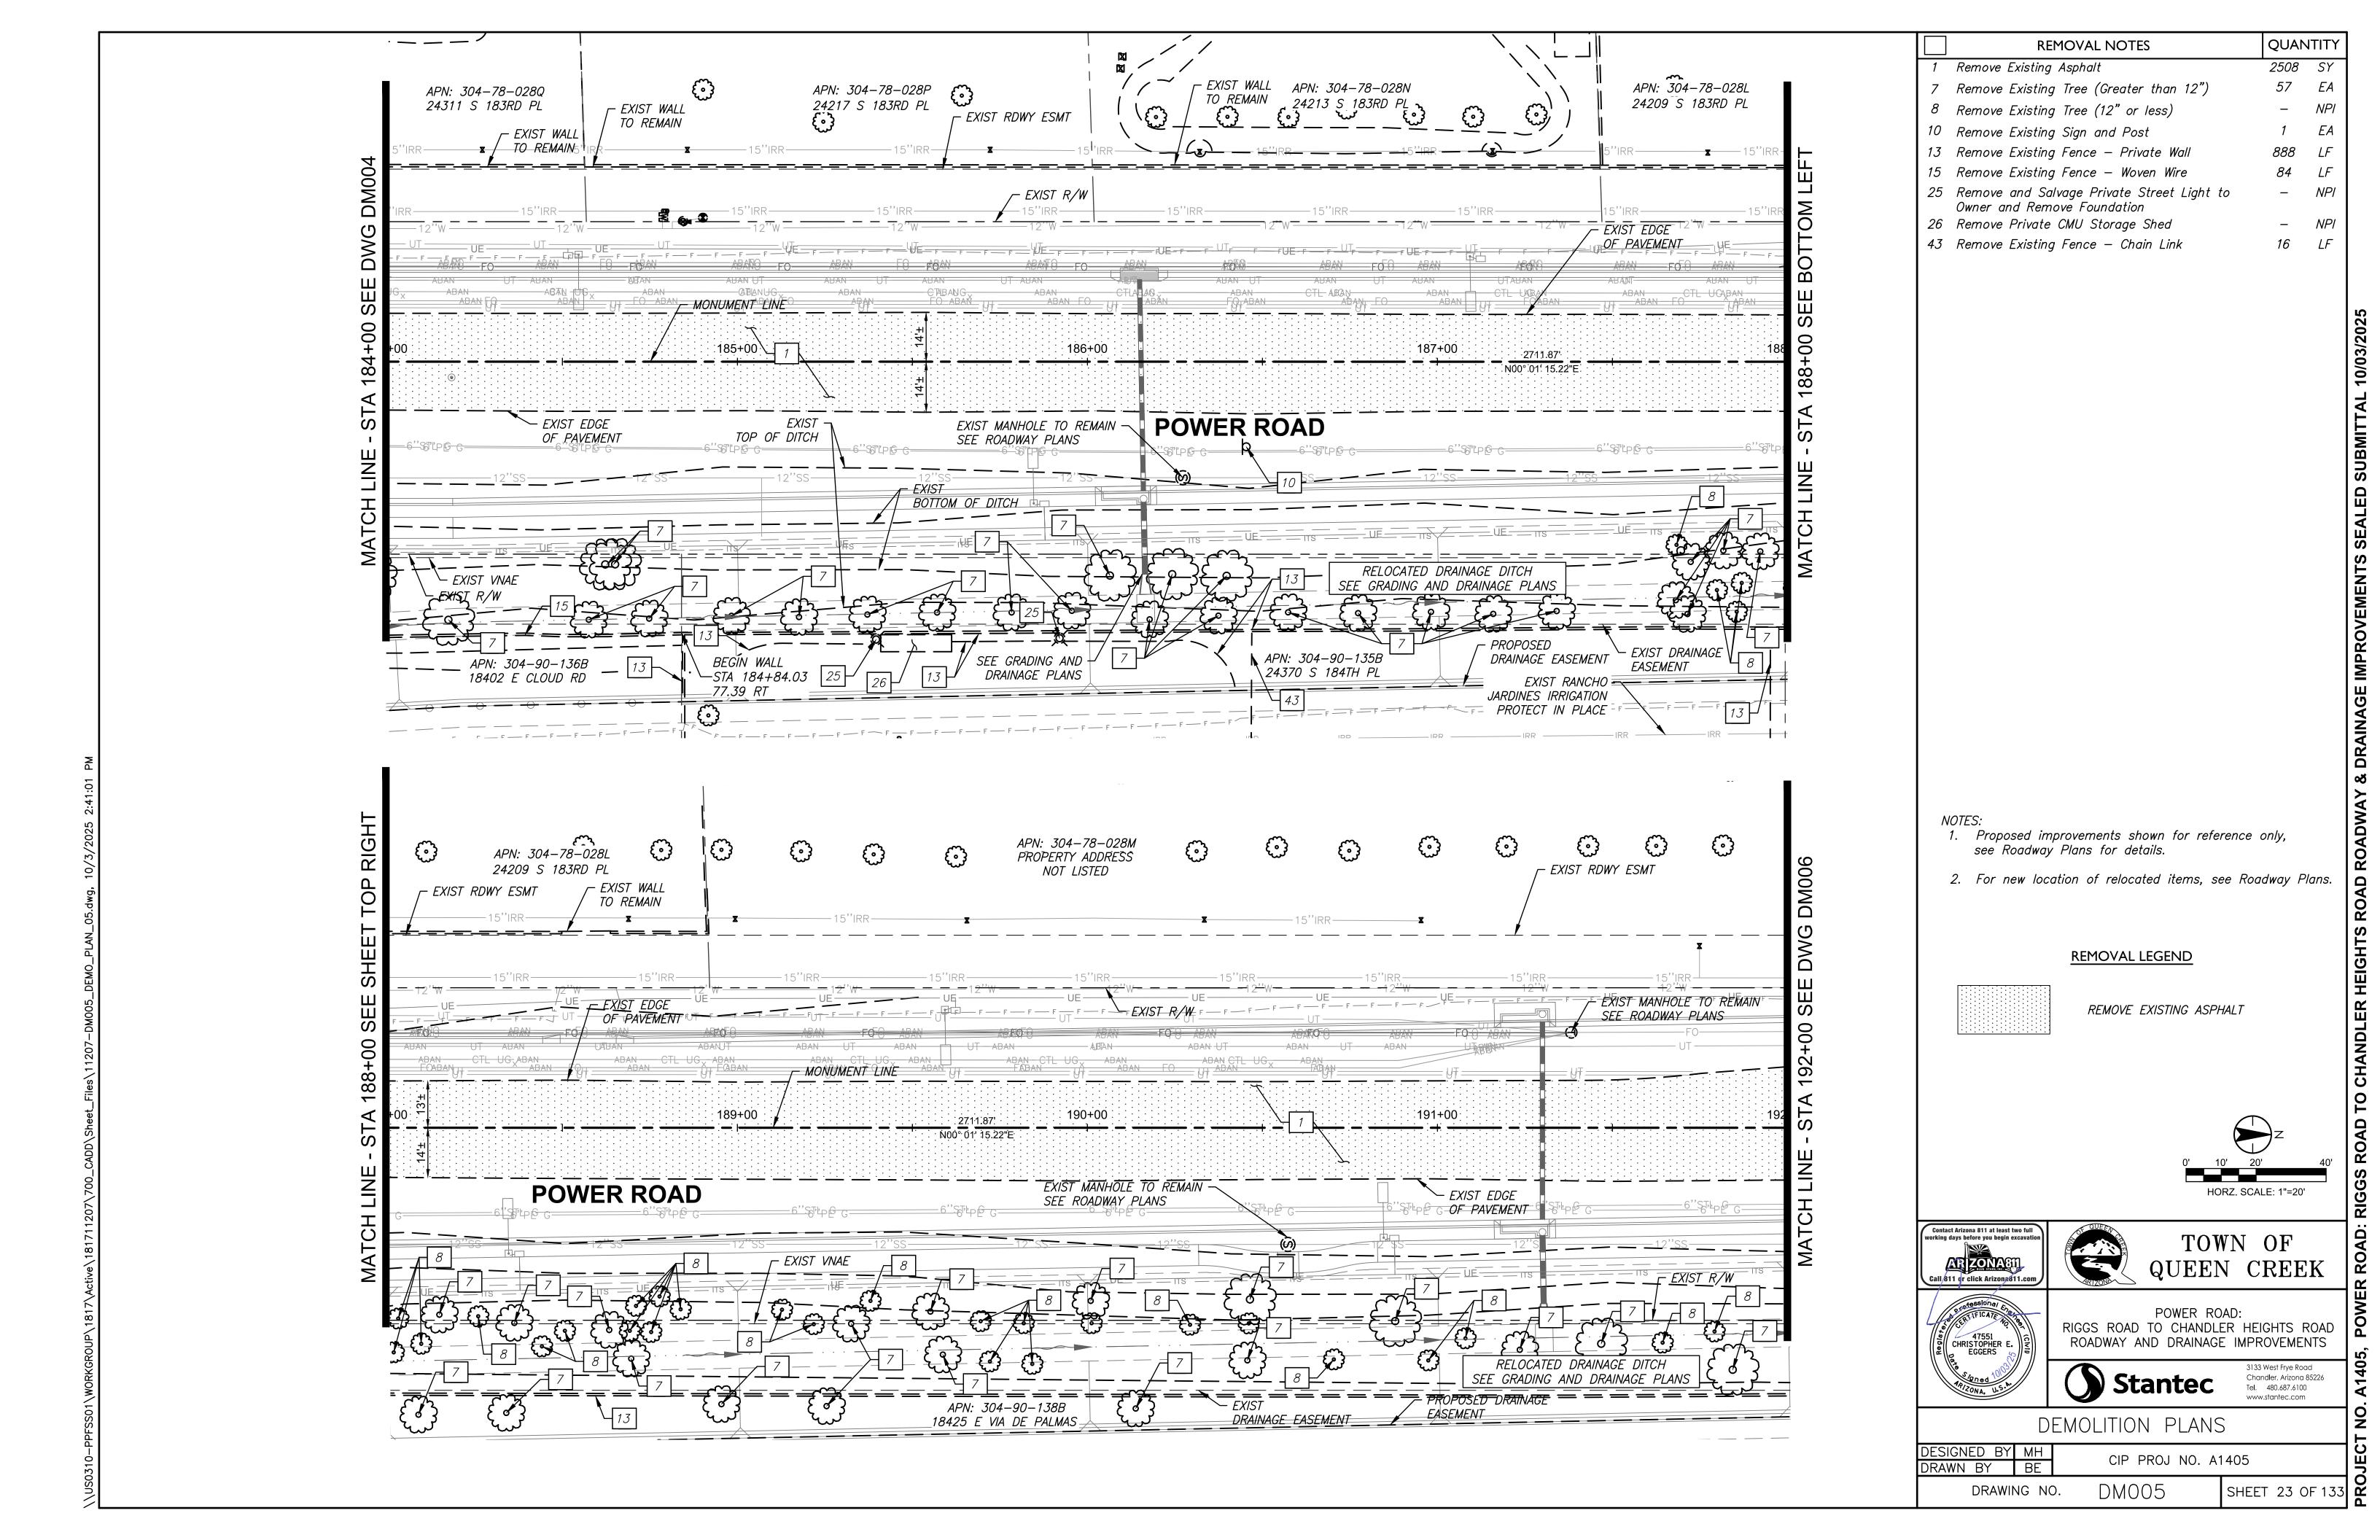

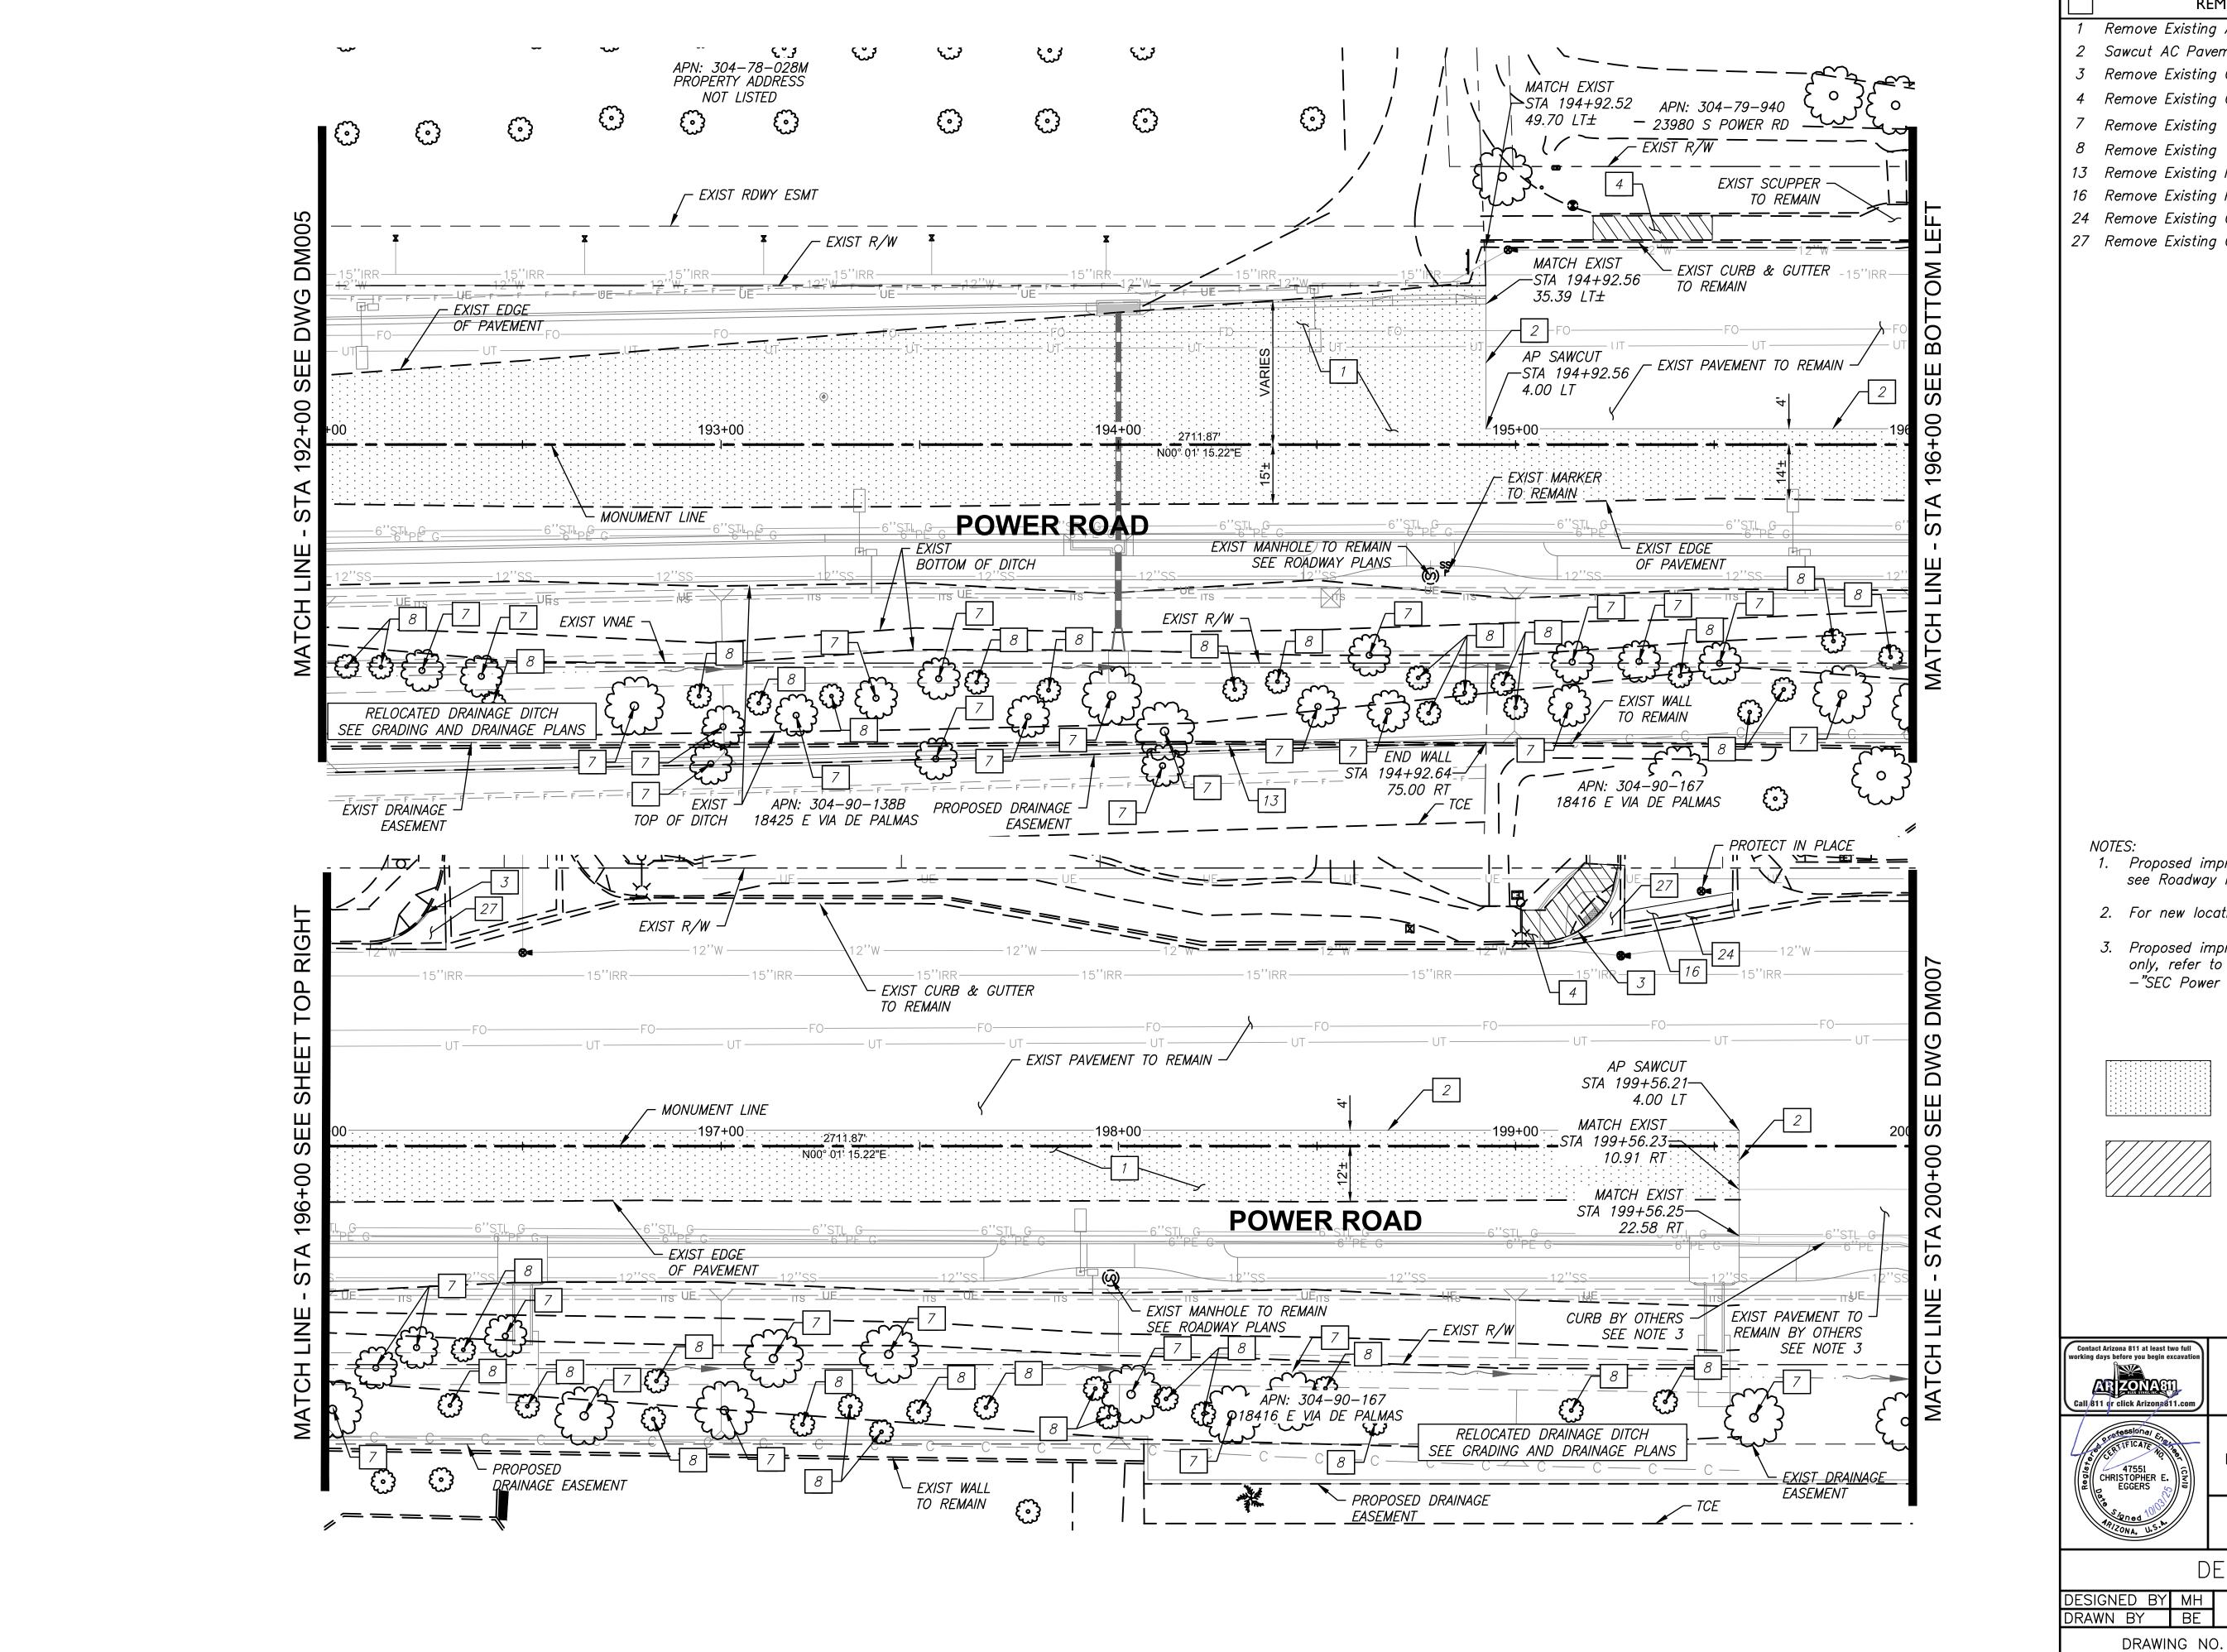

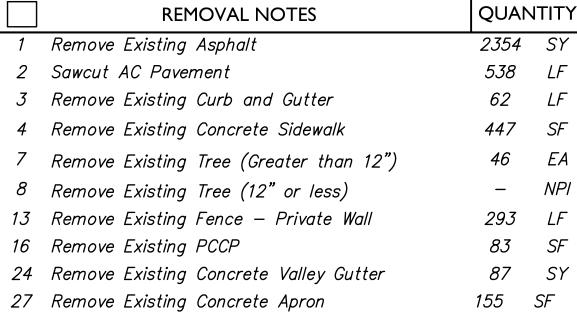


- 1. Proposed improvements shown for reference only, see Roadway Plans for details.
- 2. For new location of relocated items, see Roadway Plans.
- 3. Proposed improvements "BY OTHERS" shown for reference only, refer to Town of Queen Creek Project Number 6862 "SEC Power Road & Chandler Heights Road", for details.


REMOVAL LEGEND



REMOVE EXISTING ASPHALT

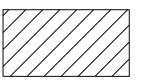

REMOVE EXISTING SIDEWALK

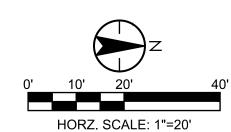





TOWN OF QUEEN CREEK




POWER ROAD: RIGGS ROAD TO CHANDLER HEIGHTS ROAD ROADWAY AND DRAINAGE IMPROVEMENTS


Stantec


Chandler, Arizona 85226 Tel. 480.687.6100 DEMOLITION PLANS


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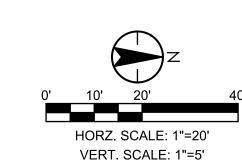
SHEET 24 OF 133



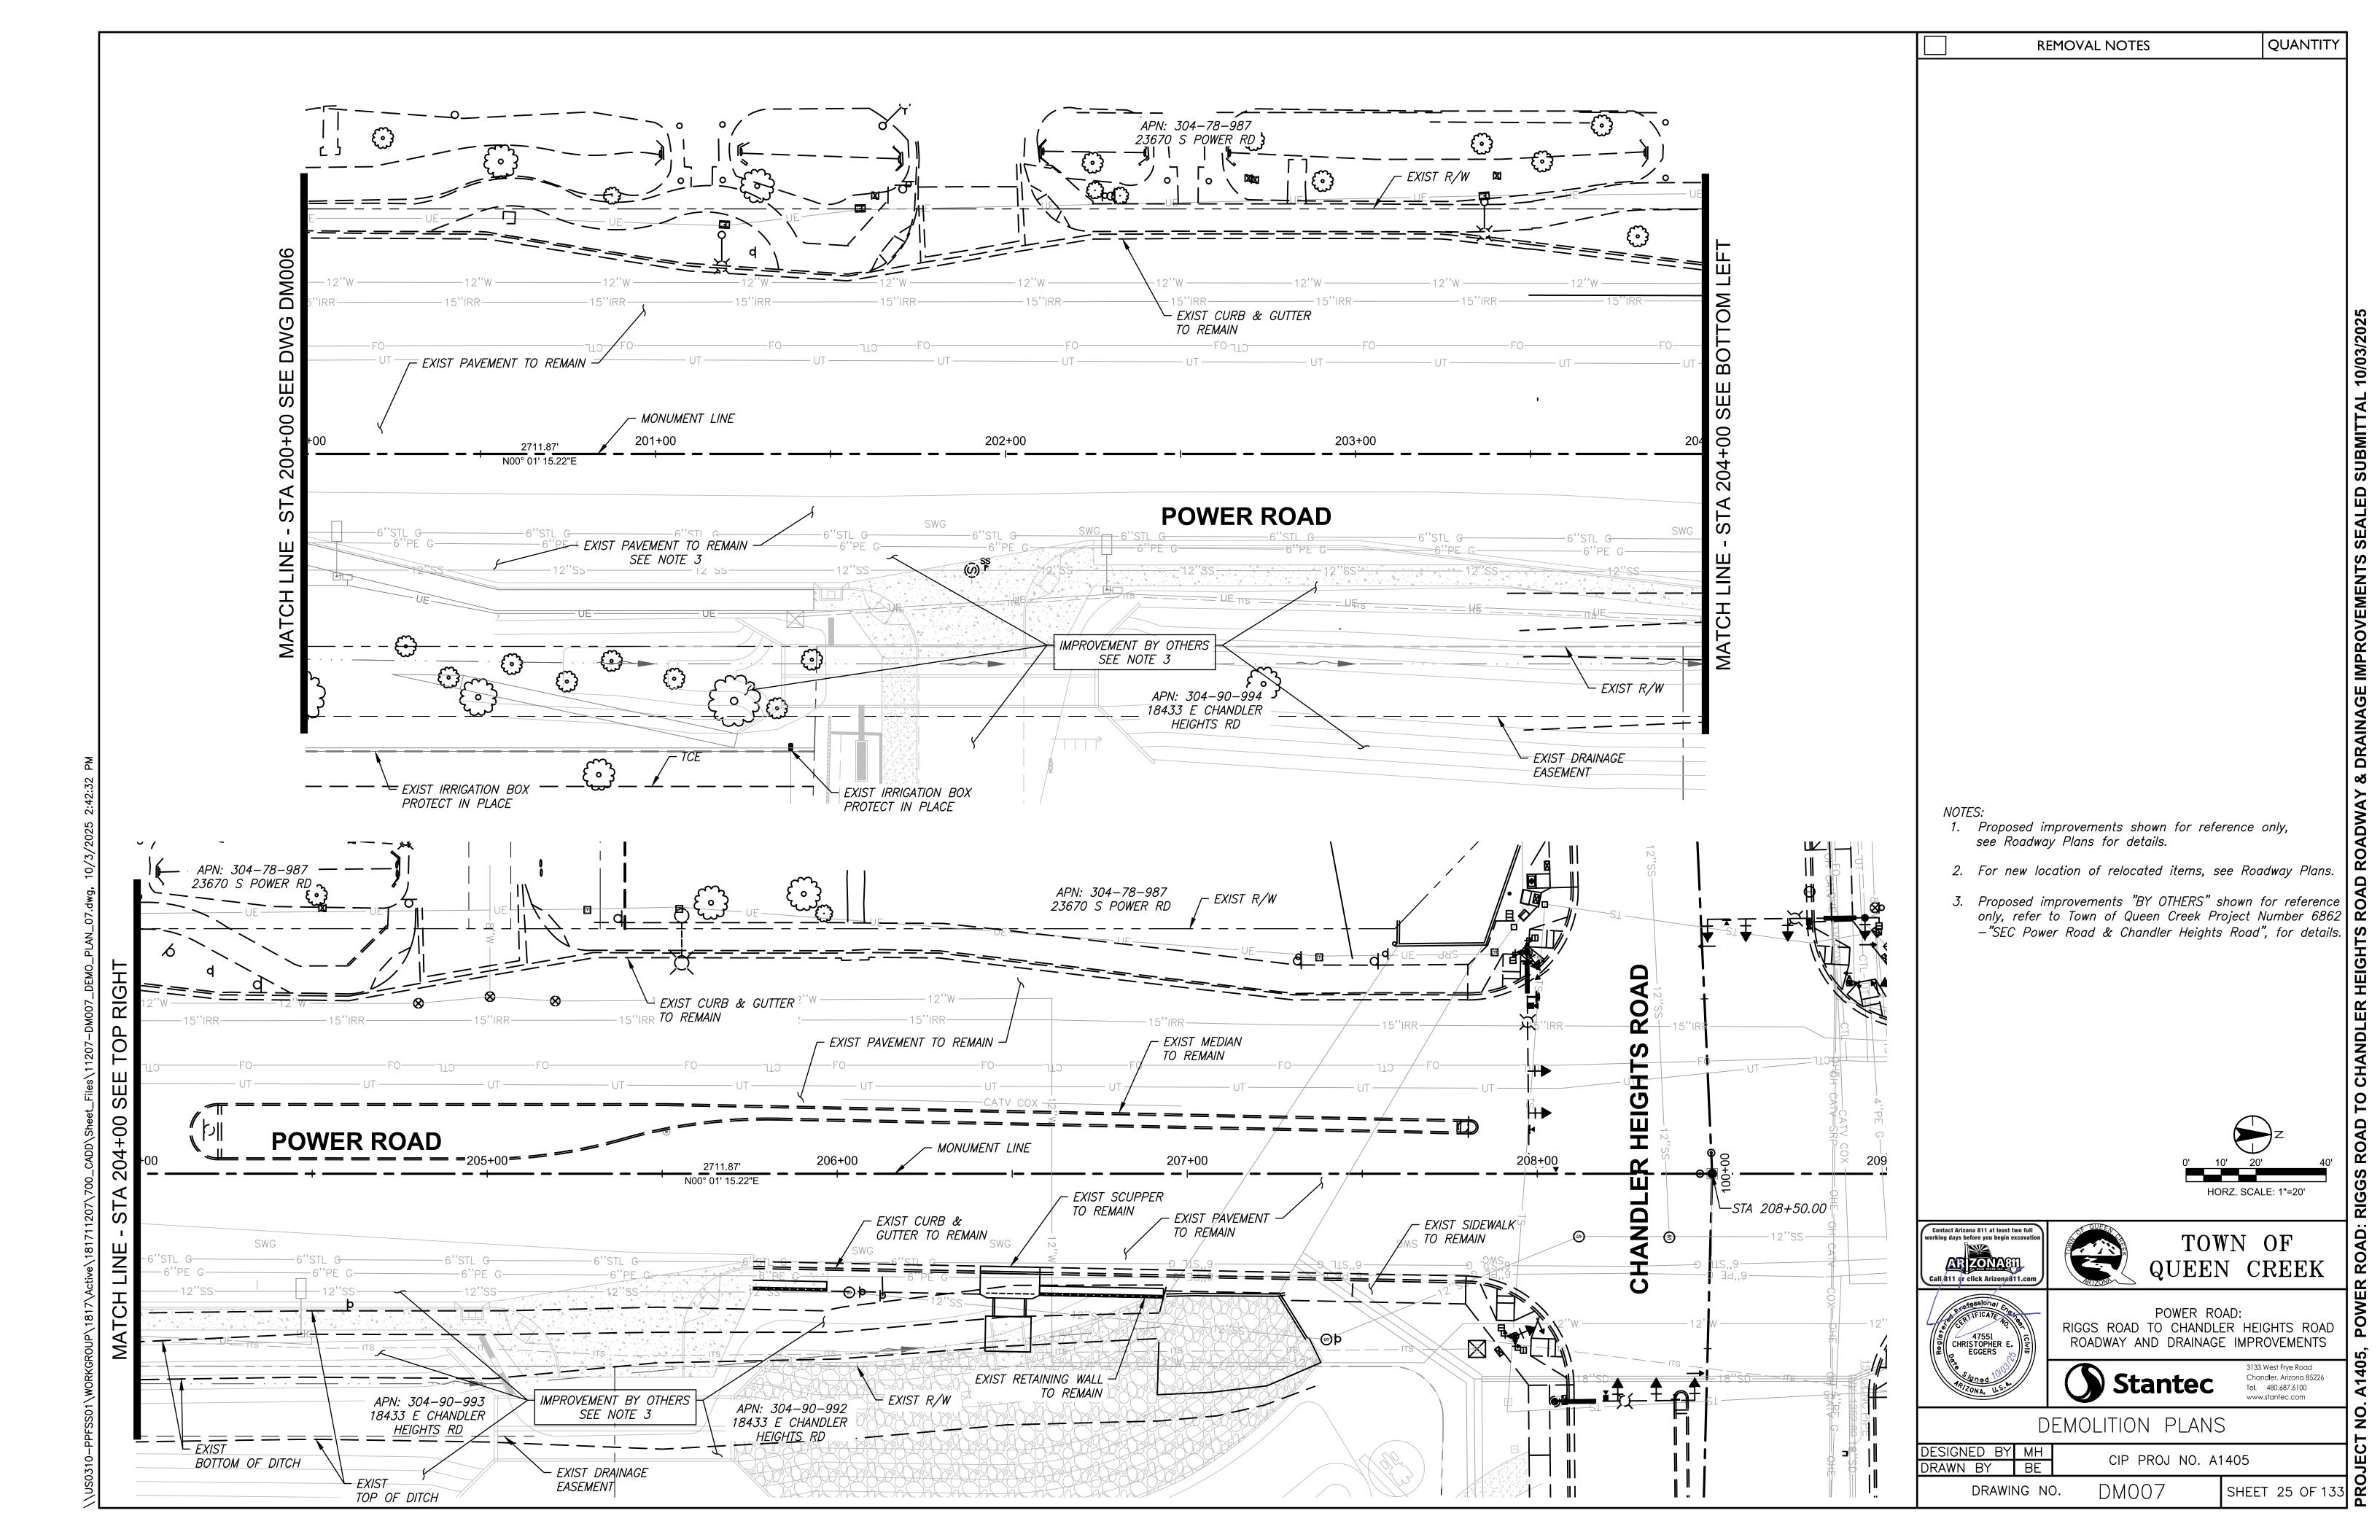

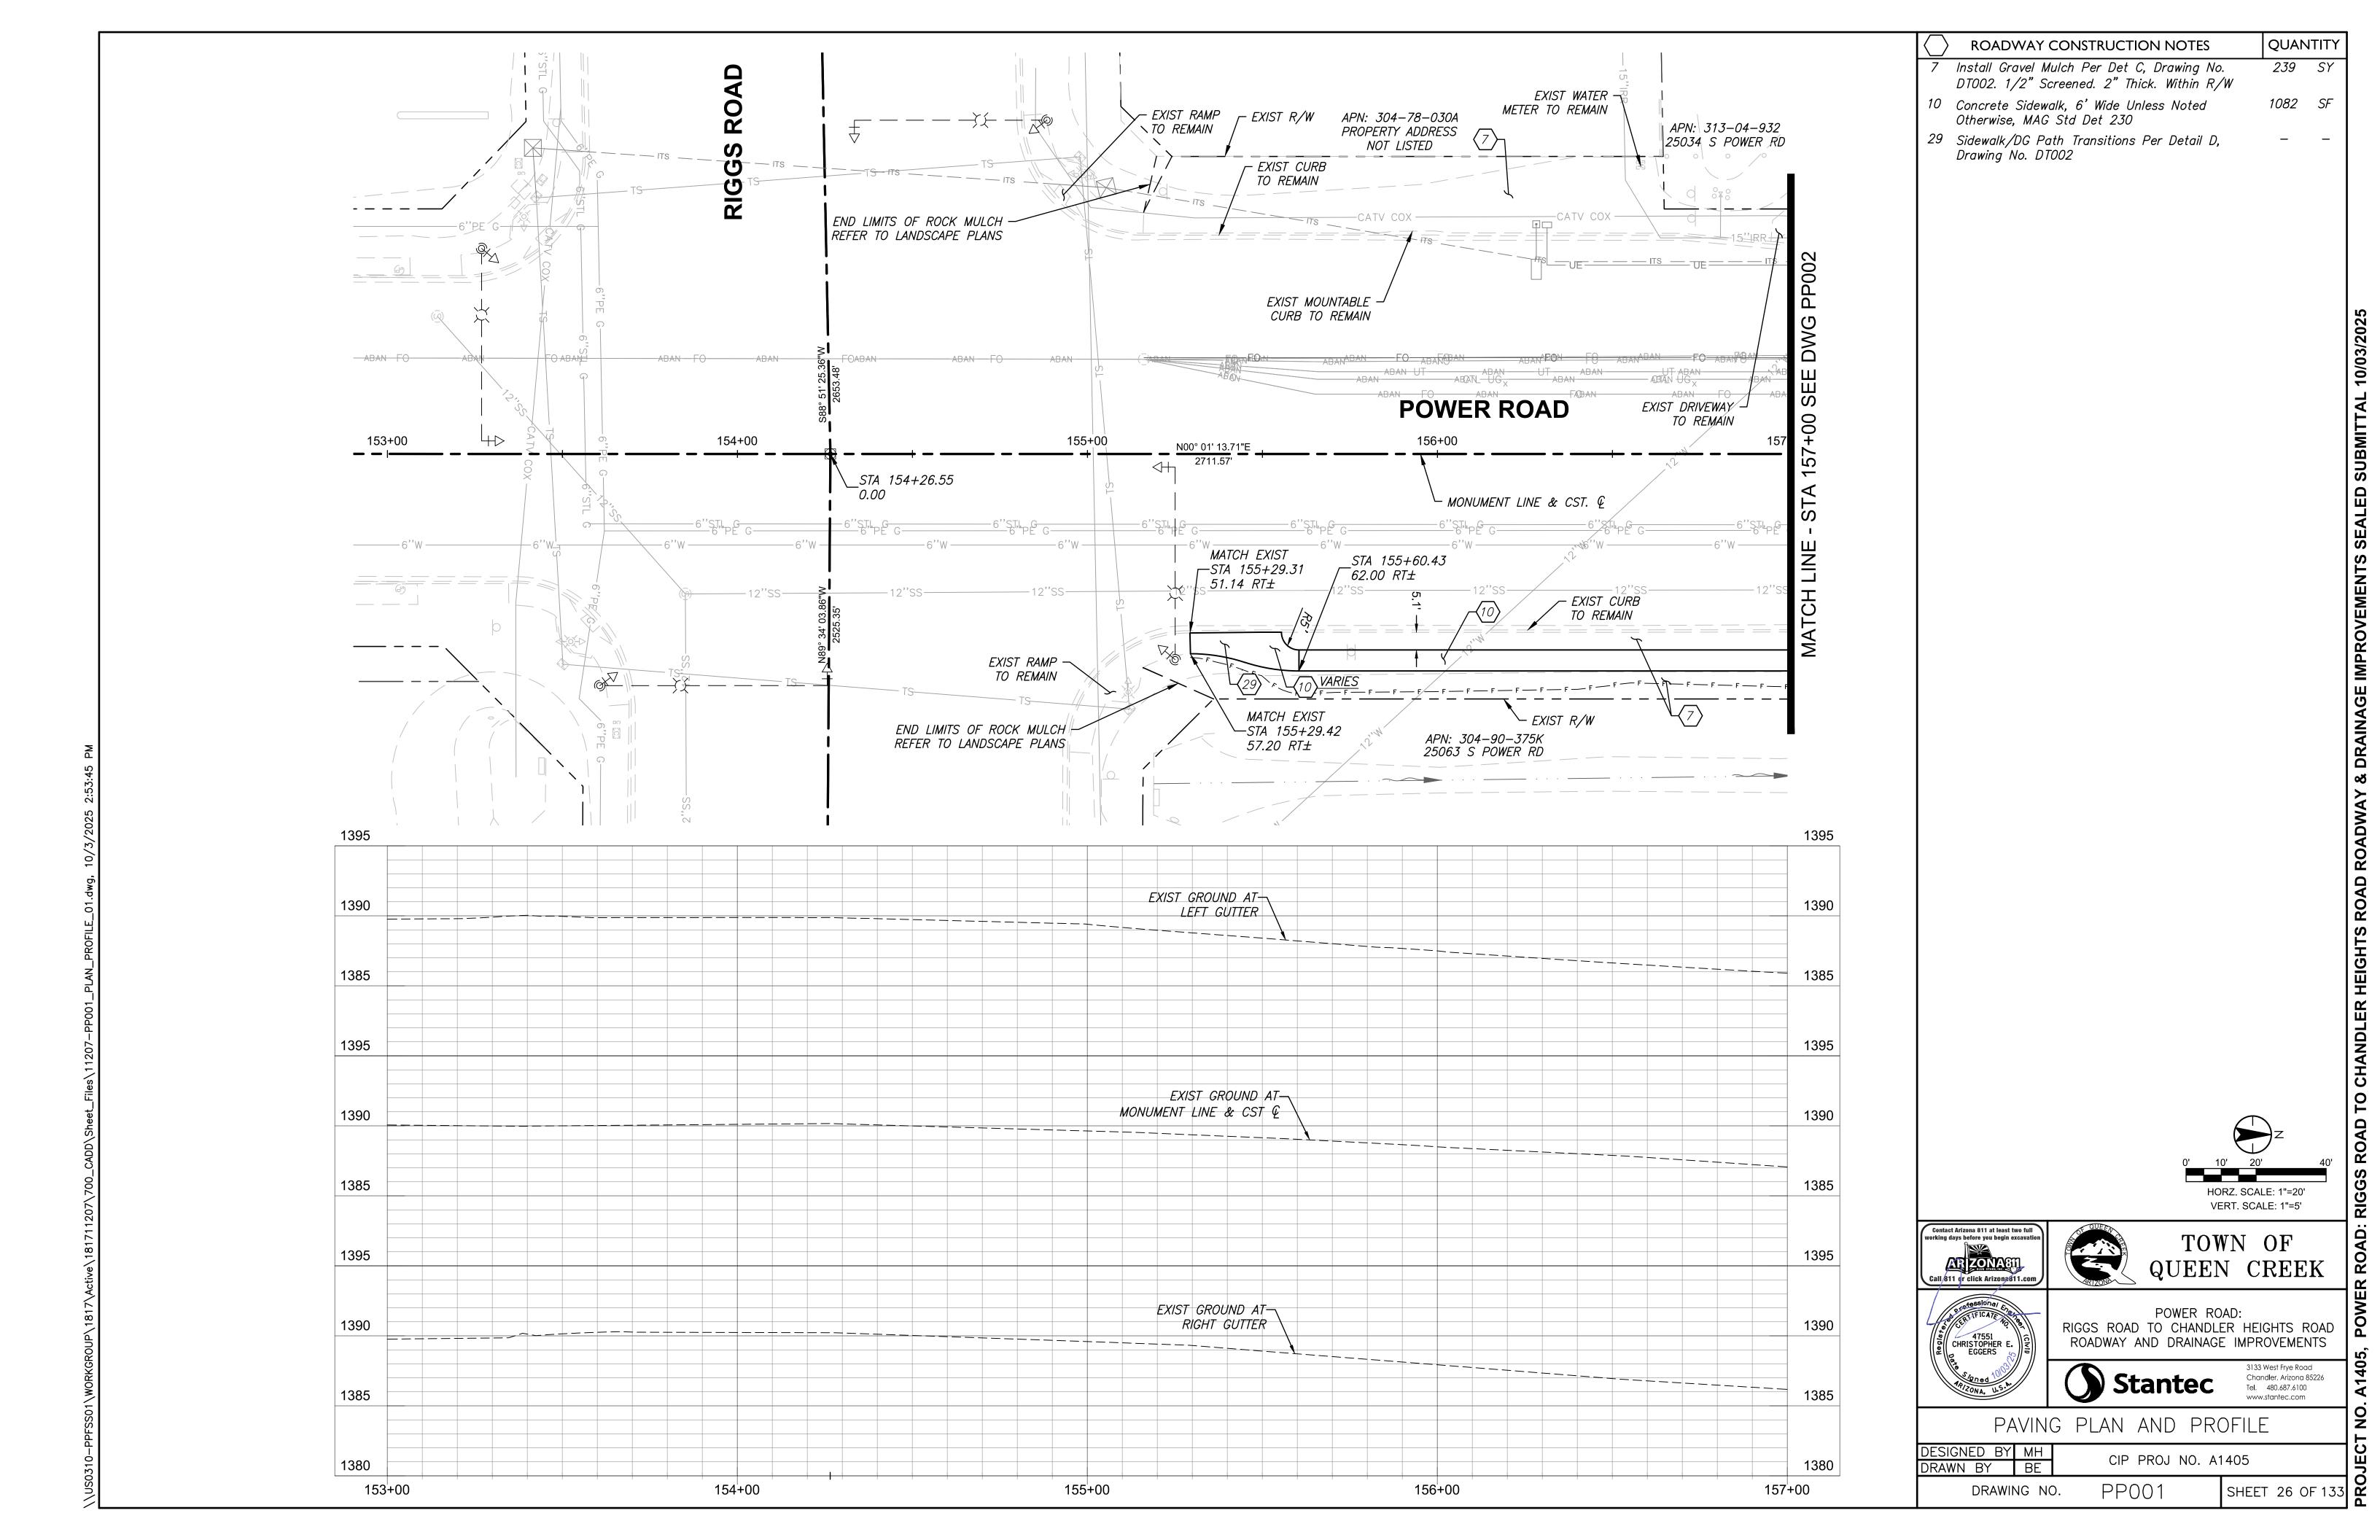

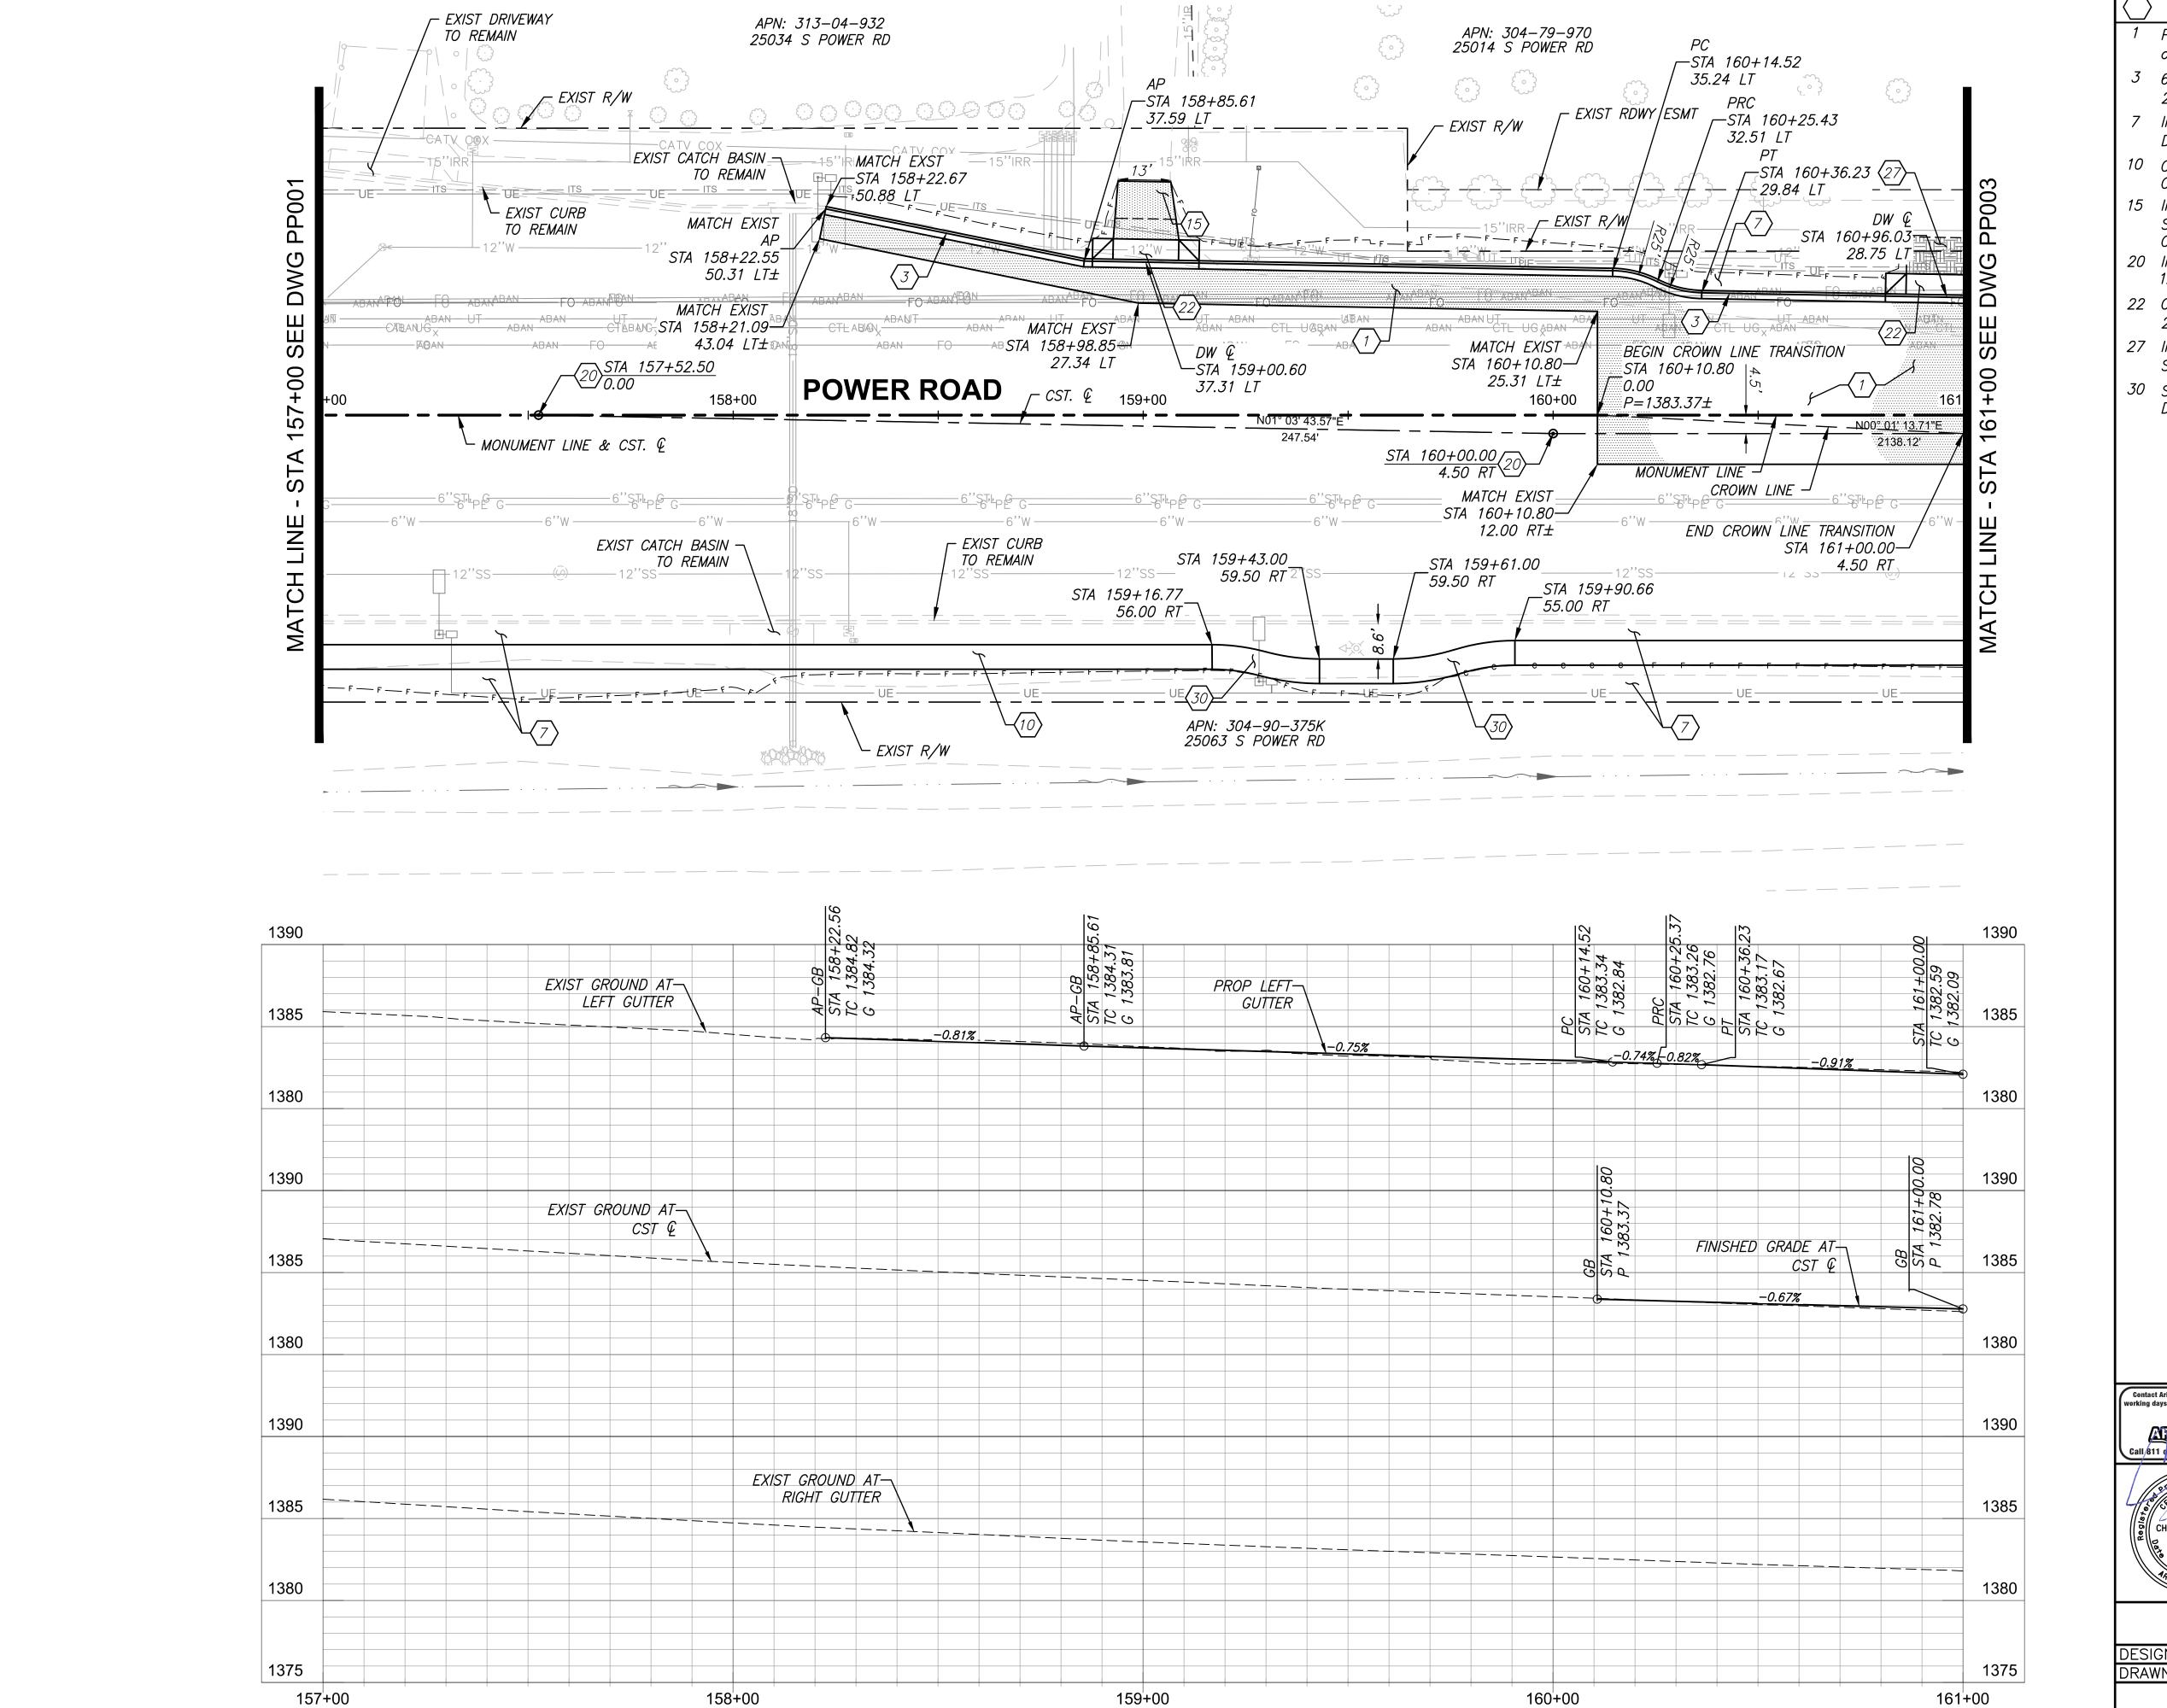

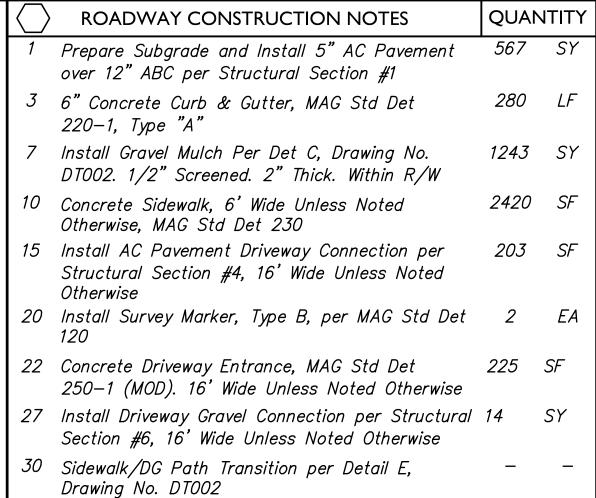








POWER ROAD:
RIGGS ROAD TO CHANDLER HEIGHTS ROAD ROADWAY AND DRAINAGE IMPROVEMENTS


Tel. 480.687.6100


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PAVING PLAN AND PROFILE

SHEET 27 OF 133



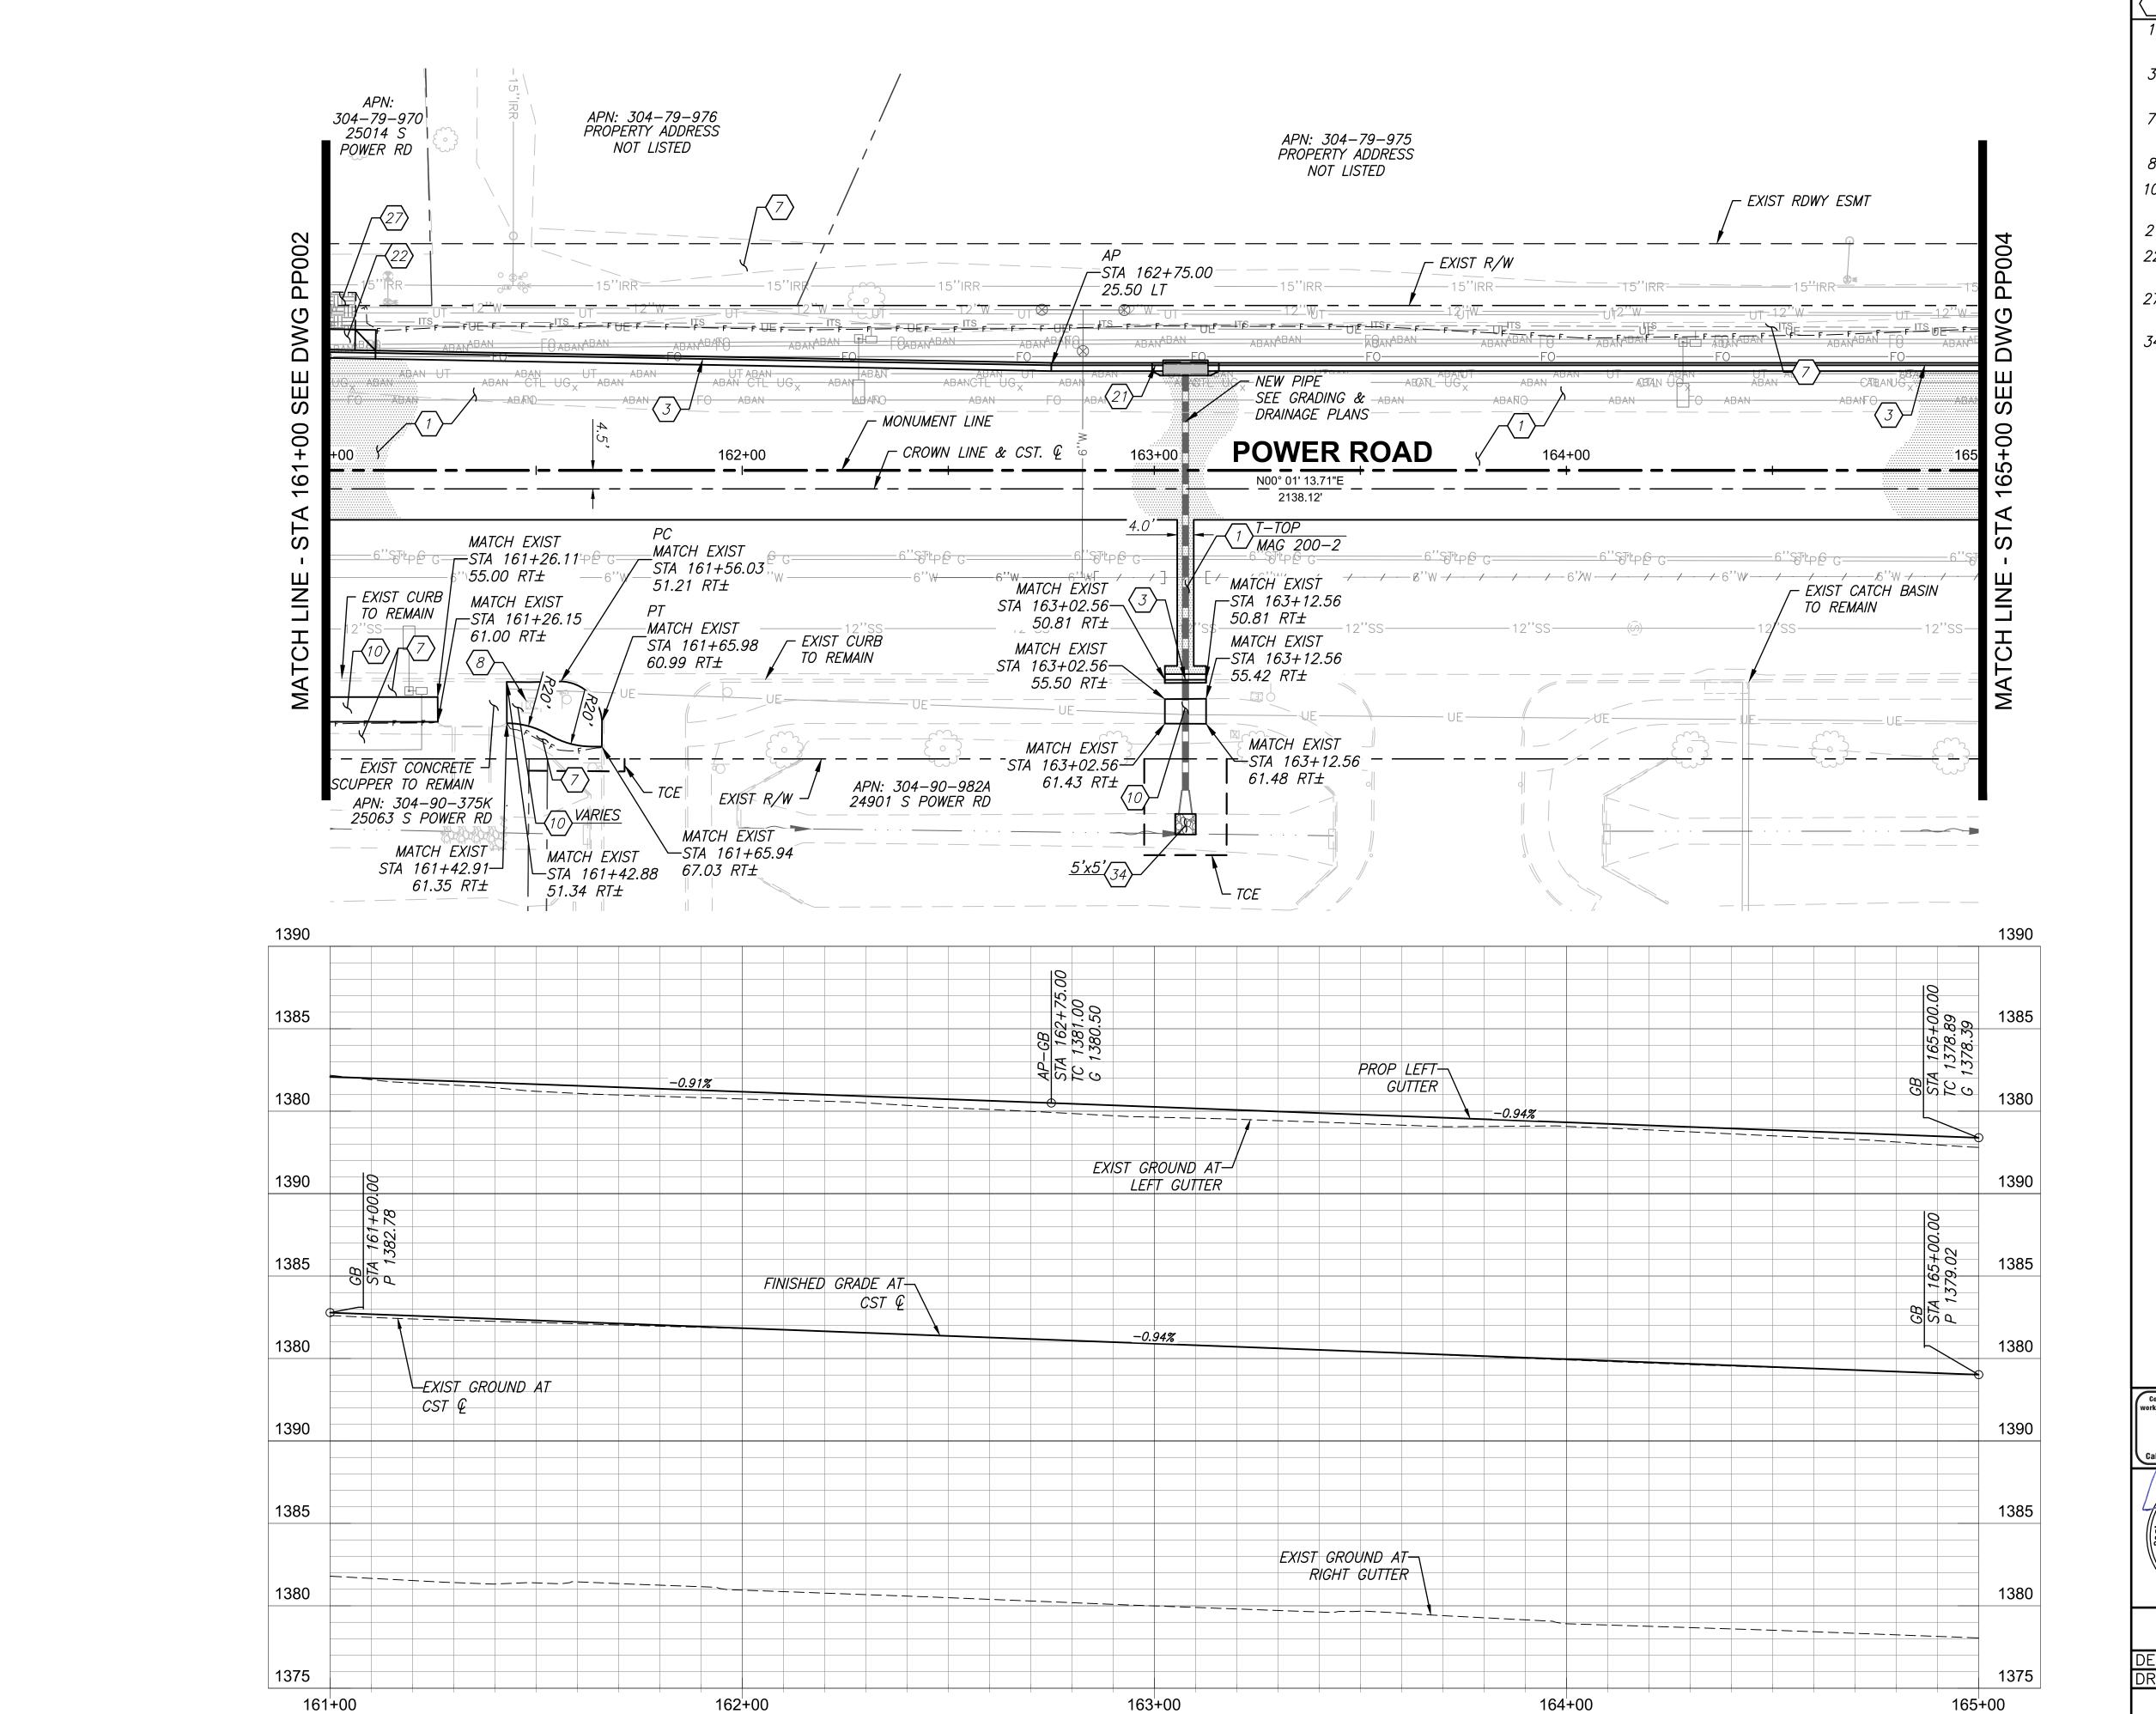

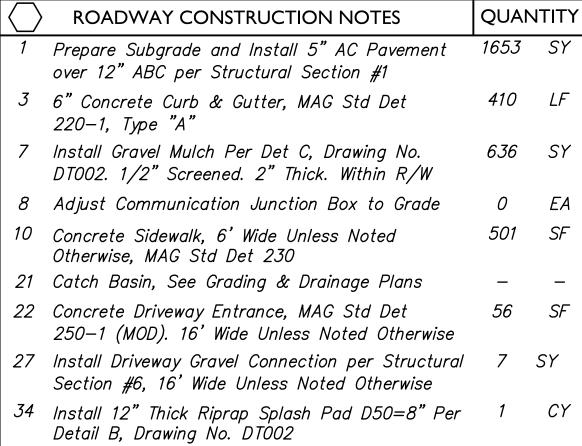

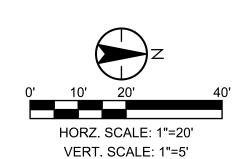



TOWN OF




POWER ROAD: RIGGS ROAD TO CHANDLER HEIGHTS ROAD ROADWAY AND DRAINAGE IMPROVEMENTS


Chandler, Arizona 85226 Tel. 480.687.6100


PAVING PLAN AND PROFILE


DESIGNED BY MH CIP PROJ NO. A1405 DRAWN BY SHEET 28 OF 133 DRAWING NO.

PP003

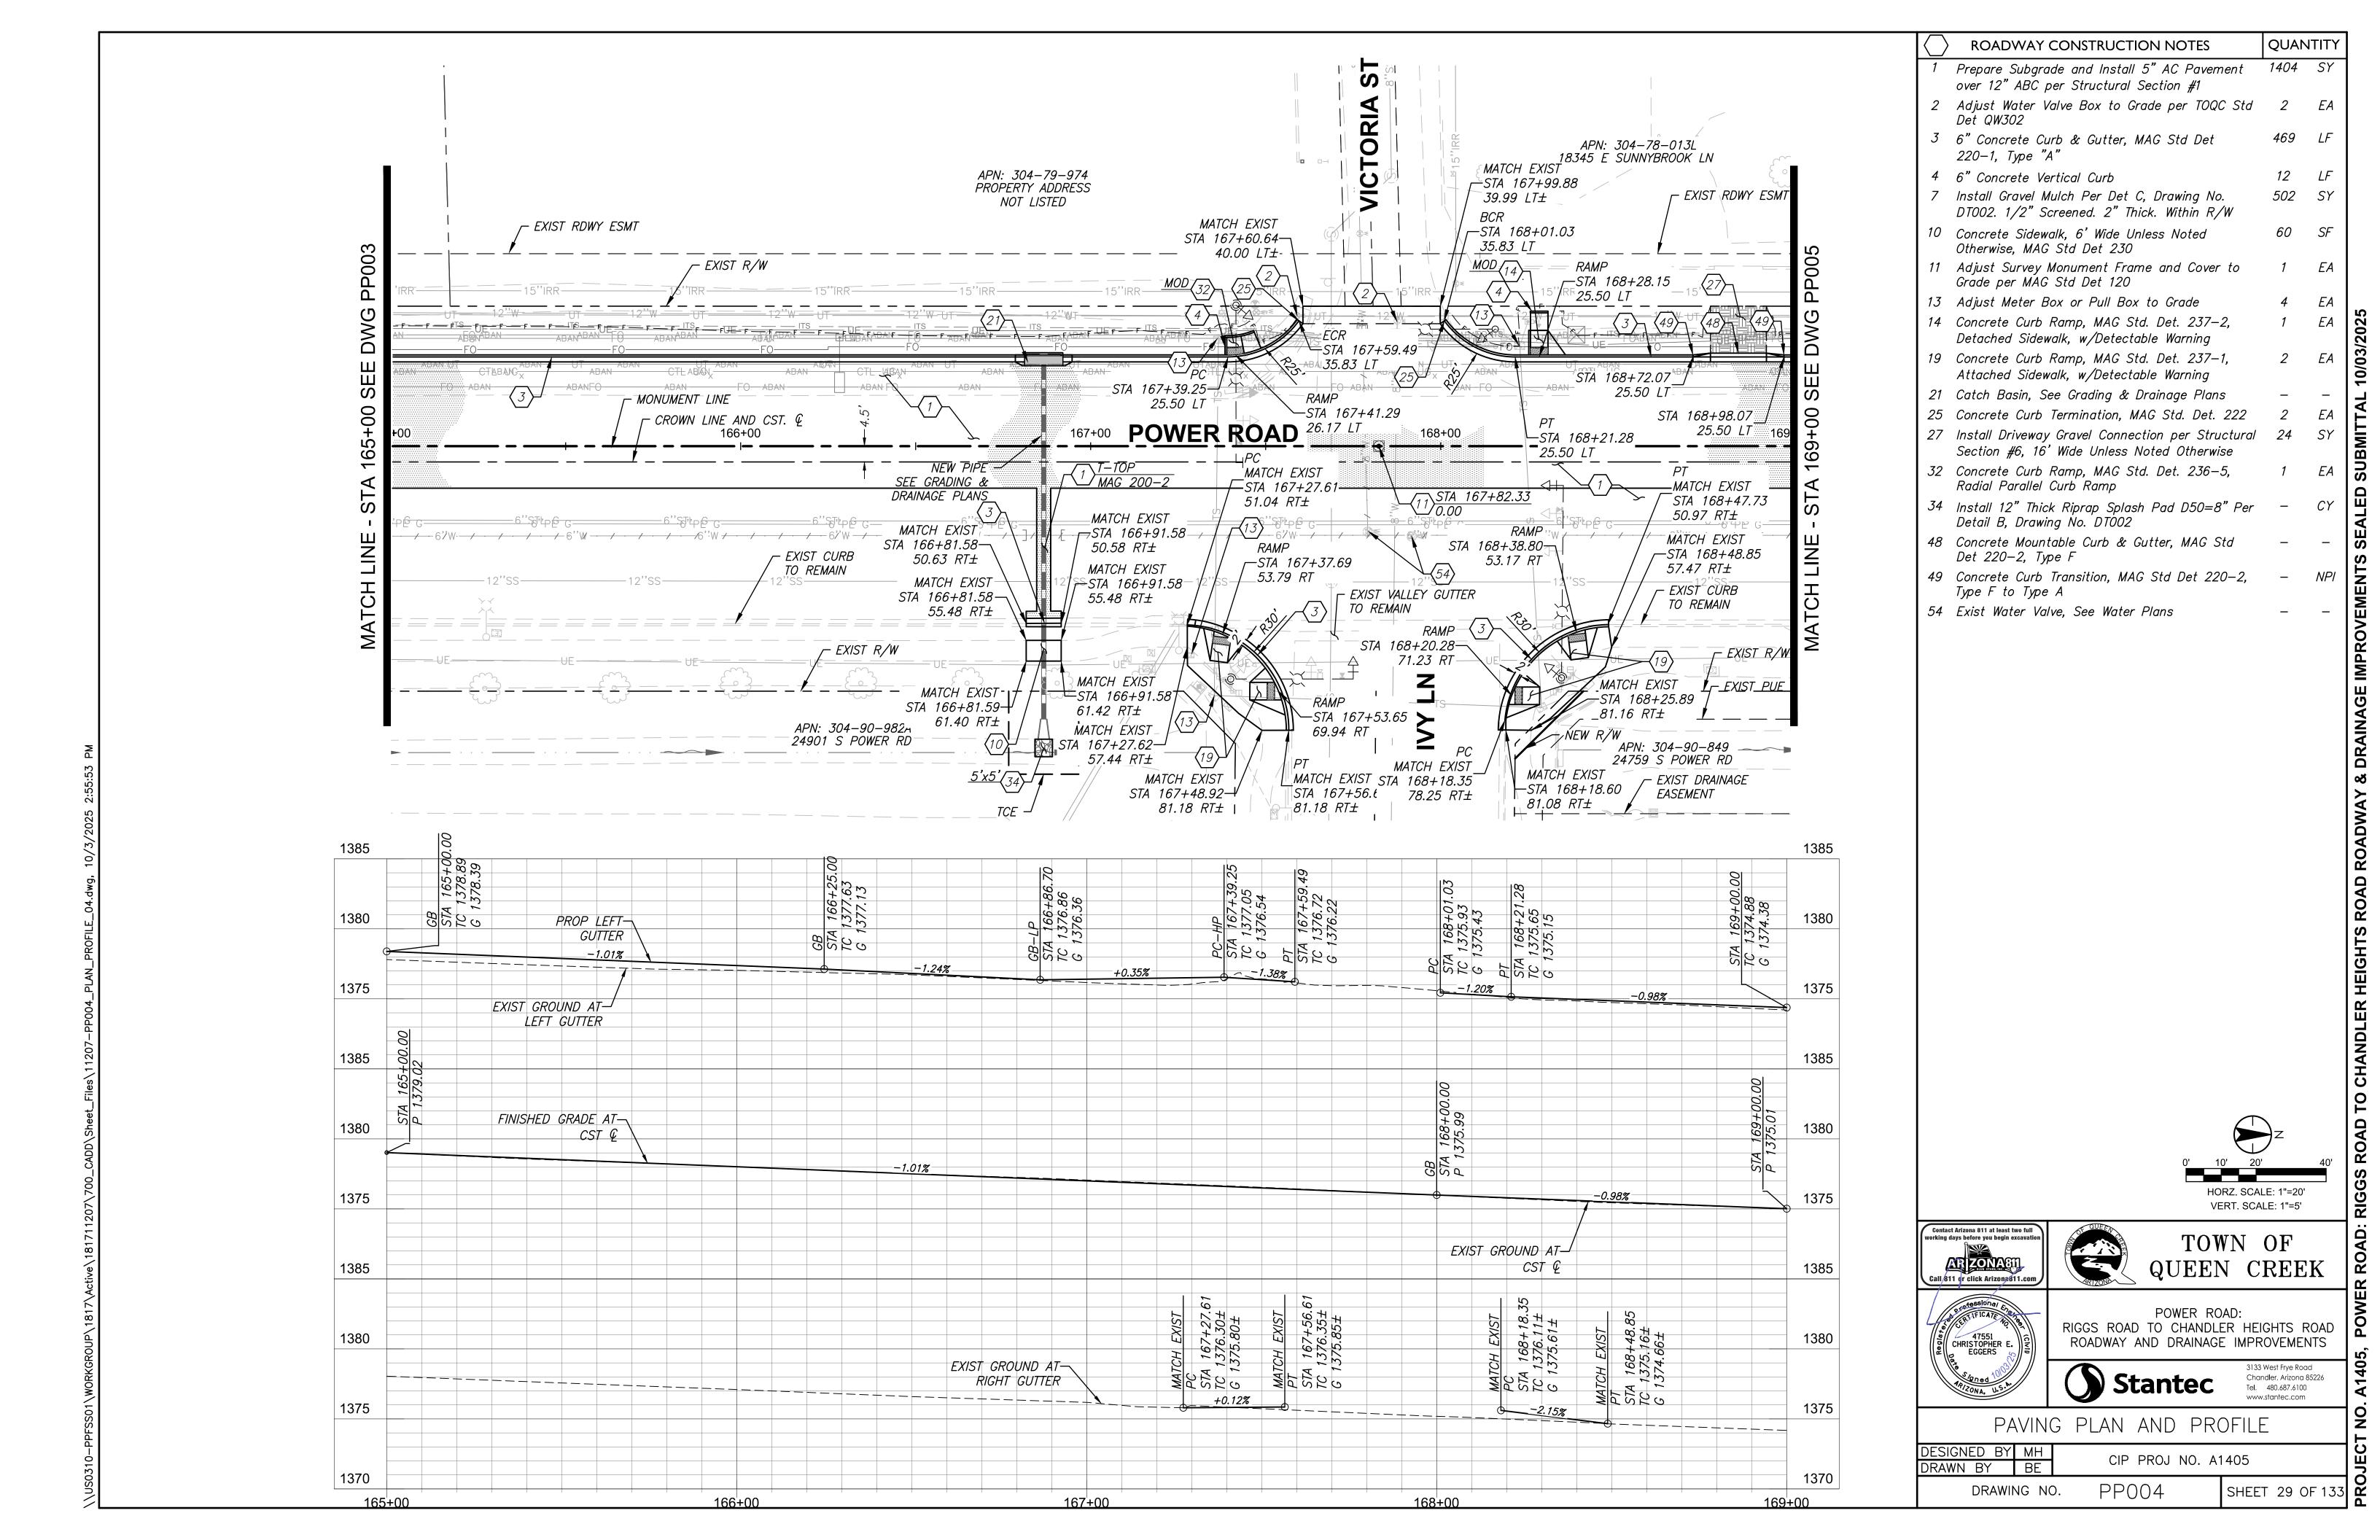

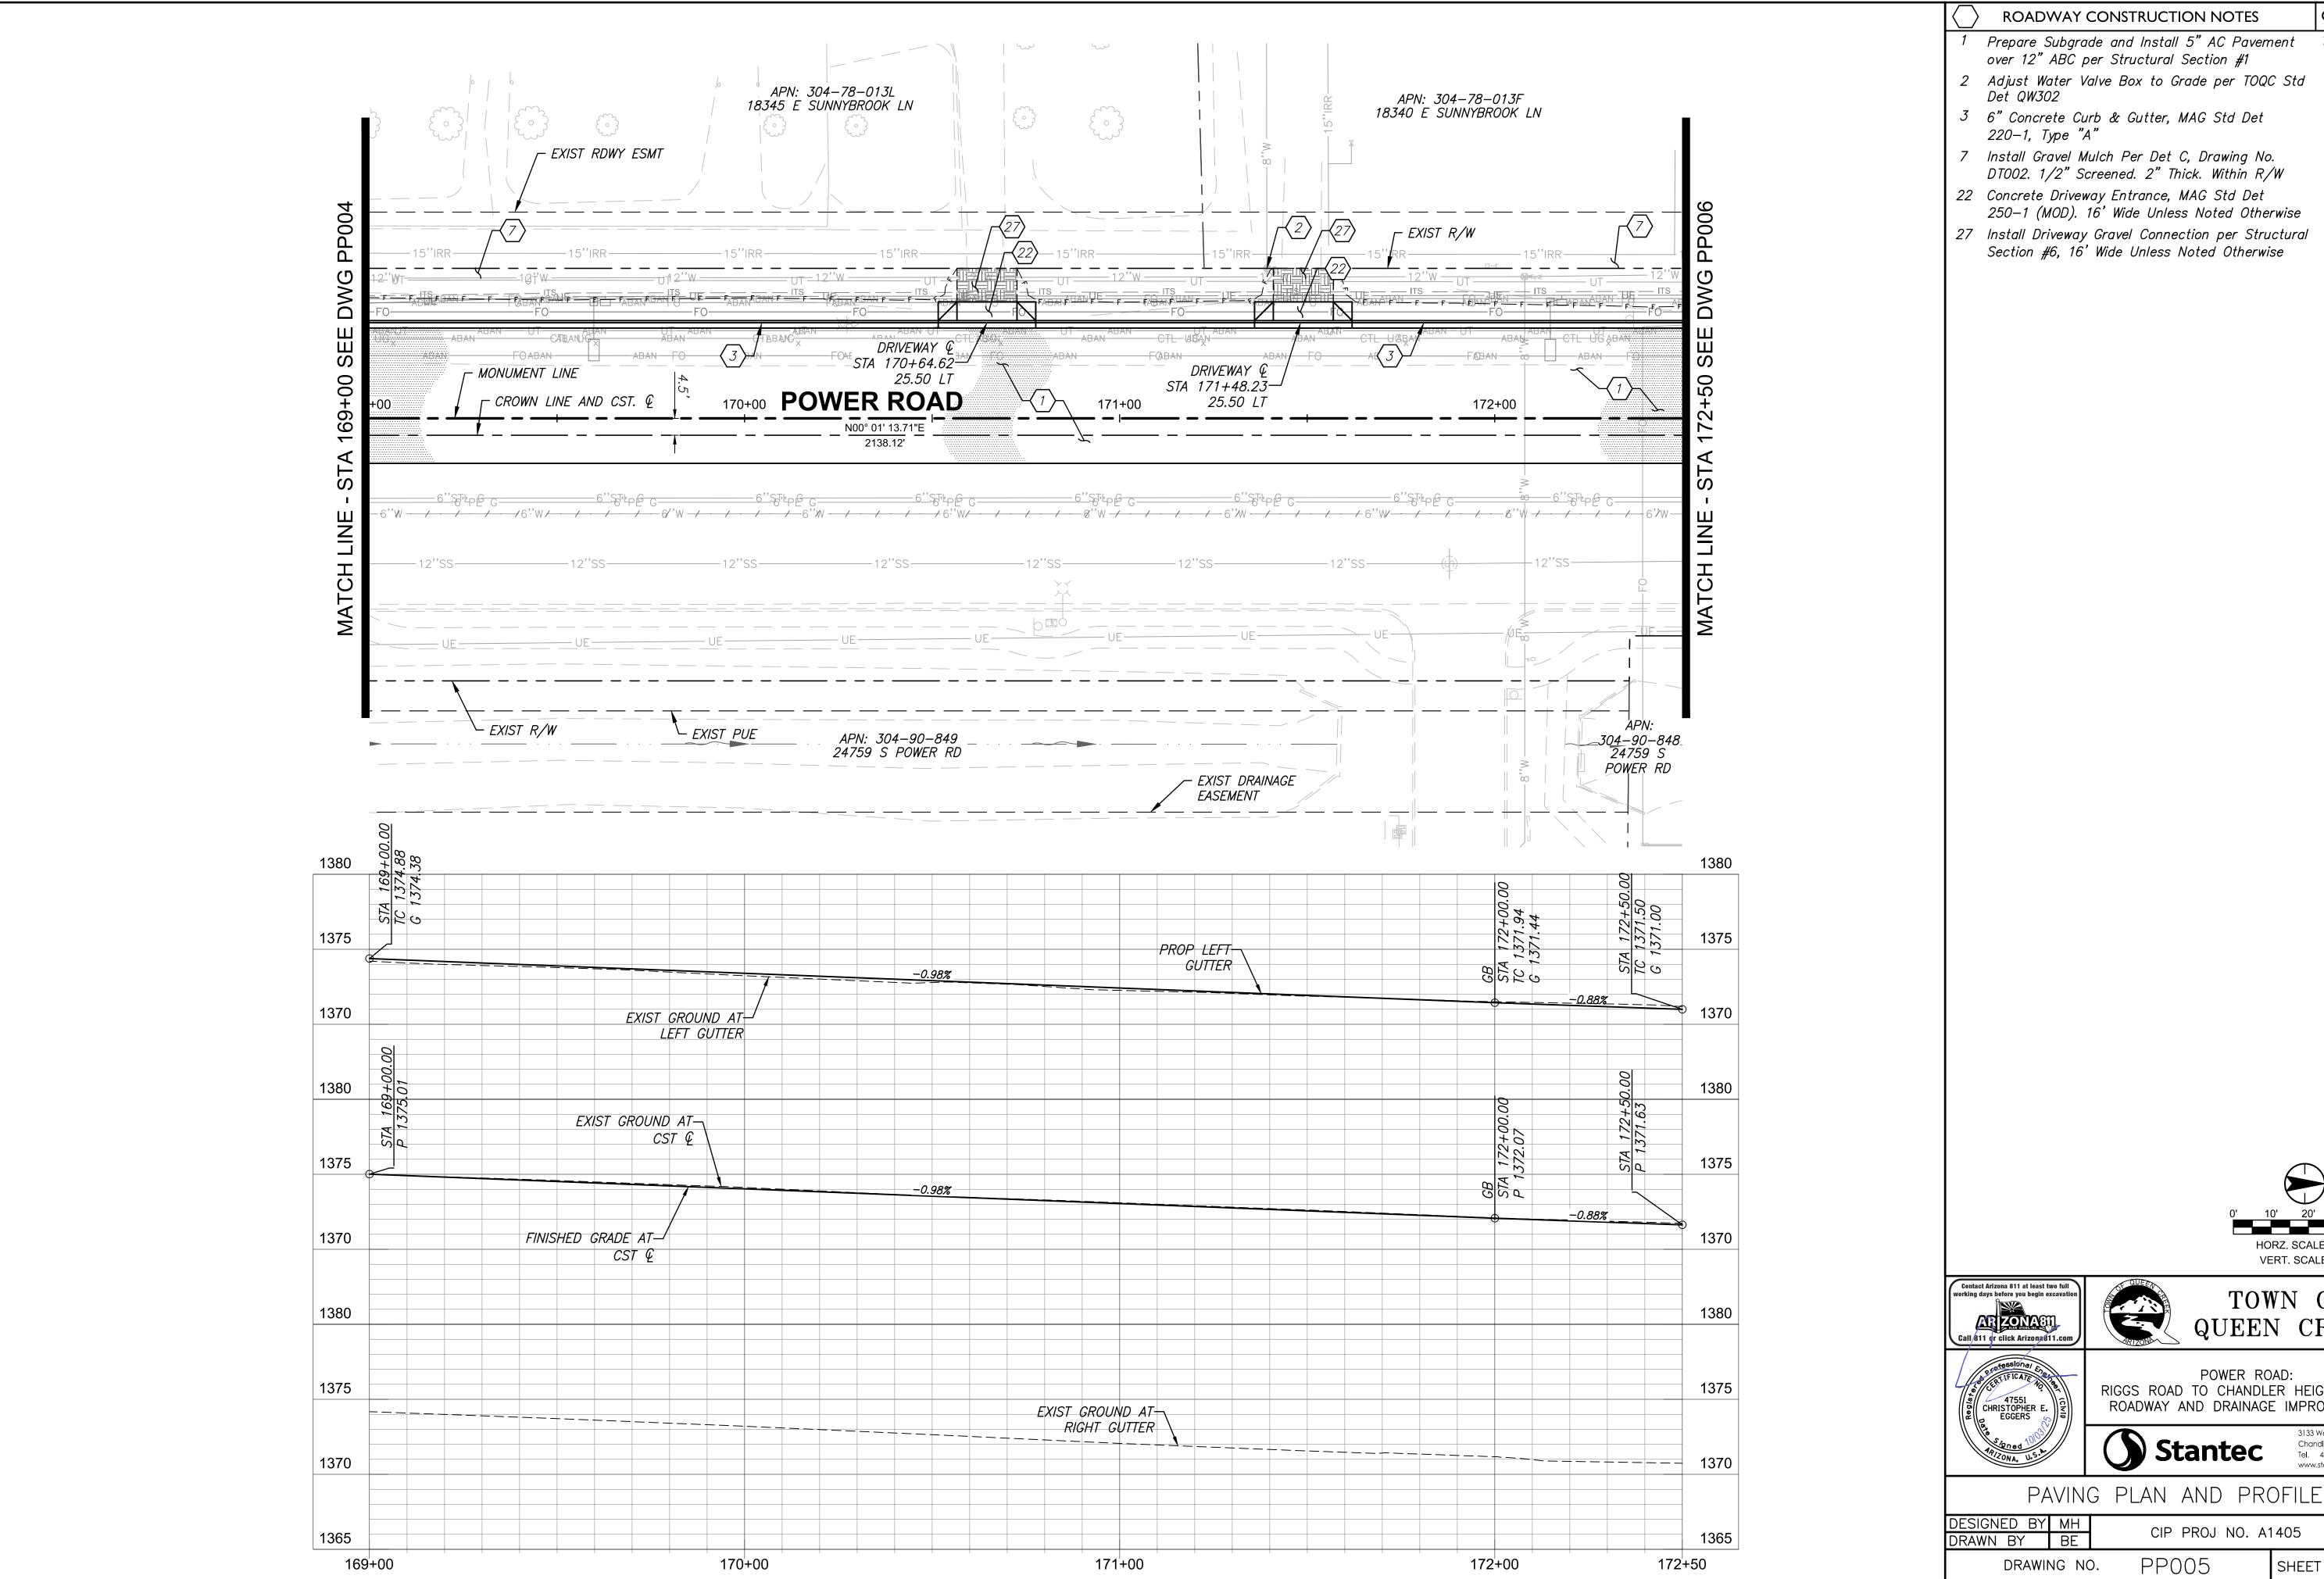

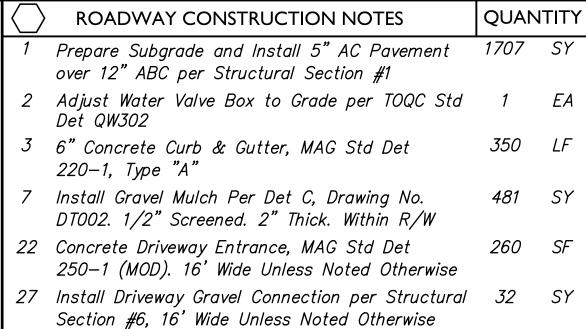

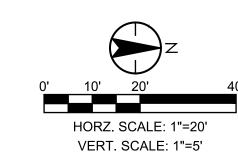





TOWN OF


POWER ROAD: RIGGS ROAD TO CHANDLER HEIGHTS ROAD ROADWAY AND DRAINAGE IMPROVEMENTS


Chandler, Arizona 85226 Tel. 480.687.6100 www.stantec.com


CIP PROJ NO. A1405

PP005 DRAWING NO.

SHEET 30 OF 133

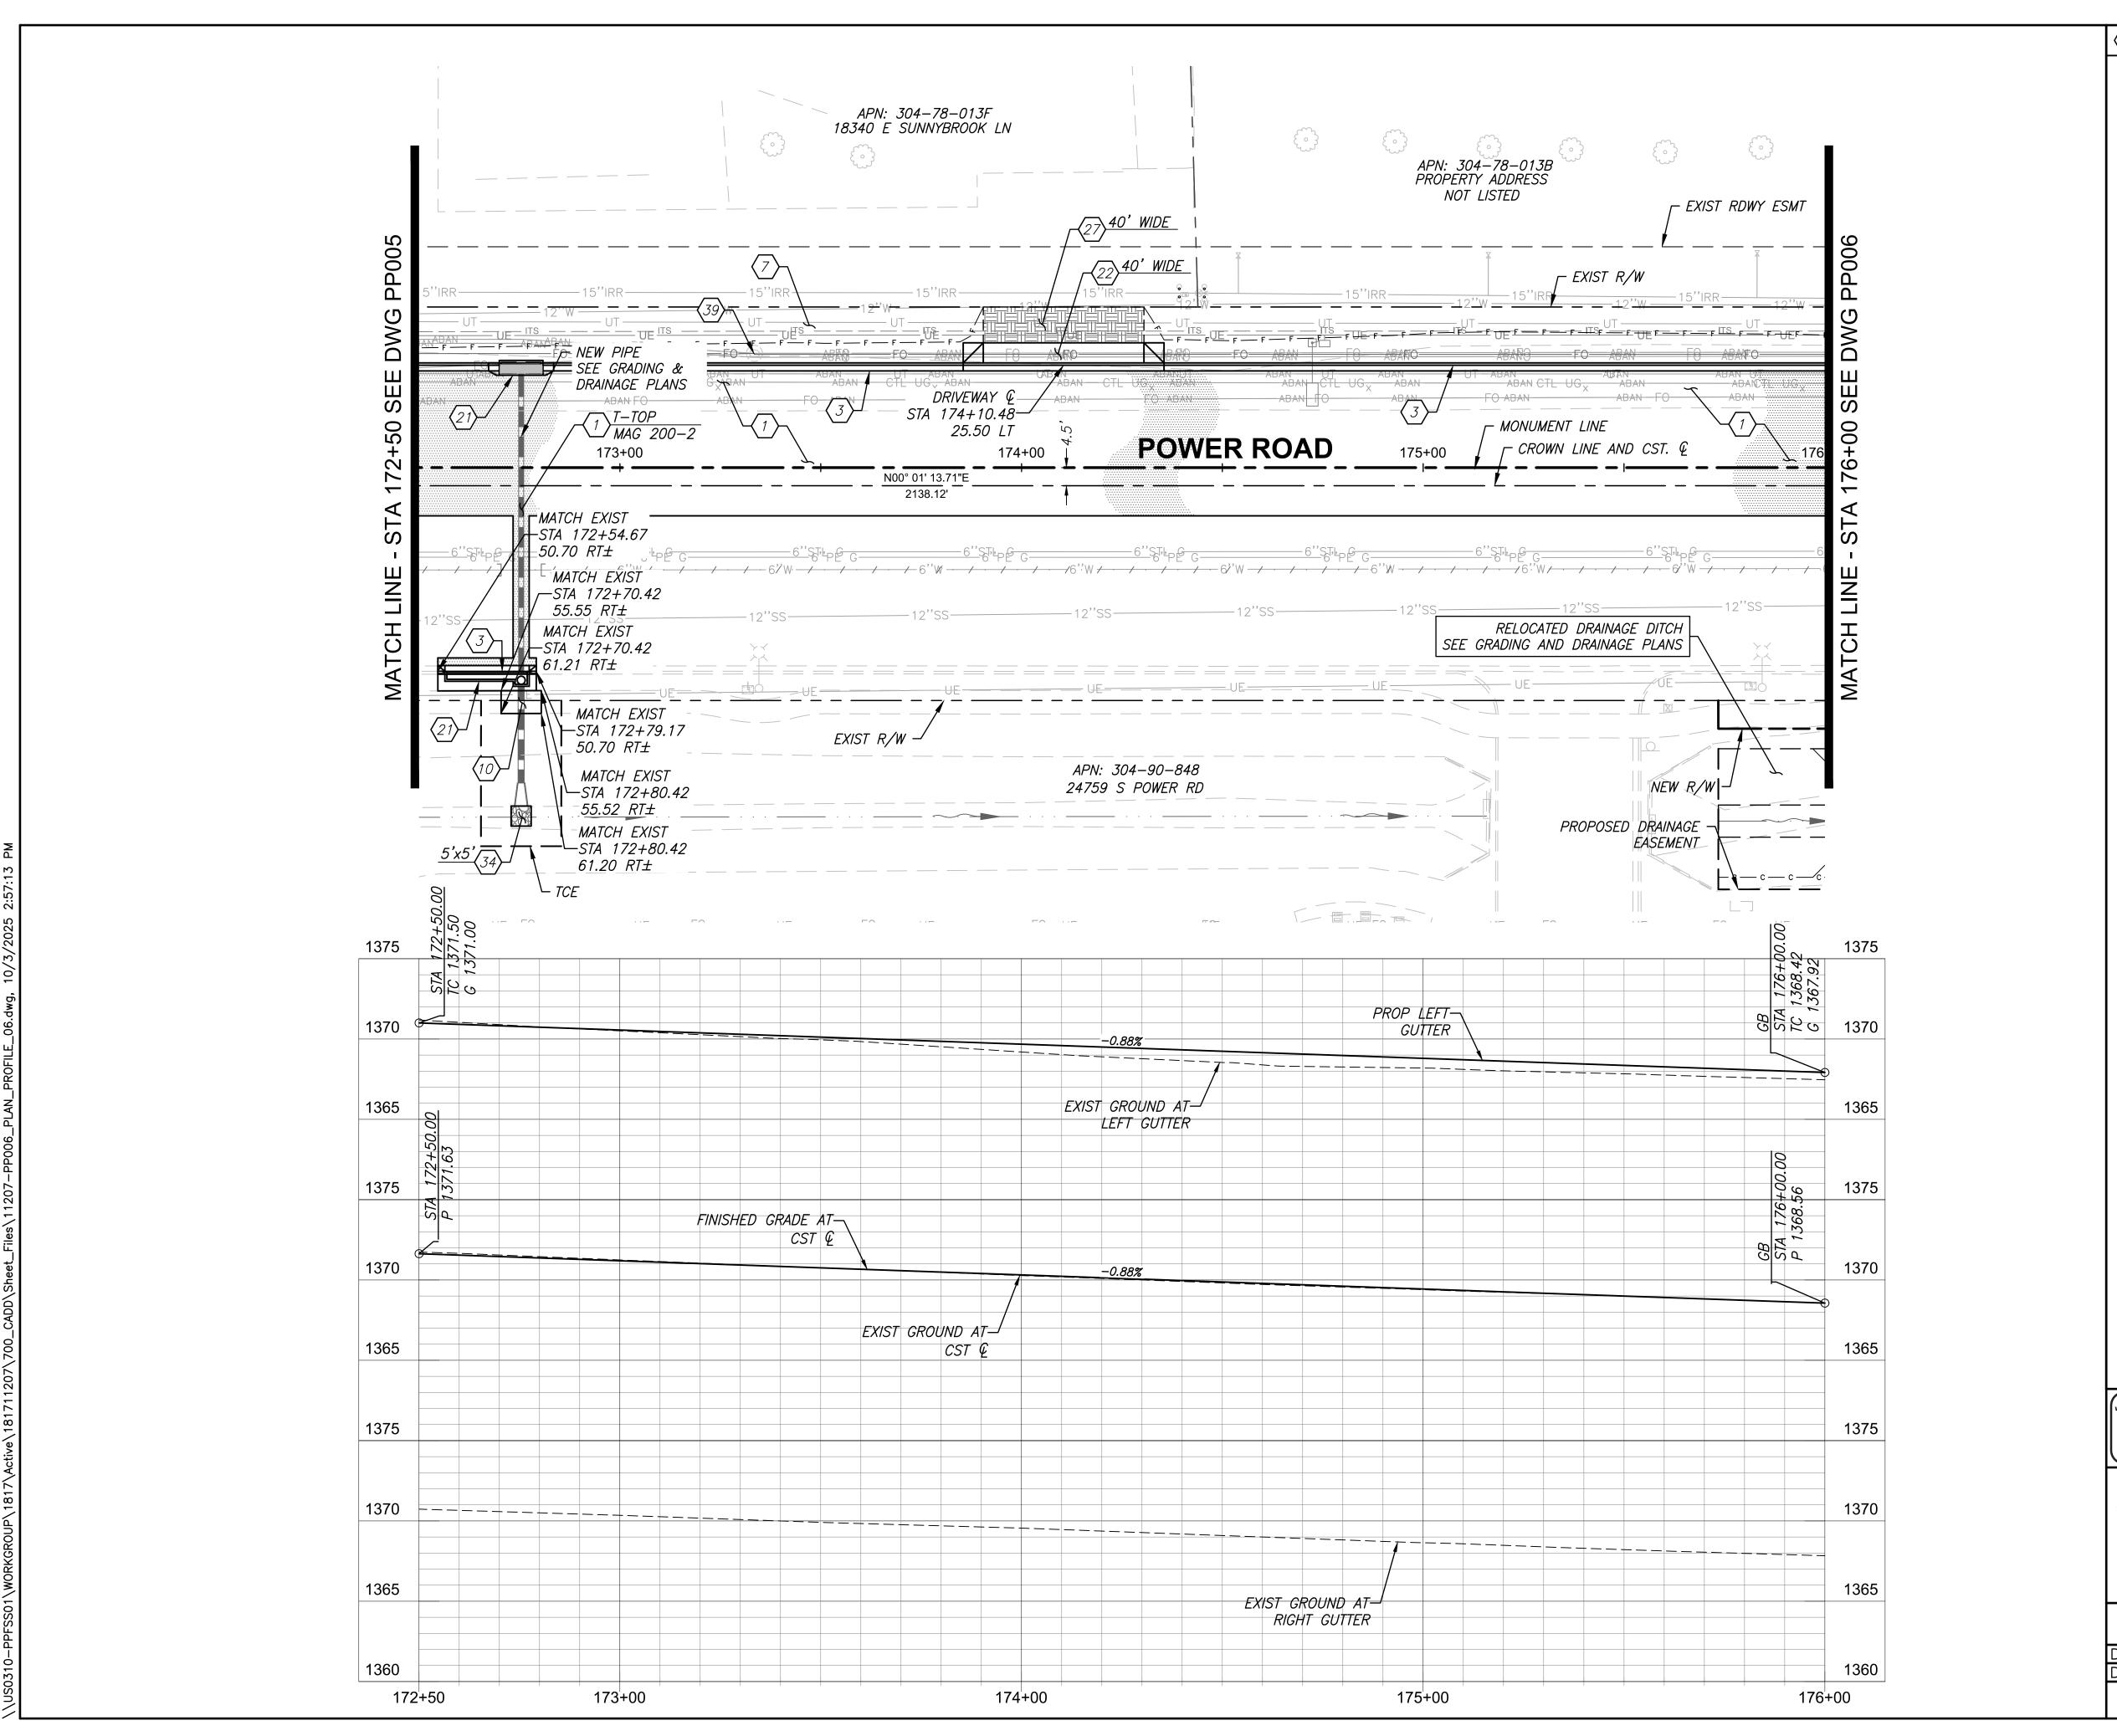

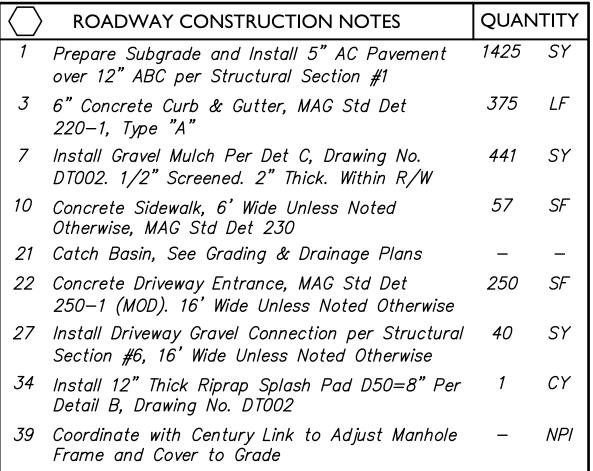

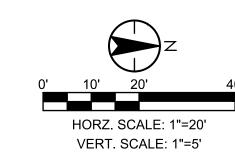





TOWN OF Queen creek



POWER ROAD: RIGGS ROAD TO CHANDLER HEIGHTS ROAD ROADWAY AND DRAINAGE IMPROVEMENTS

Stantec


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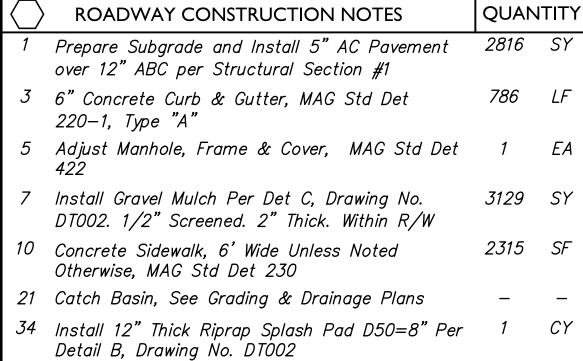
DESIGNED BY MH
DRAWN BY BE


CIP PROJ NO. A1405

DRAWING NO. PP006

SHEET 31 OF 133



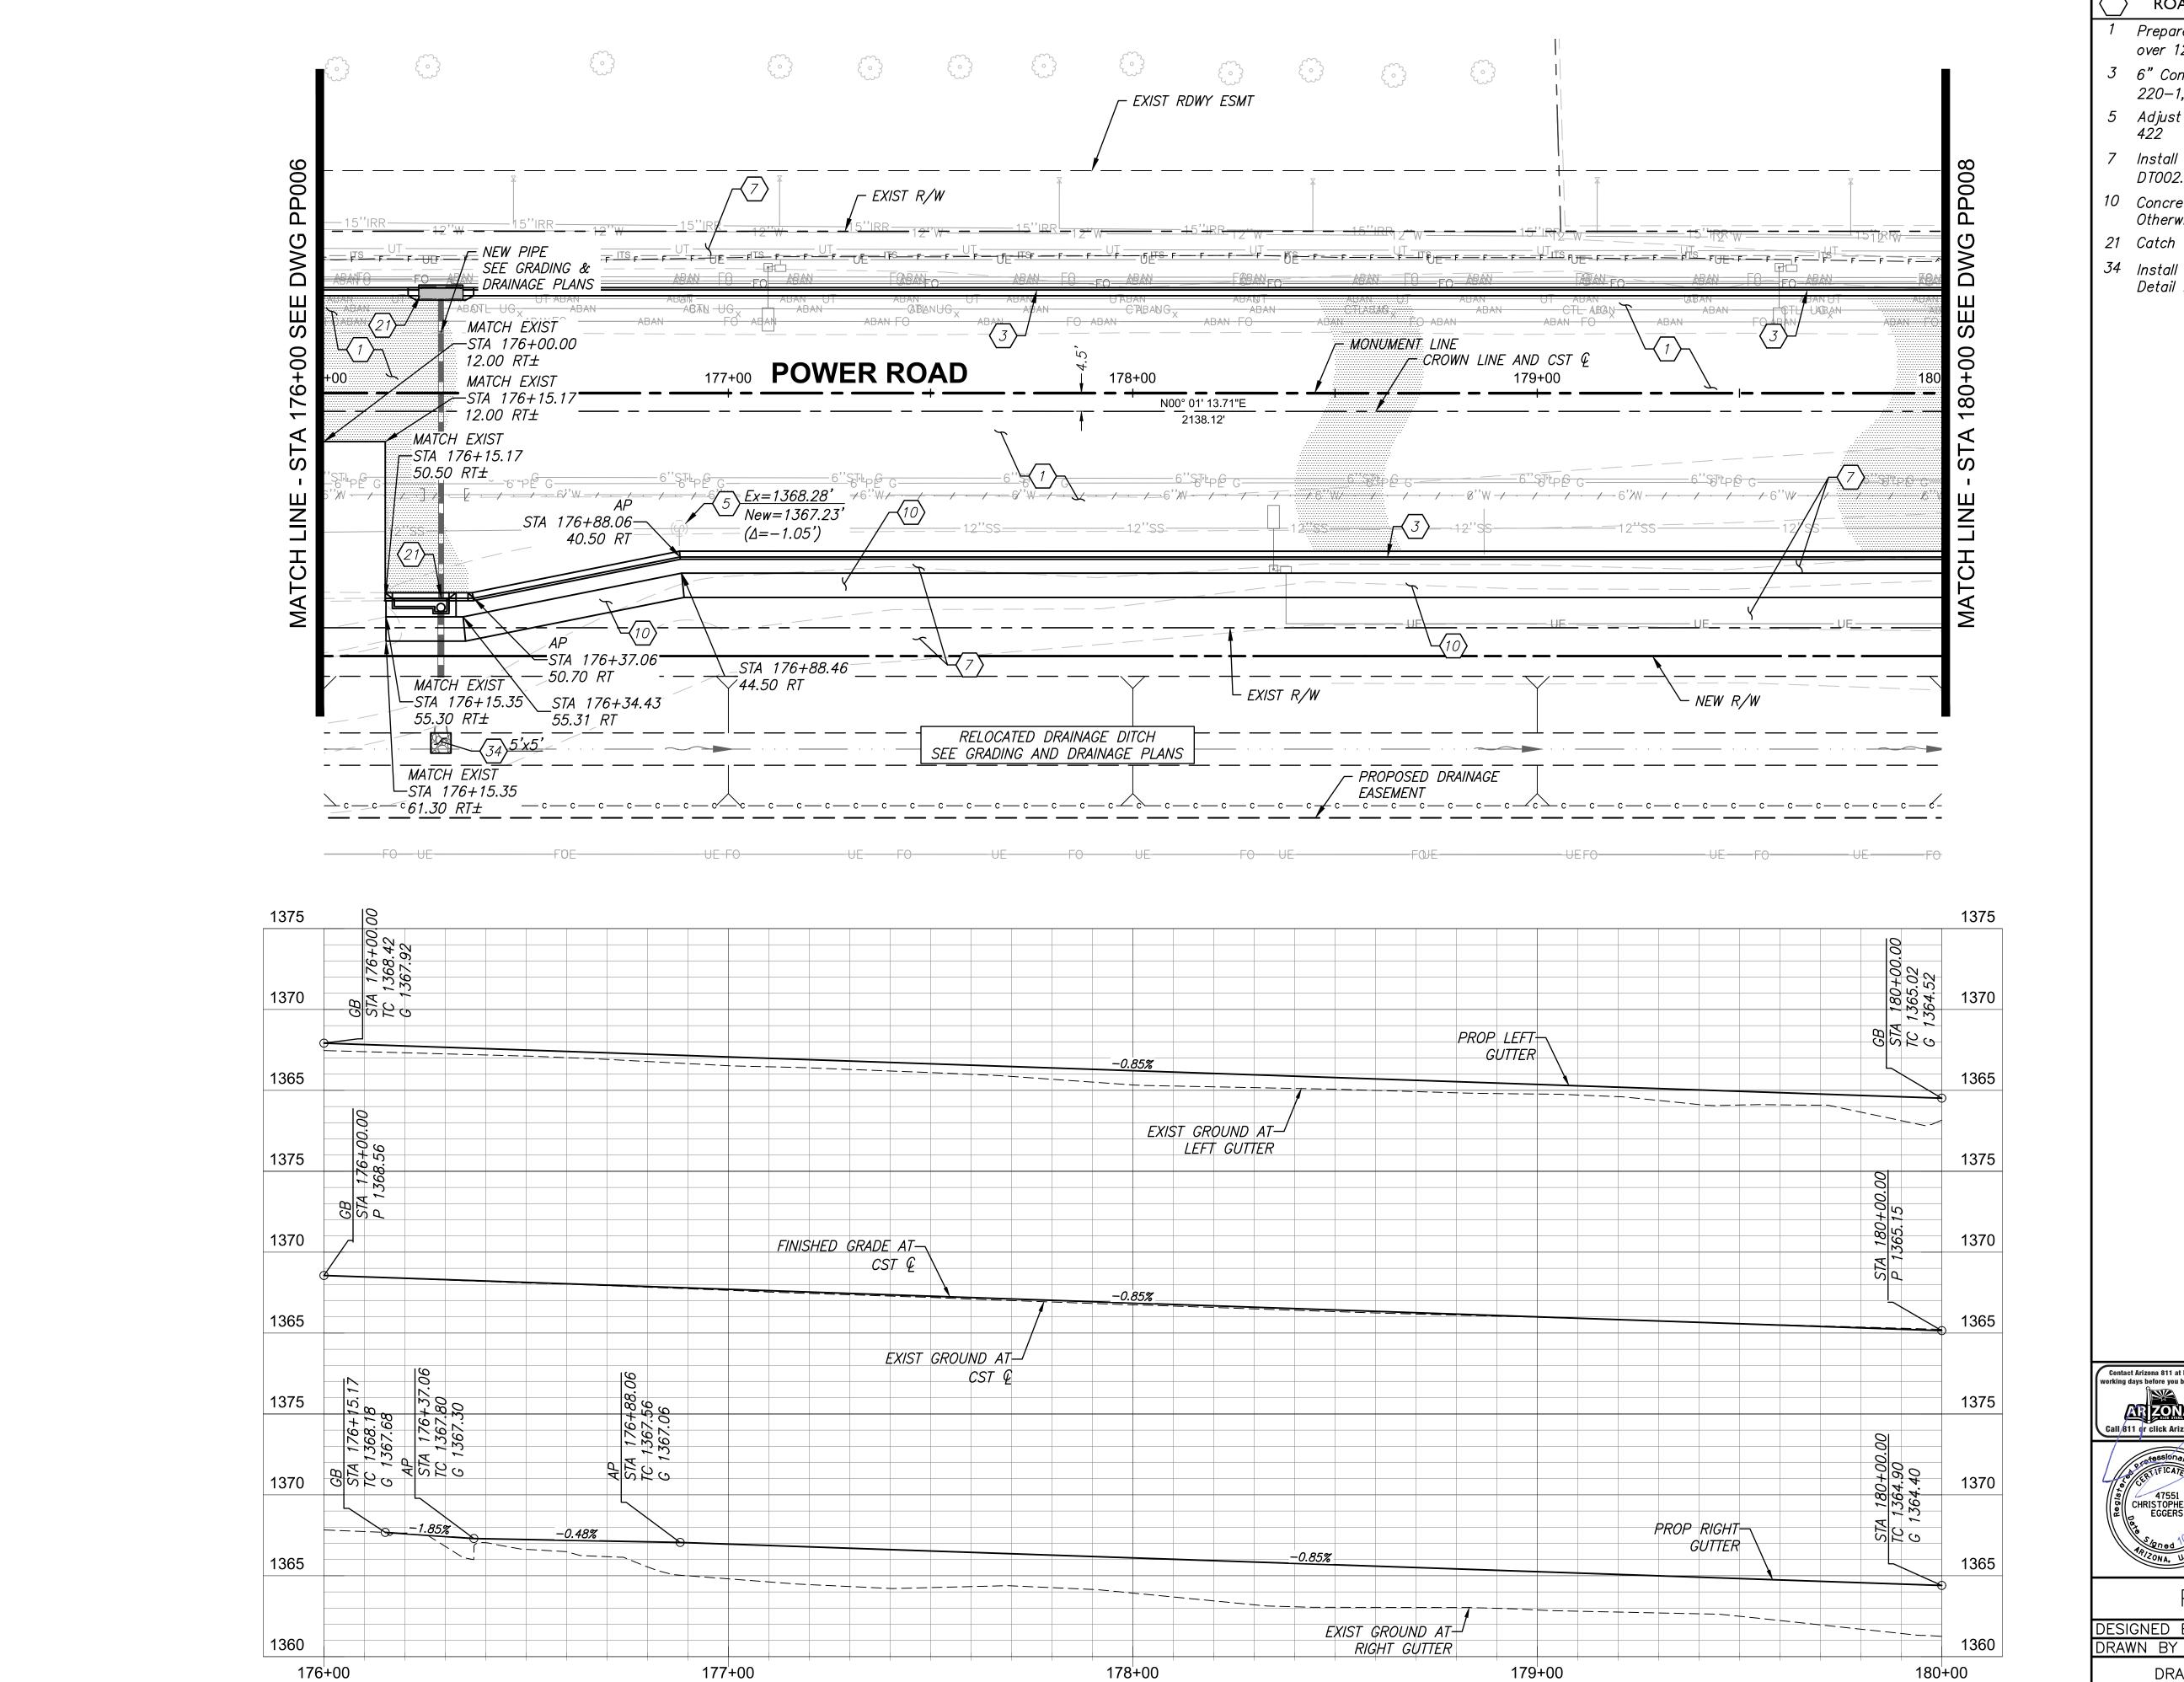

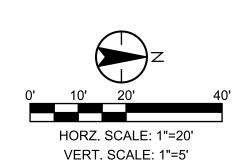









POWER ROAD:
RIGGS ROAD TO CHANDLER HEIGHTS ROAD
ROADWAY AND DRAINAGE IMPROVEMENTS


Chandler, Arizona 85226 Tel. 480.687.6100


PAVING PLAN AND PROFILE DESIGNED BY MH CIP PROJ NO. A1405

SHEET 32 OF 133 PP007 DRAWING NO.

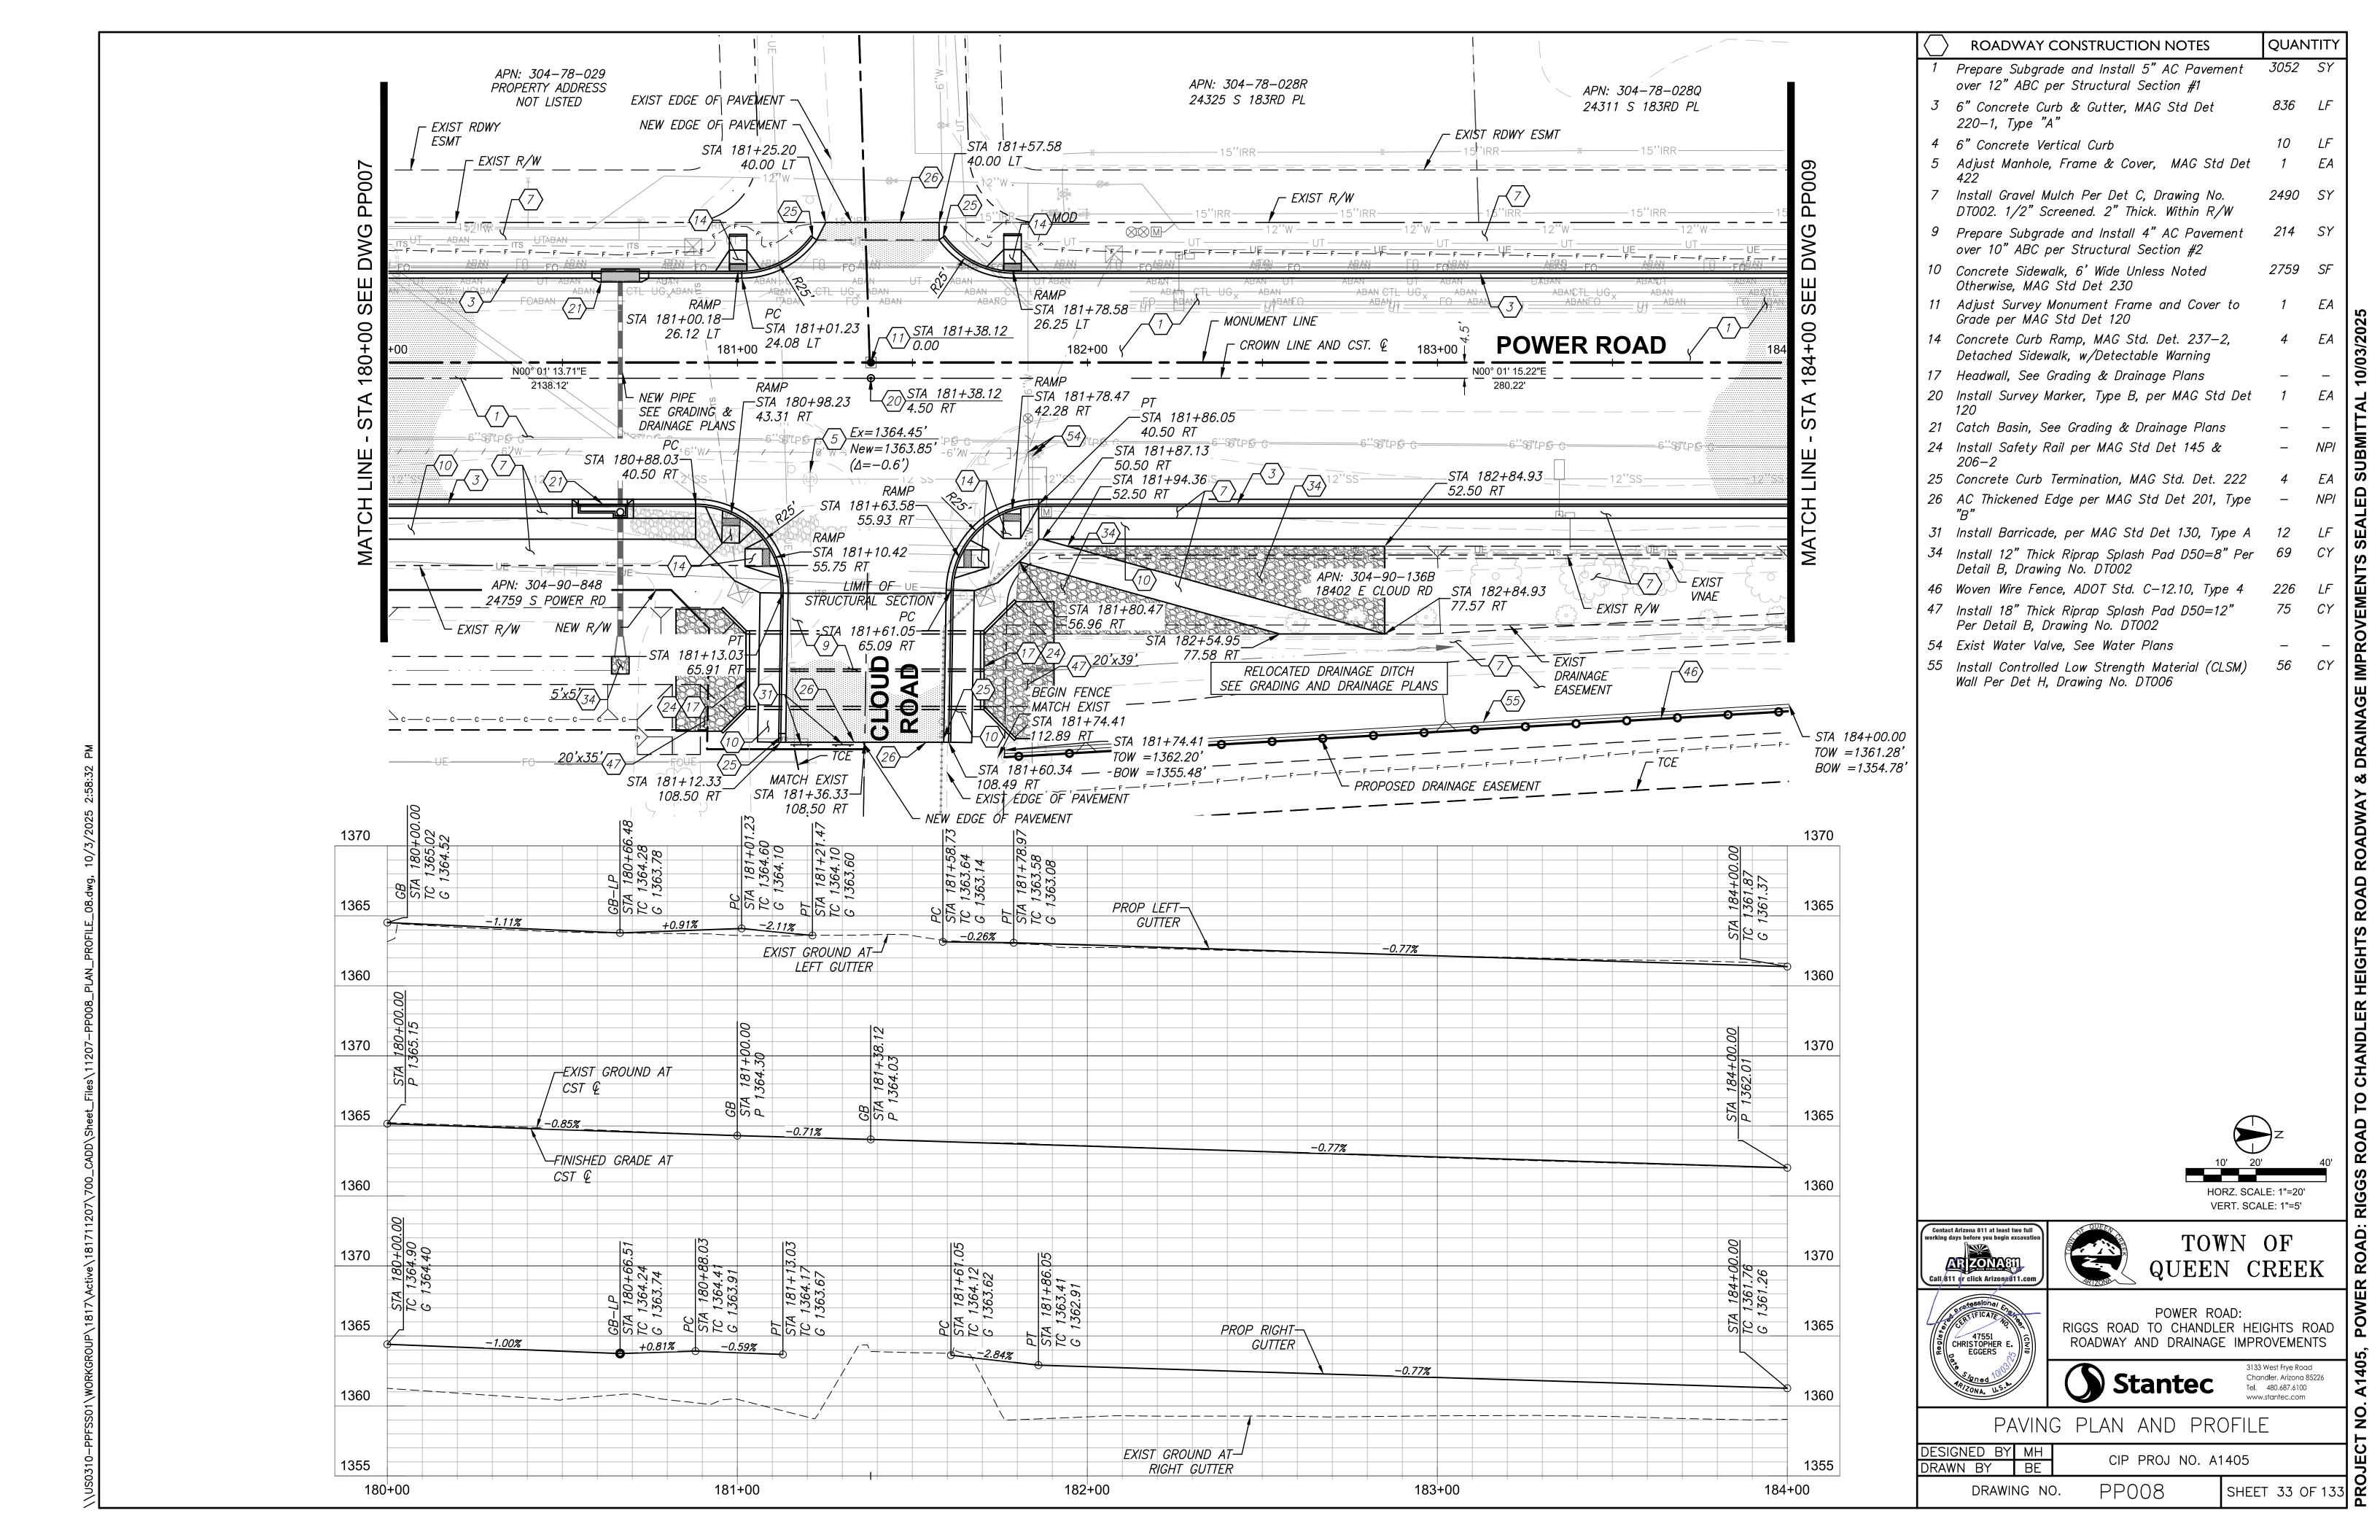

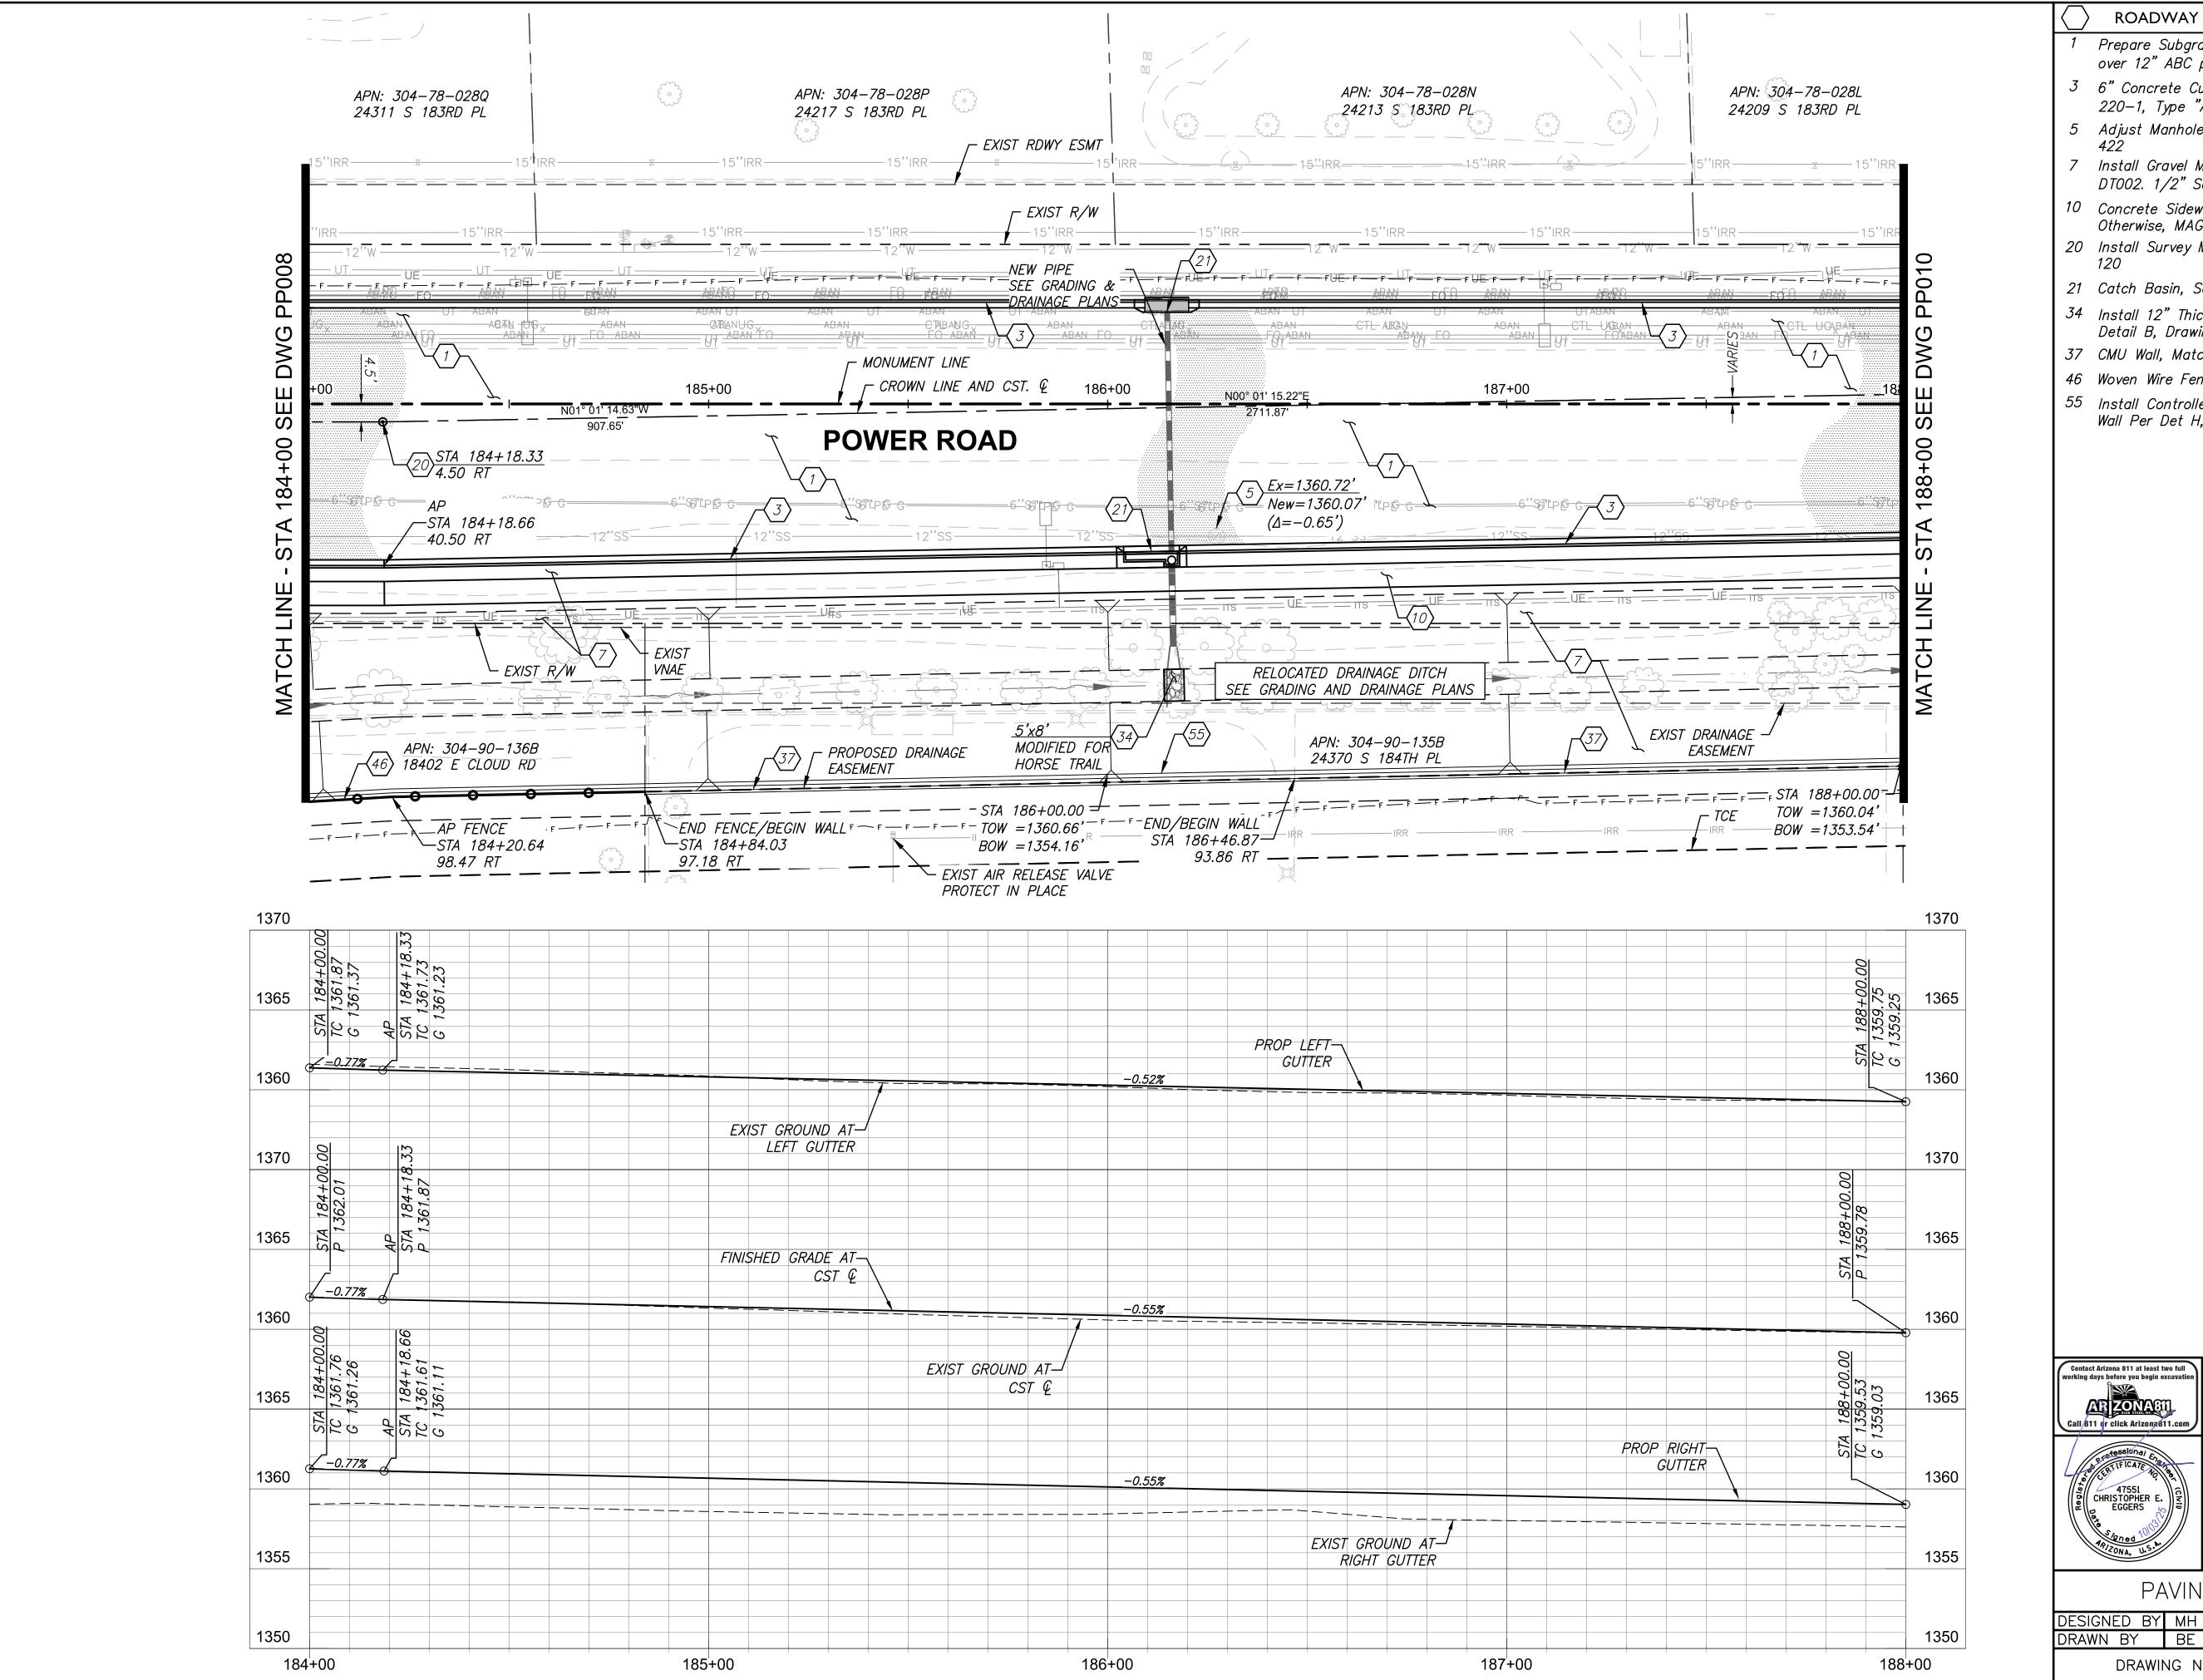

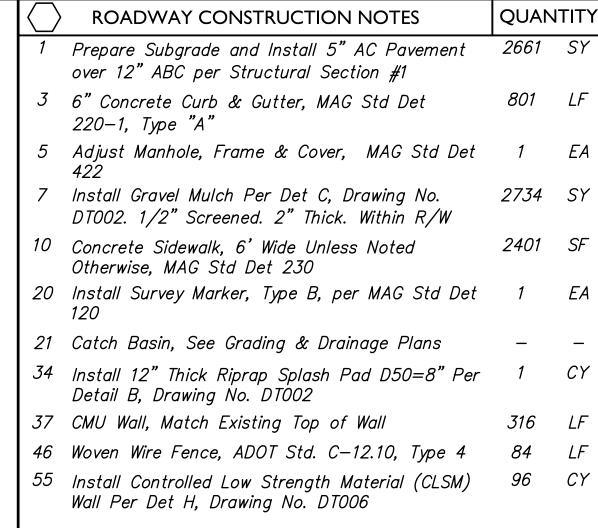

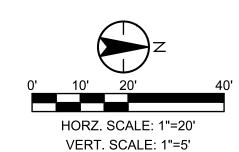







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ROADWAY AND DRAINAGE IMPROVEMENTS


Stantec


Chandler, Arizona 85226 Tel. 480.687.6100


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CIP PROJ NO. A1405 SHEET 34 OF 133

PP009 DRAWING NO.




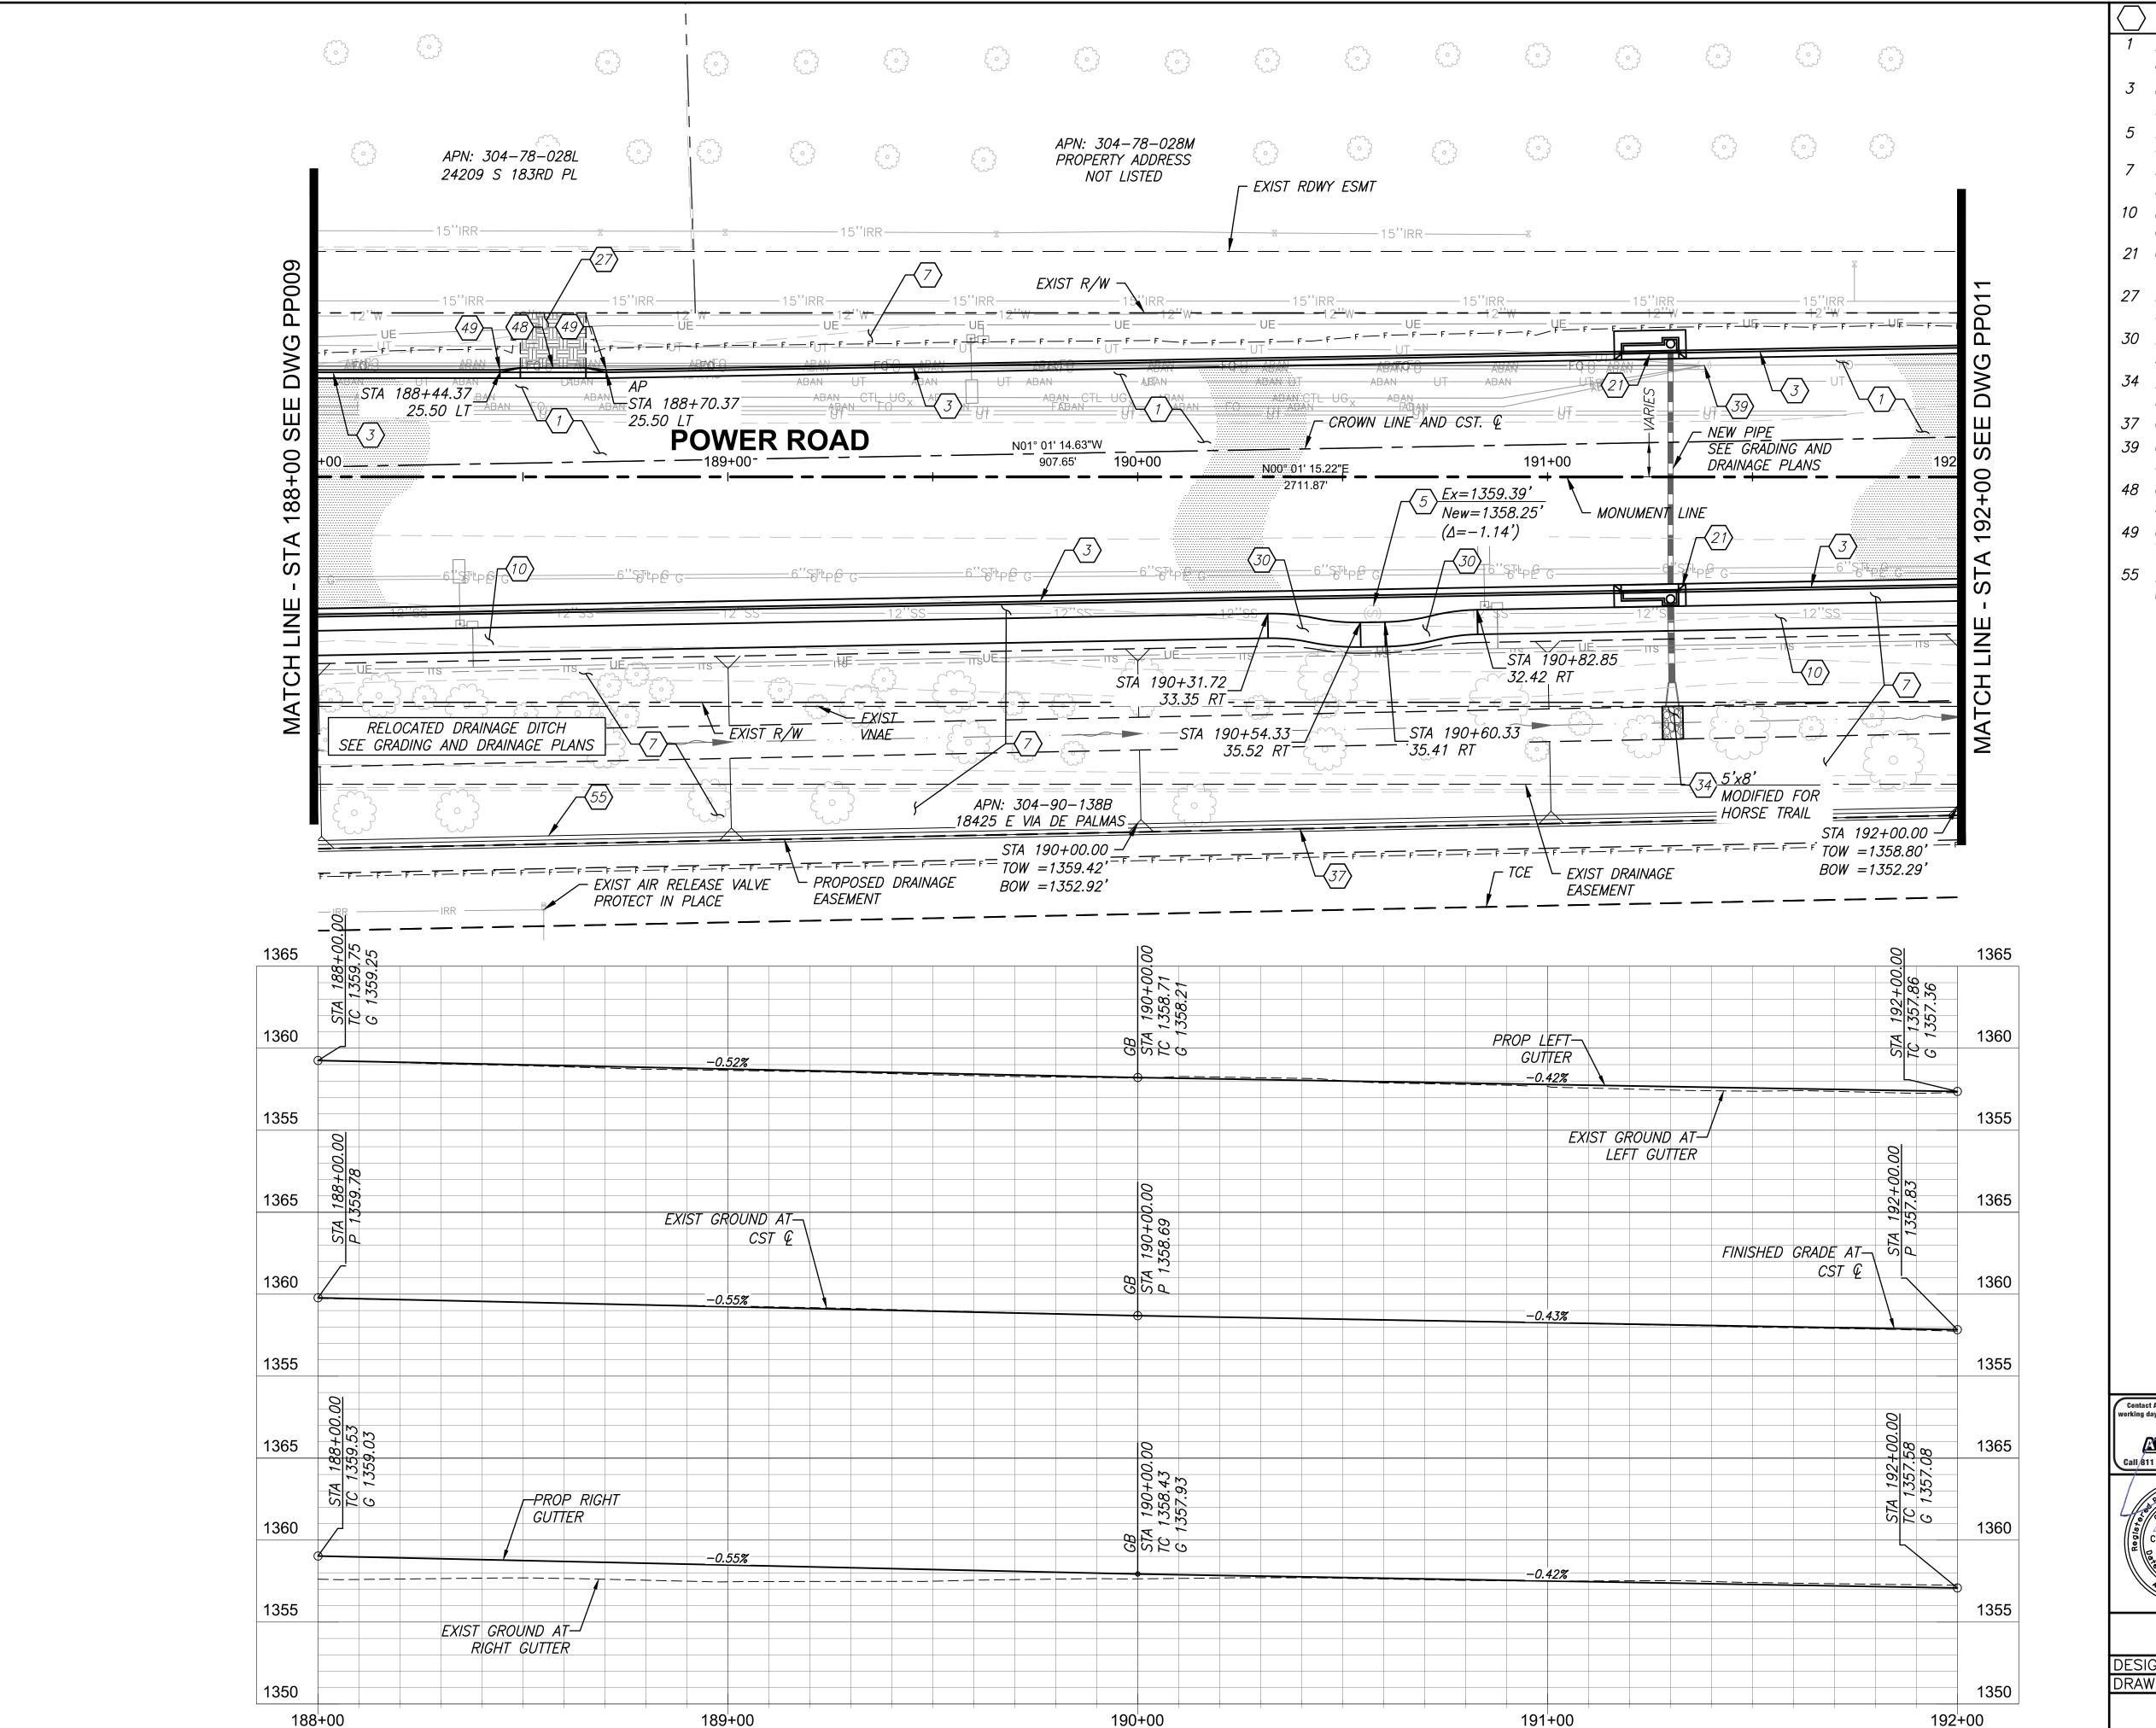

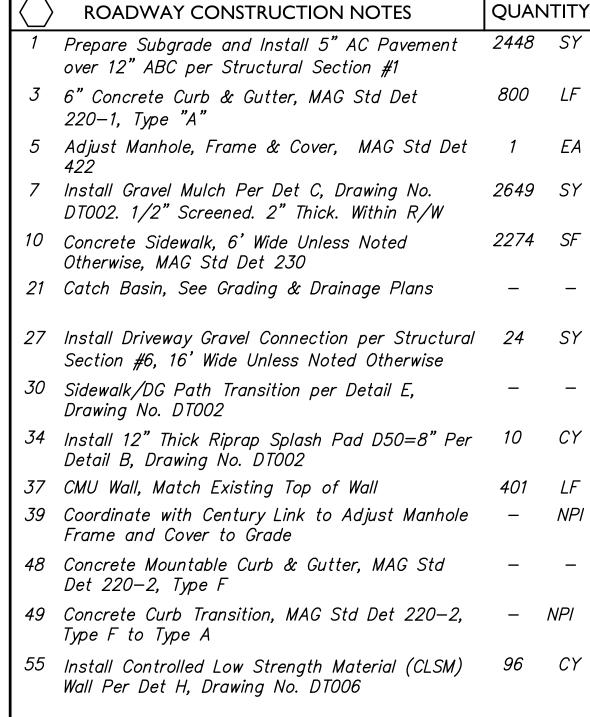

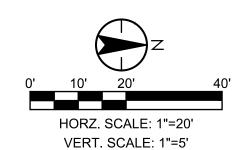



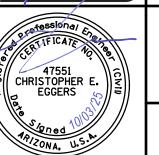



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RIGGS ROAD TO CHANDLER HEIGHTS ROAD
ROADWAY AND DRAINAGE IMPROVEMENTS


Stantec

Chandler, Arizona 85226 Tel. 480.687.6100 PAVING PLAN AND PROFILE

DESIGNED BY MH CIP PROJ NO. A1405 DRAWN BY SHEET 35 OF 133 PP010 DRAWING NO.

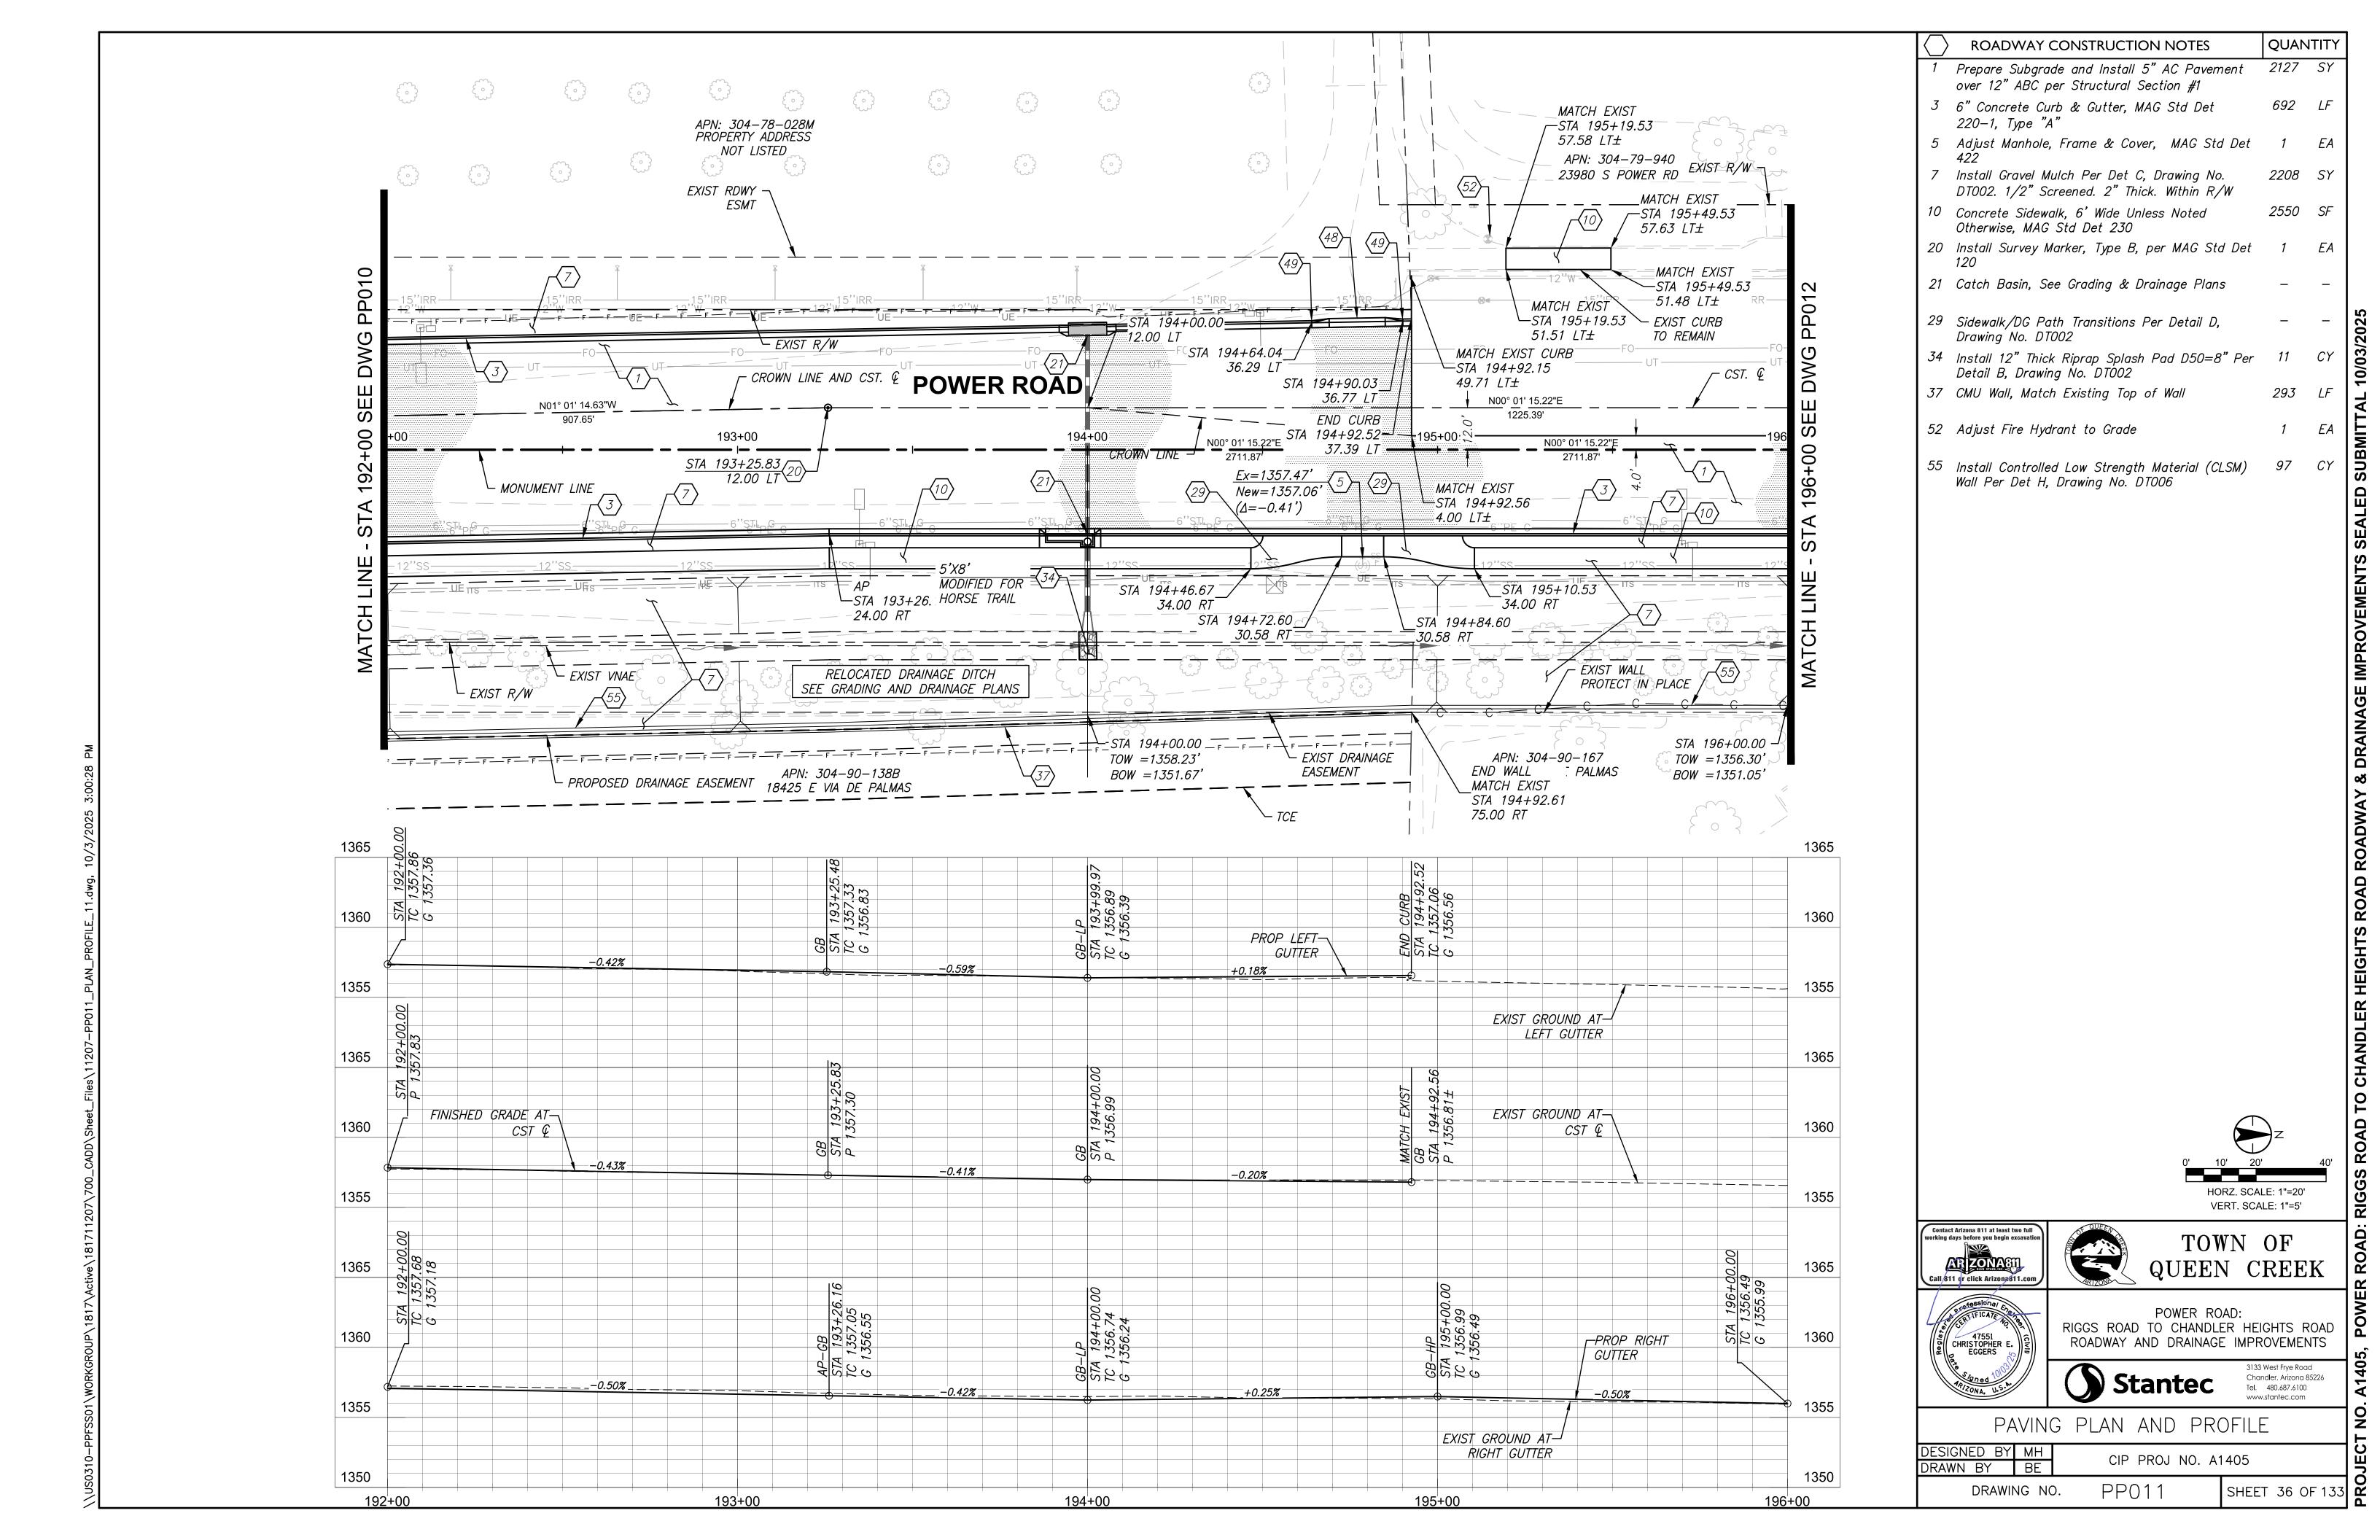

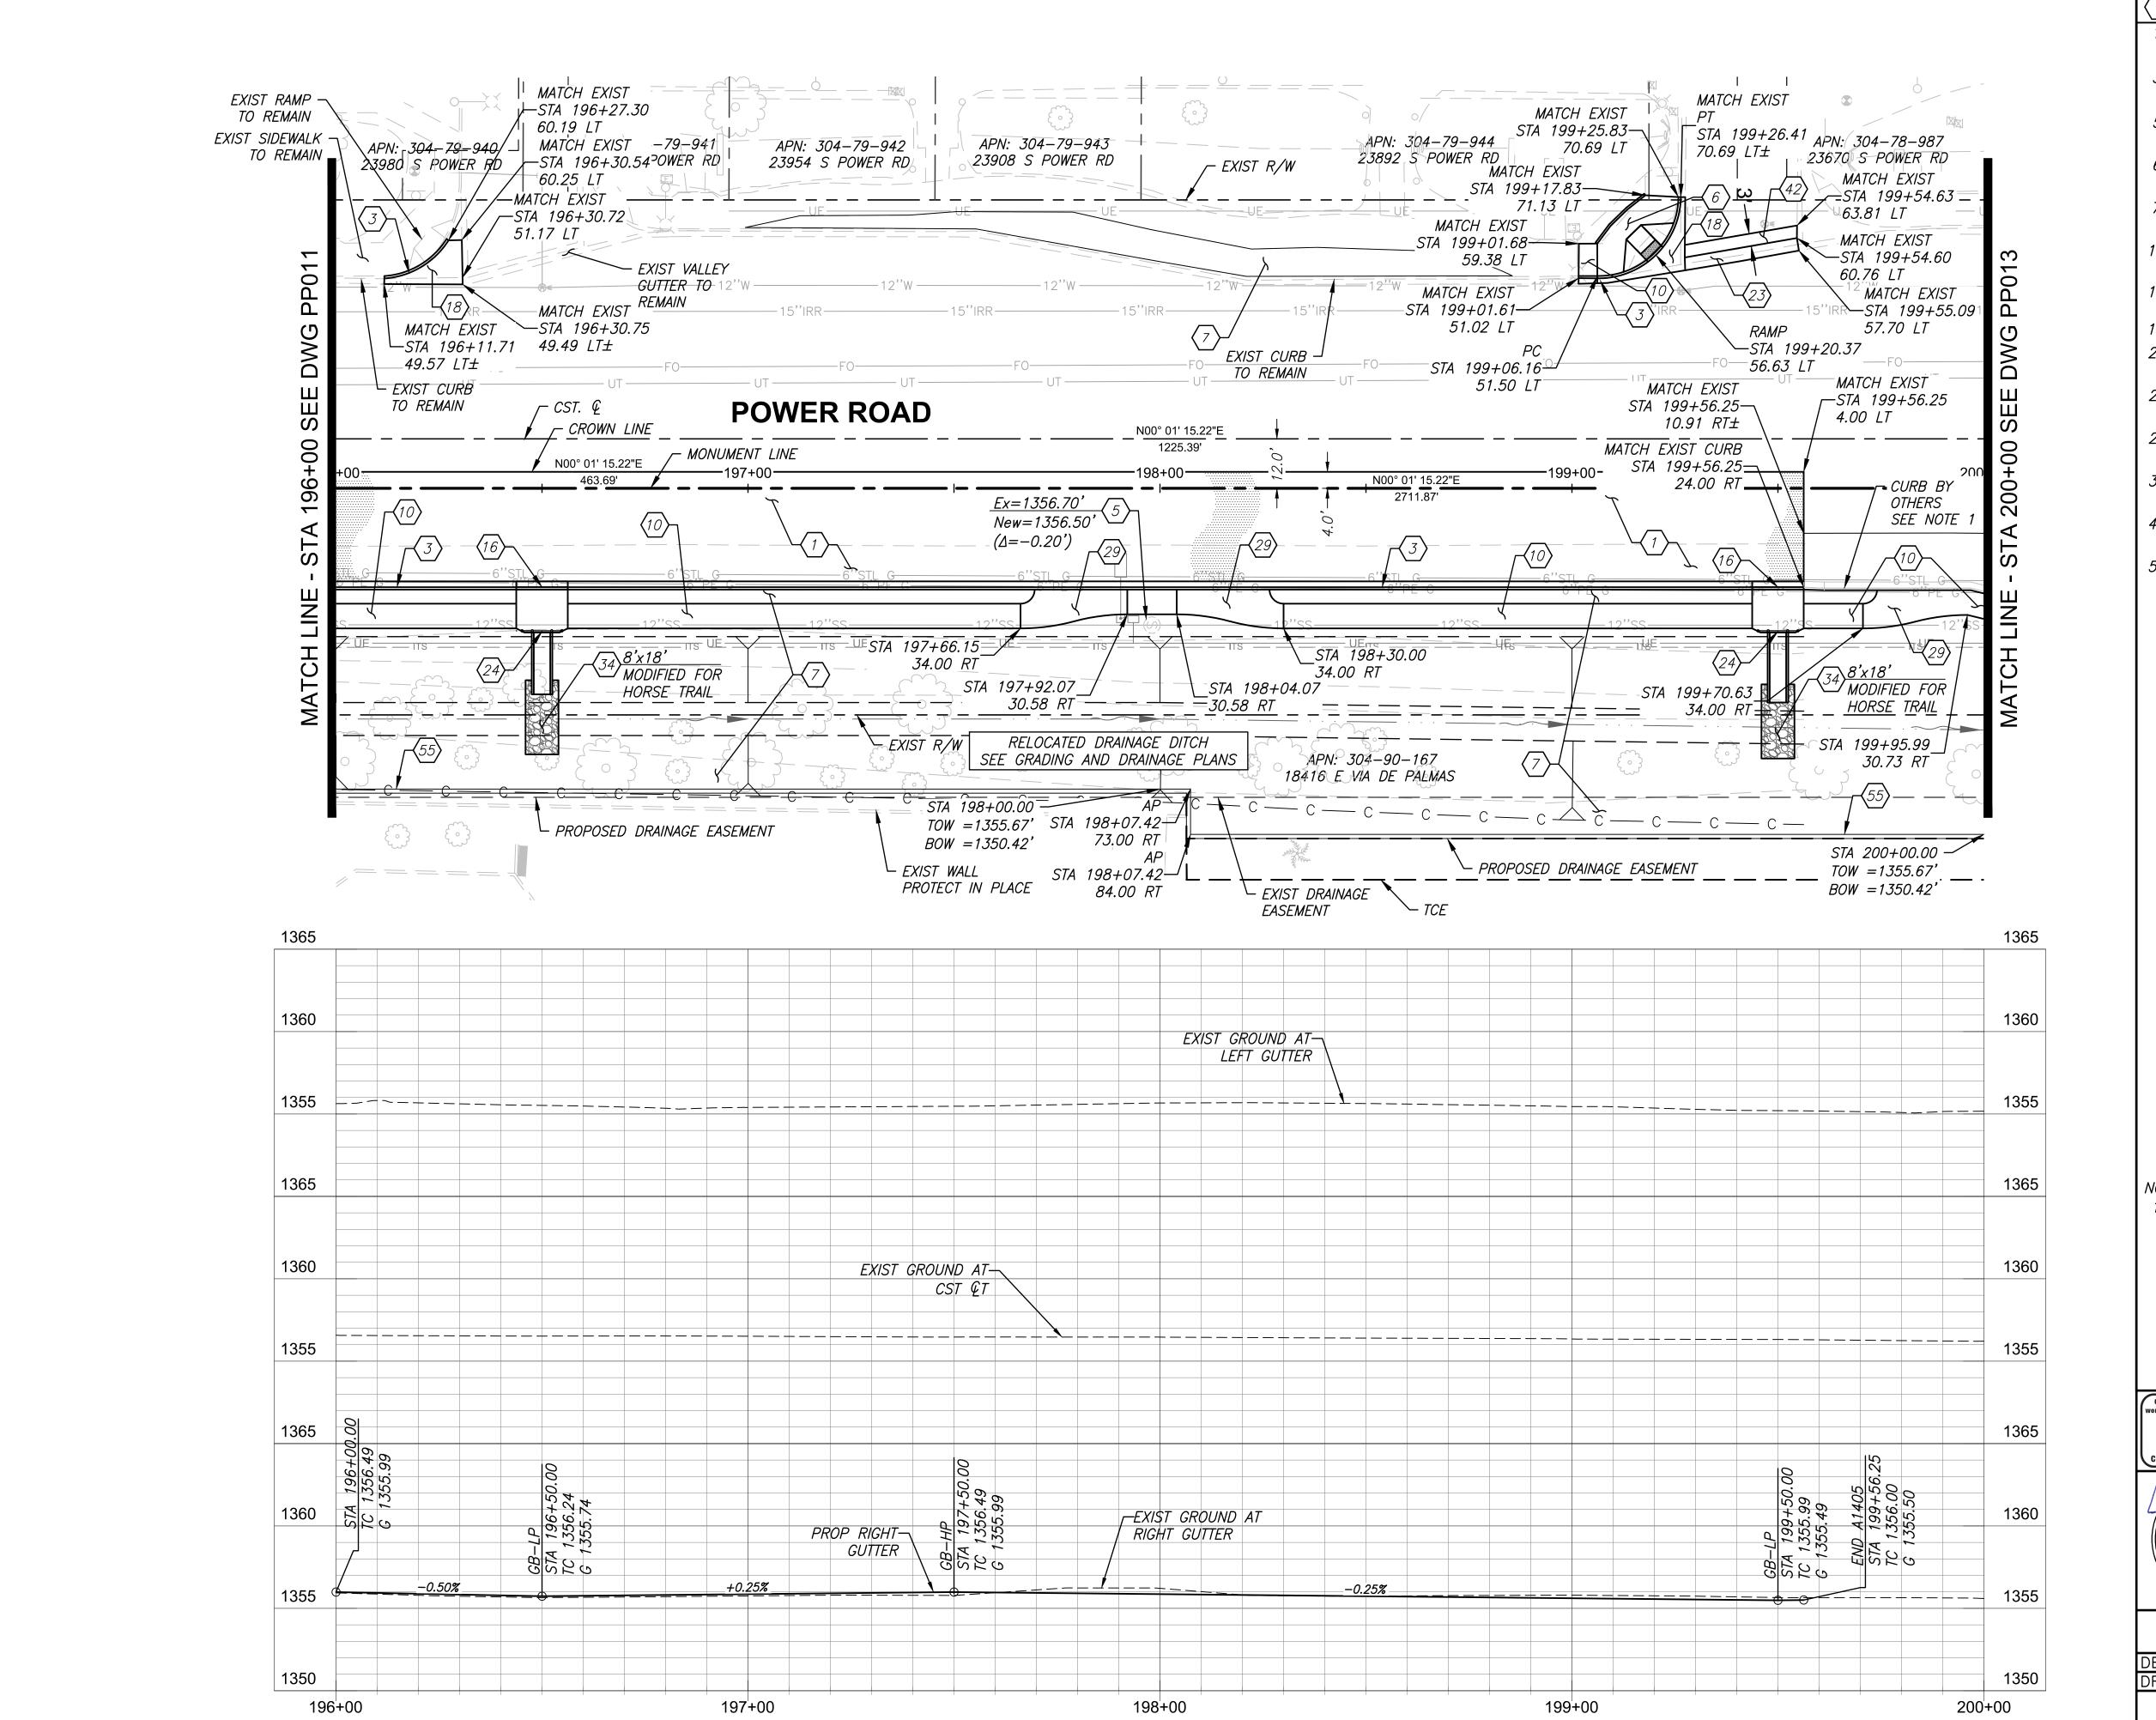


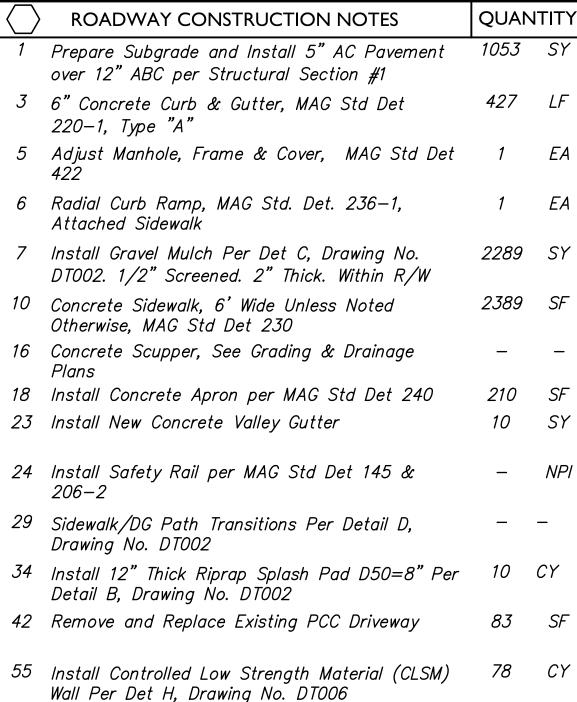

| 6

CHANDLER HEIGHTS

1. Proposed improvements "BY OTHERS" shown for reference only, refer to Town of Queen Creek Project Number 6862 - "SEC Power Road & Chandler Heights Road", for details

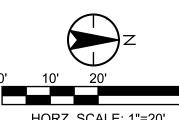


VERT. SCALE: 1"=5'

TOWN OF





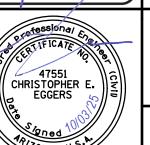



POWER ROAD: RIGGS ROAD TO CHANDLER HEIGHTS ROAD ROADWAY AND DRAINAGE IMPROVEMENTS

Chandler, Arizona 85226 Tel. 480.687.6100

PAVING PLAN AND PROFILE


DESIGNED BY MH CIP PROJ NO. A1405 DRAWN BY SHEET 37 OF 133 PP012 DRAWING NO.

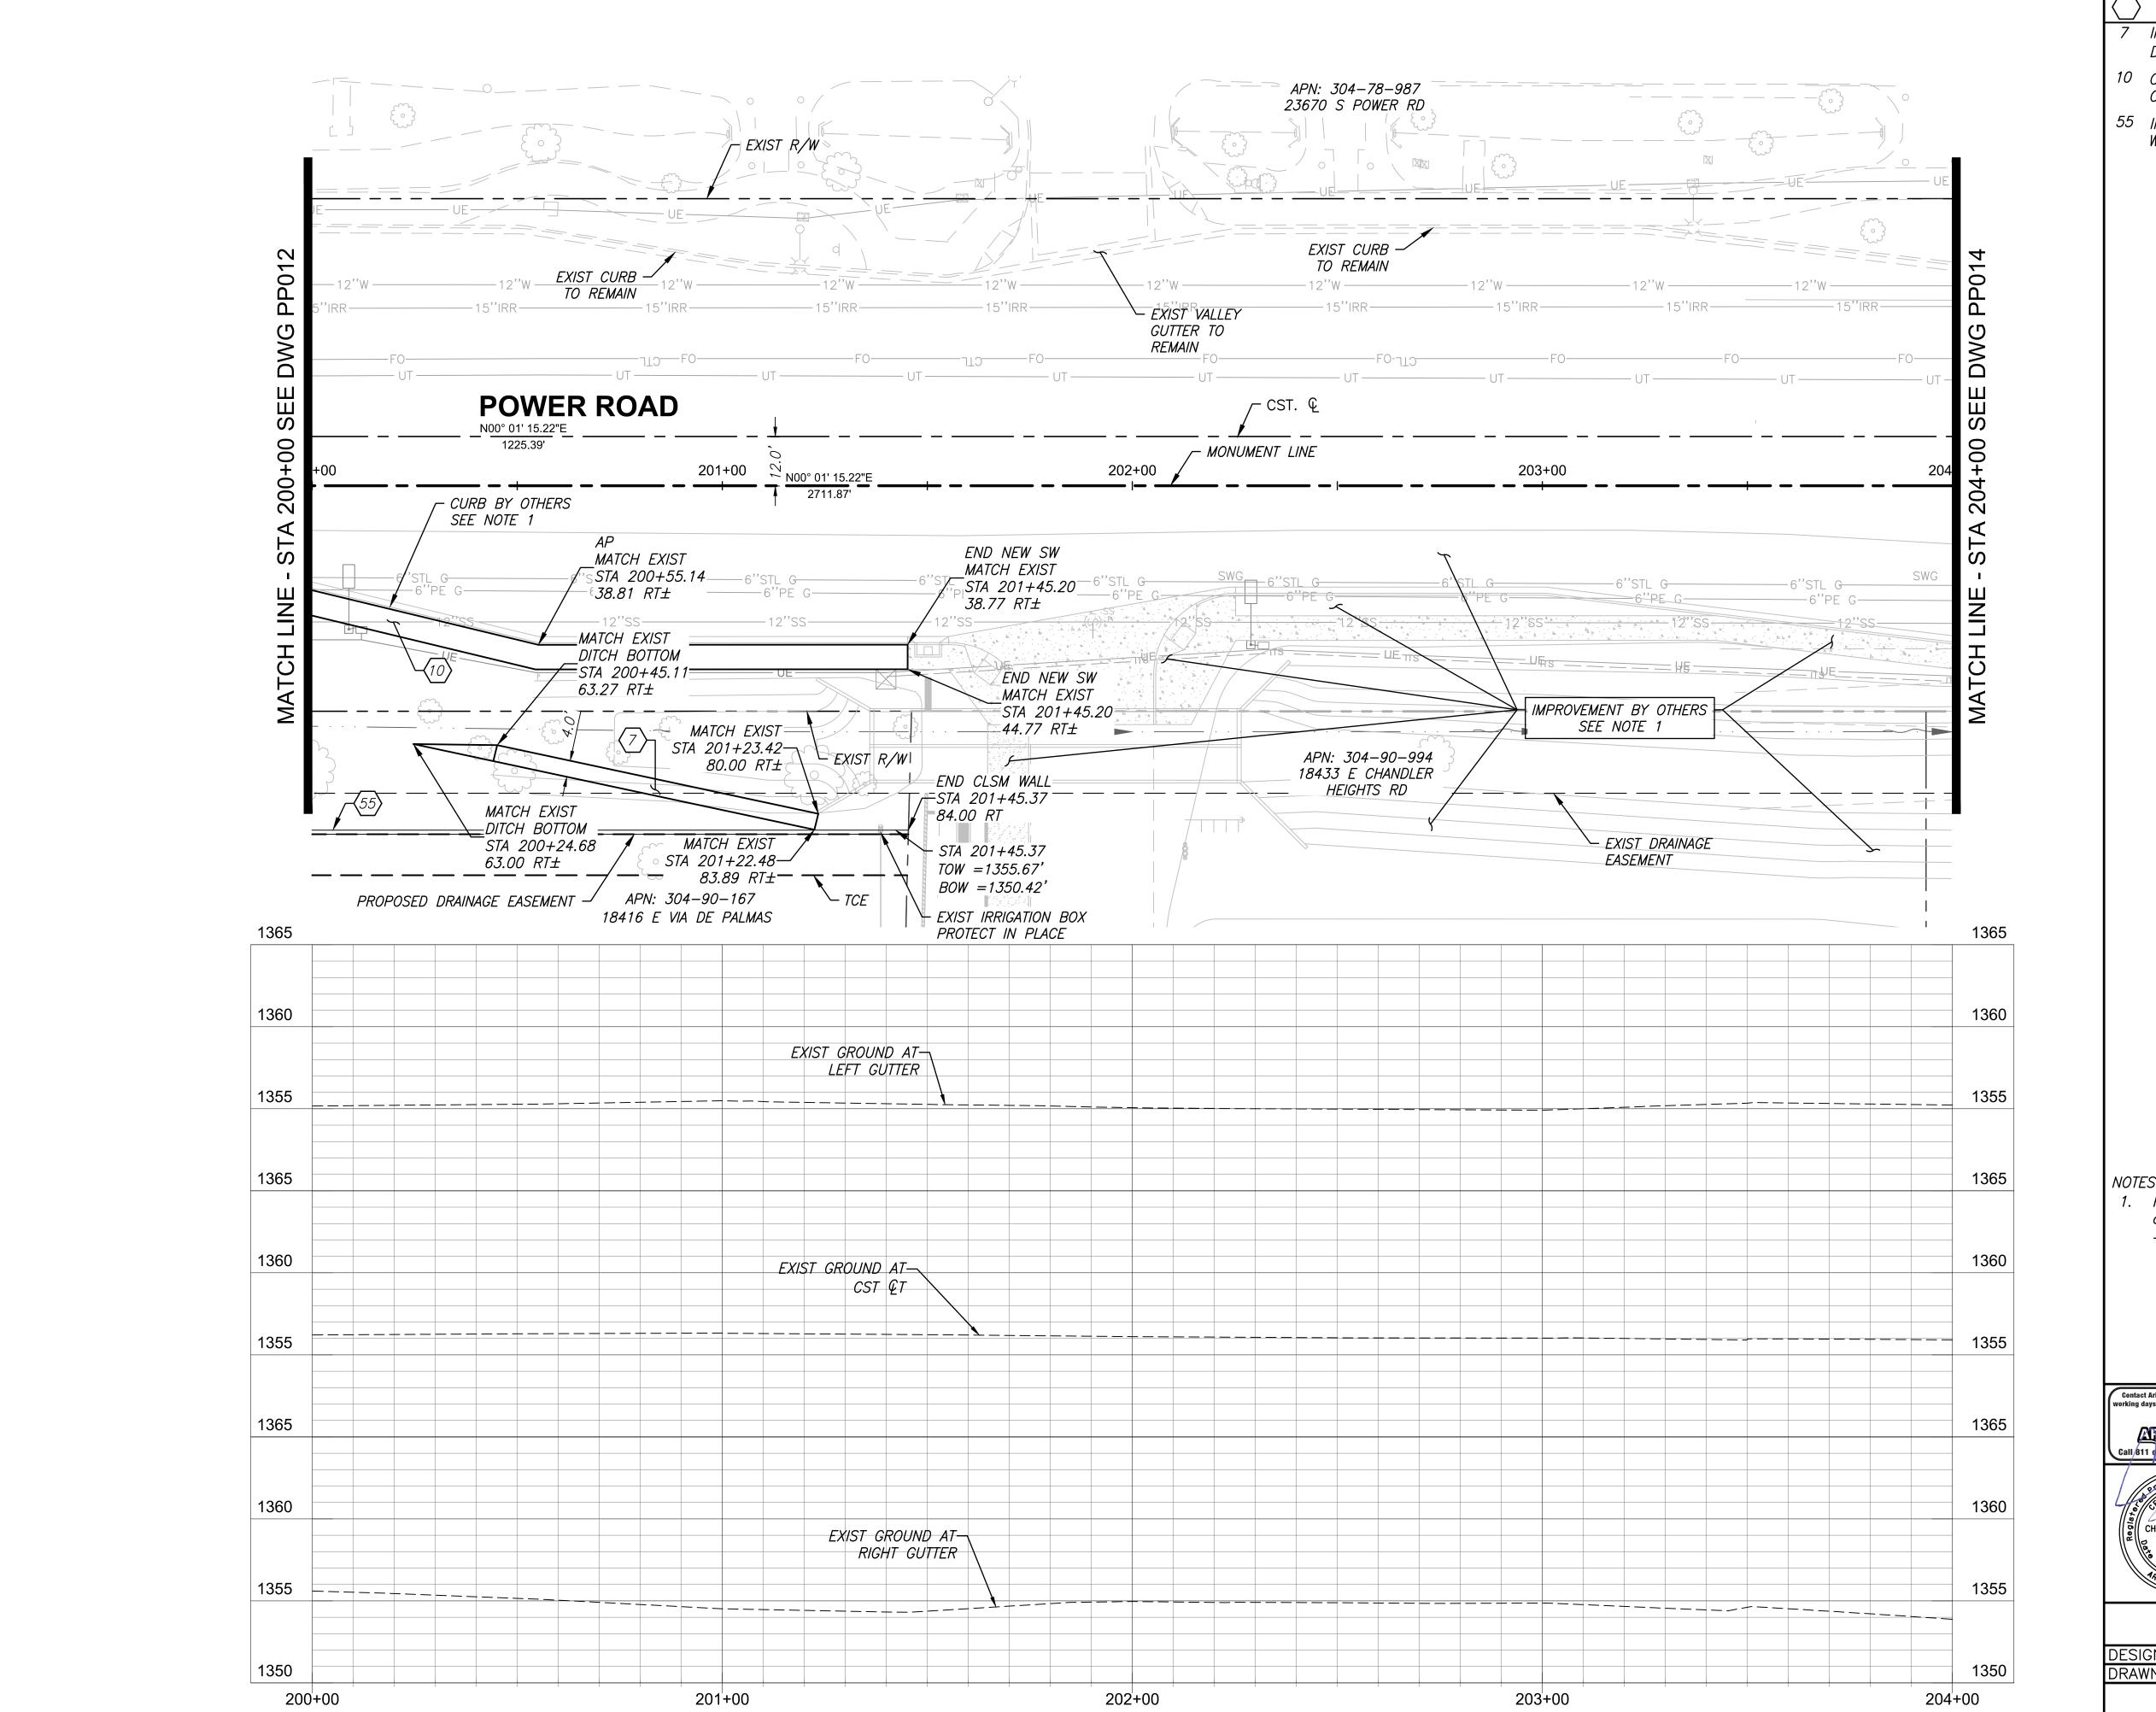

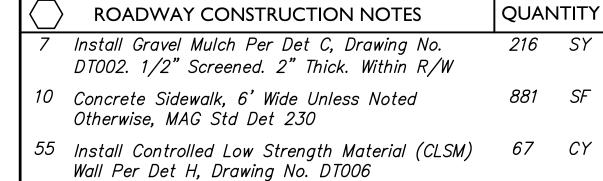

Proposed improvements "BY OTHERS" shown for reference only, refer to Town of Queen Creek Project Number 6862

 "SEC Power Road & Chandler Heights Road", for details.

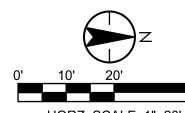

VERT. SCALE: 1"=5'









RIGGS ROAD TO CHANDLER HEIGHTS ROAD ROADWAY AND DRAINAGE IMPROVEMENTS


Chandler, Arizona 85226 Tel. 480.687.6100


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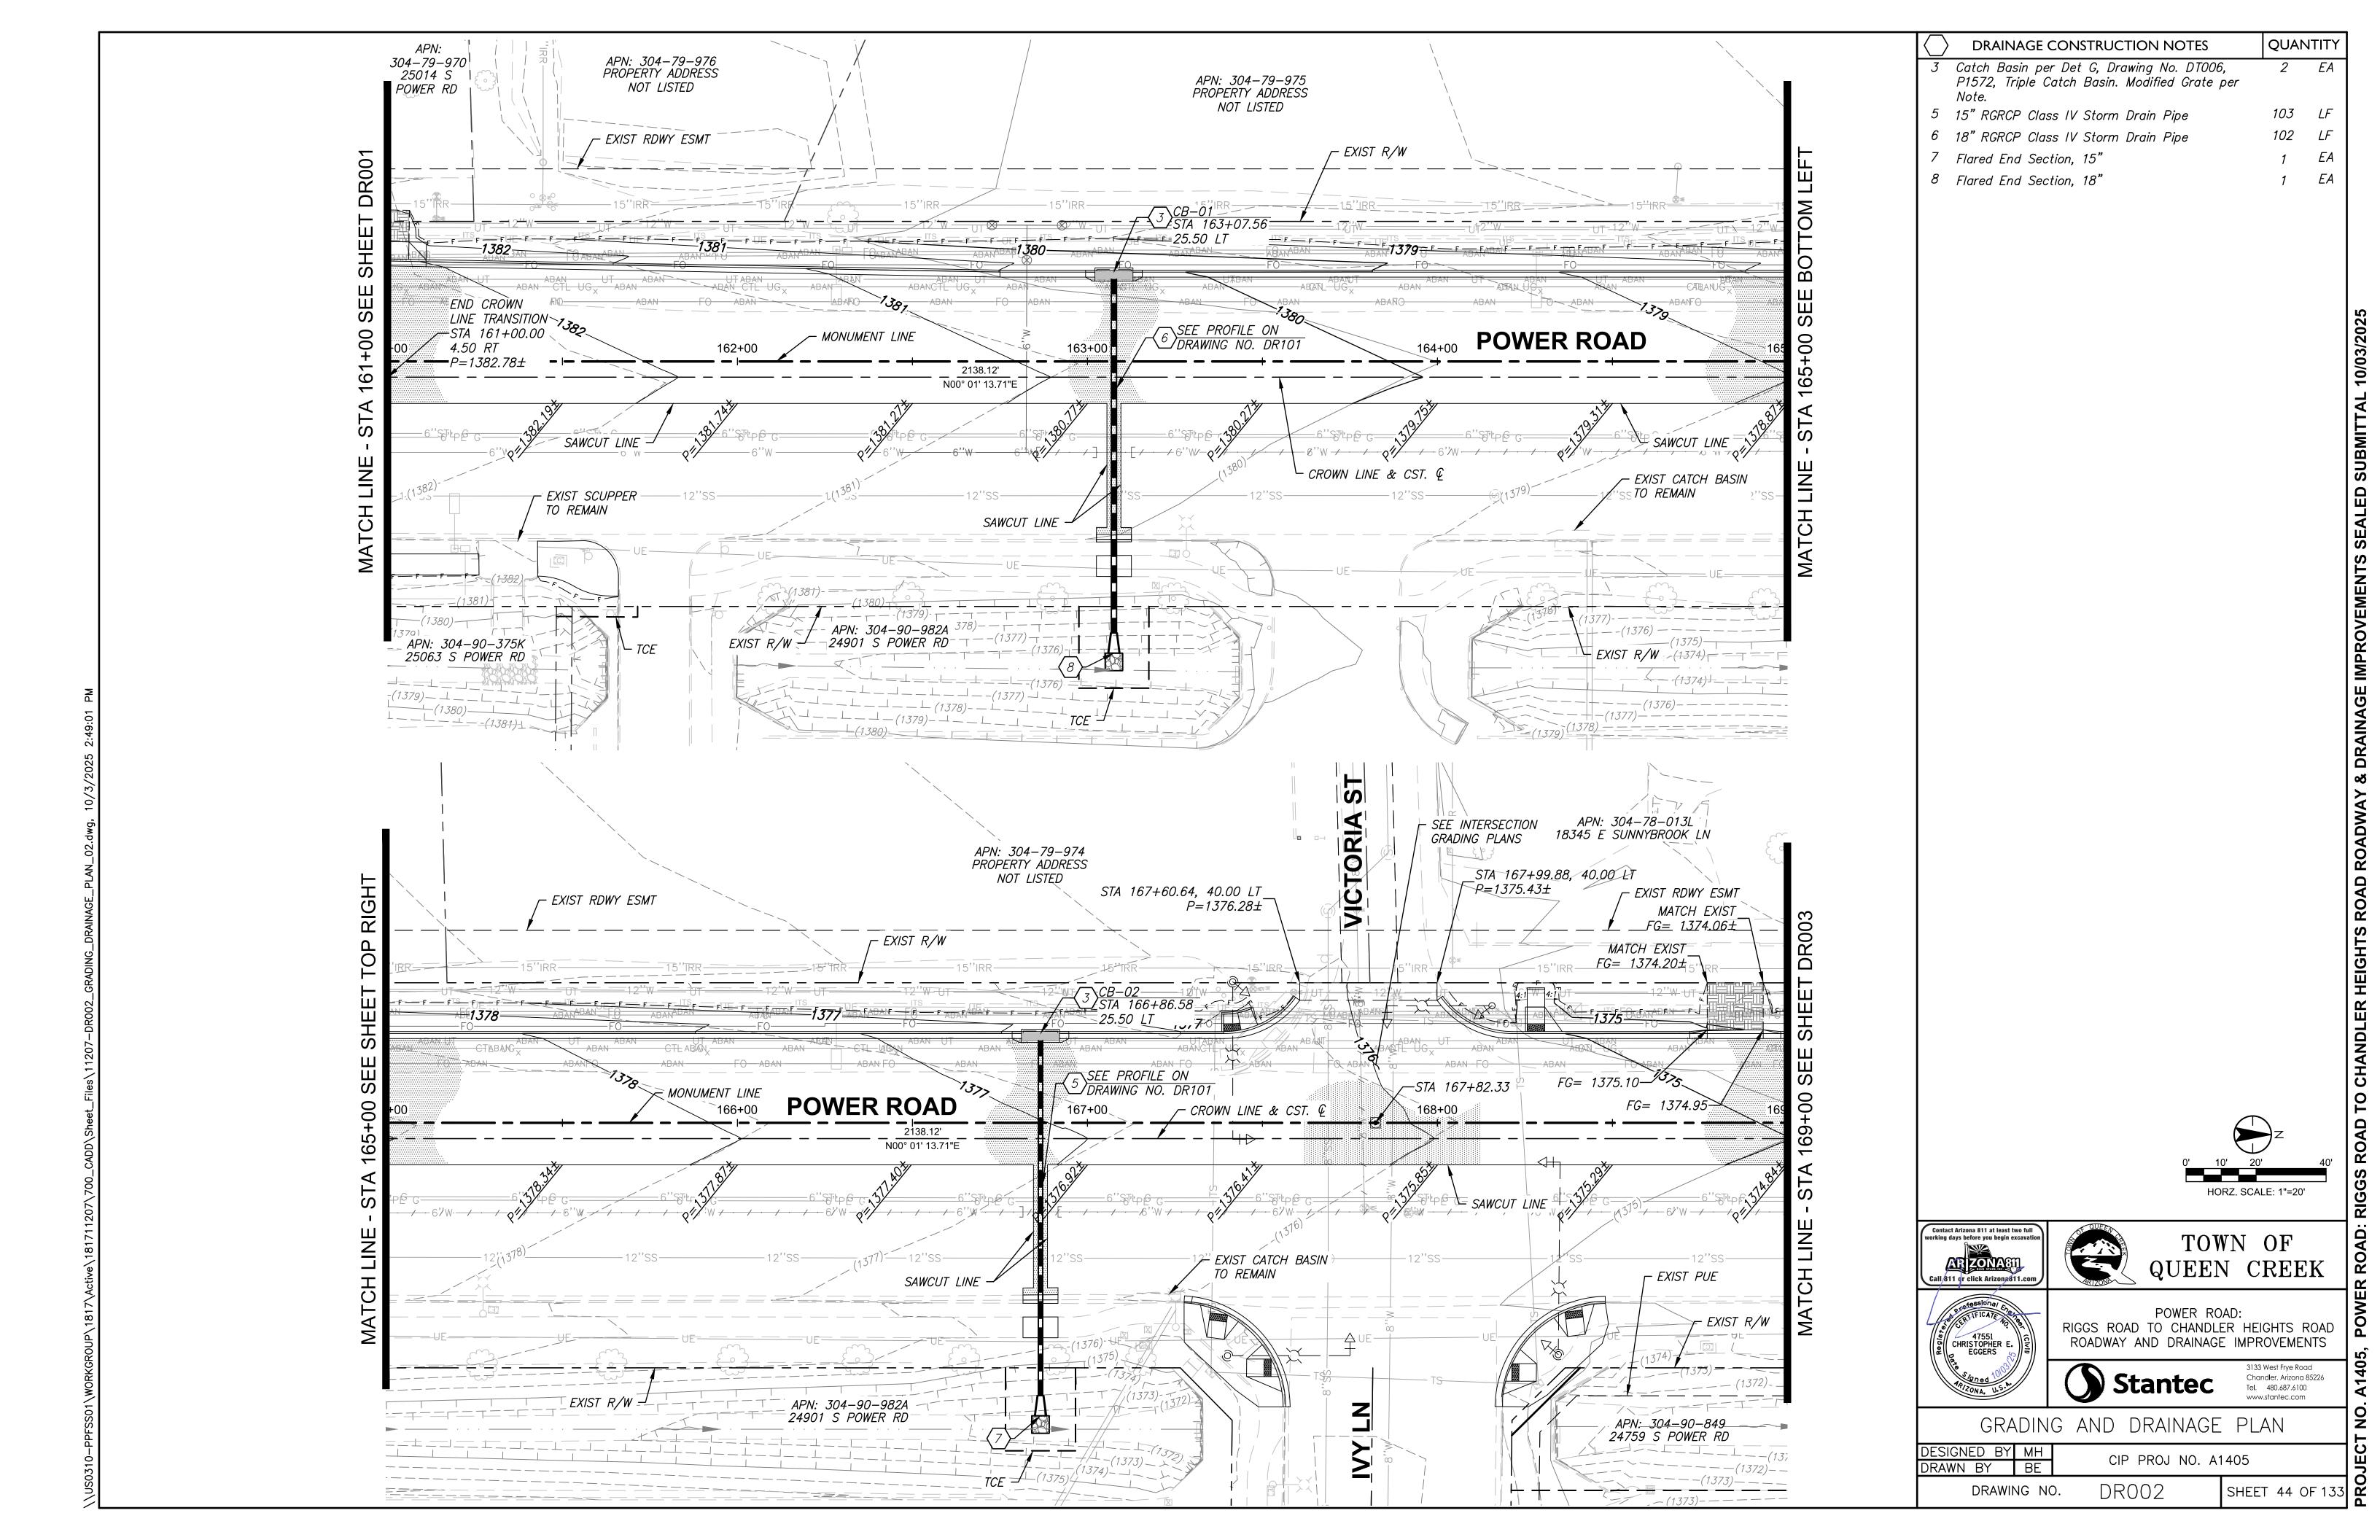
CIP PROJ NO. A1405 SHEET 38 OF 133 PP013 DRAWING NO.




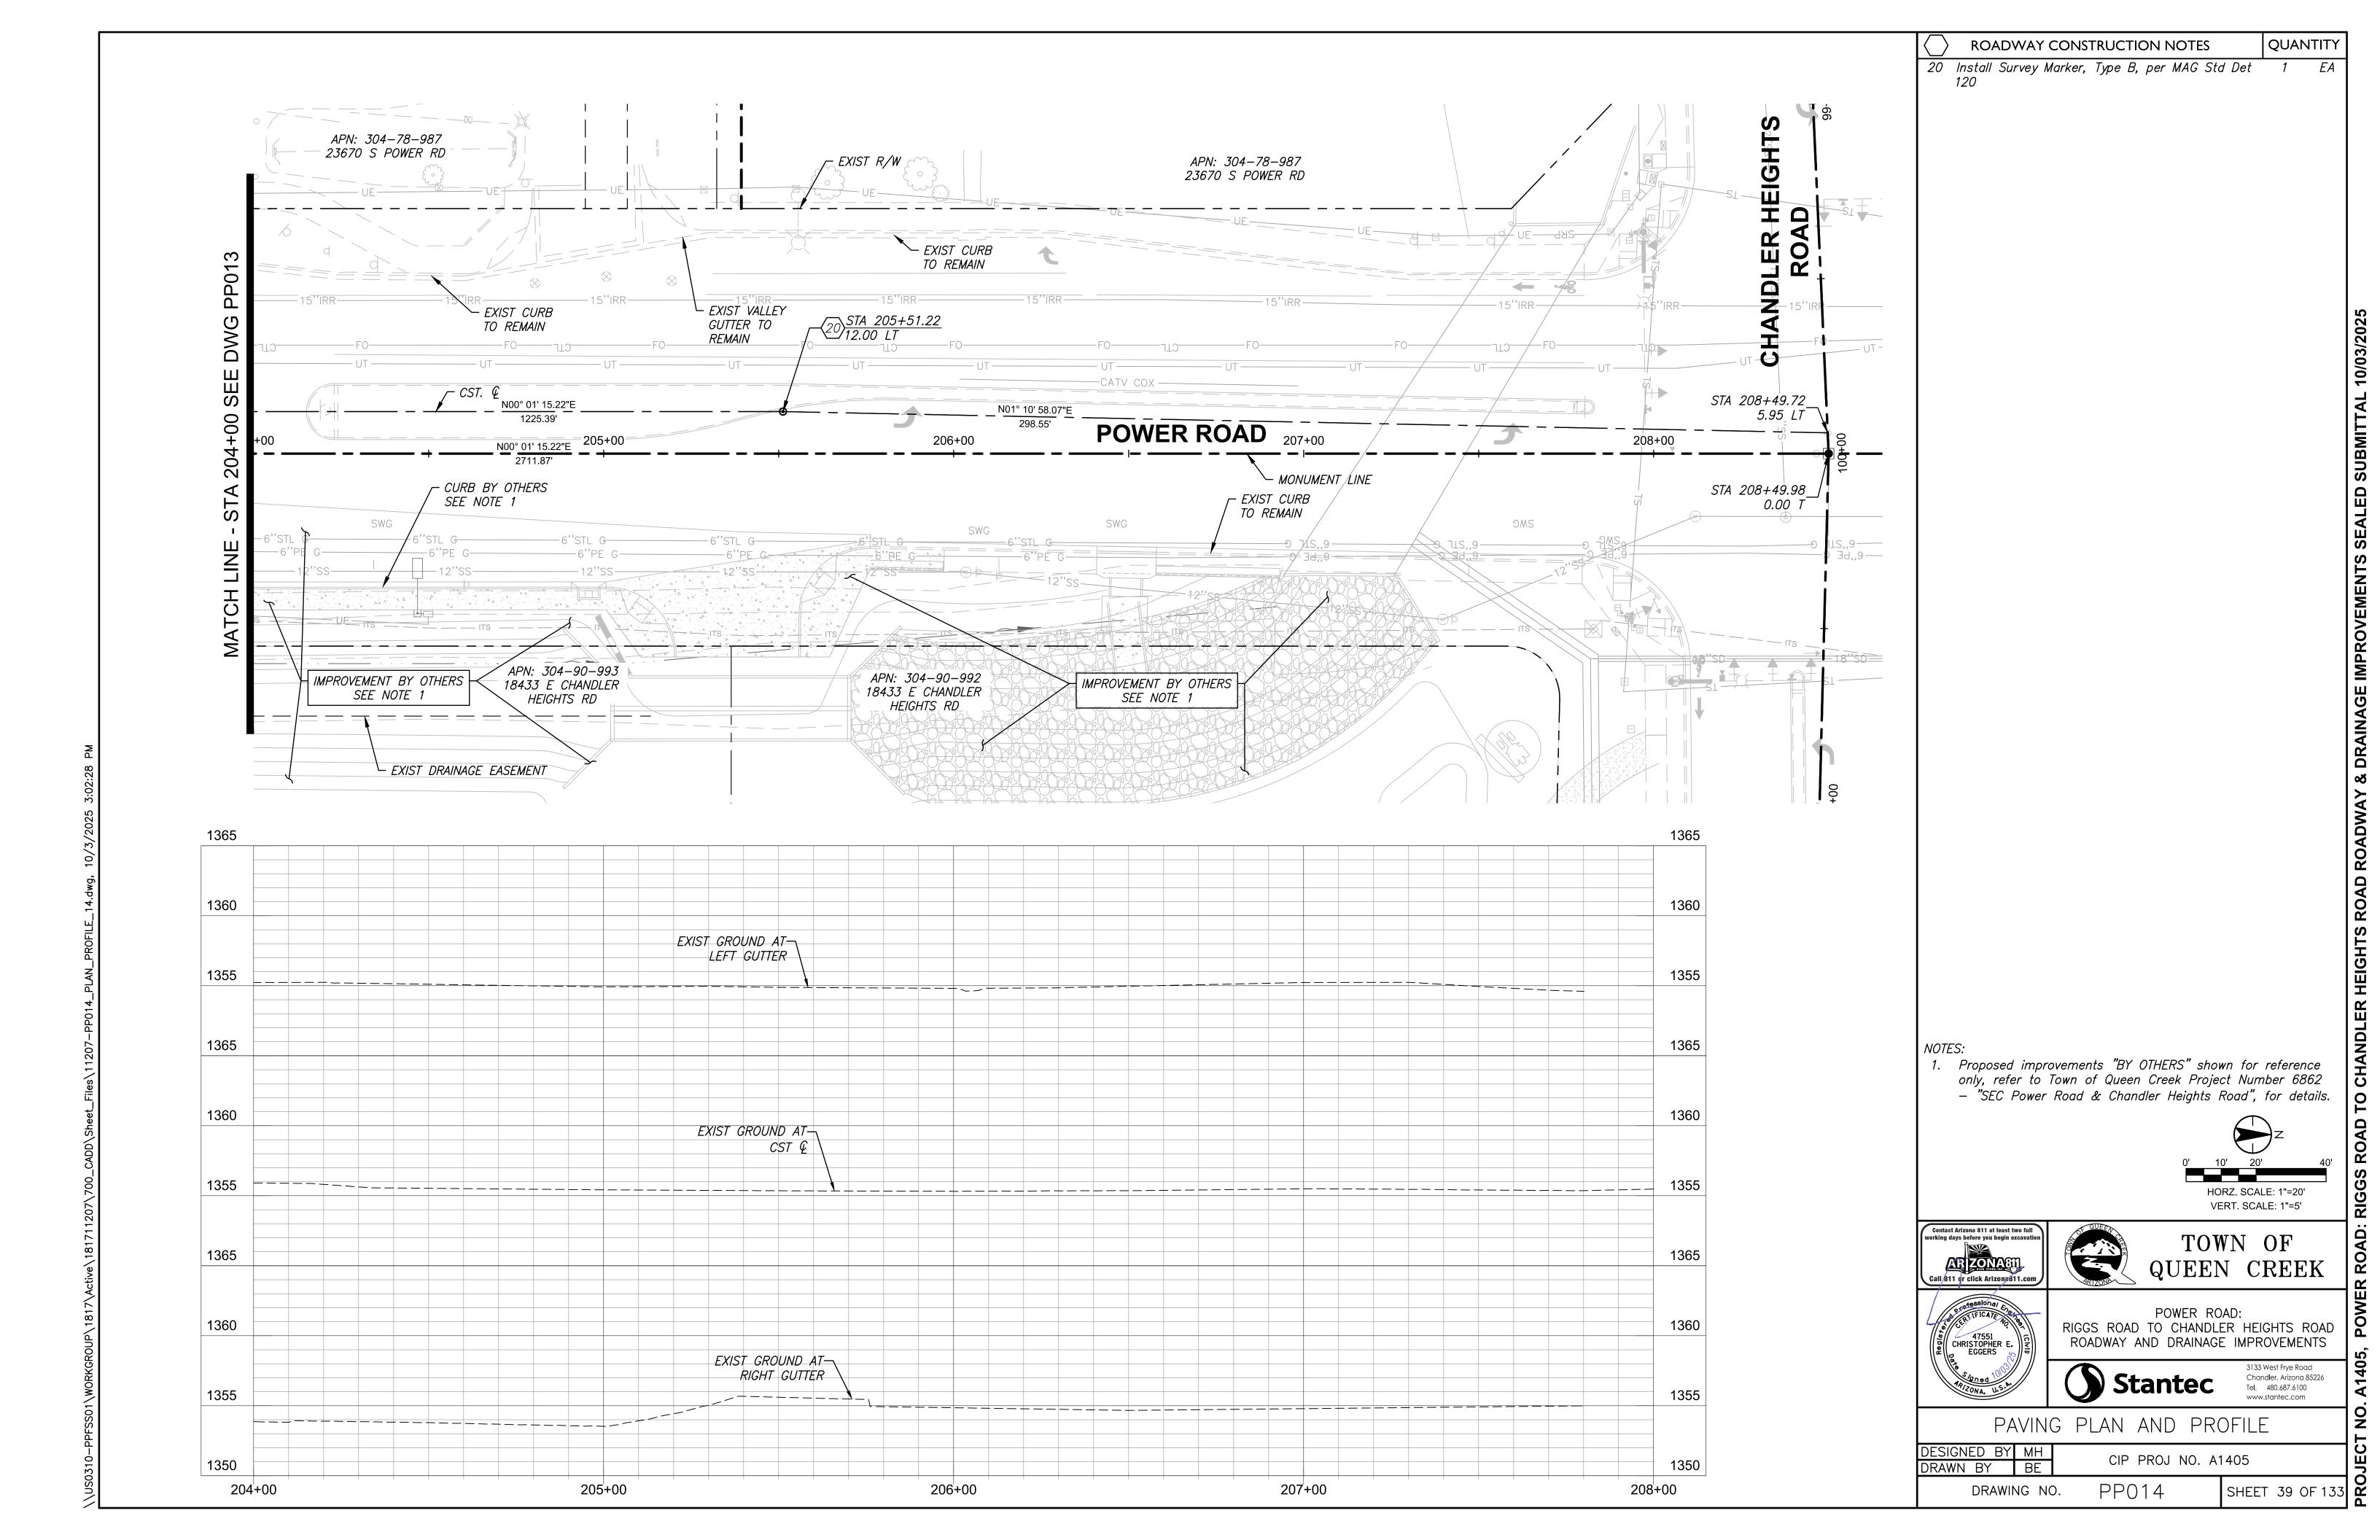


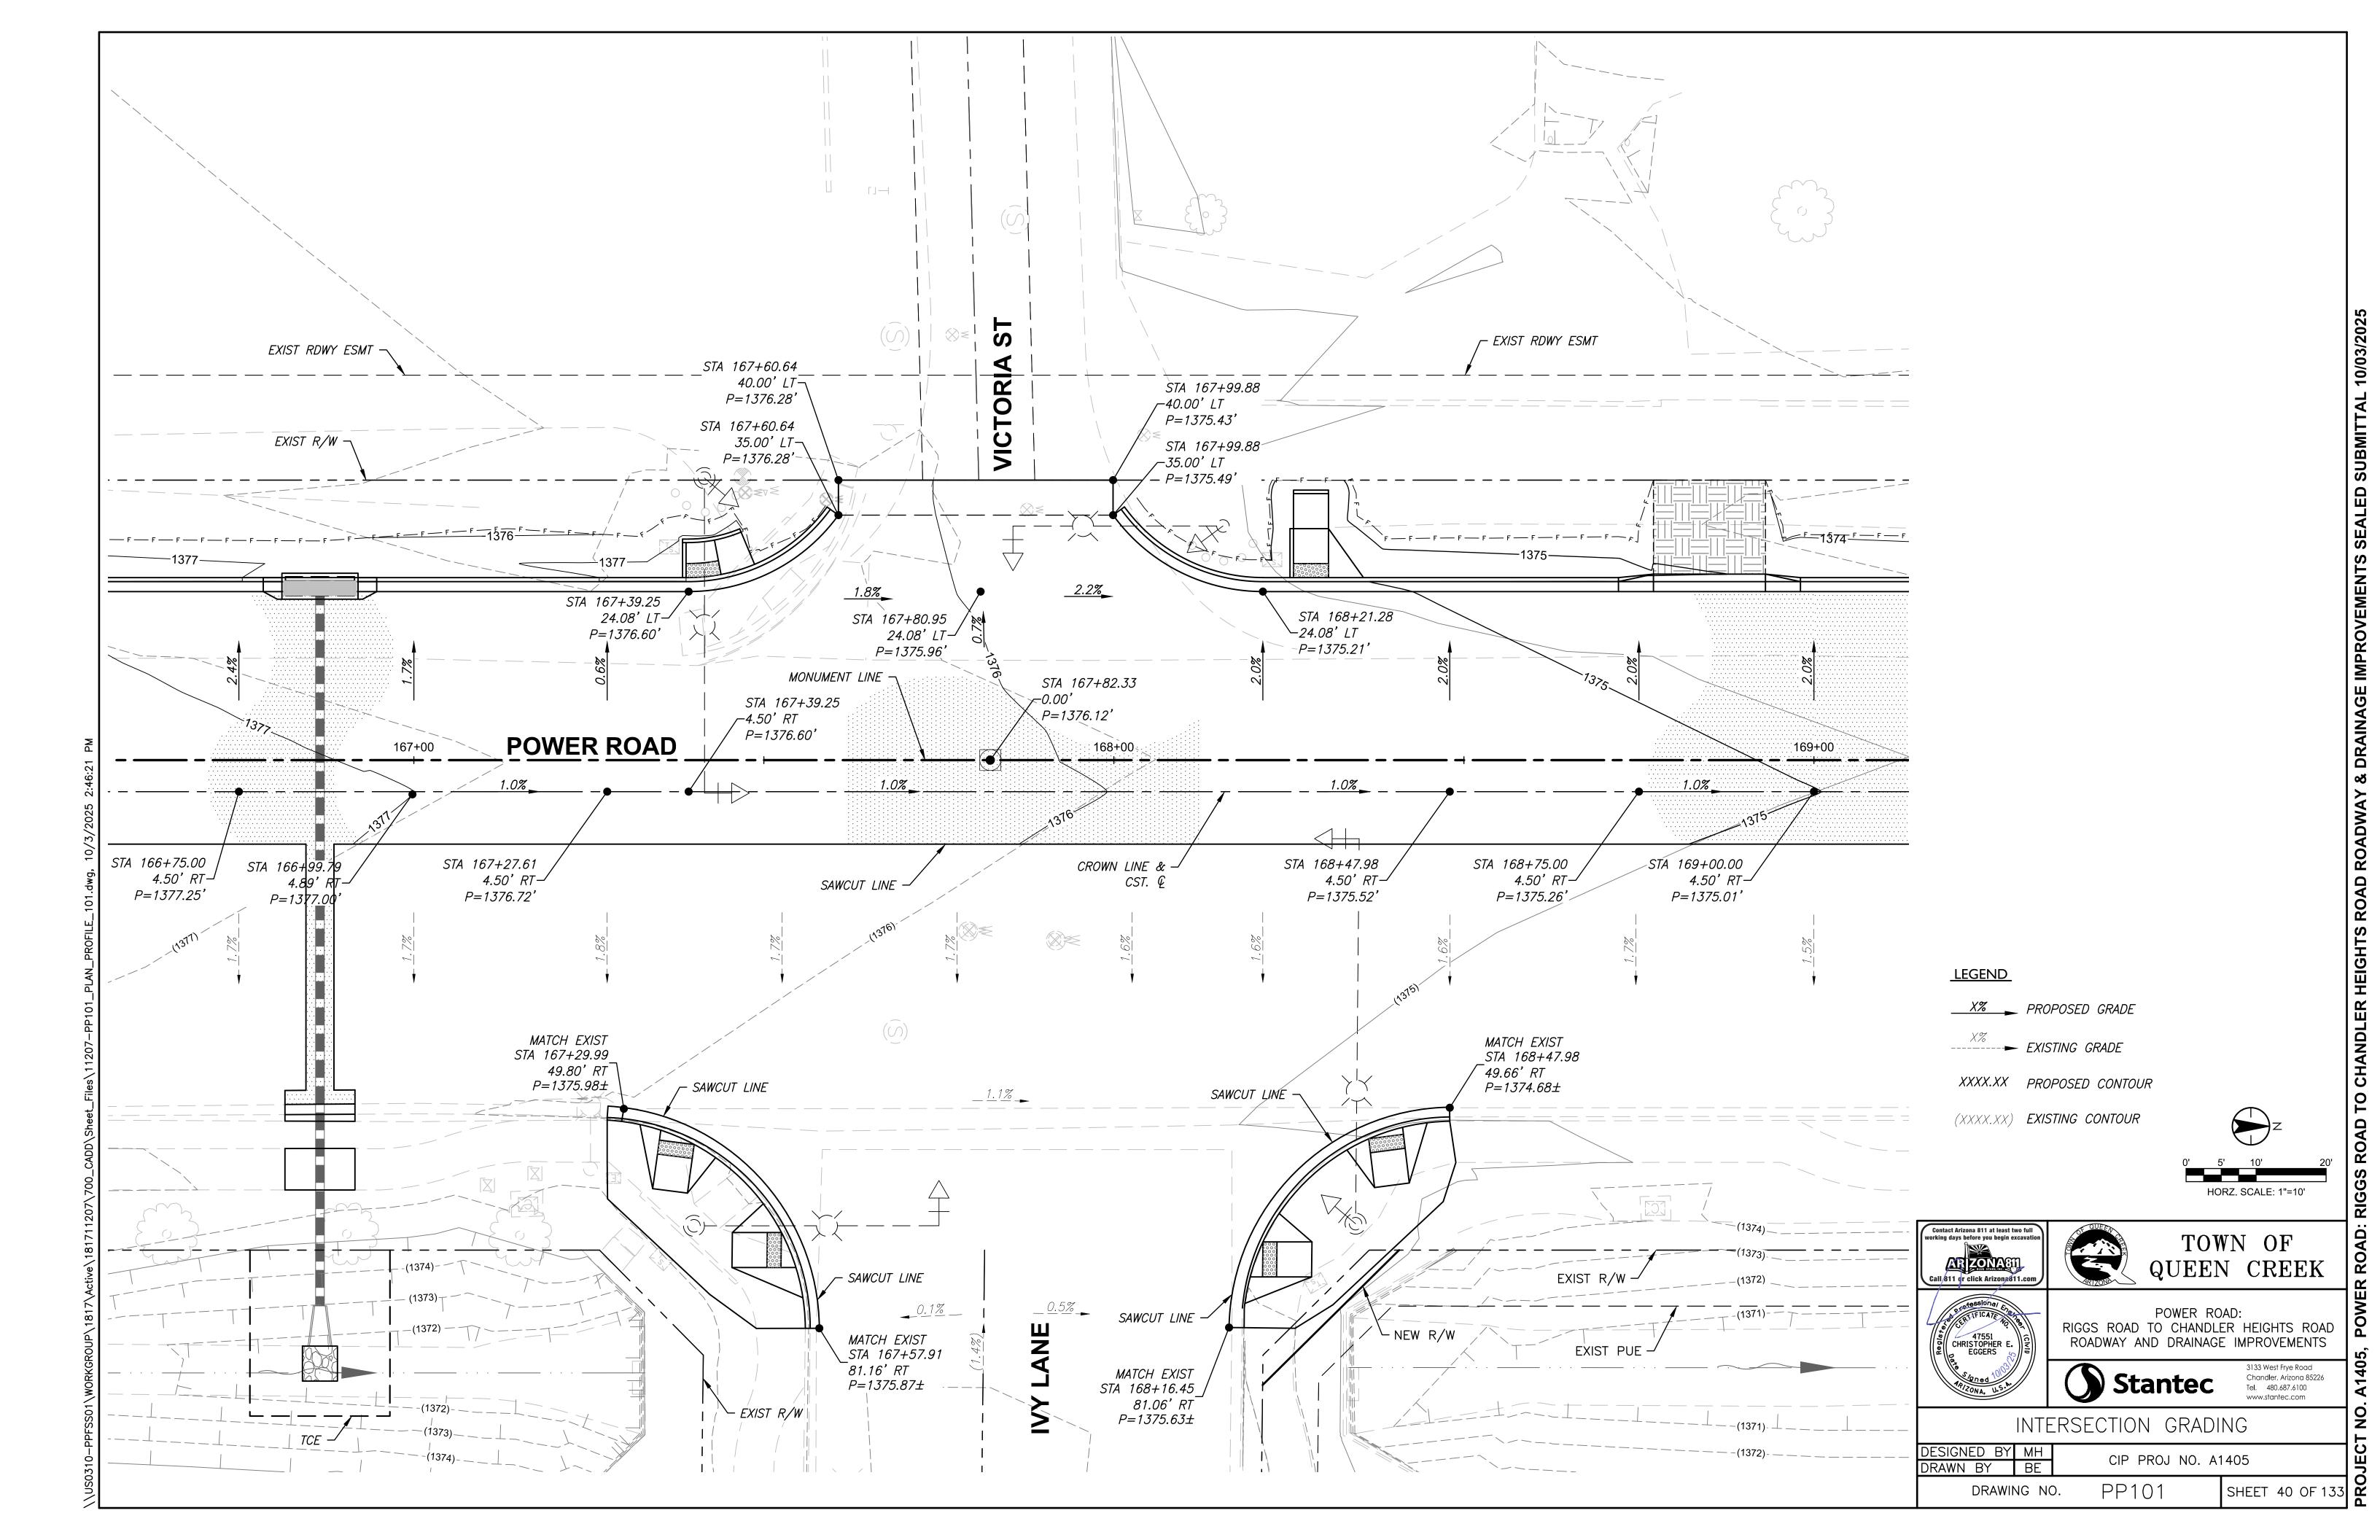


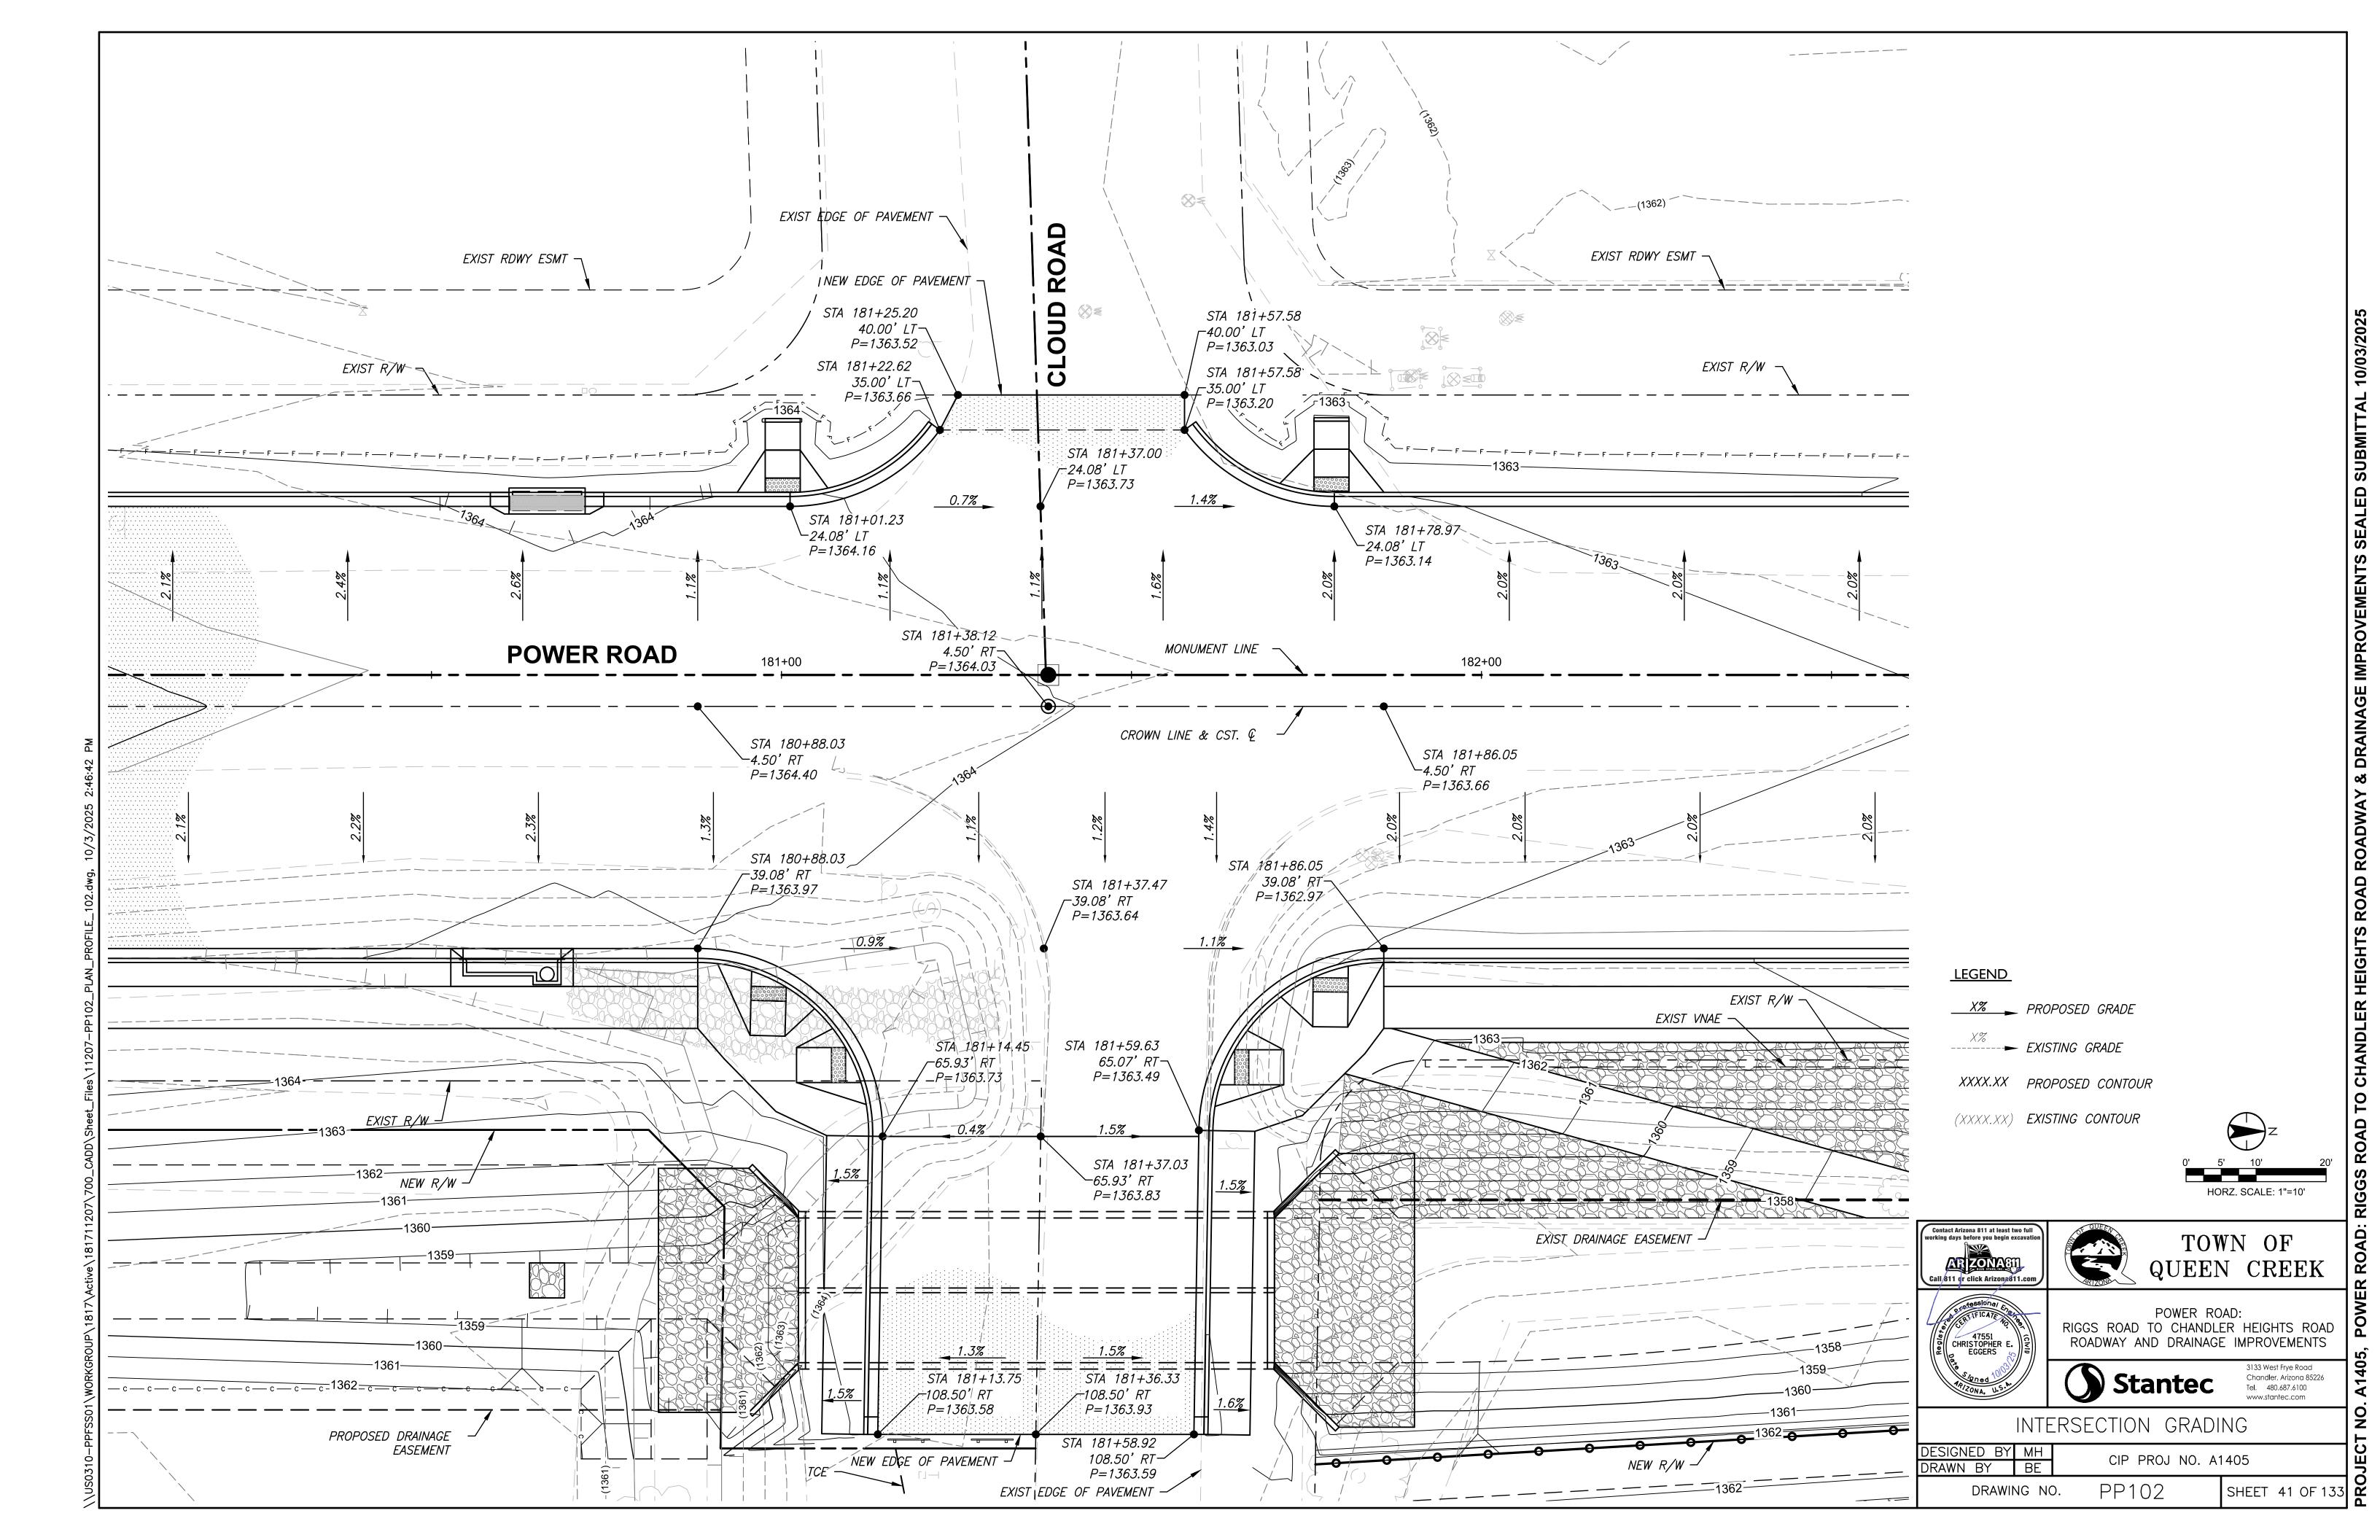


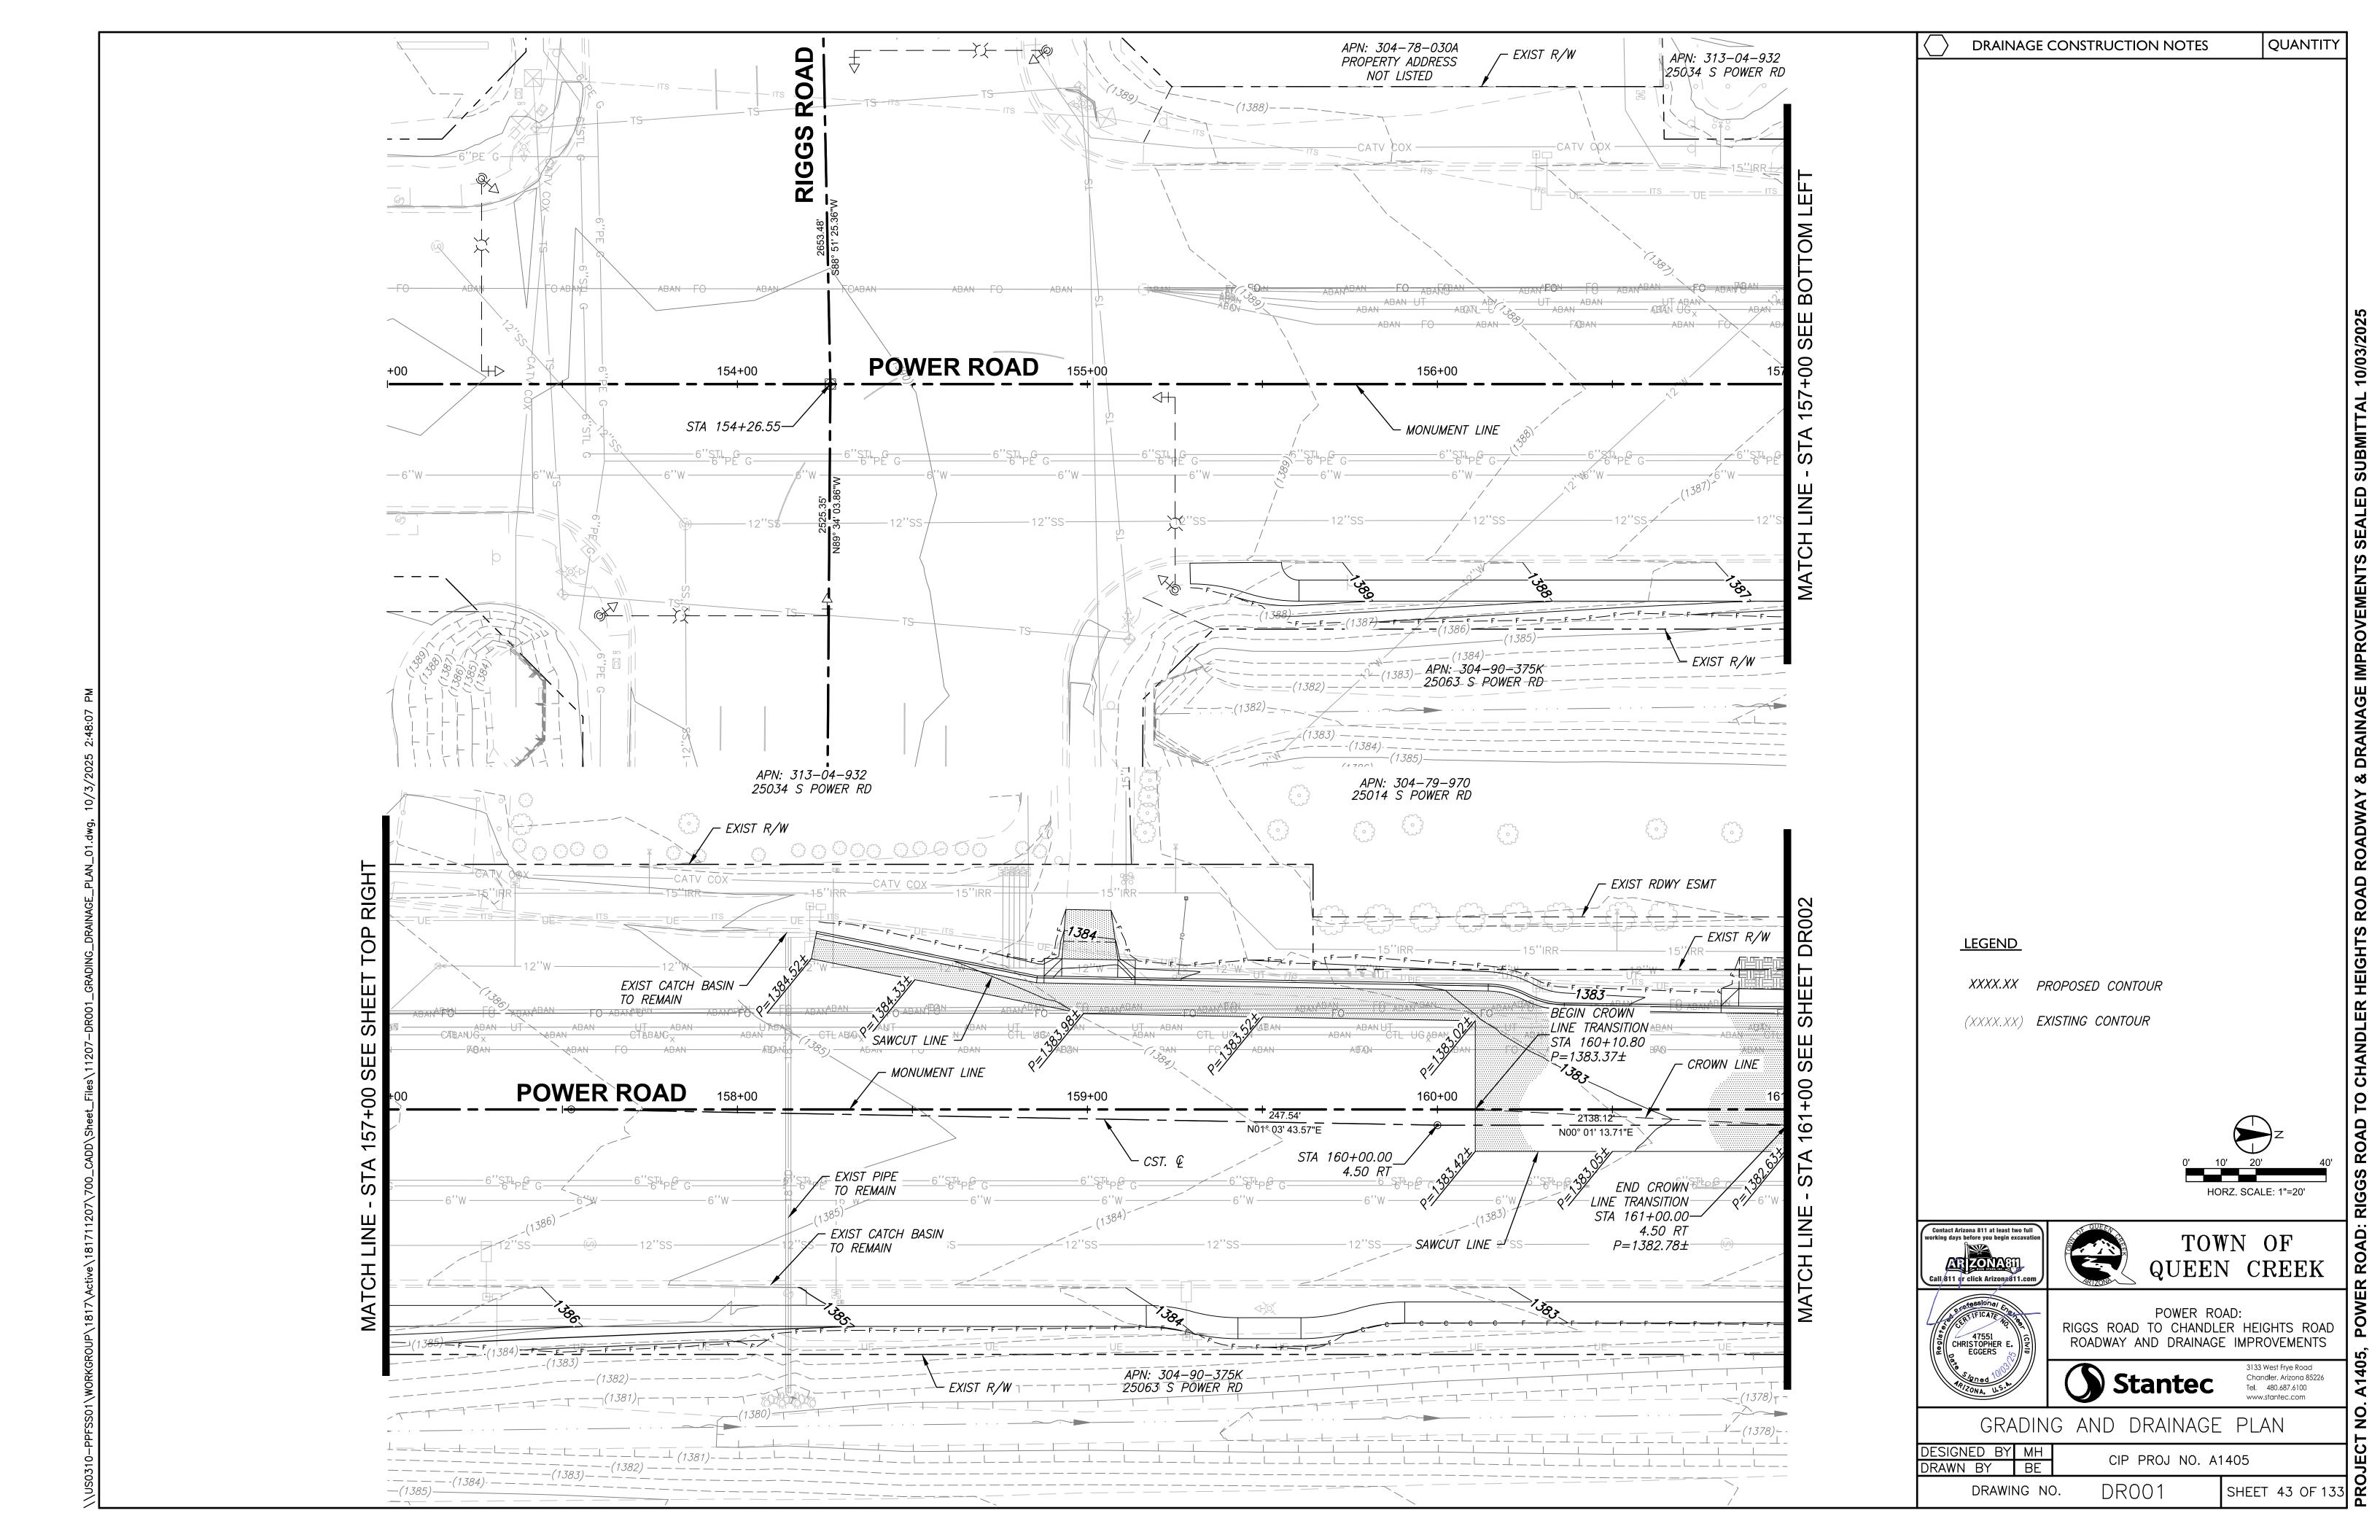


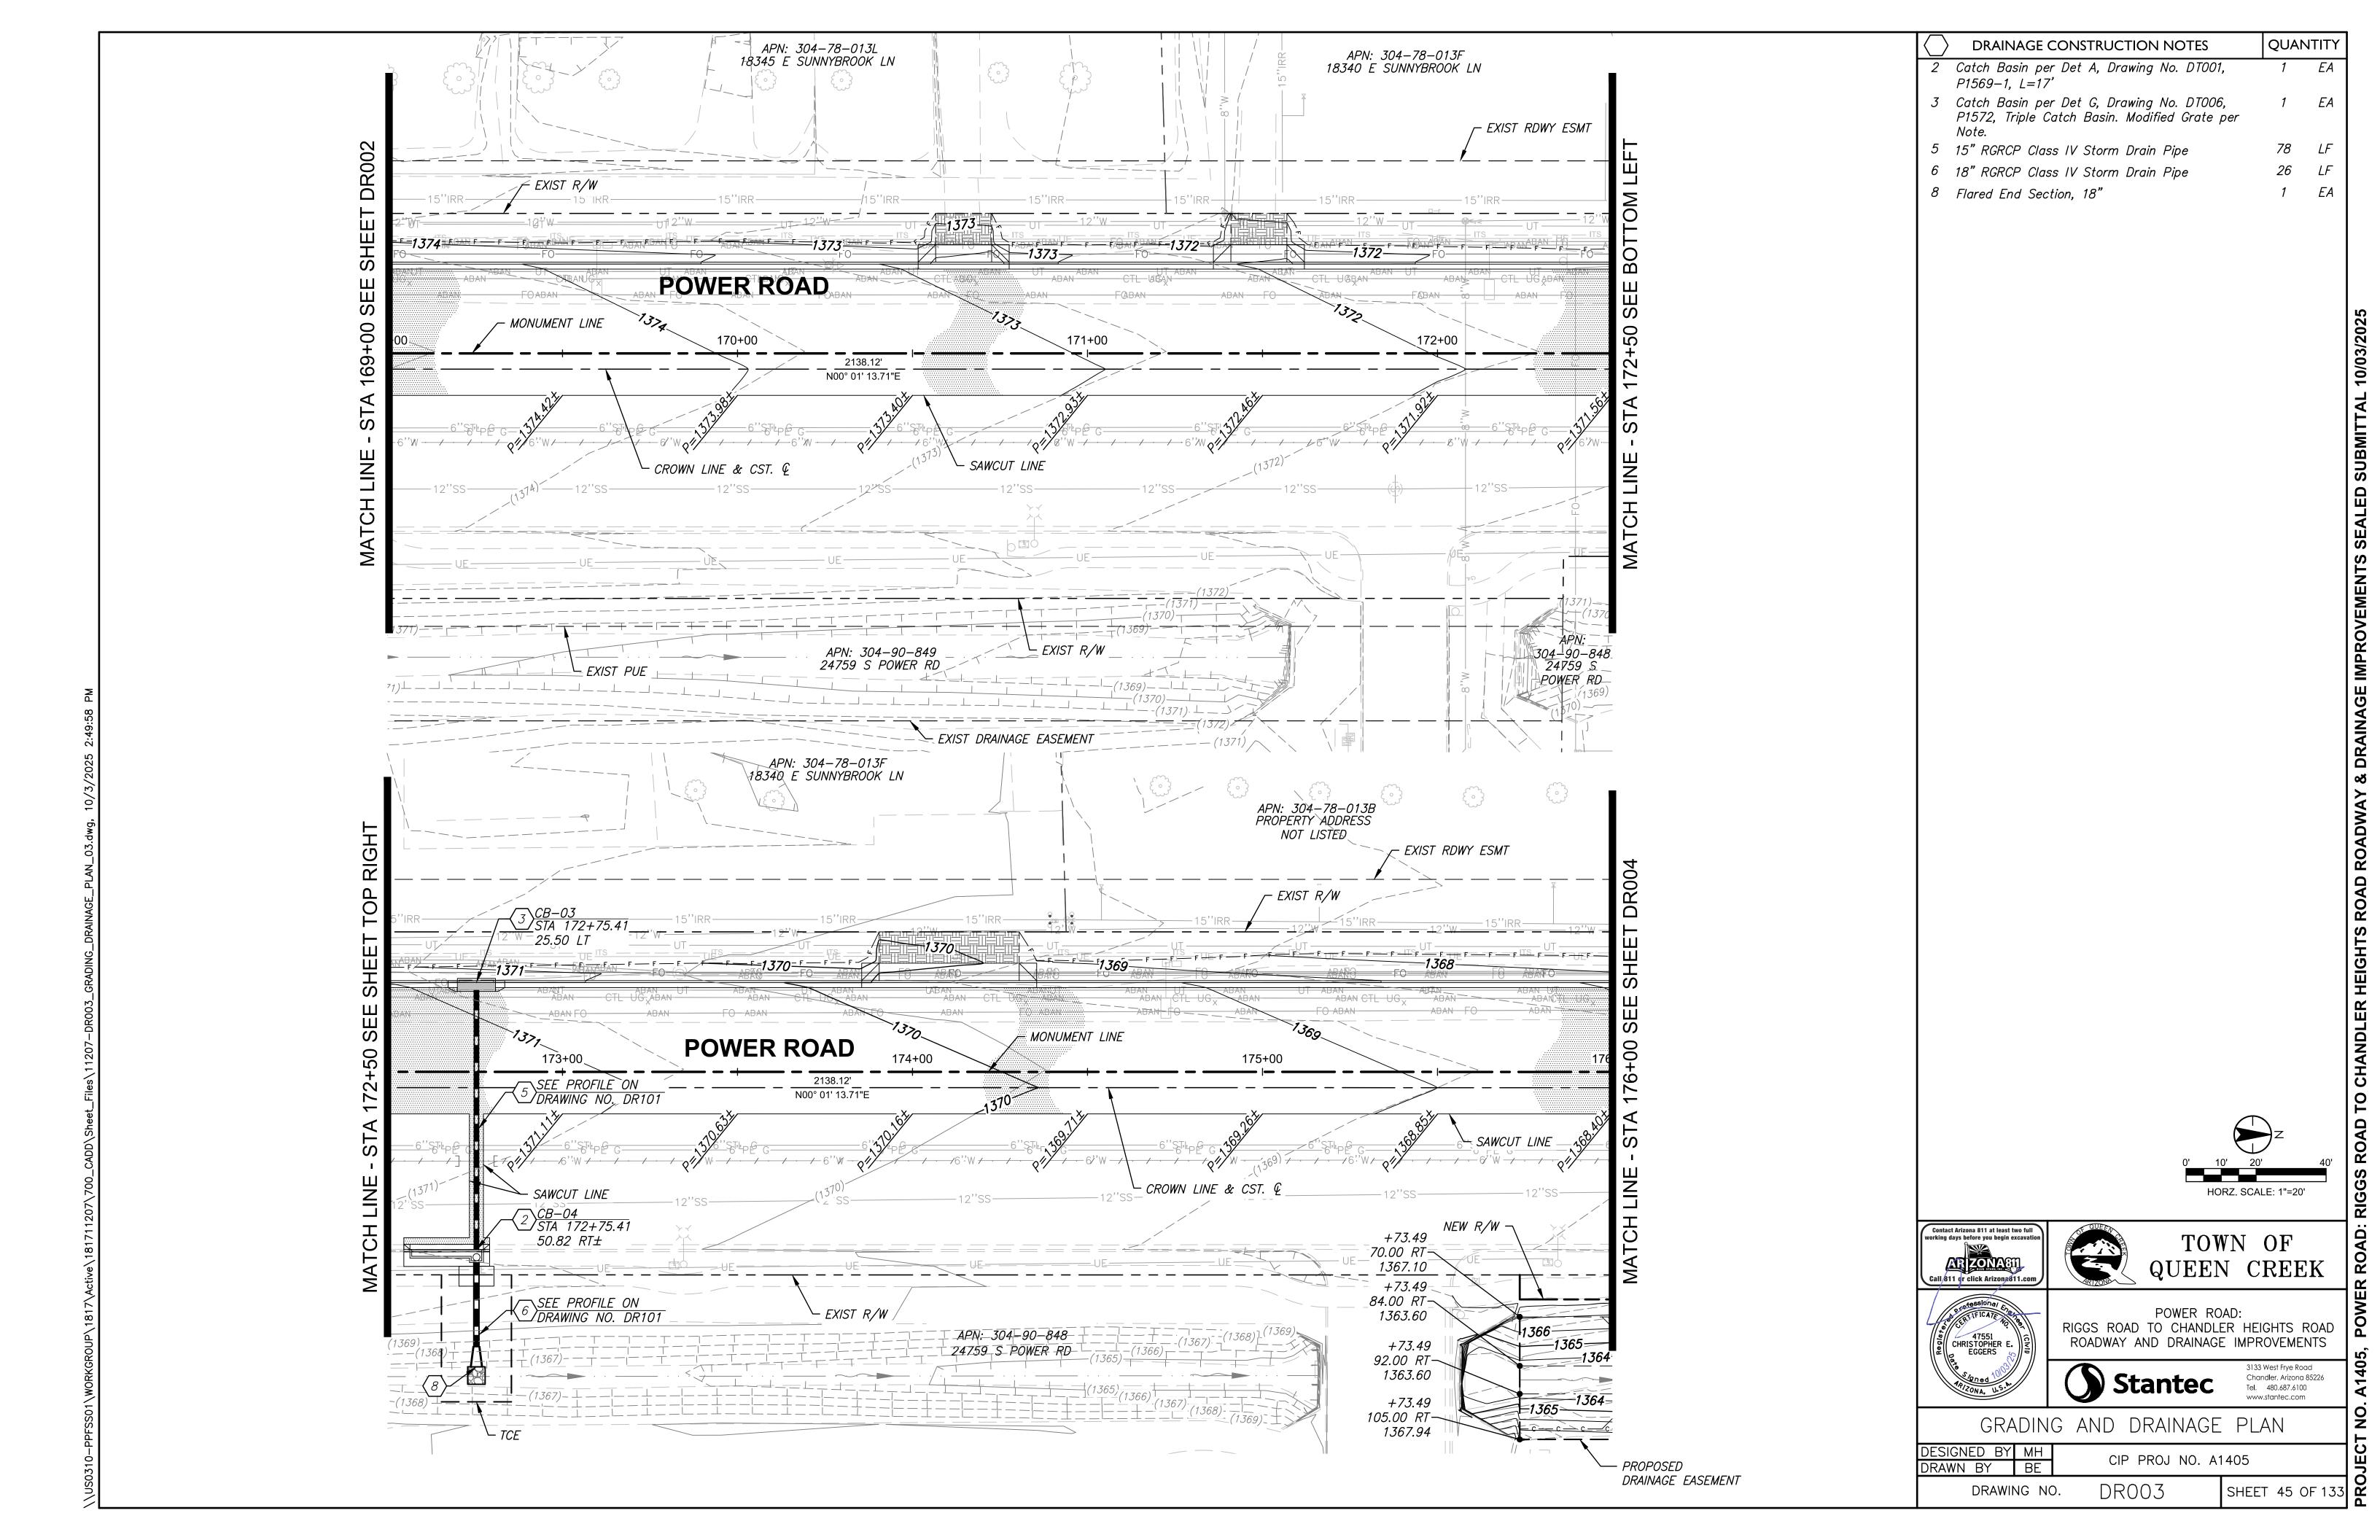


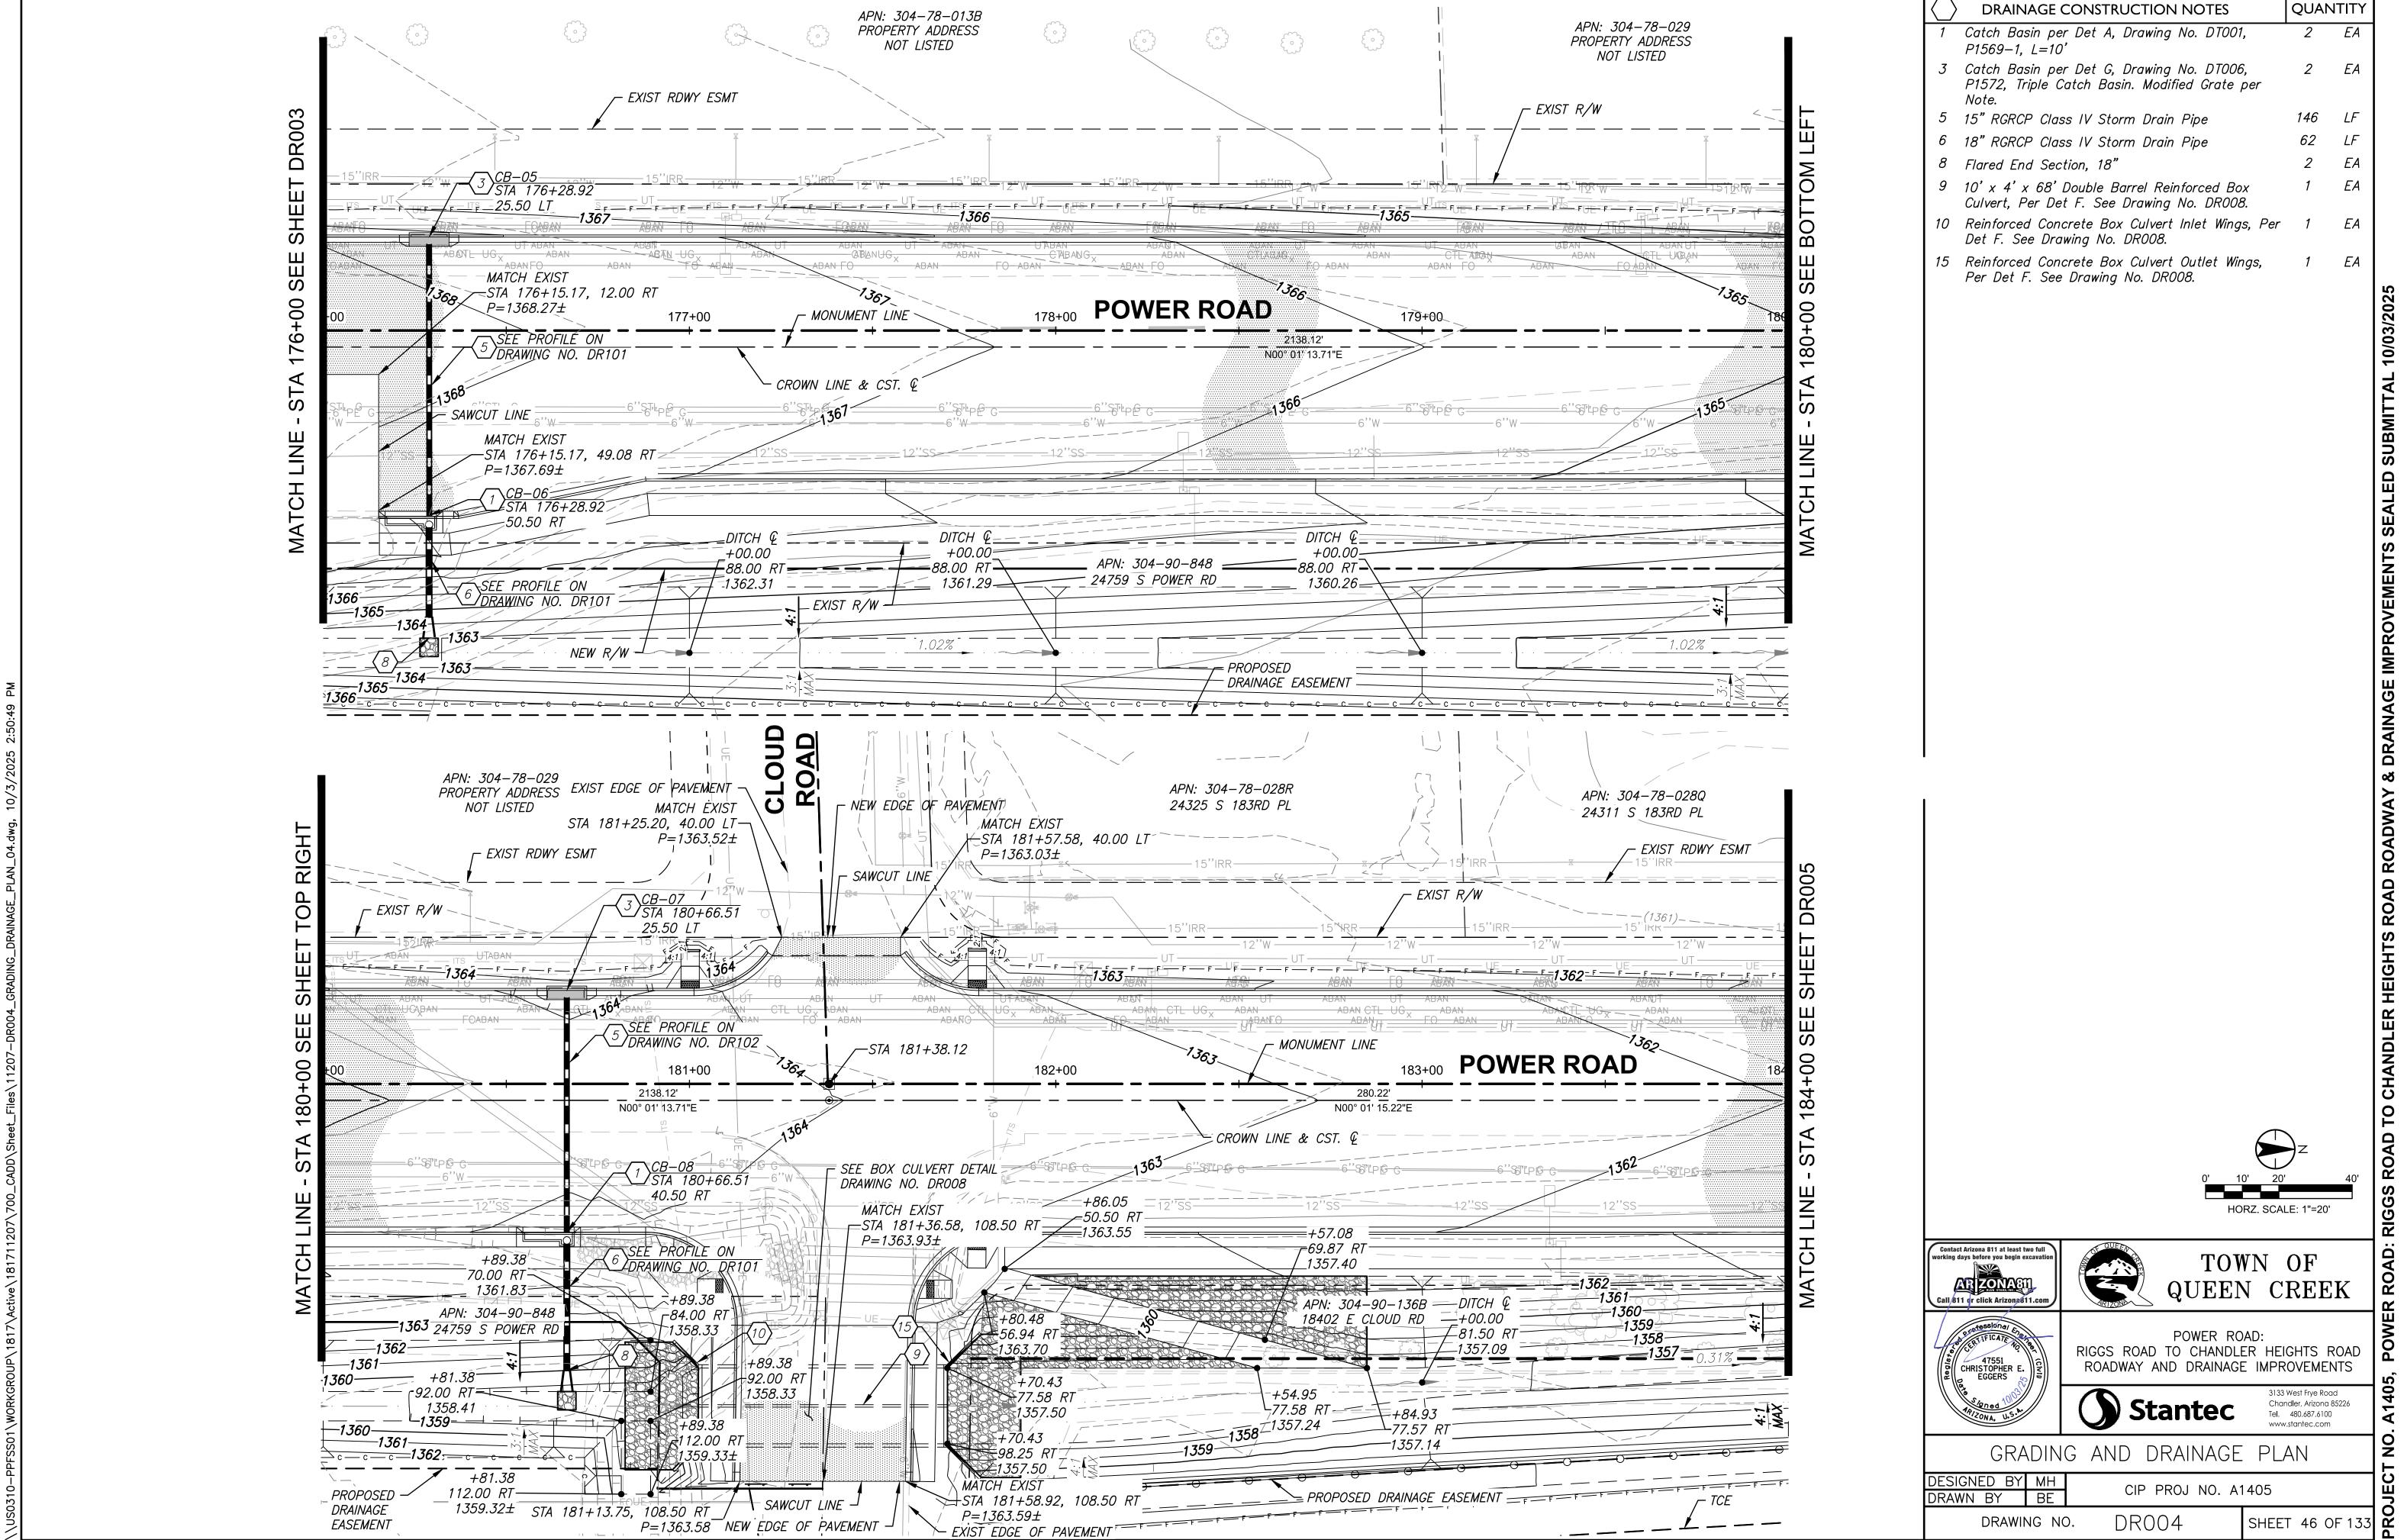

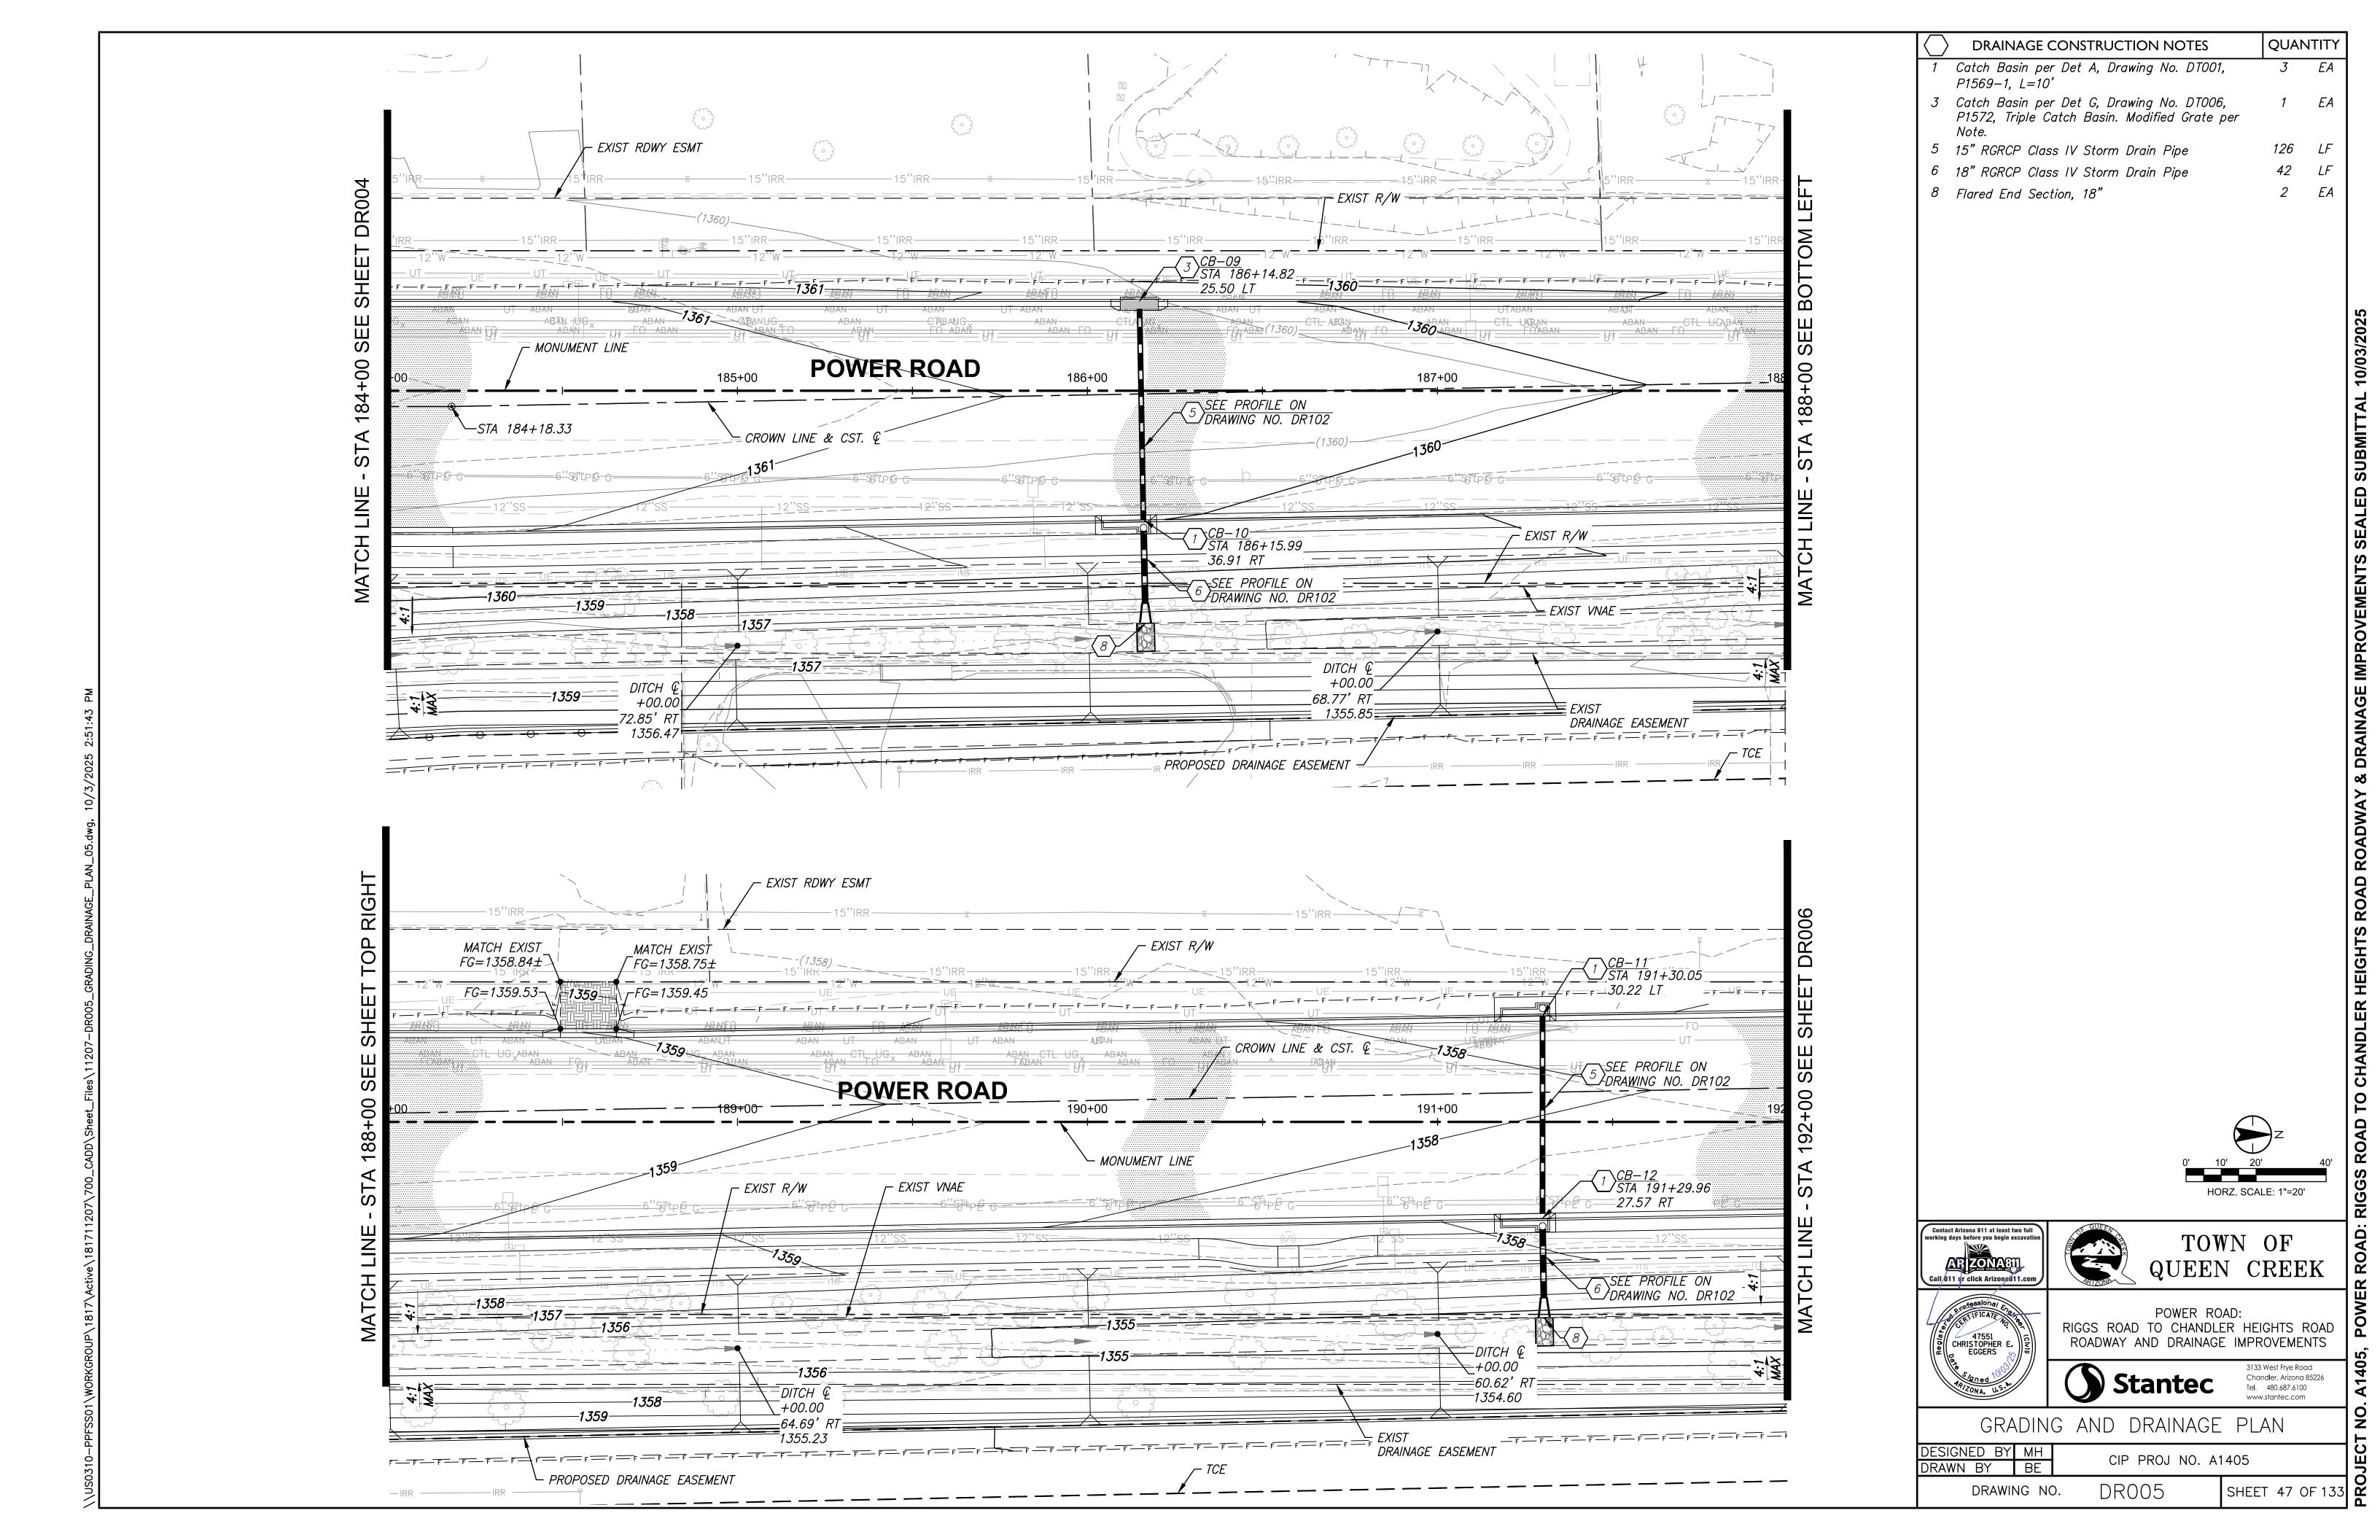

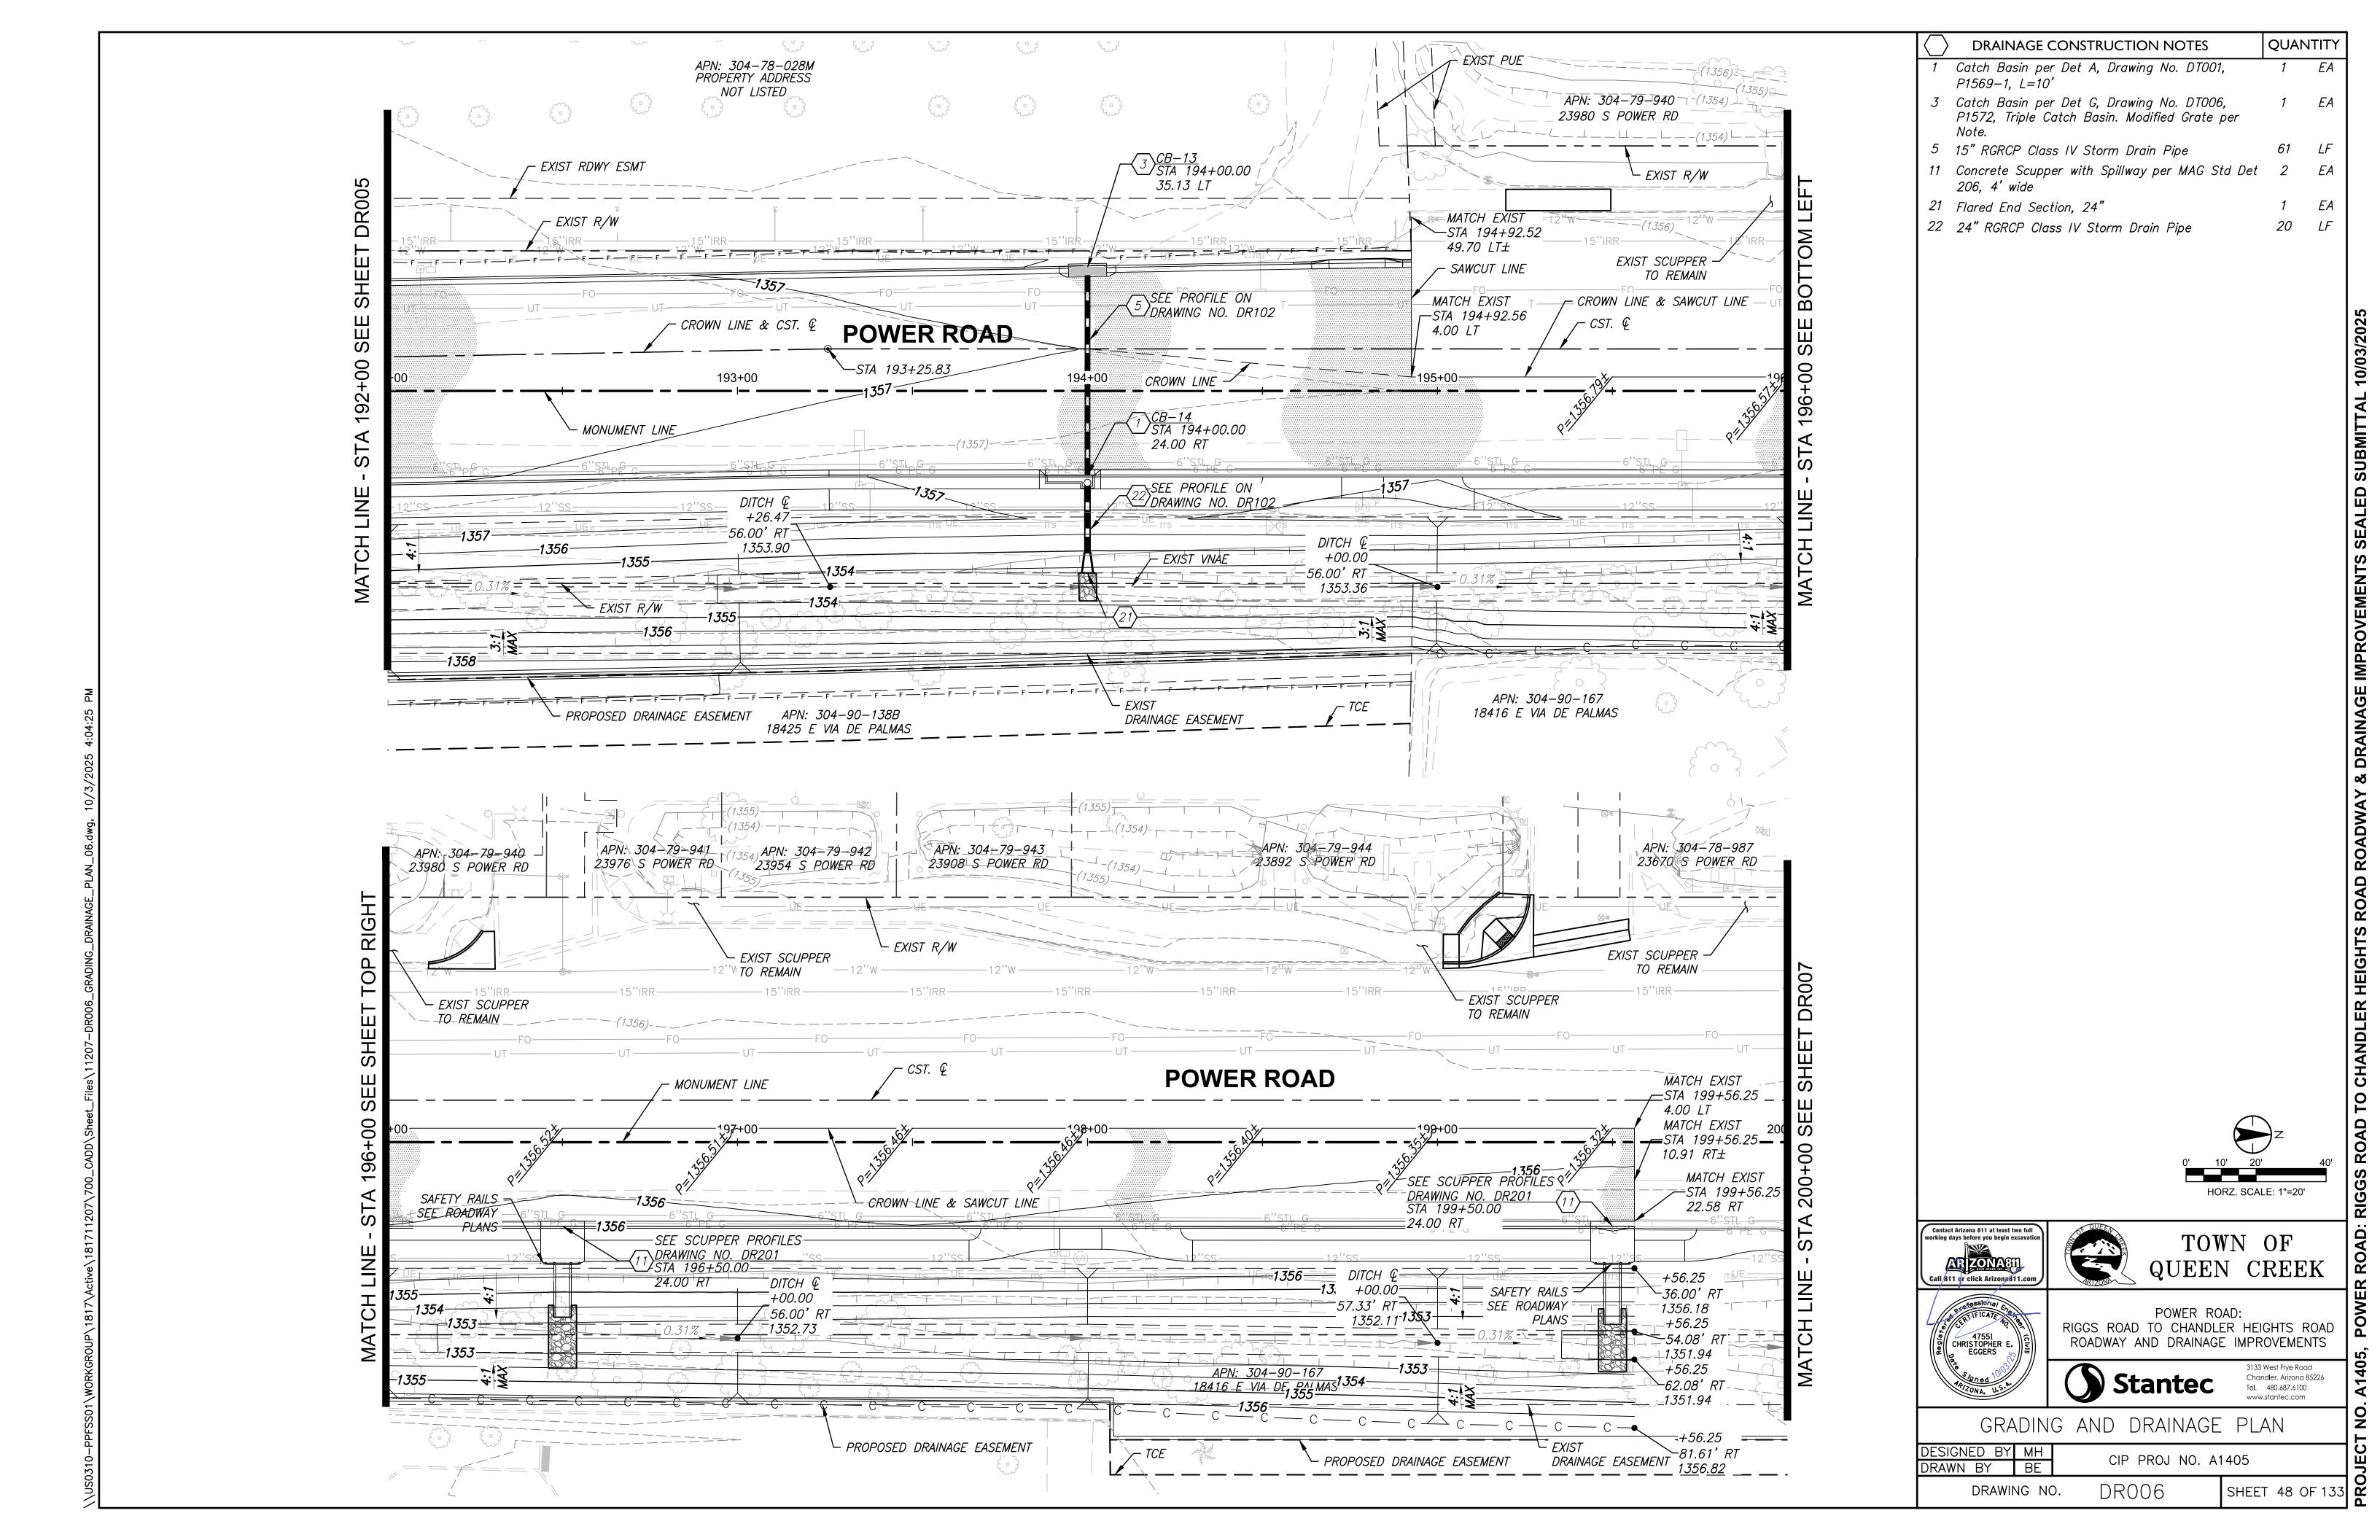

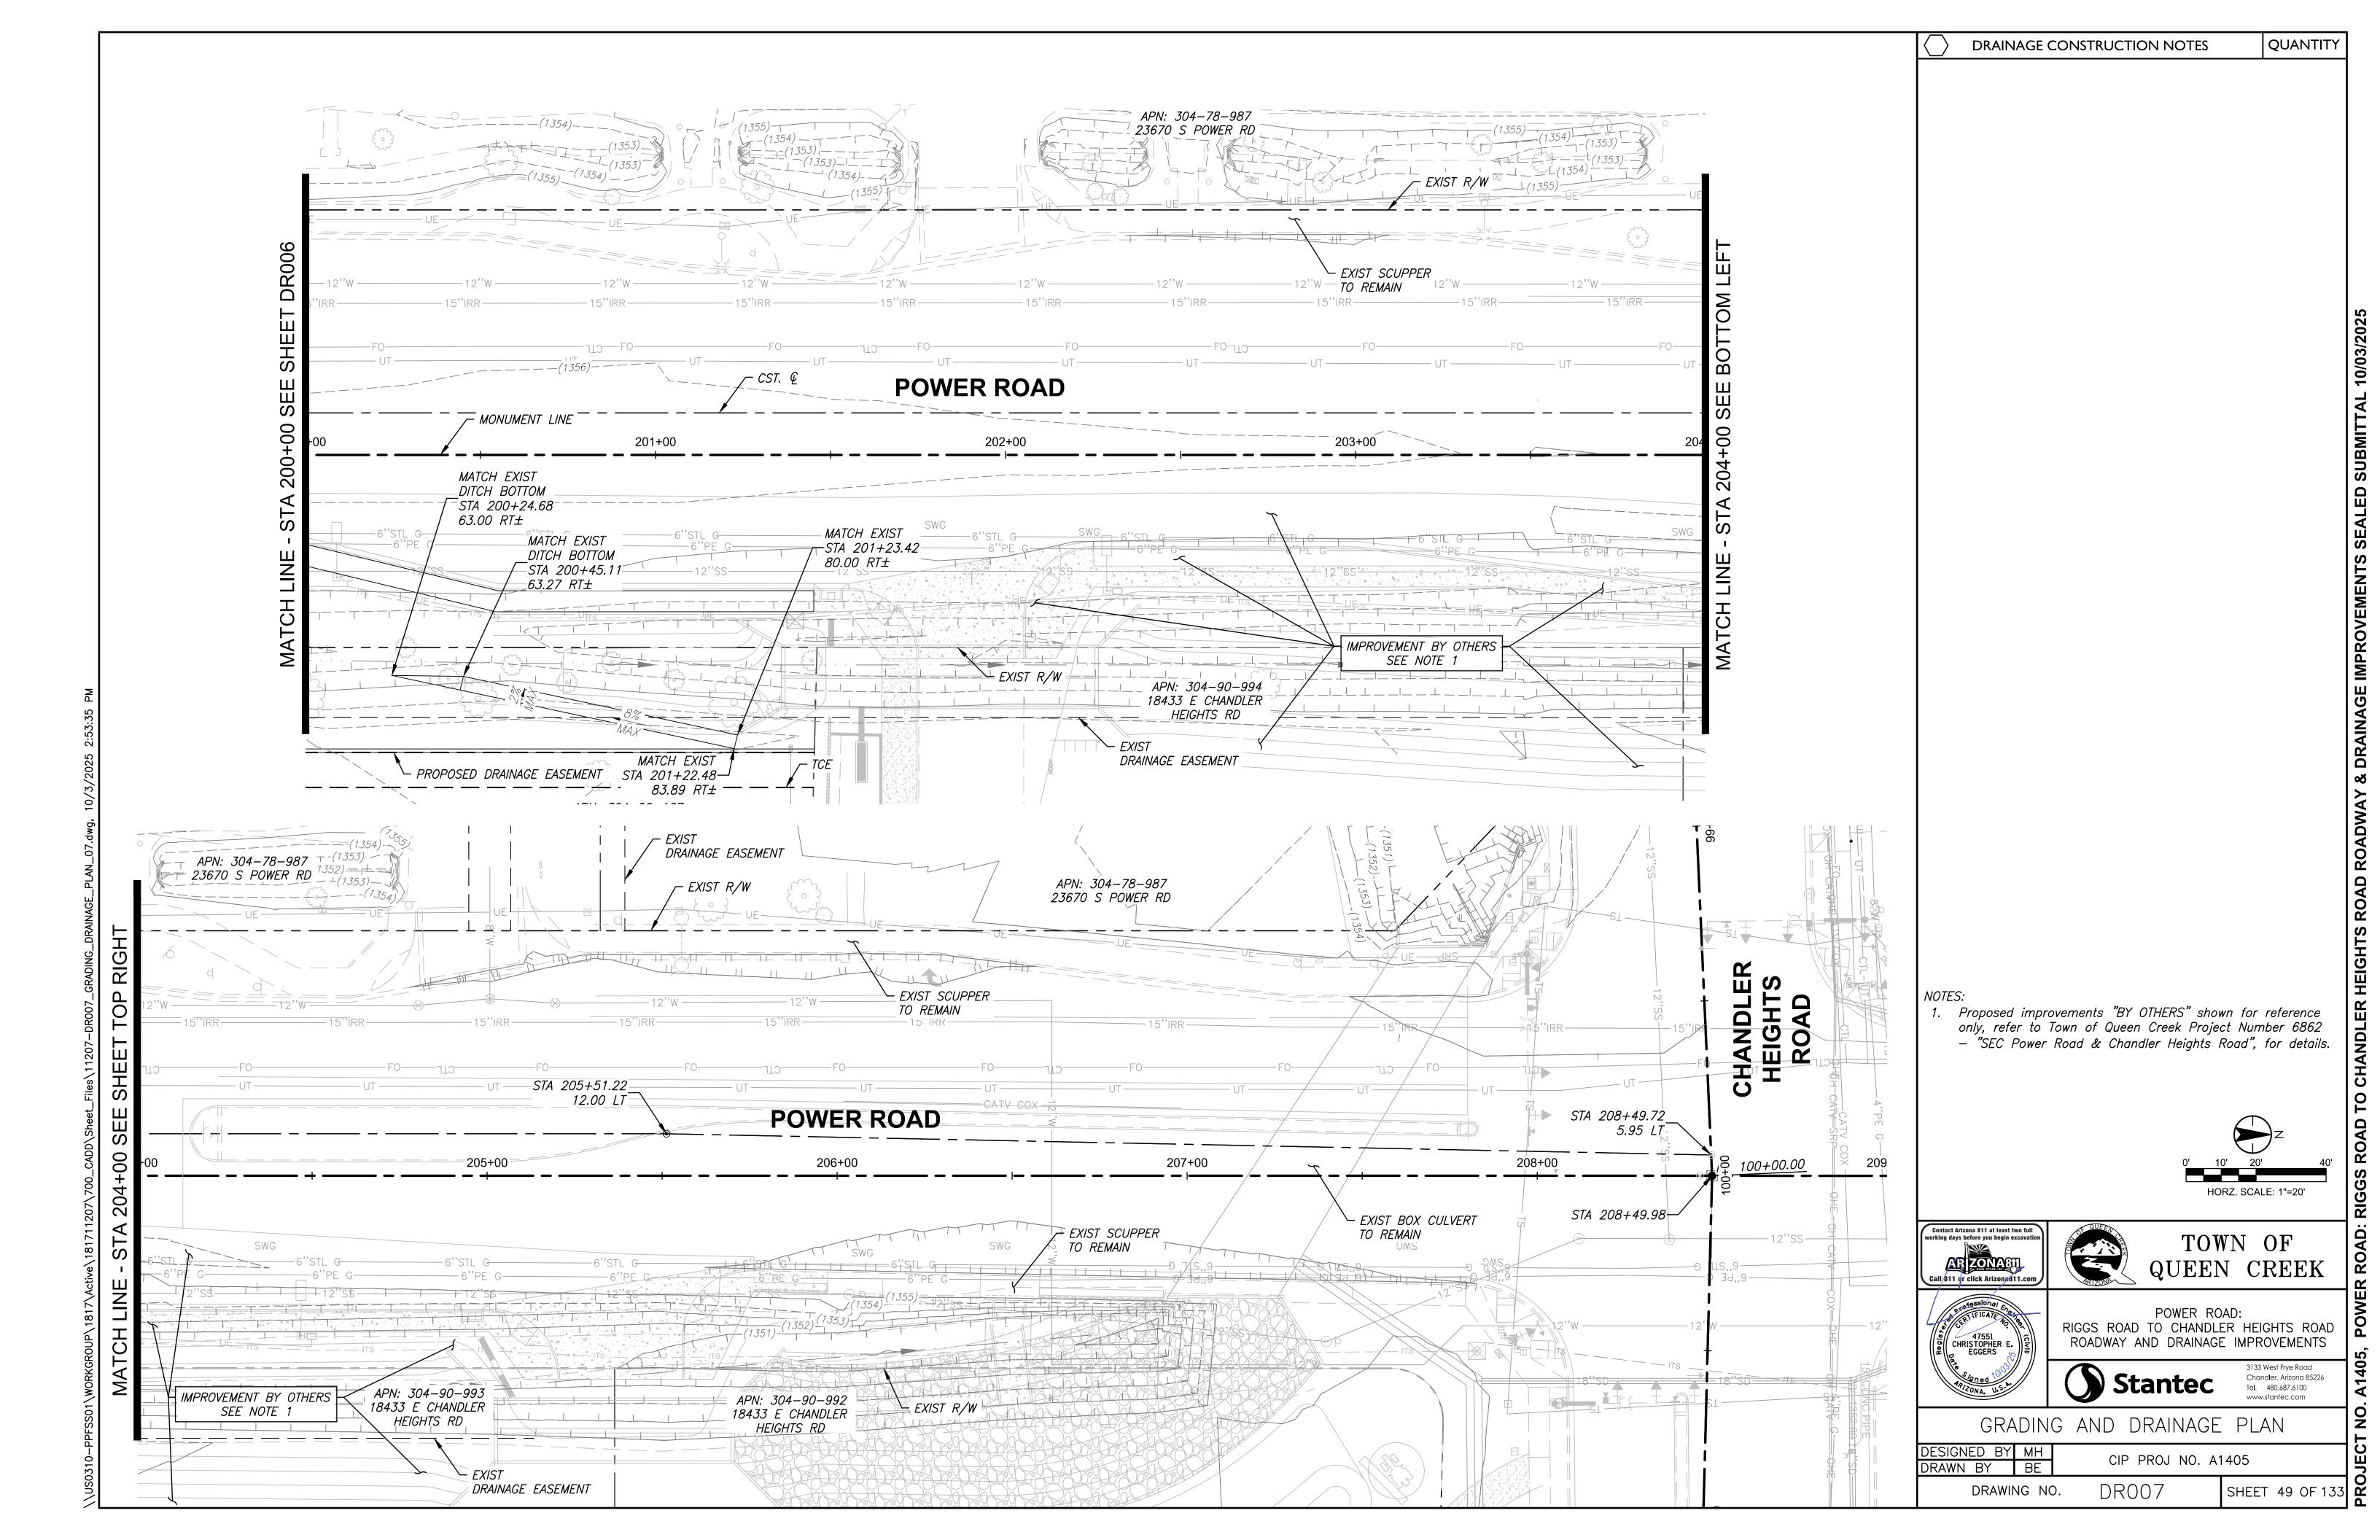


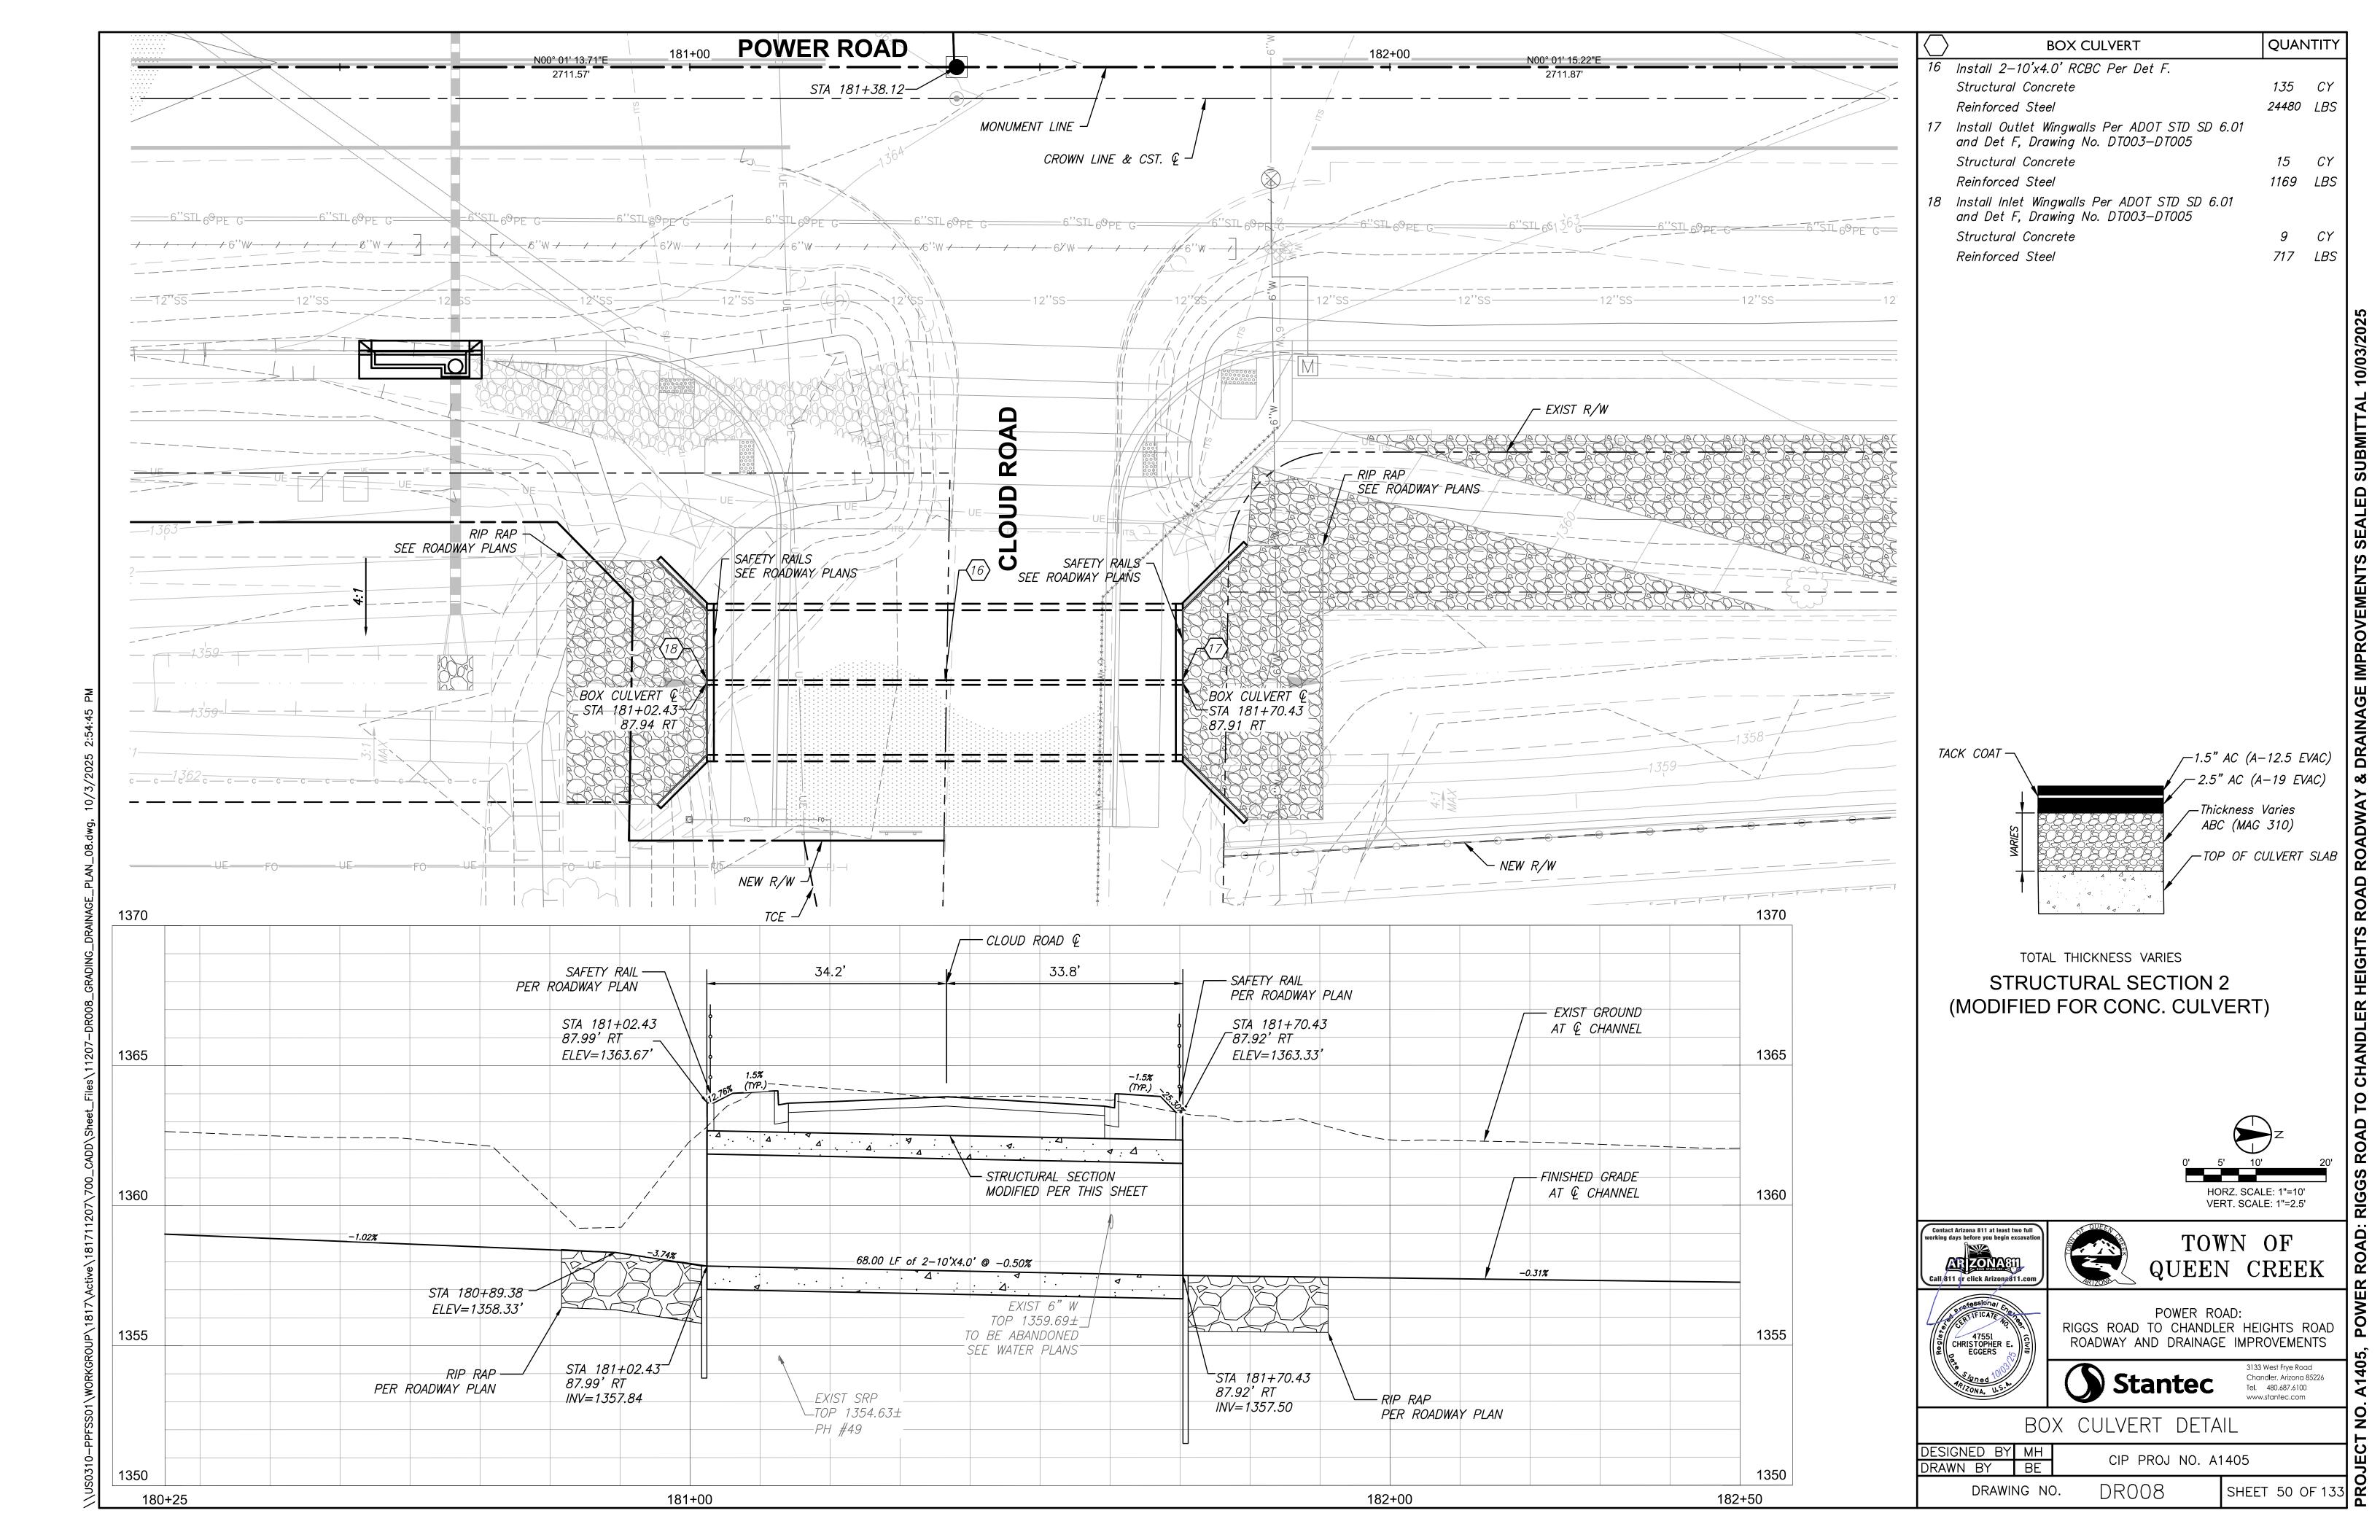

EXIST CTL 4" PVC MONUMENT TOP 1374.87± LINE 1390 1390 (ABANDONED) EXIST CTL 2" HDPE I CROWN & TOP 1374.87± 1385 1385 Cst. 🛭 PH #7. (ABANDONED). **◄** 4.5' EXIST 2.5" CL-TOP XXXX.XX (UNK)-EXIST 6" W FTOP 1372.54± 1380 1380 (ABANDONED) _PROPOSED *--EXI\$T* EXIST 12" W-GRADE GRADE -TOP 1371.89 $\pm =$ (ASSUMED)-1375 1375 103 L.A. @ 0.0092 ft/ft EXIST CTL 4 1370 1370 TOP 1373.24±(ASSUMED) EXIST 6" G PE *□TOP 1371.12±* EXIST CTL 4" TOP 1373.24±(ASSUMED) PH#10 EXIST CTL 1365 1365 -EXIST 6" G STL TOP 1373.14 ± *□TOP 1370.40±* EXIST 2" UE -(ASSUMED)(ABANDONED): *└_TOP 1373.44±*--EXIST CTL 2" HDPE EXIST 12" SS -PH #12 TOP 1373.14± 1360 PH #8⁼ INV 1361.35± (ABANDONED) EXIST CTL--TOP 1373.14±= 1355 1355 (ABANDONED)


(ABANDONED)

STA 163+08

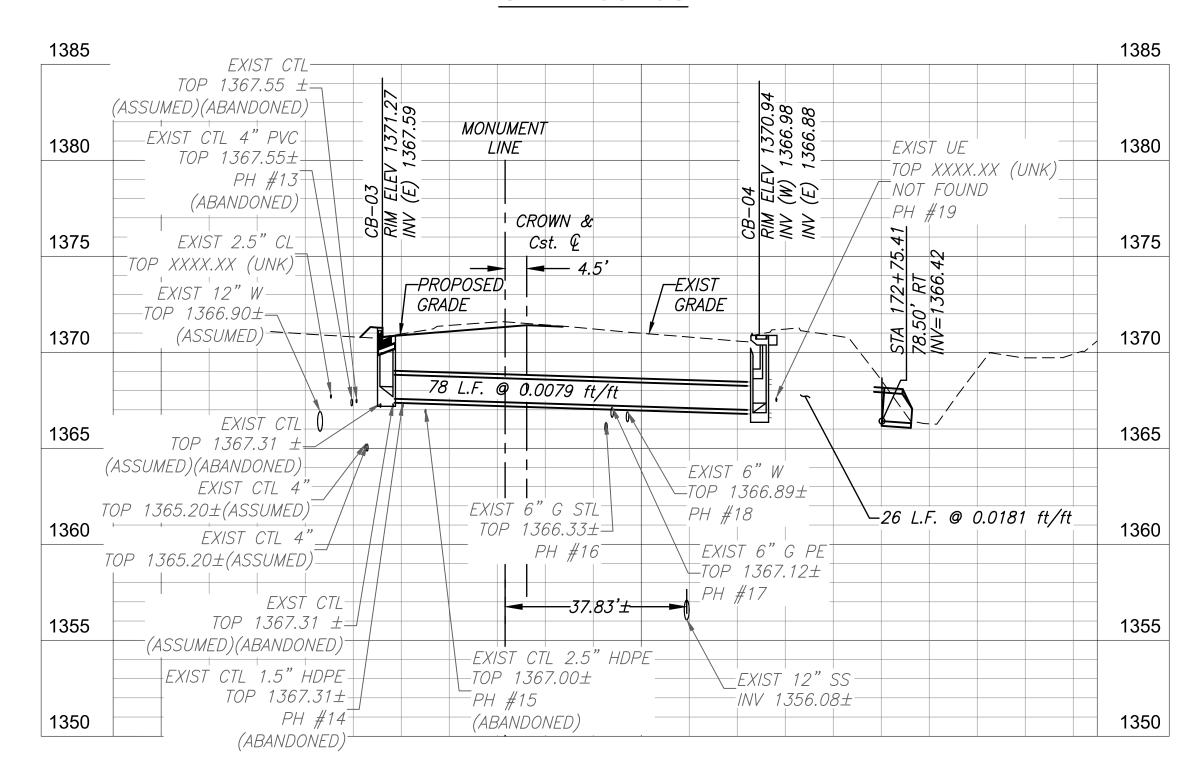

STA 172+76

STA 166+87

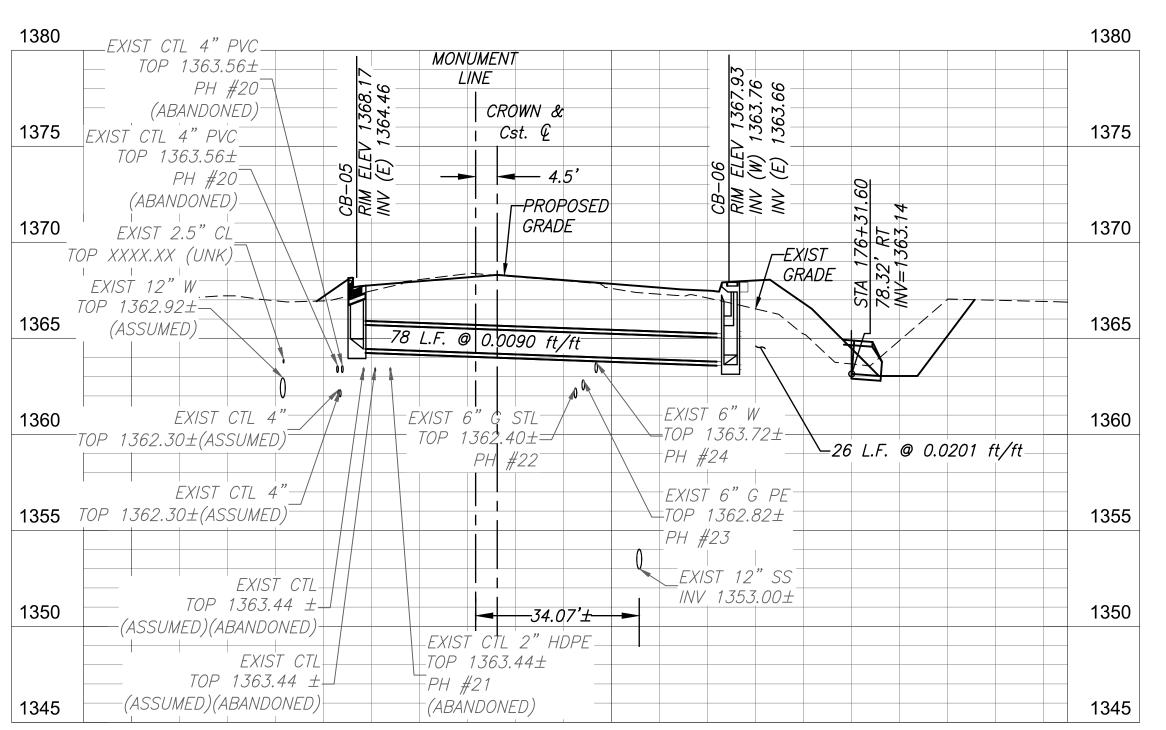


STA 176+31

NOTES:

CONTRACTOR SHALL PROVIDE ADEQUATE COVER DURING CONSTRUCTION OVER ALL PIPES TO AVOID DAMAGE. ANY DAMAGE THAT OCCURS TO THE PIPE DURING CONSTRUCTION SHALL BE REPLACED AT NO COST TO THE TOWN.

EXISTING CENTURYLINK LINES SHOWN AS "ABANDONED" ARE IDENTIFIED AS SUCH BASED ON THE DESIGN PLANS FOR CTL PROJECT NO. P.080046. CONTRACTOR SHALL FIELD VERIFY THE STATUS OF ALL CENTURYLINK FACILITIES AND COORDINATE DIRECTLY WITH CENTURYLINK TO CONFIRM ABANDONMENT PRIOR TO ANY REMOVAL, RELOCATION OR DISTURBANCE TO THE LINES.

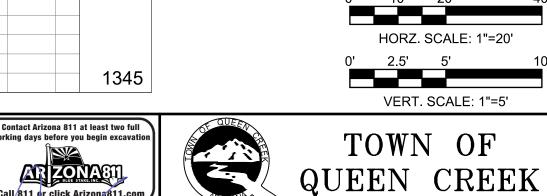



POWER ROAD: ROAD TO CHANDLER HEIGHTS

RIGGS ROAD TO CHANDLER HEIGHTS ROAD ROADWAY AND DRAINAGE IMPROVEMENTS

3133 West Frye Road Chandler, Arizona 85226

Stantec

PIPE PROFILES

DESIGNED BY MH
DRAWN BY BE
CIP PROJ NO. A1405

DRAWING NO. DR101

SHEET 51 OF 133

Tel. 480.687.6100

SEALED SUBMITTAL

& DRAINAGE IMPROVEMENTS

ROADWAY


CHANDLER HEIGHTS ROAD

ROAD:


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10/03/2025


STA 180+67

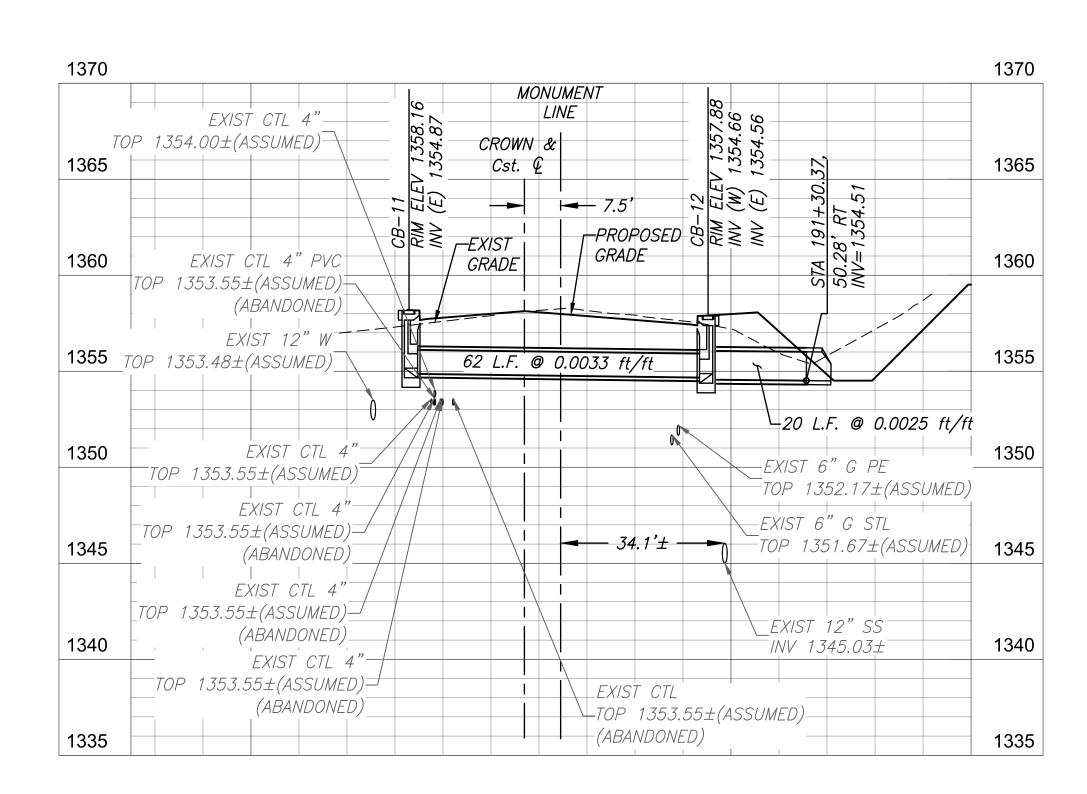


STA 191+30

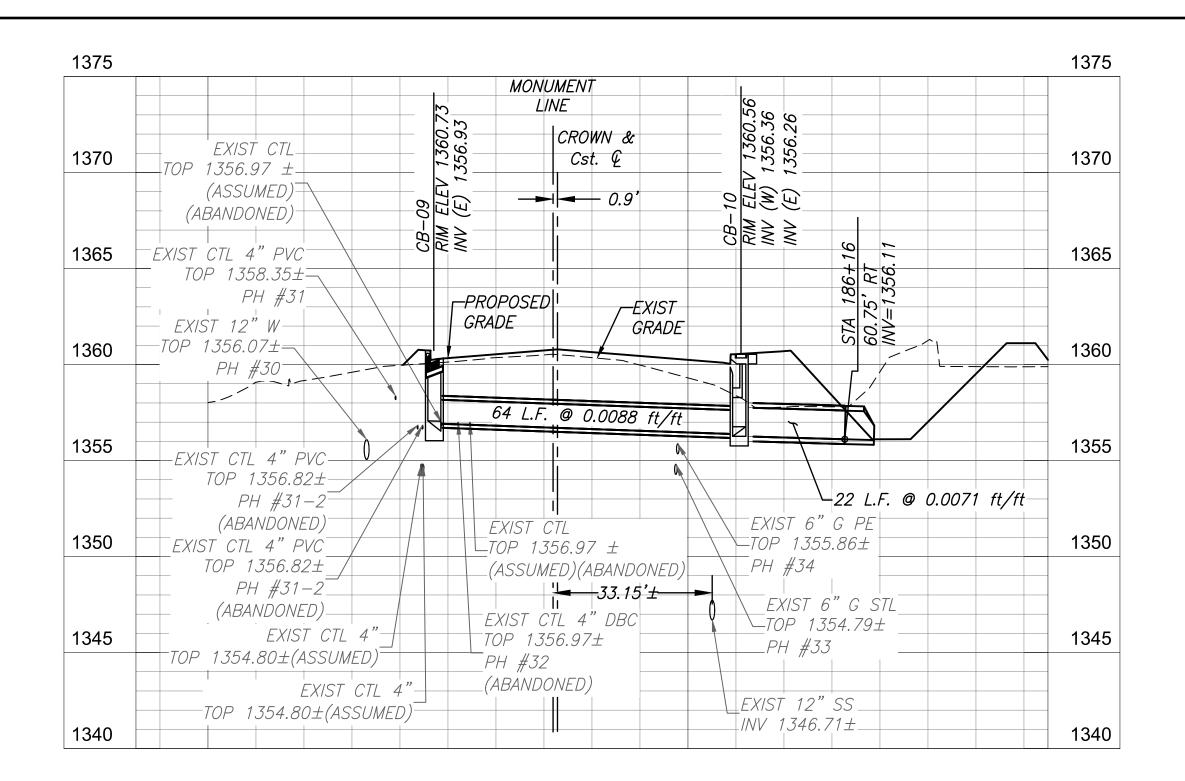

STA 186+15

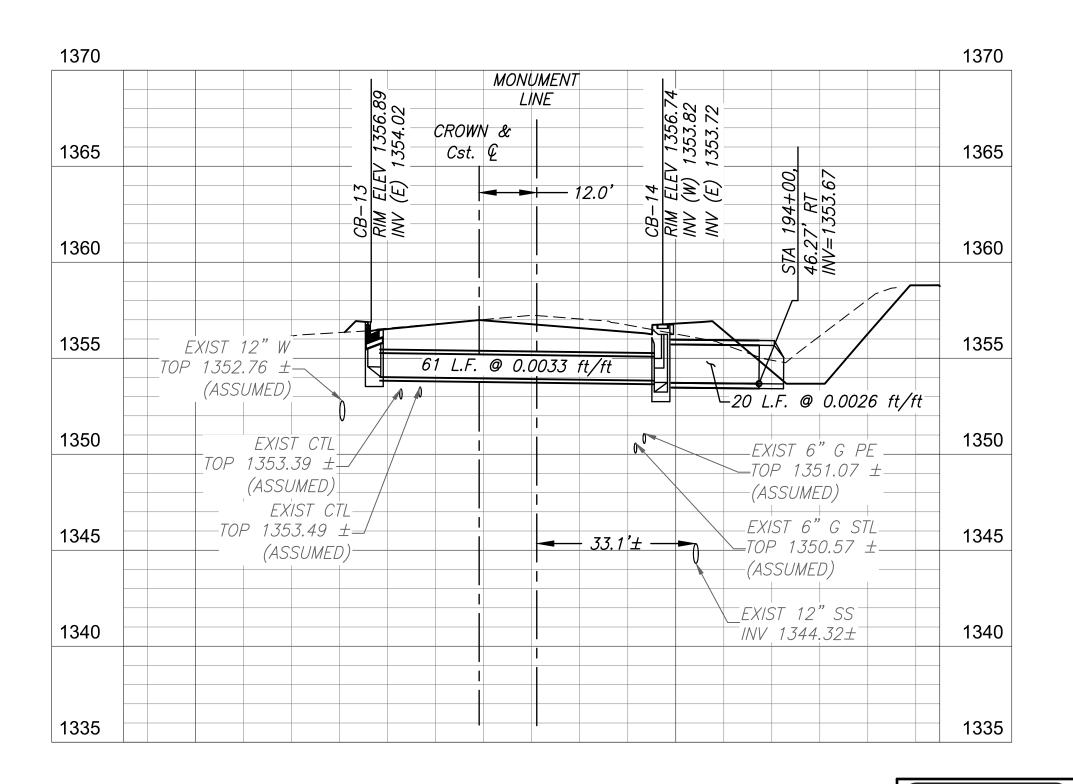

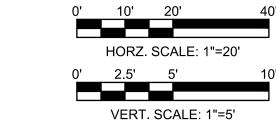

STA 194+00

NOTES:

CONTRACTOR SHALL PROVIDE ADEQUATE COVER DURING CONSTRUCTION OVER ALL PIPES TO AVOID DAMAGE. ANY DAMAGE THAT OCCURS TO THE PIPE DURING CONSTRUCTION SHALL BE REPLACED AT NO COST TO THE TOWN.


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orking days before you begin exc

Contact Arizona 811 at least two full

TOWN OF QUEEN CREEK



POWER ROAD: RIGGS ROAD TO CHANDLER HEIGHTS ROAD ROADWAY AND DRAINAGE IMPROVEMENTS

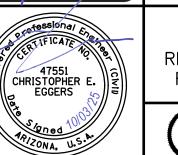Stantec

PIPE PROFILES DESIGNED BY MH


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DR102 DRAWING NO.


SHEET 52 OF 133

Chandler, Arizona 85226


Tel. 480.687.6100

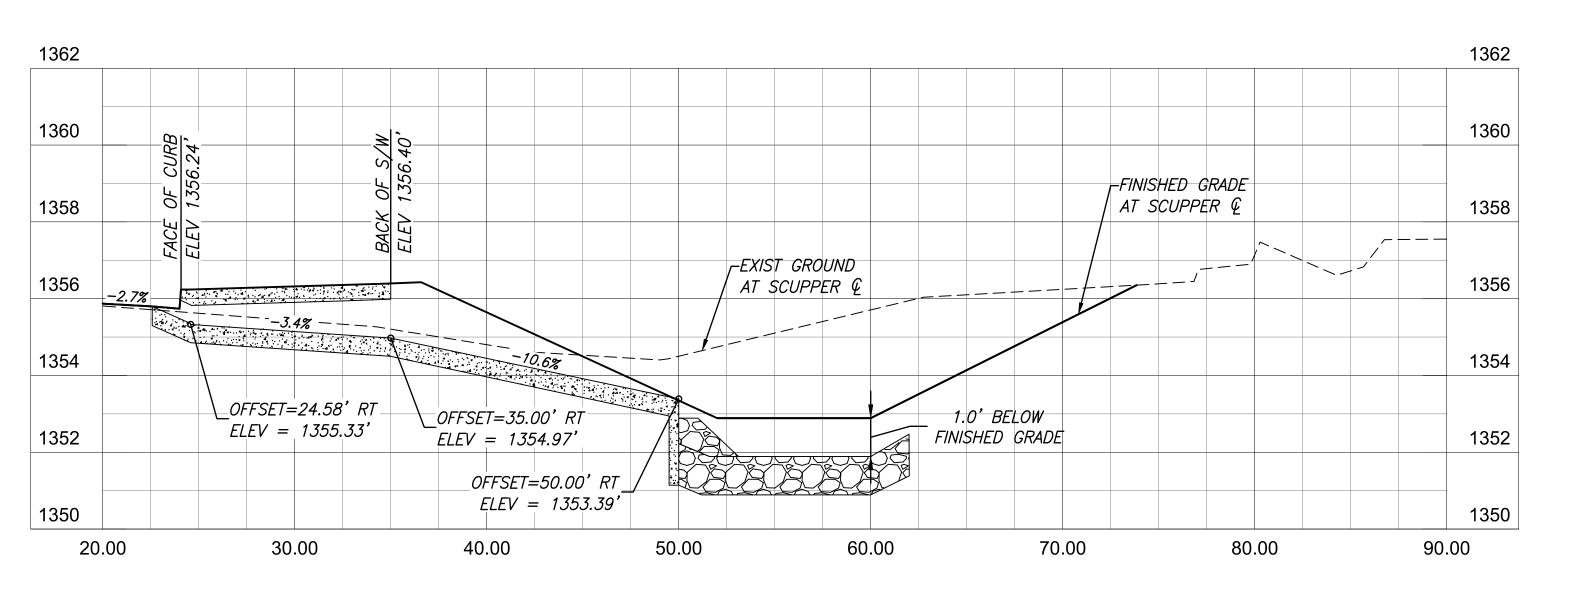


Sta 196+50.00 RT

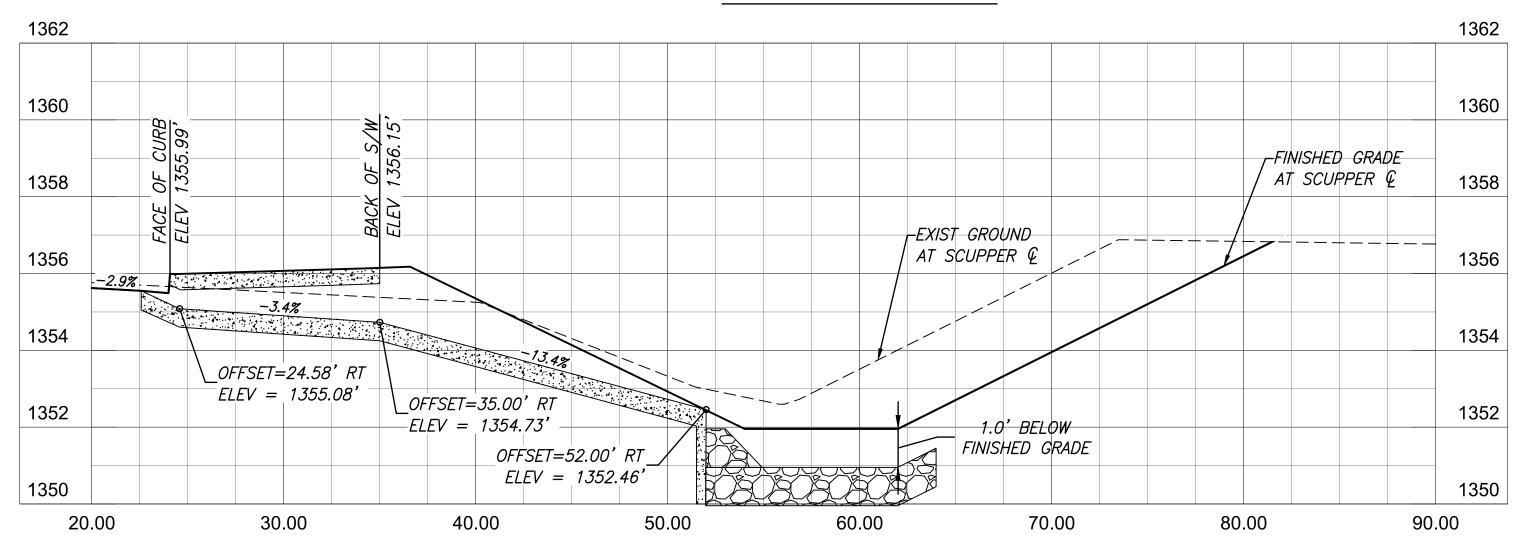

Sta 199+50.00 RT

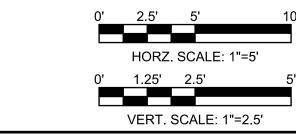

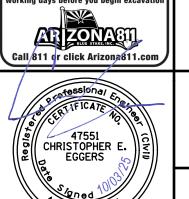





POWER ROAD:
RIGGS ROAD TO CHANDLER HEIGHTS ROAD
ROADWAY AND DRAINAGE IMPROVEMENTS

3133 West Frye Road

Stantec


Chandler, Arizona 85226
Tel. 480.687.6100
www.stantec.com

SCUPPER PROFILES

DESIGNED BY MH
DRAWN BY BE
CIP PROJ NO. A1405

DRAWING NO. DR201

SHEET 53 OF 133

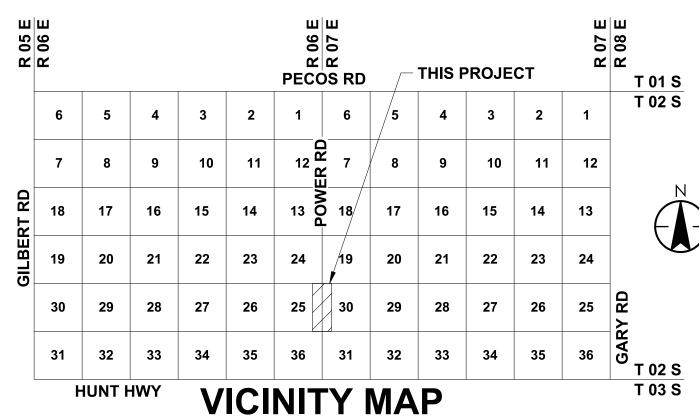

NOT TO SCALE


UTILITY COORDINATION AND CONTACT LIST

HEREIN IS IN AGREEMENT WITH PROVIDED UTILITY COMPANY RECORDS. IDENTIFIED CONFLICTING UTILITY FACILITIES HAVE BEEN MOVED AND NO LONGER CONFLICT UTILITY PRIOR TO CONSTRUCTION CONTINUING IN THE LOCATION

UTILITY	REPRESENTATIVE	PHONE	E-MAIL
S.R.P.	KAYE BOCKMANN	602-236-3129	KAYE.BOCKMANN@SRPNET.COM
SW GAS	GENE FLOREZ	480-730-3841	GENE.FLOREZ@SWGAS.COM
CENTURYLINK	KEVIN WAGNER	815-245-9640	KWAGNER@TERRATECHLLC.NET
COX COMM.	JEFF KRAUSE	520-955-0084	JEFF.KRAUSE@COX.COM
TOQC WATER	MIKE HUBER	480-358-3482	MIKE.HUBER@QUEENCREEKAZ.GOV
TOQC SEWER	MIKE HUBER	480-358-3482	MIKE.HUBER @QUEENCREEKAZ.GOV
TOQC TRAFFIC ITS	CLINTON MCCLEVE	480-358-3476	CLINTON.MCCLEVE@QUEENCREEKAZ.GOV
SAN TAN IRRIGATION	TODD ANGLE	480-988-3385	TODD@SANTANID.COM
RANCHOS JARDINES	JIM MILLSPAUGH	480-570-2643	JMRJID@GMAIL.COM
CITRUS IRRIGATION	GREGORY DUNNAN	480-254-0983	GDUNNAN@DKGCIVIL.COM

TOWN OF QUEEN CREEK C.I.P PROJECT NO. A1405 **WATER PLANS**

POWER ROAD: RIGGS ROAD TO CHANDLER HEIGHTS ROAD ROADWAY AND DRAINAGE IMPROVEMENTS

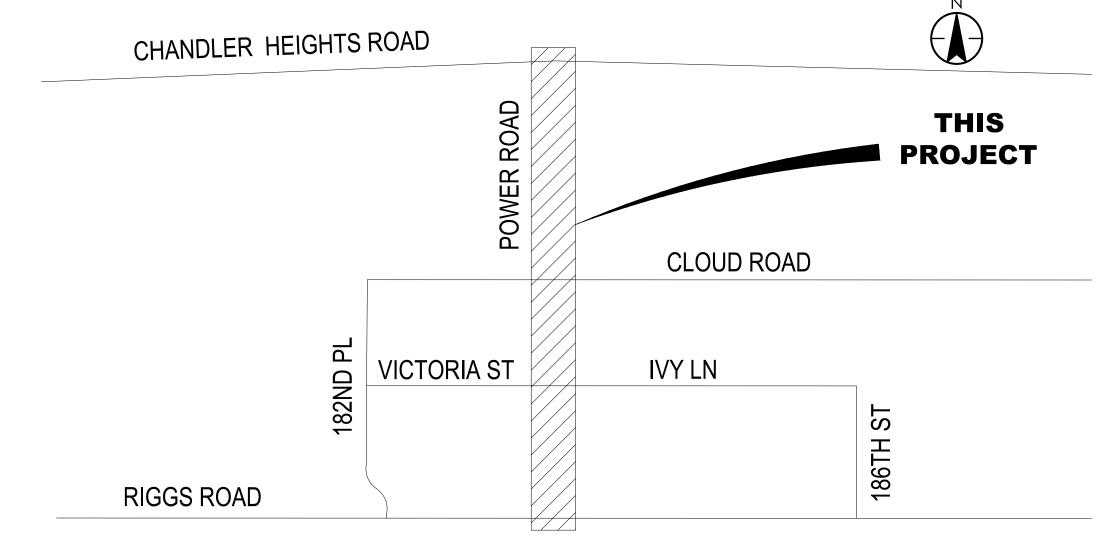

LOCATION MAP

SHEET INDEX

SHEET TITLE

WATER COVER SHEET AND SHEET INDEX WATER KEY MAP WATER PLAN AND PROFILE SHEETS

WATER DETAIL SHEET

SHEET NO. DRAWING NO. CS003 KM002 56-61 UW001 - UW006 62-63 UW101 - UW102



TOWN COUNCIL

JEFF BROWN

MAYOR - JULIA WHEATLEY VICE-MAYOR - LEAH MARTINEAU COUNCIL MEMBERS ROBIN BENNING DAWN OLIPHANT

TRAVIS PADILLA **BRYAN MCCLURE**

TOWN OF QUEEN CREEK

19715 S. 220TH ST QUEEN CREEK, AZ 85142 TELEPHONE (480) 358-3140 FAX (480) 358-3105 **CONTACT:** Bob Coulthard E-MAIL: bob.coulthard@queencreekaz.gov

ENGINEER

STANTEC CONSULTING INC. 3133 WEST FRYE ROAD SUITE 300 CHANDLER, AZ 85226 PHONE: (480) 687-6100 FAX: (480) 431-9562 **CONTACT: Chris Eggers**

EMAIL: chris.eggers@stantec.com

APPROVALS

THE AUTHORIZED REPRESENTATIVES OF THE FOLLOWING AGENCIES HEREBY ACKNOWLEDGE OR HAVE ACKNOWLEDGED THAT THEY HAVE REVIEWED AND APPROVED THE DESIGN SHOWN HEREIN. CONSTRUCTION MAY BEGIN AFTER ALL APPROPRIATE PERMITS HAVE BEEN OBTAINED

TOWN CIP GROUP DIRECTOR TOWN TRAFFIC ENGINEER

MARICOPA COUNTY DEPARTMENT OF ENVIRONMENTAL SERVICES DWR2500548

TOWN OF QUEEN CREEK UTILITY ENGINEER

UNDERGROUND UTILITIES

- THE EXISTENCE AND LOCATION OF ANY UNDERGROUND UTILITY OR STRUCTURE DEPICTED HEREIN IS BASED UPON THE BEST AVAILABLE INFORMATION FURNISHED BY THE UTILITY OR STRUCTURE OWNER AT THE TIME OF THE SURVEY.
- TO THE BEST OF OUR KNOWLEDGE, THERE ARE NO OTHER EXISTING UTILITIES WITHIN THE PROJECT LIMITS EXCEPT AS SHOWN ON THESE DRAWINGS. THE ENGINEER AND TOWN ASSUME NO RESPONSIBILITY FOR THE ACCURACY OF THE
- UTILITY LOCATIONS DEPICTED IN THESE DRAWINGS. THE CONTRACTOR SHALL CALL BLUE STAKE AT (602) 263-1100 OR 811 AT LEAST 48 HOURS PRIOR TO ANY CONSTRUCTION ACTIVITY. IT IS THE CONTRACTOR'S RESPONSIBILITY TO CONTACT ALL INVOLVED UTILITIES AND FIELD VERIFY THE
- LOCATION(S) OF ALL UTILITIES. IF DISCREPANCIES IN UTILITY LOCATIONS ARE FOUND, THE CONTRACTOR SHALL NOTIFY THE TOWN'S PROJECT REPRESENTATIVE IMMEDIATELY.
- ALL MATERIAL THAT COMES INTO CONTACT WITH WATER SHALL CONFORM TO ANSI/NSF STANDARD 61.

LOCATION FOR AS-BUILT INDEXING

TOWNSHIP	RANGE	SECTION	QUARTER
2S	6E	25	NE
2S	6E	25	SE
2S	6E	30	NW
28	6E	30	SW

DESIGN DATA

POWER ROAD	
CLASSIFICATION	URBAN MINOR ARTERIAL
DESIGN SPEED	55 MPH
AVERAGE DAILY TRAFFIC(ADT)	UNKNOWN
CLEAR ZONE DISTANCE	MINIMUM SIX-FEET (6')

AS-BUILT CERTIFICATION

I HEREBY CERTIFY THAT THE "RECORD-DRAWING" MEASUREMENTS AS SHOWN HEREON WERE MADE UNDER MY SUPERVISION, OR AS NOTED, AND ARE CORRECT TO THE BEST OF MY KNOWLEDGE AND BELIEF.

REGISTERED ENGINEER/ LAND SURVEYOR SEAL &





QUEEN CREEK



POWER ROAD: RIGGS ROAD TO CHANDLER HEIGHTS ROAD ROADWAY AND DRAINAGE IMPROVEMENTS

Stantec

WATER COVER SHEET AND SHEET INDEX

DESIGNED BY MH CIP PROJ NO. A1405 DRAWN BY

> CS003 DRAWING NO.

SHEET 54 OF 133

ROADWAY RIGGS ROAD TO CHANDLER HEIGHTS

CONSTRUCTION ACTIVITIES.

- AND CONSTRUCTION STANDARDS MANUAL. ALL WORK AND MATERIALS NOT IN CONFORMANCE WITH STANDARDS AND DETAILS ARE SUBJECT TO REMOVAL AND REPLACEMENT AT THE CONTRACTOR'S EXPENSE. THE TOWN OF QUEEN CREEK WATER DEPARTMENT REPRESENTATIVE SHALL HAVE FINAL AUTHORITY ON ALL IMPROVEMENTS REGARDLESS OF THE PLANS AND/OR SPECIFICATIONS
- THIS SET OF PLANS HAS BEEN REVIEWED FOR COMPLIANCE WITH DEPARTMENT REQUIREMENTS PRIOR TO ISSUANCE OF CONSTRUCTION PERMITS. HOWEVER, SUCH REVIEW SHALL NOT PREVENT THE DEPARTMENT FROM REQUIRING CORRECTION OF ERRORS IN PLANS FOUND TO BE IN VIOLATION OF ANY LAW OR ORDINANCE.
- THE CONTRACTOR SHALL OBTAIN ALL NECESSARY PERMITS PRIOR TO BEGINNING CONSTRUCTION.
- THE CONTRACTOR IS RESPONSIBLE FOR VERIFICATION OF EXISTING PERMITS AND RENEWAL OF LAPSED PERMITS

THE WATER DEPARTMENT APPROVAL IS VALID FOR A PERIOD OF ONE YEAR. CONSTRUCTION PERMITS SHALL BE

- OBTAINED DURING THIS PERIOD OR THE PLANS SHALL BE RESUBMITTED FOR REVIEW AND APPROVAL.
- AN APPROVED SET OF PLANS SHALL BE AVAILABLE ON THE JOB SITE AT ALL TIMES.
- DEVELOPER IS RESPONSIBLE FOR OBTAINING ALL PERMANENT AND TEMPORARY EASEMENTS PRIOR TO BEGINNING CONSTRUCTION.
- PRIVATE ON-SITE WATER LINES SHALL BE CONSTRUCTED IN ACCORDANCE WITH THE LATEST REVISION OF THE UNIFORM PLUMBING CODE AND THE LATEST REVISION OF THE UNIFORM FIRE CODE.

ENGINEER CERTIFIES THAT HE HAS CONTACTED ALL INTERESTED UTILITY COMPANIES AND HAS TRANSFERRED ALL

- EXISTING AND/OR PROPOSED UTILITY LINES AND RELATED INFORMATION ONTO THESE PLANS.
- THE ENGINEER SHALL CERTIFY THAT ALL WATER IMPROVEMENTS HAVE BEEN INSTALLED AT THE LOCATIONS AND ELEVATIONS SHOWN ON THE APPROVED PLANS.
- THE ENGINEER SHALL CERTIFY THAT THE MINIMUM HORIZONTAL AND VERTICAL SEPARATION BETWEEN UTILITIES HAS BEEN MAINTAINED AS REQUIRED BY LAW OR POLICY.
- THE CONTRACTOR SHALL ARRANGE TO PROVIDE ALL CONSTRUCTION STAKING REQUIRED FOR THE PROJECT.
- 13. THE CONTRACTOR IS RESPONSIBLE FOR COORDINATING THE RELOCATION OF ALL UTILITIES, POWER POLES, IRRIGATION
- DRY-UPS, REMOVALS BY OTHERS, ETC. ALL FRAMES, COVERS, VALVE BOXES, MANHOLES, ETC. SHALL BE INSTALLED TO FINISH GRADE OR SHALL BE ADJUSTED

TO FINISH GRADE PRIOR TO PLACING OF ASPHALT SURFACE COURSE BY THE CONTRACTOR AS PER MAG STANDARD

- DETAIL 270 AND 422. 15. IT IS THE CONTRACTOR'S RESPONSIBILITY TO LOCATE ALL UTILITIES PRIOR TO EXCAVATION AND AVOID DAMAGE TO SAME. CALL (602) 283-1100 FOR BLUE STAKE TWO WORKING DAYS PRIOR TO DIGGING.
- CONTRACTOR WILL EXPOSE ALL TIE-IN POINTS TO VERIFY LOCATION PRIOR TO BEGINNING SUBSTANTIAL
- THE TOWN OF QUEEN CREEK WATER DEPARTMENT IS NOT LIABLE FOR DELAYS NOR DAMAGES TO UTILITIES RELATED TO THIS CONSTRUCTION; NEITHER WILL THE WATER DEPARTMENT PARTICIPATE IN THE COST OF UTILITY RECONSTRUCTION OR RELOCATION.
- 18. THE CONTRACTOR IS RESPONSIBLE FOR MAKING ARRANGEMENTS FOR INSPECTION AND TESTING. INSPECTIONS SHOULD BE COORDINATED WITH BILL LAWRENCE (480) 748-3952. INSPECTIONS ARE ON A DAY-TO-DAY, FIRST COME, FIRST SERVED BASIS. CONSTRUCTION CONCEALED WITHOUT THE REQUIRED INSPECTION SHALL BE SUBJECT TO EXPOSURE AT THE CONTRACTOR'S EXPENSE.
- 19. THE CONTRACTOR WILL FOLLOW GUIDELINES AND REGULATIONS SET FORTH BY OSHA. NEITHER THE ENGINEER NOR THE TOWN WILL BE RESPONSIBLE FOR JOB-SITE SAFETY PROCEDURES OR CONDITIONS
- THE CONTRACTOR IS RESPONSIBLE FOR HIS OWN TAKEOFF QUANTITIES. QUANTITIES SHOWN HEREON ARE ESTIMATES ONLY AND AS SUCH ARE NOT TO BE USED FOR BID PURPOSES.
- THE CONTRACTOR IS RESPONSIBLE FOR THE NOTIFICATION OF THE PROPER AUTHORITY(S) IF THERE ARE OBSTRUCTIONS TO PROPOSED IMPROVEMENTS AS SHOWN ON THE CONSTRUCTION DRAWINGS. ANY EXISTING ITEM REMOVED TO FACILITATE CONSTRUCTION SHALL BE REPLACED IN THE SAME OR BETTER CONDITION AT THE CONTRACTOR'S EXPENSE.
- 22. THE CONTRACTOR IS RESPONSIBLE FOR TRAFFIC CONTROL ON AND AROUND THE CONSTRUCTION SITE.
- ALL WATER LINES SHALL HAVE 48" MINIMUM COVER AS SPECIFIED IN THE TOWN OF QUEEN CREEK WATER DEPARTMENT DESIGN STANDARDS AND CONSTRUCTION MANUAL.
- CONTRACTOR MUST MAINTAIN SLOPE OF WATER LINES TO HIGH POINTS AT COMBINATION AIR VALVES OR LOW POINTS AT BLOW OFFS OR FIRE HYDRANTS.

- DUCTILE IRON PIPE, WHEN REQUIRED, SHALL BE THICKNESS CLASS 350.
- SERVICE CONNECTION BACK-FLOW PREVENTORS SHALL BE FURNISHED AND INSTALLED BY THE CONTRACTOR AS NOTED
- 28. FIRE HYDRANTS SHALL RECEIVE 2 FIELD COATS OF CHROME YELLOW PAINT PRIOR TO ACCEPTANCE OF WORK BY THE
- DEVELOPER IS TO INSTALL ALL TAPS AND METER BOXES. REFER TO THE WATER DEPARTMENT DESIGN AND
- CONSTRUCTION STANDARDS MANUAL FOR CLARIFICATION ON METER BOX LOCATION AND REQUIRED MATERIALS.
- 30. METERS SHALL BE FURNISHED AND INSTALLED BY THE WATER DEPARTMENT
- PAVEMENT REPLACEMENT AND TRENCH REPAIR SHALL BE DONE TO MAG STANDARD SPECIFICATIONS AND DETAILS
- ALL WATER SERVICE CONNECTIONS SHALL BE EXTENDED TO THE PROPOSED METER LOCATIONS AS INDICATED ON THE PLANS SUCH THAT ADDITIONAL EXTENSION WILL NOT BE REQUIRED.
- 33. IMPROVEMENTS SHALL NOT BE ACCEPTED UNTIL "AS-BUILT" PLANS HAVE BEEN SUBMITTED, REVIEWED AND APPROVED BY THE WATER DEPARTMENT.

MCDOT GENERAL NOTES

- 1. ALL WORK SHALL CONFORM TO THE REVISED EDITION OF THE UNIFORM STANDARD SPECIFICATIONS AND DETAILS FOR PUBLIC WORKS CONSTRUCTION PUBLISHED BY THE MARICOPA ASSOCIATION OF GOVERNMENTS (MAG) AS AUTHORIZED AND MODIFIED BY THE MOST CURRENT MCDOT SUPPLEMENT TO THE MAG UNIFORM STANDARD SPECIFICATIONS AND DETAILS AND NON-CONFLICTING PROJECT SPECIAL PROVISIONS. ALL WORK MUST ALSO COMPLY WITH RESOLUTION 2001-01 MARICOPA COUNTY RESOLUTION FOR PERMITS TO WORK IN DEDICATED RIGHT-OF-WAY AND RESOLUTION 2001-02 MARICOPA COUNTY RESOLUTION FOR STREET IMPROVEMENTS, INSTALLATION OF UTILITIES AND TRAFFIC CONTROL. ANY EXCEPTIONS MUST RECEIVE EXPLICIT APPROVAL FROM MCDOT AND SHALL BE IDENTIFIED ON THE PLANS AS HAVING EXPLICIT APPROVAL FROM MCDOT. ALL CLEAR ZONE HAZARDS SHALL BE MITIGATED IN A MANOR APPROVED BY MCDOT AT NO COST TO THE COUNTY.
- THE ENGINEERING DESIGNS ON THESE PLANS ARE ONLY APPROVED BY MCDOT IN CONCEPT AND NOT IN DETAIL. CONSTRUCTION QUANTITIES ON THESE PLANS ARE NOT VERIFIED BY MCDOT. APPROVAL OF THESE PLANS ARE FOR PERMIT PURPOSES ONLY AND SHALL NOT PREVENT MCDOT FROM REQUIRING CORRECTION OF ERRORS IN THE PLANS WHERE SUCH ERRORS ARE SUBSEQUENTLY FOUND TO BE IN VIOLATION OF ANY LAW, ORDINANCE, HEALTH, SAFETY, THE MCDOT ROADWAY DESIGN MANUAL, OR OTHER DESIGN ISSUES.
- 3. AN APPROVED SET OF PLANS SHALL BE ON THE SITE DURING CONSTRUCTION AND AVAILABLE TO MCDOT AND OTHER INSPECTORS.
- 4. ALL BOX CULVERTS CONSTRUCTED IN THE PUBLIC RIGHT-OF-WAY SHALL COMPLY WITH ARIZONA DEPARTMENT OF TRANSPORTATION (ADOT) LATEST DESIGN SPECIFICATIONS AND STANDARDS. MINIMUM CLEAR HEIGHT OF BOX CULVERT SHALL BE 4 FEET.
- 5. CONTRACTOR TO OBTAIN MCDOT PERMITS PRIOR TO CONSTRUCTION WITHIN COUNTY RIGHT-OF-WAY, AND ALL NECESSARY PERMITS FROM OTHER AGENCIES AND FROM LOCAL GOVERNMENTS FOR WORK WITHIN THEIR
- CONTRACTOR SHALL NOTIFY THE MCDOT INSPECTION DEPT. AT LEAST 24 HOURS IN ADVANCE OF ANY CONSTRUCTION AT (602) 506-8606.
- CONTRACTOR PERFORMING CONSTRUCTION OR EXCAVATING OPERATIONS IS RESPONSIBLE FOR LOCATING AND RELOCATING ALL UTILITIES IN CONFLICT AT NO EXPENSE TO MARICOPA COUNTY. THE CONTRACTOR SHALL CONTACT "BLUE STAKE" AT (602) 263-1100 PRIOR TO BEGINNING CONSTRUCTION.
- THE CONTRACTOR IS RESPONSIBLE FOR OBTAINING ANY REQUIRED PERMITS FOR EARTH MOVING FROM MARICOPA COUNTY AIR QUALITY DEPARTMENT'S DUST COMPLIANCE DIVISION (602) 506-6010 PRIOR TO CONDUCTING

- PRIOR TO CONDUCTING EXCAVATION OPERATIONS, THE CONTRACTOR SHALL OBTAIN FROM THE ARIZONA STATE HISTORICAL PRESERVATION OFFICER (602) 542-4009, RECOMMENDATIONS REGARDING THE NEED FOR CULTURAL RESOURCES (ARCHAEOLOGICAL) CLEARANCE. ALL DISCOVERIES OF HUMAN REMAINS, CULTURAL ARTIFACTS, OR PALEONTOLOGICAL REMAINS SHALL BE REPORTED TO THE ARIZONA STATE MUSEUM AND MCDOT. UPON DISCOVERY, CONTRACTOR SHALL CEASE OPERATIONS IN THE VICINITY OF THE FIND AND PROTECT THE DISCOVERY AREA FROM AND MCDOT.
- EXCEPT UNDER EMERGENCY CONDITIONS, ROADS SHALL NOT BE CLOSED FOR CONSTRUCTION ACTIVITY UNLESS PRIOR
- 11. PRIOR TO MOVING OR DESTROYING PROTECTED NATIVE PLANT SPECIES, THE CONTRACTOR SHALL FILE A FORMAL NOTICE OF INTENT WITH THE ARIZONA DEPARTMENT OF AGRICULTURE NATIVE PLANTS (602) 542-6408.
- 12. PRIOR TO INSTALLATION OF CURB, GUTTER, SIDEWALK, BASE COURSE AND WEARING SURFACE, SUBMIT SOIL TEST(S) OF SUBGRADE AND REVISED PAVEMENT DESIGN/CALCULATIONS TO MCDOT FOR REVIEW AND APPROVAL. IF SUBGRADE STABILIZATION IS REQUIRED. THE AREA STABILIZED SHALL BE FROM BACK OF SIDEWALK TO BACK OF SIDEWALK AND MATCH THE STABILIZATION DEPTH OF THE PAVEMENT STRUCTURE.
- 13. ASPHALT MIX DESIGN SHALL BE SUBMITTED TO MCDOT A MINIMUM OF 48 HOURS PRIOR TO PLACING ANY ASPHALT COURSES. (TRENCH WORK EXCLUDED.) ALL PAVED TURNOUTS SHALL HAVE THE SAME ASPHALT AND BASE REQUIREMENTS AS THE ADJACENT ROADWAY UNLESS NOTED OTHERWISE.
- 14. ALL COMPACTION AND BACKFILL WITHIN COUNTY RIGHT-OF-WAY SHALL CONFORM TO THE MCDOT SUPPLEMENT TO MAG SPECIFICATION SECTION 601. BACKFILL UNDER EXISTING PAVEMENT, CURB AND GUTTER, ROADWAY SHOULDERS, AND UNPAVED ROADWAYS SHALL CONSIST OF ONE-HALF (1/2) OR ONE SACK CLSM. UNPAVED ROADWAY AREAS INCLUDE THE TRAVELLED WAY PLUS FIVE FEET BEYOND THE TRAVELLED WAY.
- 15. ALL STRUCTURES, SUCH AS MANHOLES, VALVE BOX & COVERS, AND MONITORING WELLS MUST BE MARKED WITH AT LEAST TWO REFLECTIVE YELLOW FLEX POSTS WHEN STRUCTURES ARE LOCATED OUTSIDE THE TRAVELED WAY AND WITHIN THE RIGHT-OF-WAY. (APPLIES ONLY WHEN THERE IS NO CURB.)
- 16. PAVEMENT WIDENING AND PAVEMENT REPLACEMENT SHALL CONFORM TO REQUIREMENTS OF SPECIFICATION SECTION 336. PAVEMENT CUTS SHALL NOT BE LOCATED WITHIN A LANE WHEEL PATH. THE LANE WHEEL PATH IS THE ENTIRE LANE WIDTH EXCEPT THE AREA WITHIN ONE FOOT OF A LANE LINE STRIPE AND EXCEPT THE CENTER TWO FEET OF THE TRAVEL LANE.
- 17. ALL EXISTING PAVEMENT MARKINGS, TRAFFIC SIGNS AND SIGNAL EQUIPMENT THAT NEED TO BE REMOVED, REPLACED, RELOCATED OR REPAIRED BECAUSE OF CONTRACTOR'S WORK WILL BE DONE BY THE CONTRACTOR AT HIS EXPENSE. ALL SALVAGED SIGNS SHALL BE DELIVERED TO THE TRAFFIC OPS BUILDING AT 2909 W. DURANGO ST. ARRANGEMENTS CAN BE MADE FOR DELIVERY BY CALLING (602) 506-8662. ALL NEW STREET NAME SIGNS SHALL BE PROVIDED AND INSTALLED BY PERMITTEE AT NO EXPENSE TO MARICOPA COUNTY.
- 18. PAVEMENT MARKING, SIGNING AND SIGNAL WORK WILL BE INSPECTED AND SHALL MEET COUNTY STANDARDS BEFORE RELEASE OF BOND.
- 19. THE CONTRACTOR SHALL RESTORE ALL DISTURBED AREAS WITHIN THE RIGHT-OF-WAY TO A CONDITION EQUAL TO OR BETTER THAN PRIOR EXISTING CONDITIONS PER MAG 107.9. DISPOSAL OF ALL WASTE MATERIAL WILL BE THE RESPONSIBILITY OF THE CONTRACTOR.
- 20. ALL PIPES, FITTINGS, VALVES, FIRE HYDRANTS AND OTHER APPURTENANCES SHALL CONFORM TO CURRENT AWWA, ASTM, AND NSF STANDARDS. (EB 10, CHAP. 7, SECTION B)
- 21. ALL NEW ELEMENTS OF A DISTRIBUTION SYSTEM SHALL BE DISINFECTED IN ACCORDANCE WITH ADEQ ENGINEERING BULLETIN 8 OR AWWA C651. (MAG 611.3)

- 22. PRESSURE TESTING OF WATER LINES SHALL BE IN ACCORDANCE WITH AWWA C600
- 23. ALL MATERIALS INSTALLED AFTER JANUARY 1ST, 1993, WHICH MAY COME INTO CONTACT WITH DRINKING WATER, SHALL CONFIRM TO ANSI/NSF STANDARDS 60 AND 61. (R18-4-213.A AND B).





TOWN OF QUEEN CREEK

Chandler, Arizona 85226

Tel. 480.687.6100




POWER ROAD: RIGGS ROAD TO CHANDLER HEIGHTS ROAD ROADWAY AND DRAINAGE IMPROVEMENTS

WATER PLAN KEY MAP

CIP PROJ NO. A1405

KM02 DRAWING NO. SHEET 55 OF 133 **⊈**

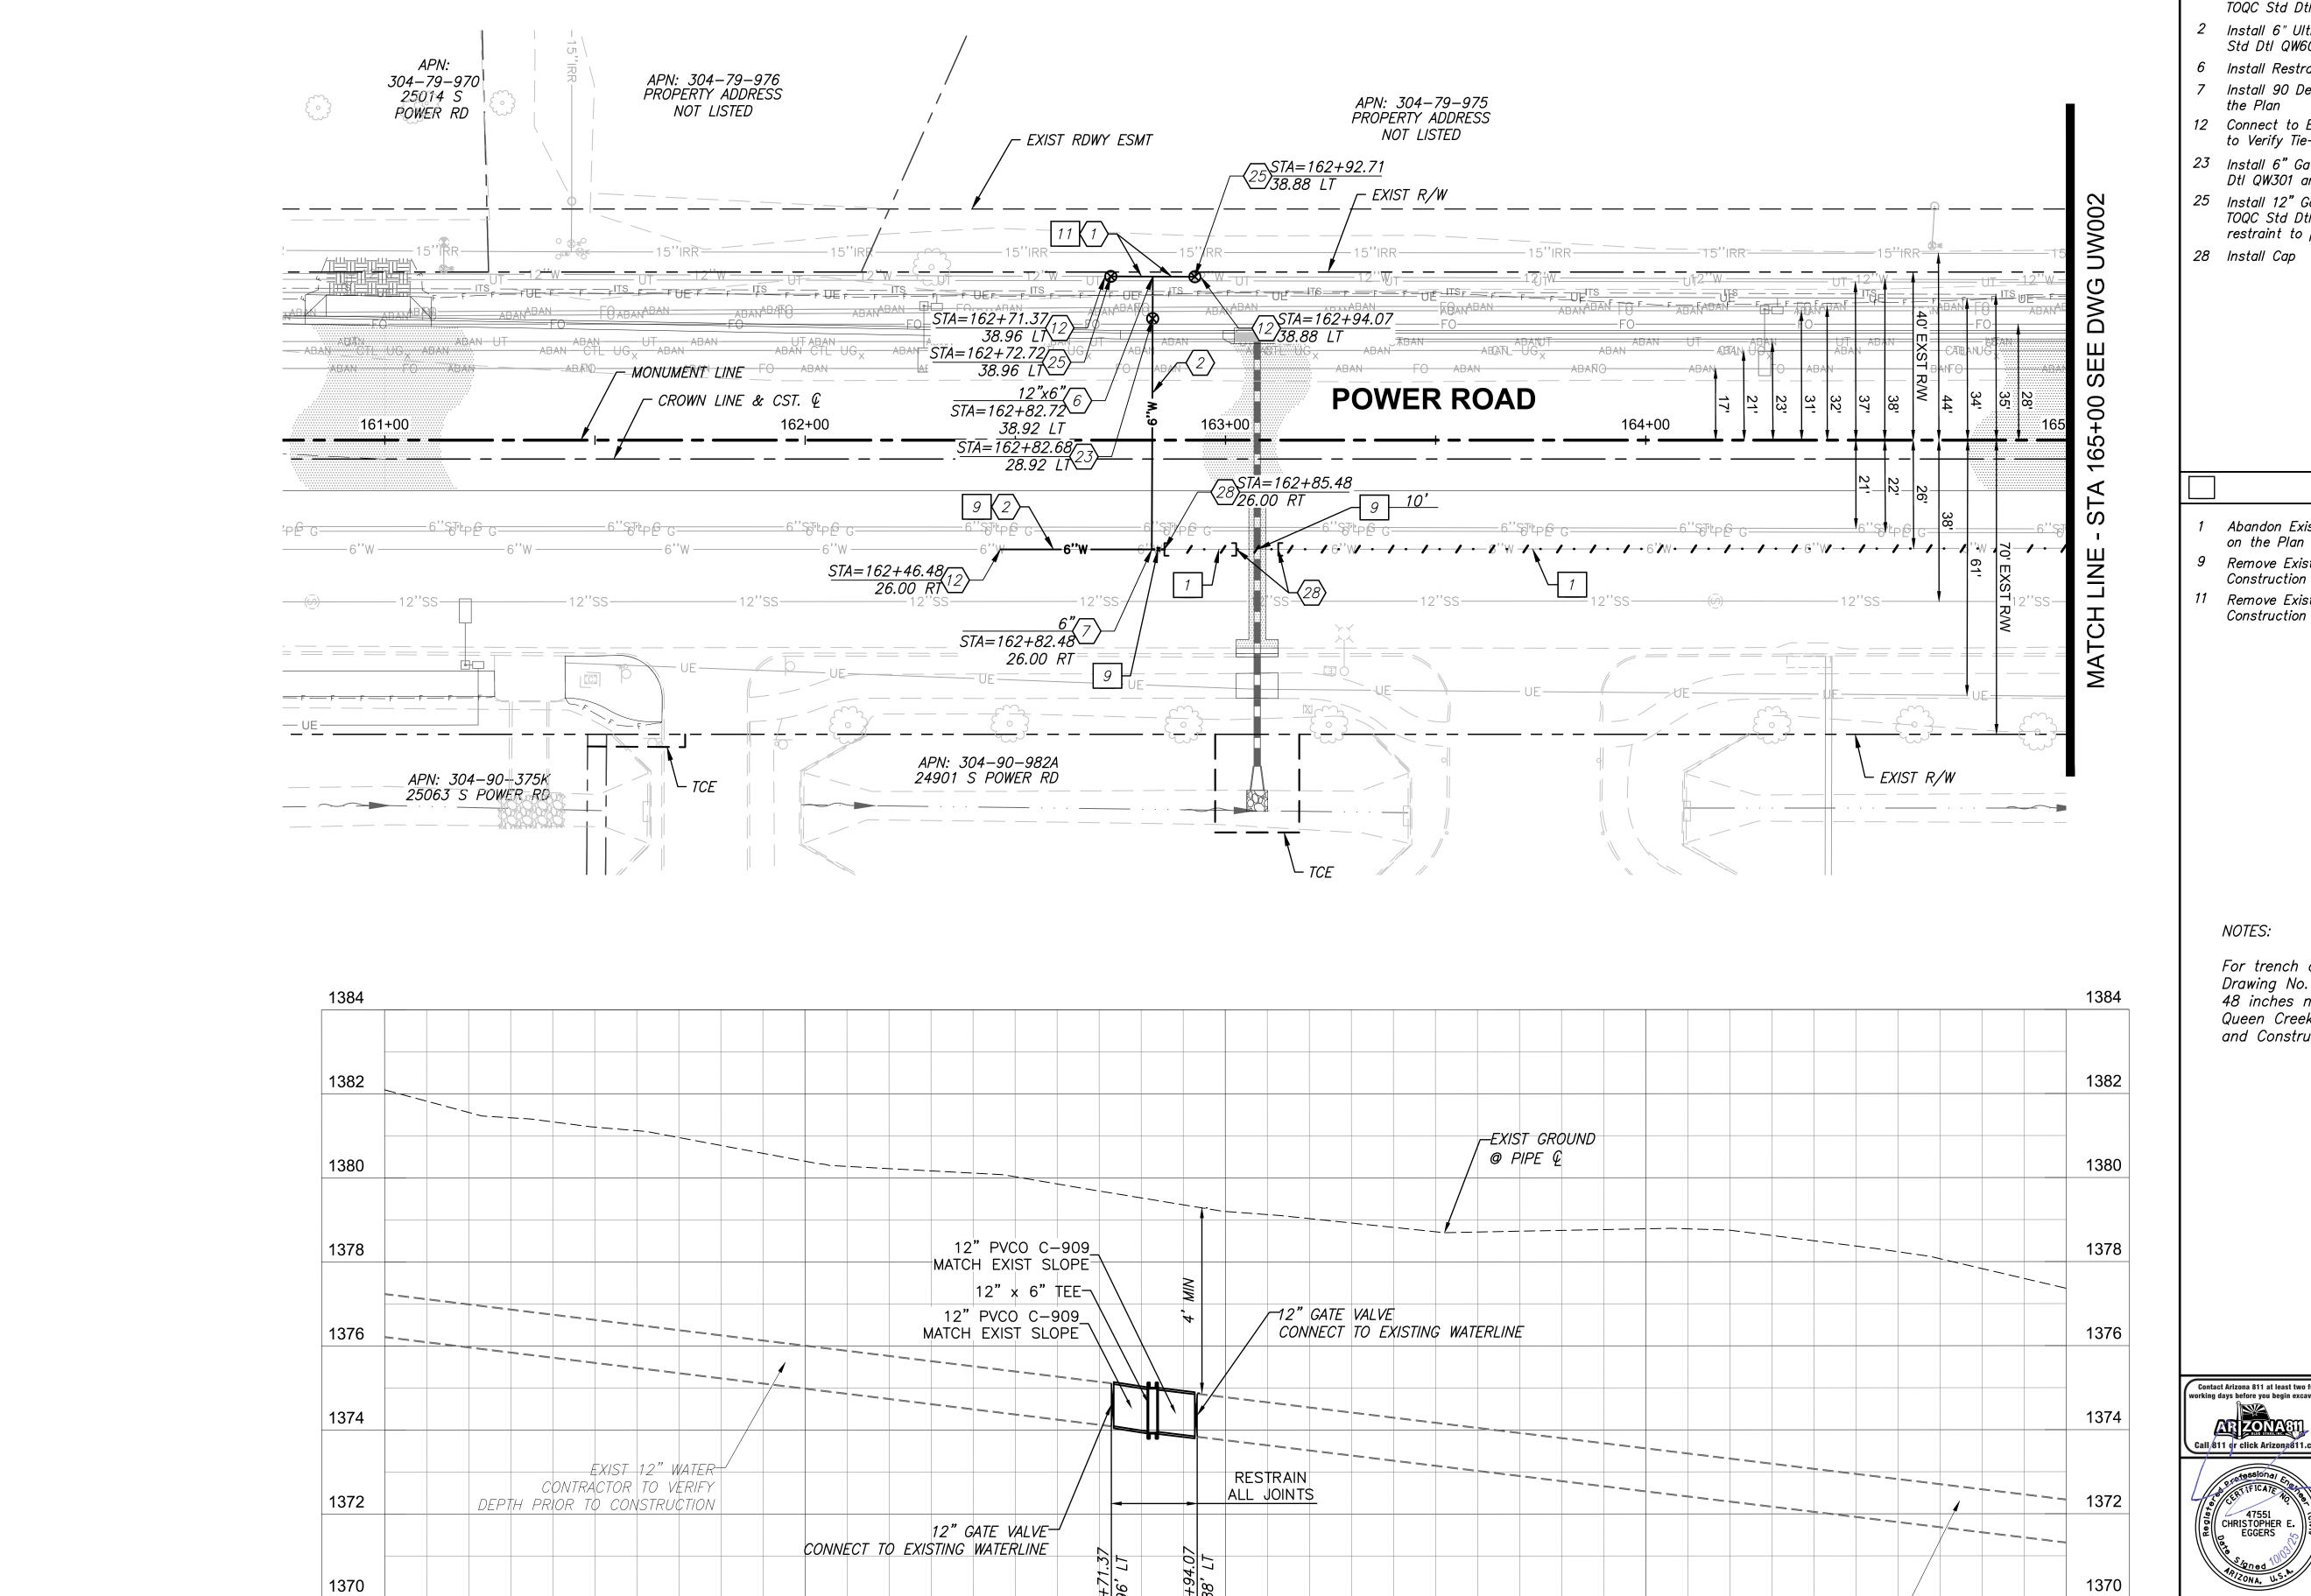

163+00

1368


161+00

162+00

		WATER CONSTRUCTION NOTES		QUANTITY	
	1	Install 12" Ultra Blue PVCO (C-909) Waterline per TOQC Std Dtl QW606, Restrain All Joints	20	LF	
	2	Install 6" Ultra Blue PVCO (C-909) Waterline per TOQC Std Dtl QW606, Restrain All Joints	101	LF	
	6	Install Restrained Tee, Size as Noted on the Plan	_	NPI	
	7	Install 90 Degree Restrained Bend, Size as Noted on the Plan	_	NPI	
	12	Connect to Existing Waterline where Shown. Contractor to Verify Tie—in Points Prior to Beginning Construction	_	NPI	
	23	Install 6" Gate Valve, Box and Cover per TOQC Std Dtl QW301 and 302	1	EA	
	25	Install 12" Gate Valve (MJXFL), Box and Cover per TOQC Std Dtl QW301 and 302. Valve to be fully restraint to pipe connections.	2	EA	
	28	Install Cap	-	NPI	

				SUBMITTA
	REMOVAL NOTES	QUAI	YTITY	
1	Abandon Existing Waterline In Place to Limits Shown on the Plan	_	NPI	SEALE
9	Remove Existing 6" Waterline to Limits of New Line Construction	49	LF	TS SE
11	Remove Existing 12" Waterline to Limits of New Line	20	LF	

For trench detail see TOQC Std Dtl QW606 on Drawing No. UW102. All water lines shall have 48 inches minimum cover per the Town of Queen Creek Water Department Design Standards and Construction Manual.

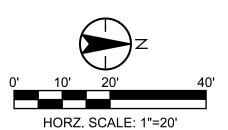


CHANDLER HEIGHTS ROAD





TOWN OF QUEEN CREEK

Chandler, Arizona 85226 Tel. 480.687.6100

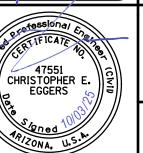

1368

165+00

EXIST 12" WATER-

CONTRACTOR TO VERIFY

DEPTH PRIOR TO CONSTRUCTION

164+00


POWER ROAD: RIGGS ROAD TO CHANDLER HEIGHTS ROAD ROADWAY AND DRAINAGE IMPROVEMENTS


Stantec


WATER PLAN

DESIGNED BY MH CIP PROJ NO. A1405 DRAWN BY

SHEET 56 OF 133 UW001 DRAWING NO.

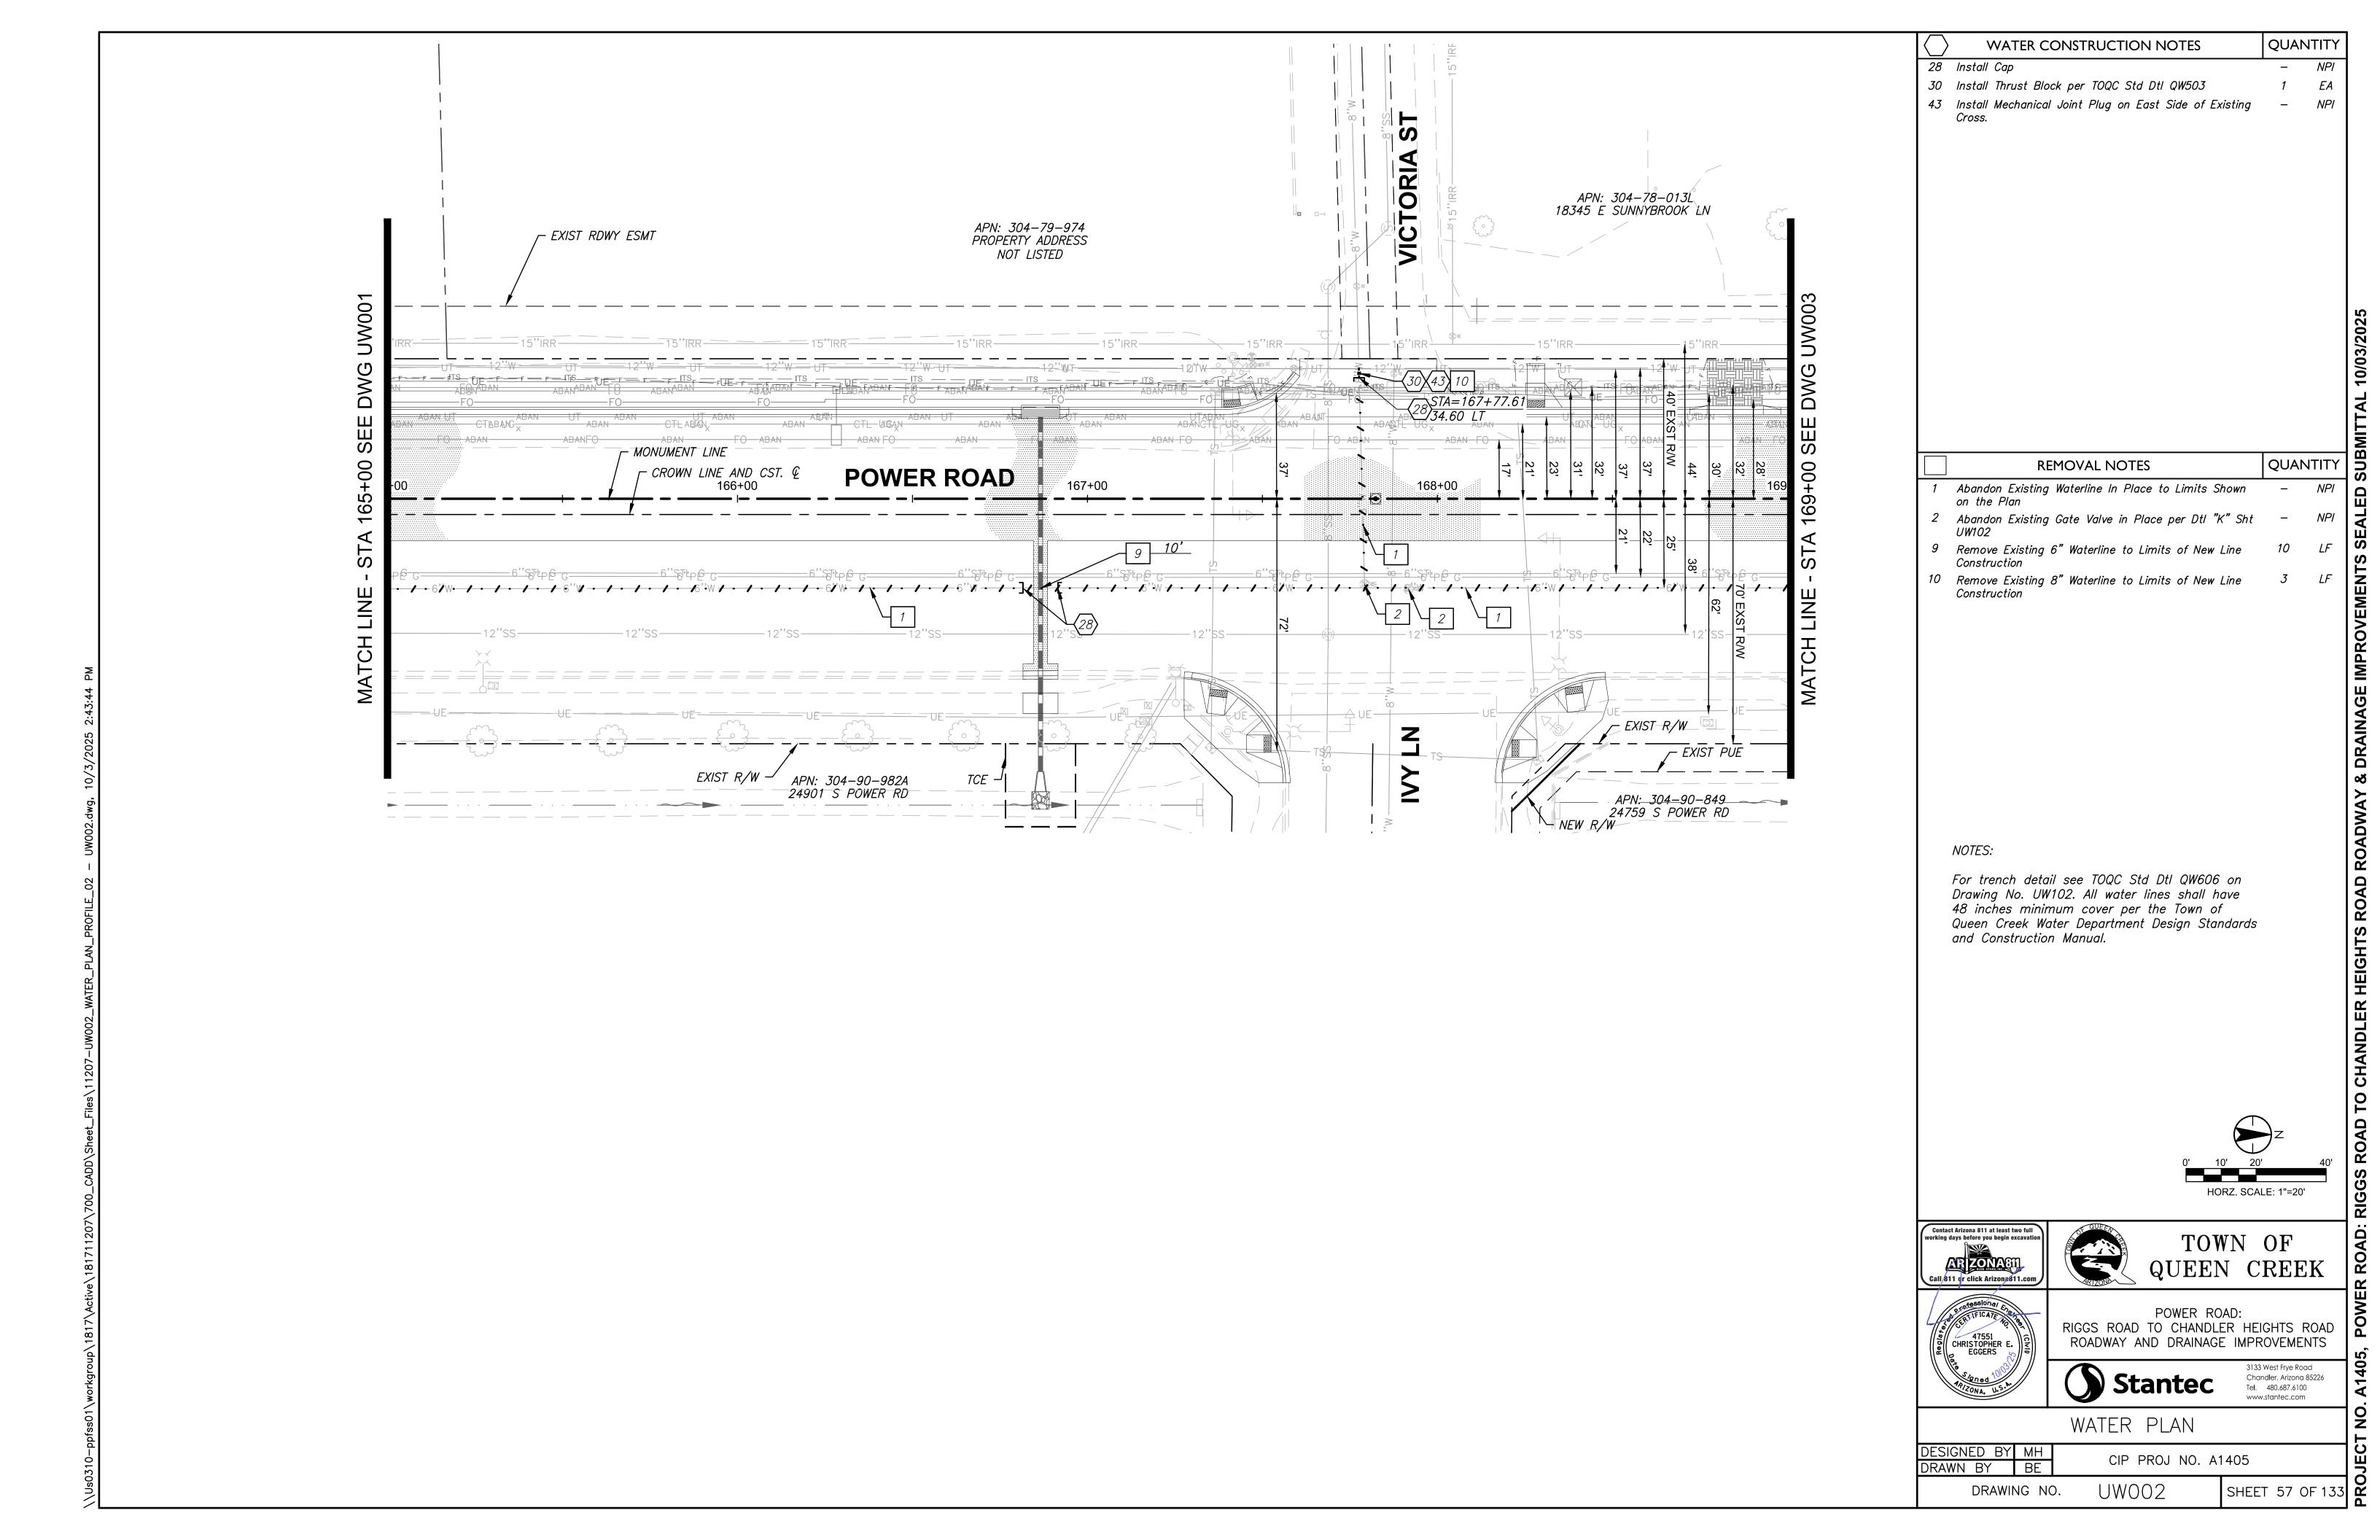

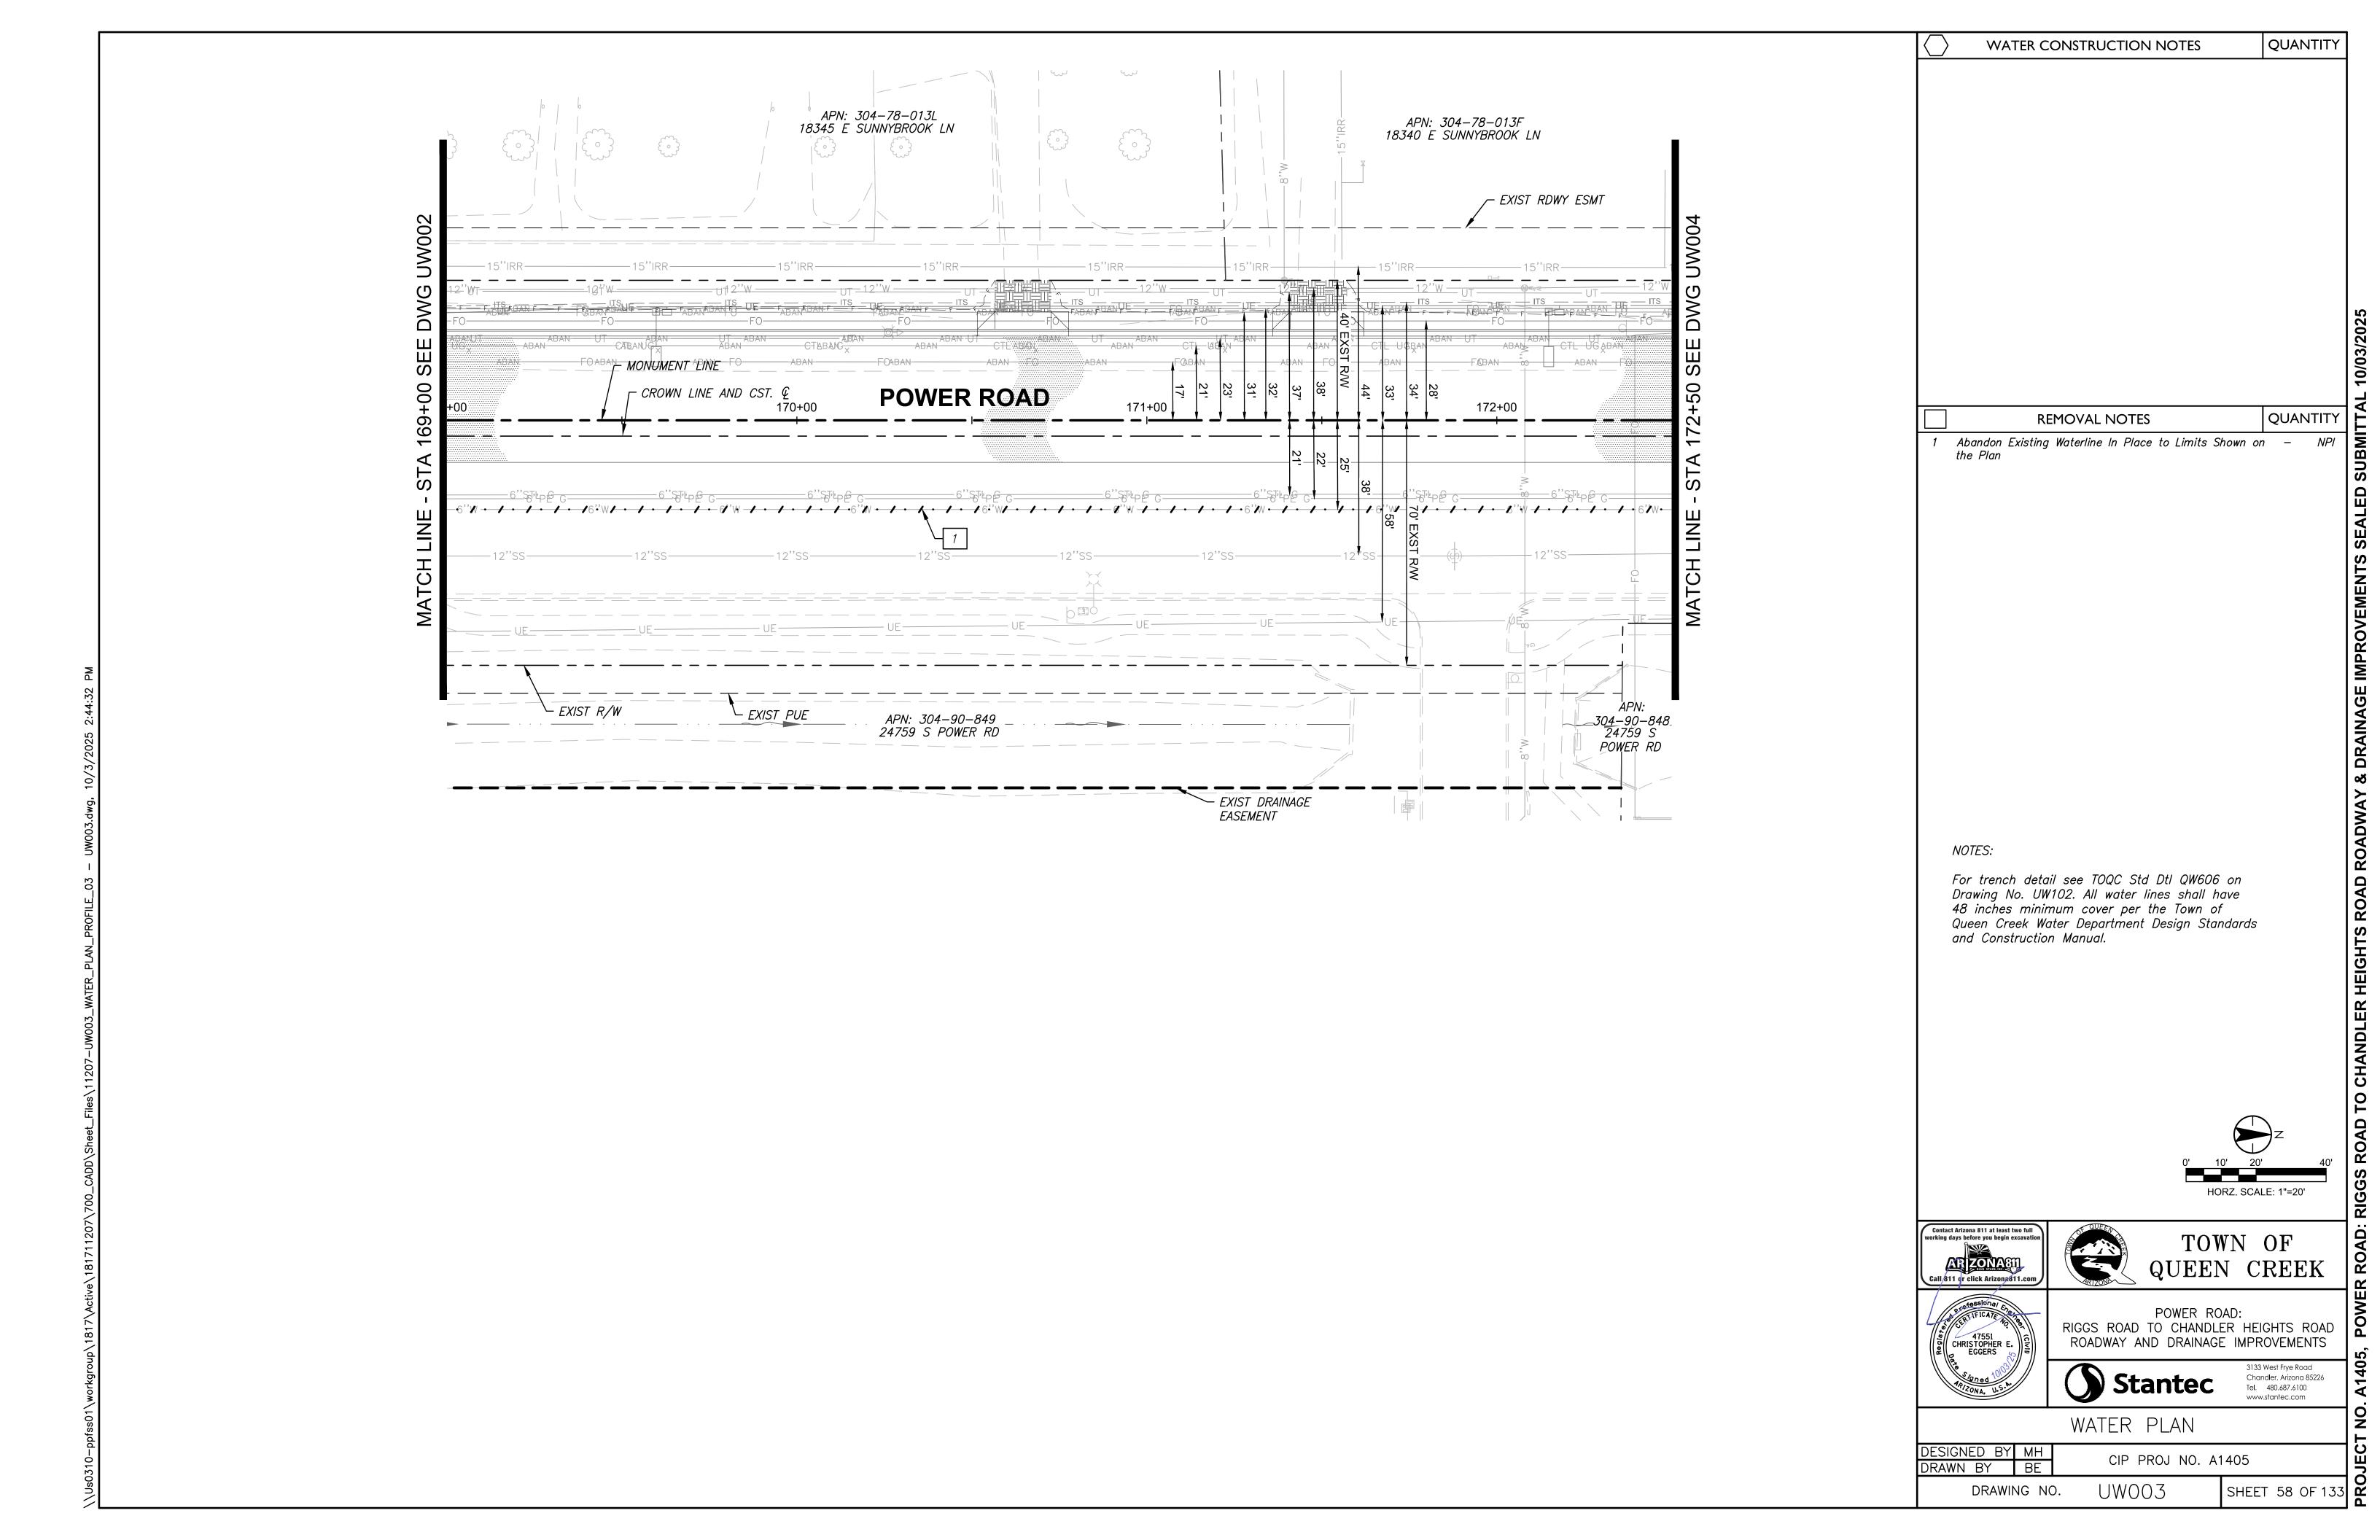

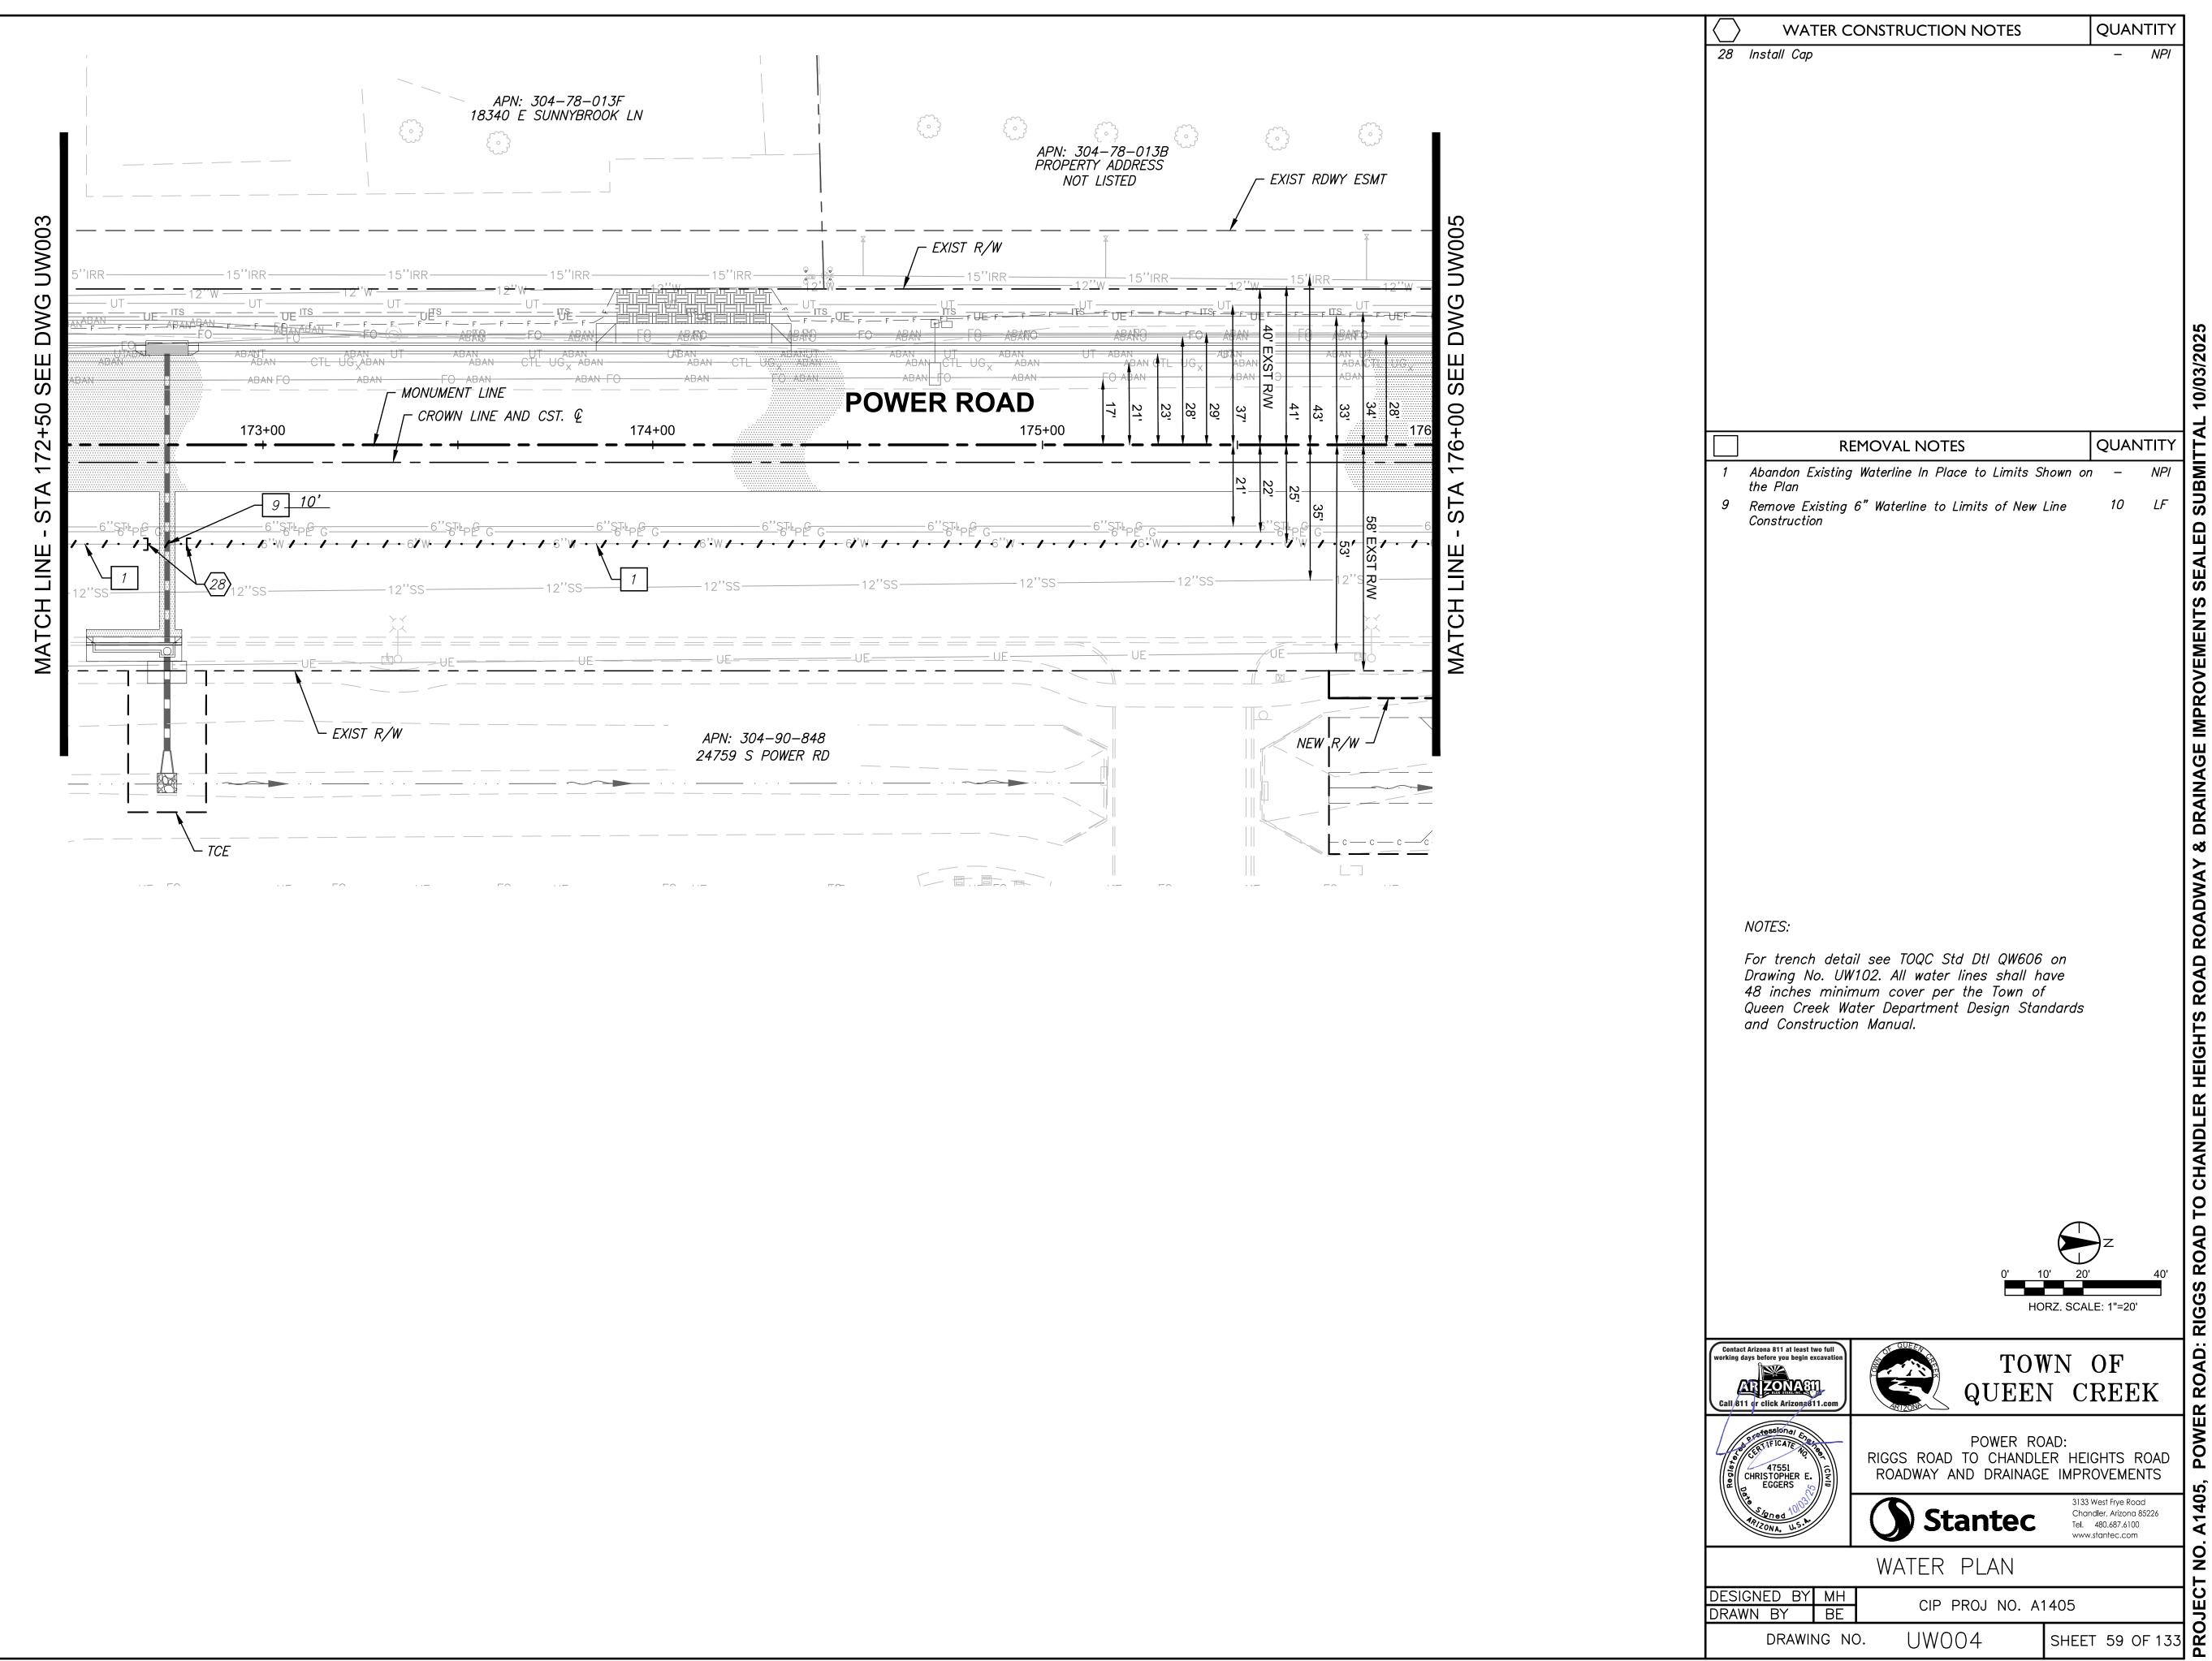



ROAD TO CHANDLER HEIGHTS ROAD


QUANTITY

DRAWING NO.

UW004

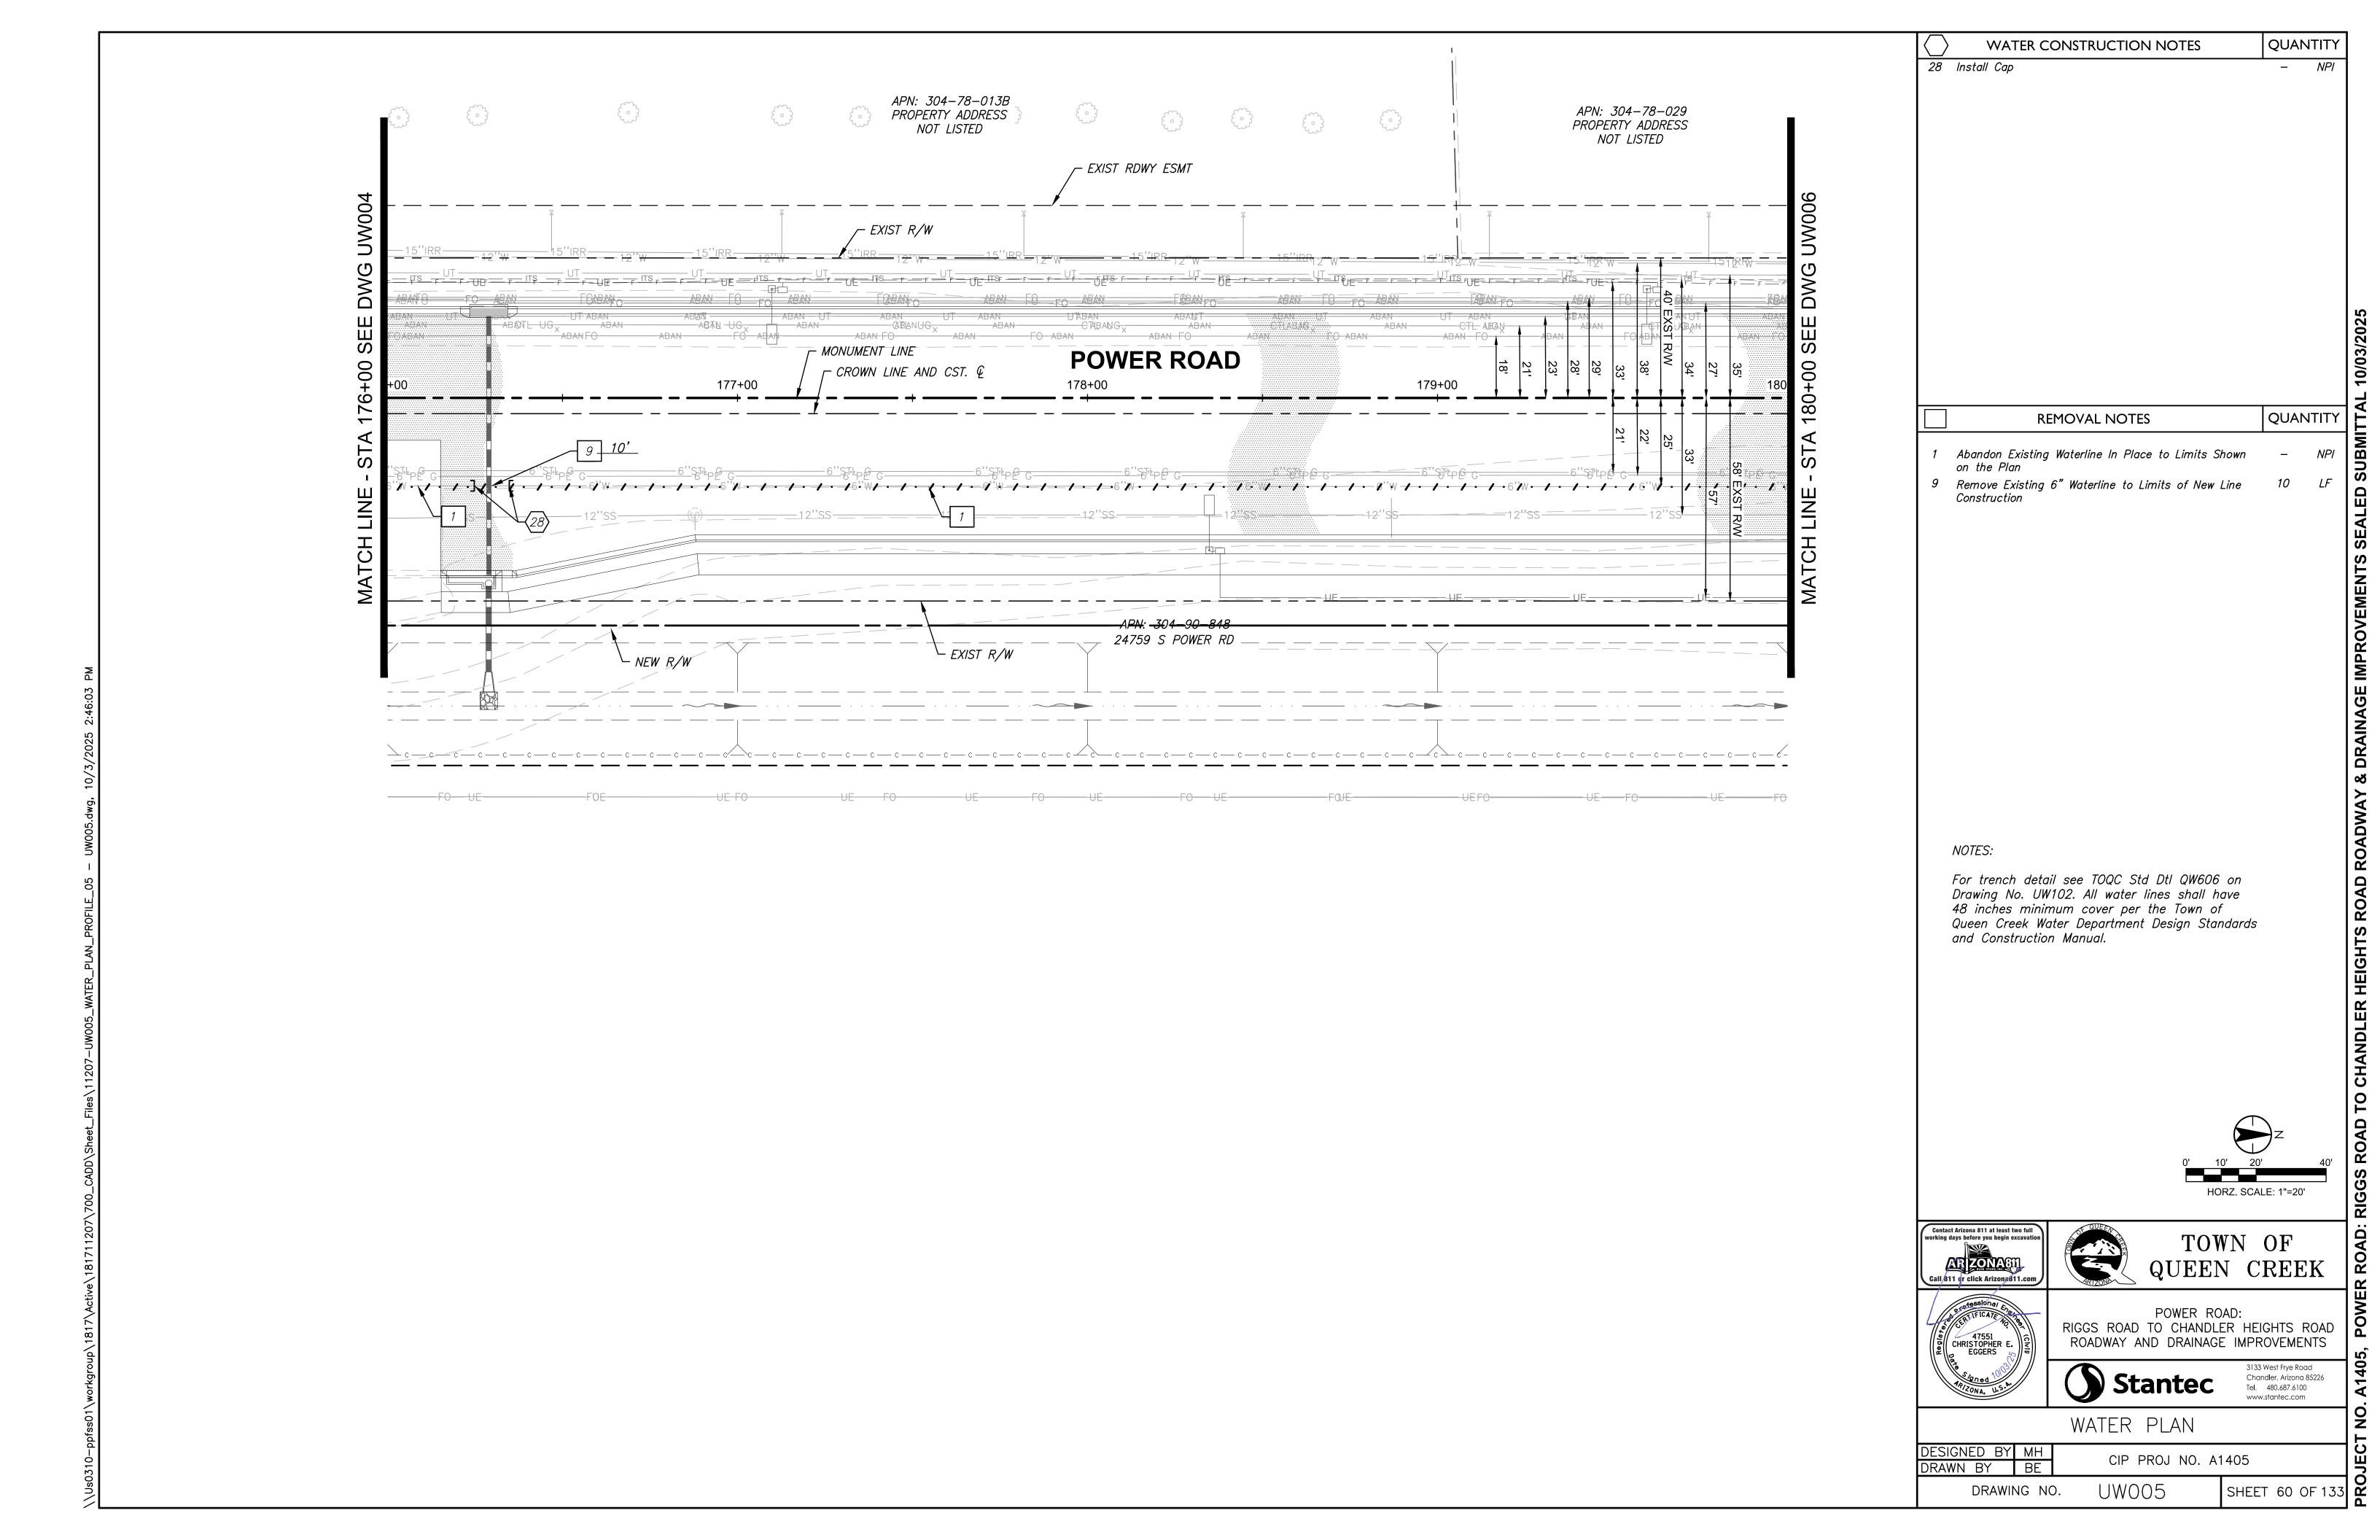

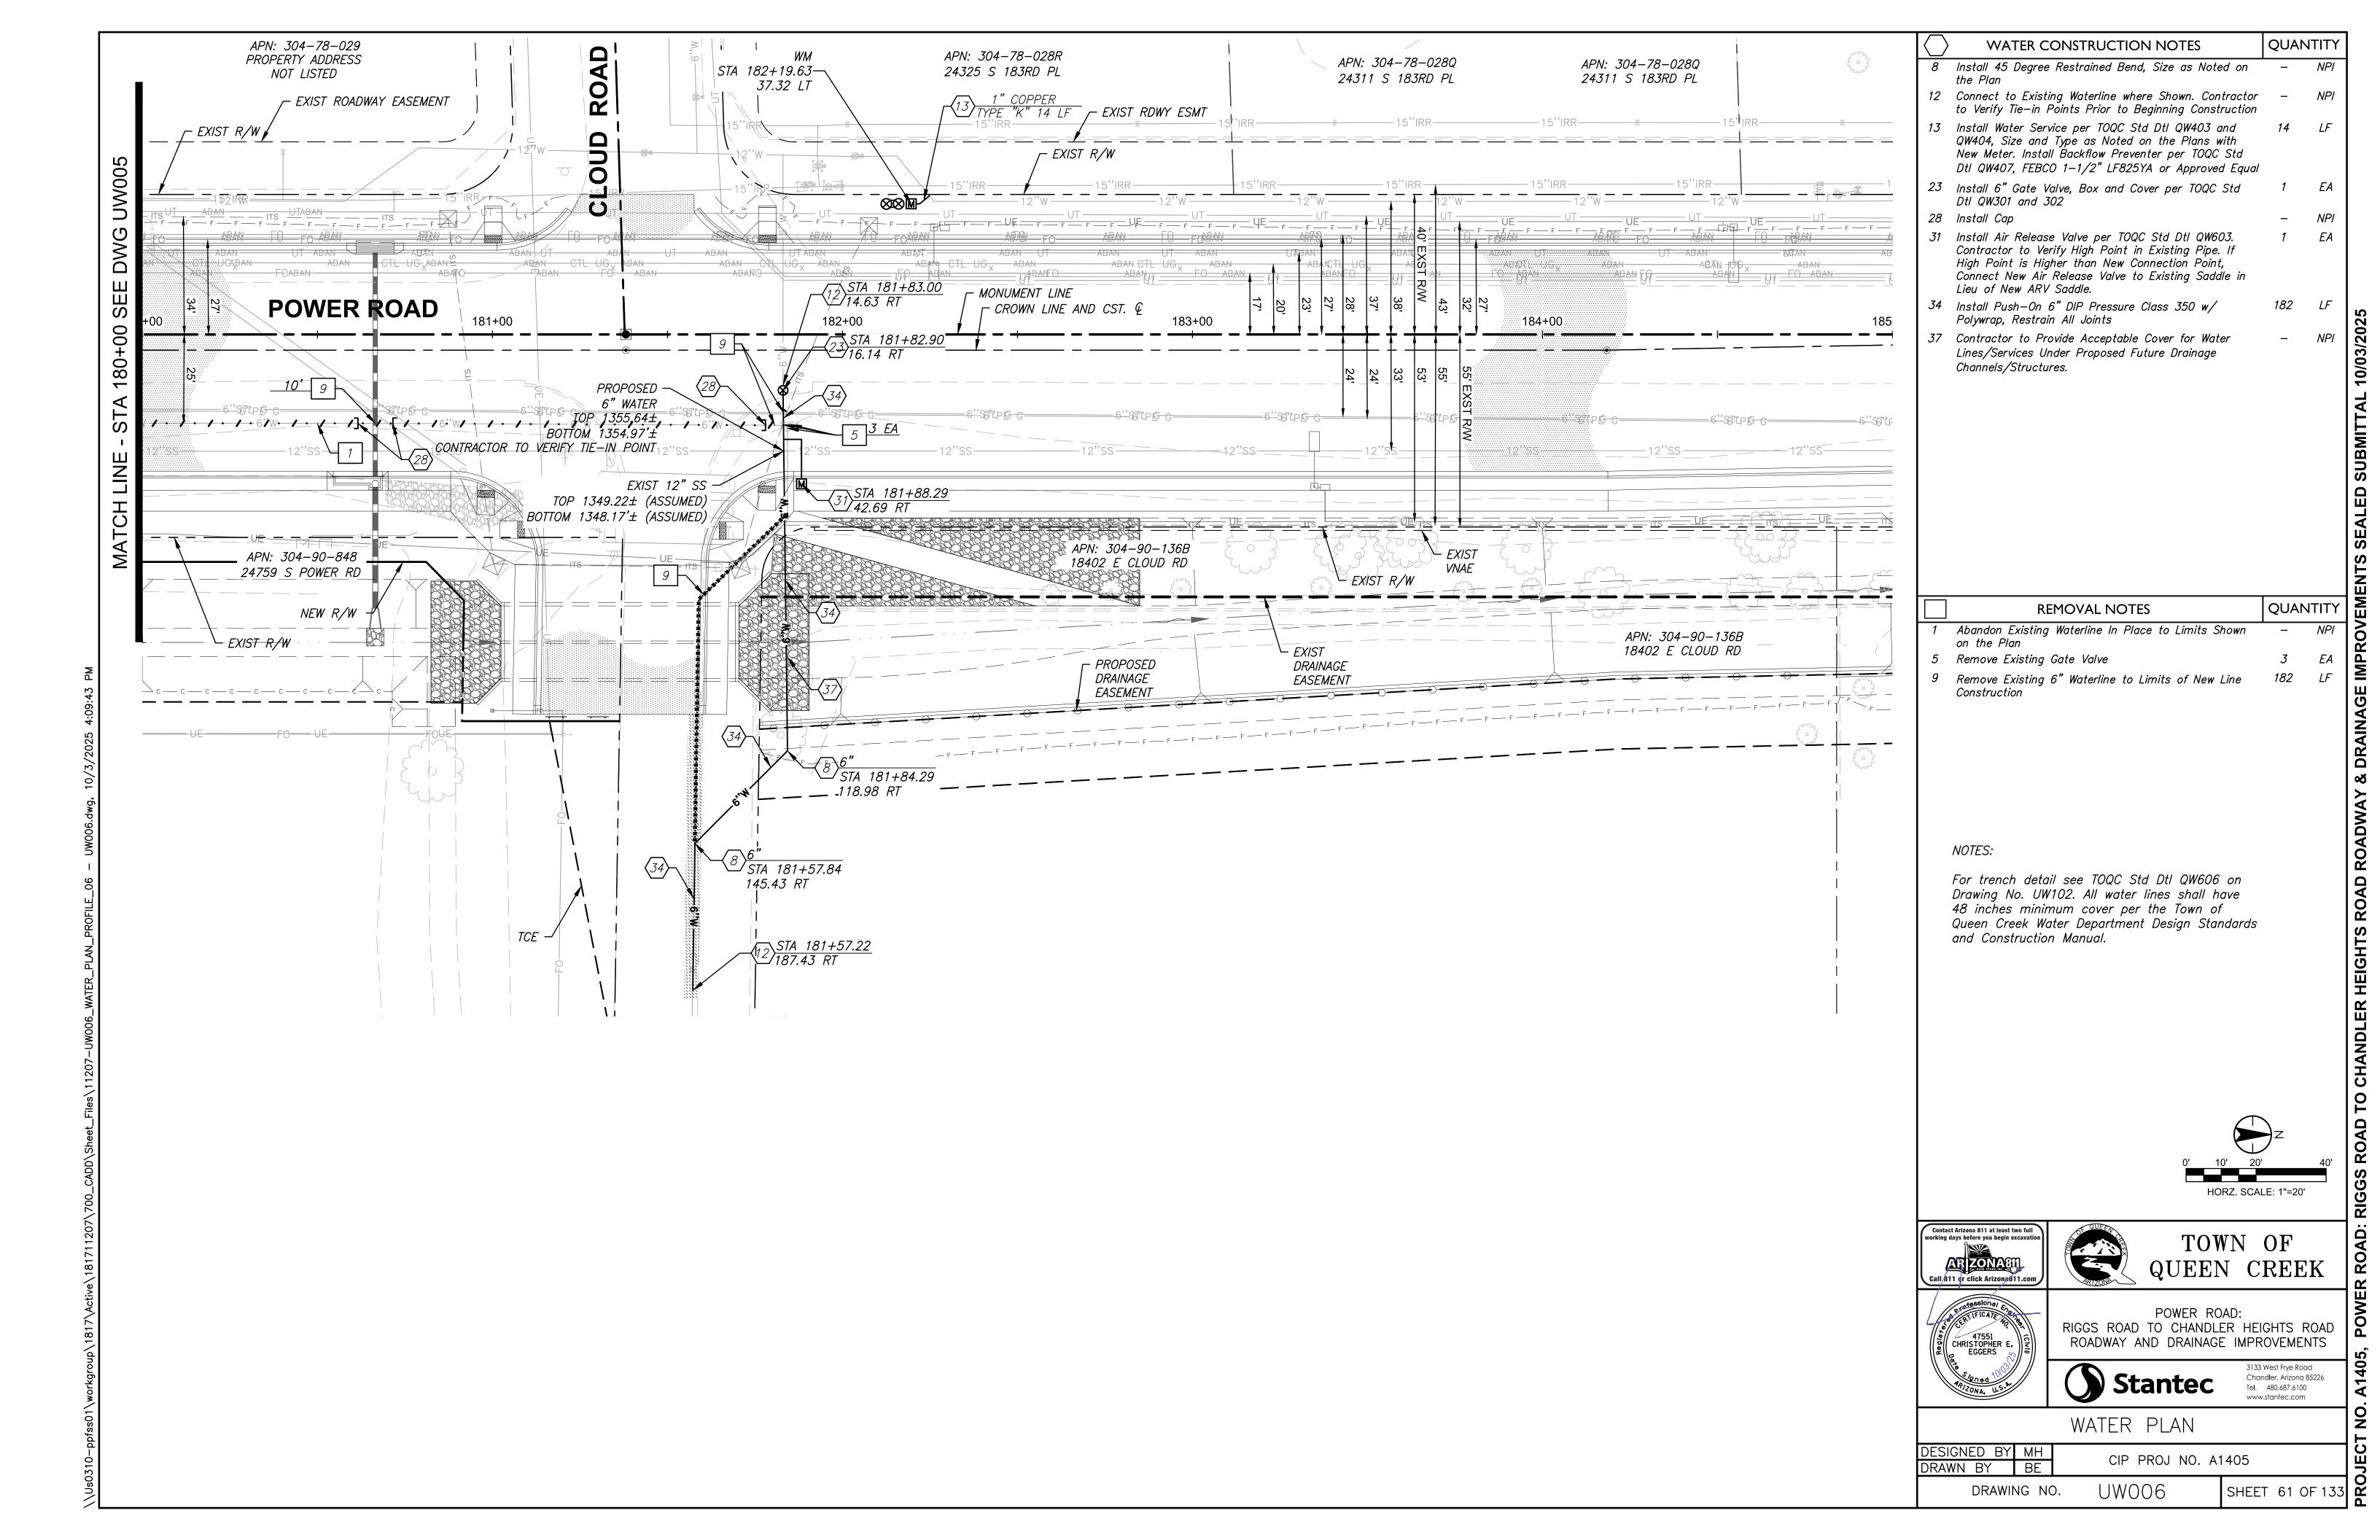

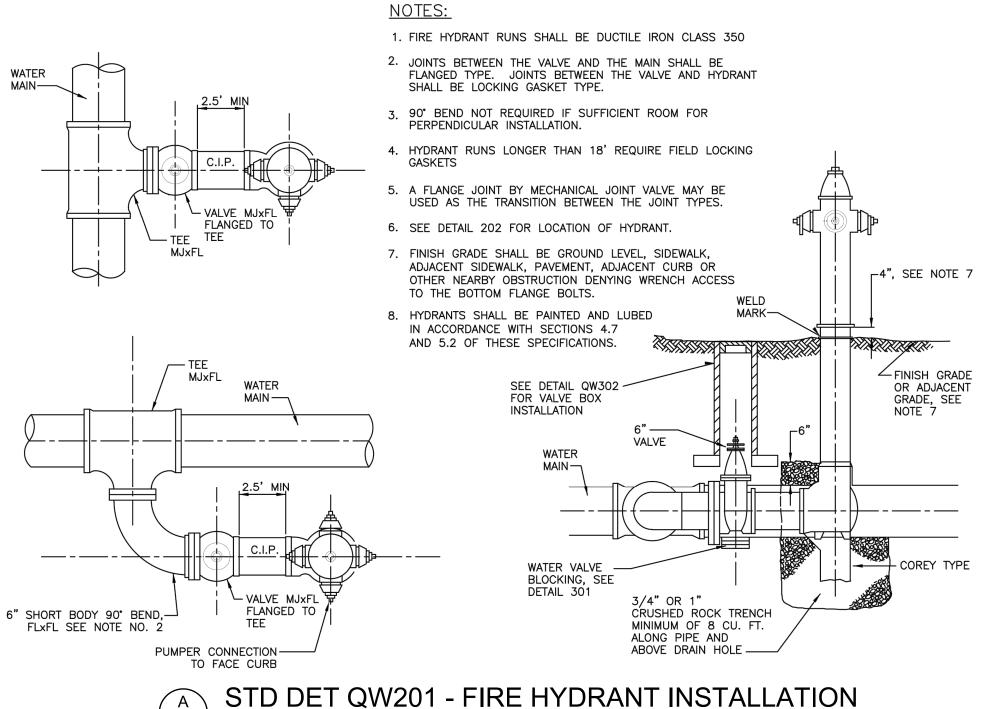

- THE WORD "WATER" ON COVER

-- VALVE BOX DEBRIS PLUG, MUD

PLUG BY INFACT CORPORATION, SEE

ALL FITTINGS TO BE MECHANICAL

-BLOCKING FOR WATER VALVE

JOINT & MECHANICAL

PER MAG STD DTL 301

RESTRAINTS

TOOC STANDARDS SECTION 4.3.1

-CAST IRON ADJUSTABLE VALVE

BOX & COVER PER MAG STD

DTL 391-1 TYPE "C"


2" SQUARE OPERATING

B" CI FRAME AND COVER PER MAG STD DTL 270,

LOCKING LID IN HIGH TRAFFIC AREA PER INSPECTOR


- CLASS 'AA' CONCRETE W/ FIBERGLASS REINFORCEMENT PER

TOQC STANDARDS SECTION 3.8

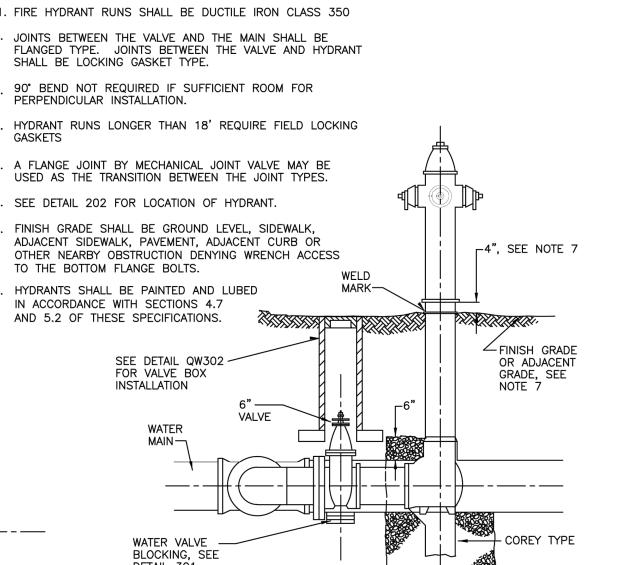

NOTES:


- 1. OBSTRUCTIONS SUCH AS UTILITY POLES, STREET SIGNS, IRRIGATION BOXES, FENCES, ETC., SHALL NOT BE PLACED BETWEEN CURB AND HYDRANT AND WITHIN THE RADIUS FOR
- 2. DIMENSIONS SHOWN ON CONSTRUCTION DRAWINGS SUPERSEDE LOCATIONS SHOWN HERE.
- 3. ON LOCATIONS IN MIDBLOCK, THE FIRE HYDRANT SHALL BE ALIGNED WITH A PROPERTY LINE.

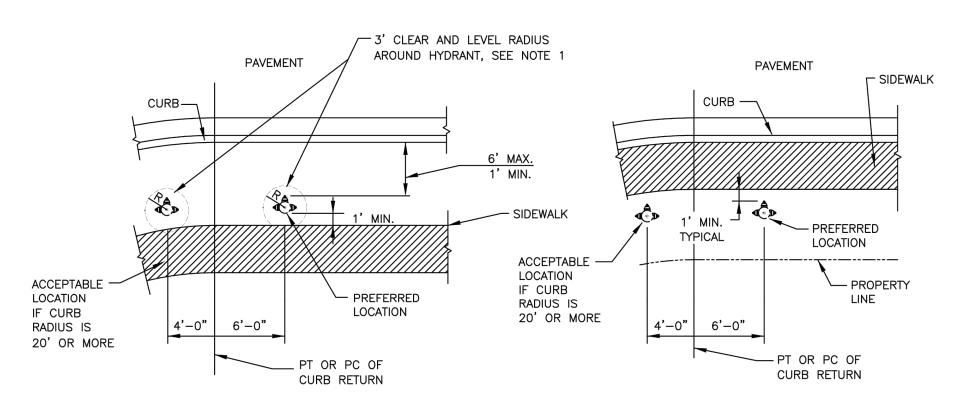

PARKWAY AREA WITH PLANTER OR NO SIDEWALK

AREA WITH SIDEWALK

STD DET QW202 - LOCATIONS FOR NEW FIRE HYDRANTS NOT TO SCALE

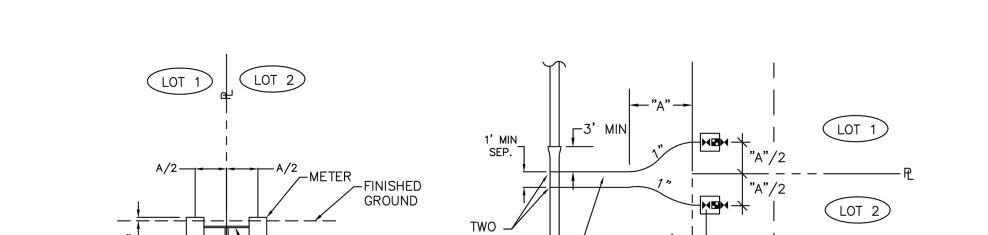

└1" COPPER ~1⅓" COPPER BALL VALVE CORP STOP TAP HORIZONTAL

SADDLES (TO ANGLE STOP VALVE) "A"=10' FOR LOTS LARGER THAN 0.5 ACRES COMMON-"A"=6' FOR LOTS SMALLER THAN 0.5 ACRES TRENCH <u>OPTION 2 — COMMON TRENCH</u>

BALL VALVE ANGLE 7

BY OTHERS

- WATER METER

(BY TOQC)

STOP BY CONTRACTOR

#2 METER BOX-

BY CONTRACTOR

2"-3" ABOVE -

TOP OF CURB

OR FINISH GRADE


SINGLE SADDLE OPTION 1 — ELEVATION, WYE/SINGLE SADDLE

NOTES:

- 1. SERVICE TAPS SHALL BE A MINIMUM OF 3' FROM BELLS.
- 2. THERE SHALL BE AT LEAST 1' BETWEEN
- 3. ALL METERS BEING RELOCATED SHALL REQUIRE A NEW COMPLETE SERVICE LINE FROM MAIN TO METER (NO EXTENSIONS OR COUPLINGS PERMITTED).
- 4. WHEN MAIN LINES ARE RELOCATED OR REPLACED FOLLOW NOTE 3.
- 5. THE CONTRACTOR MAY ADJUST THE COMMON TRENCH LOCATION BASED ON FIELD CONDITIONS AND UTILITY CONFLICTS. REQUIRED ADJUSTMENTS SHALL BE IDENTIFIED AND REVIEWED WITH THE TOWN'S PROJECT MANAGER.

FINISHED GROUND-TYPE K COPPER TUBING - MUELLER WYE IF OPTION 1 USED SERVICE LINE BY CONTRACTOR BALL VALVE CORP STOP - TAP HORIZONTAL TO MAIN

STD DET QW403 - WATER METER LOCATION NOT TO SCALE

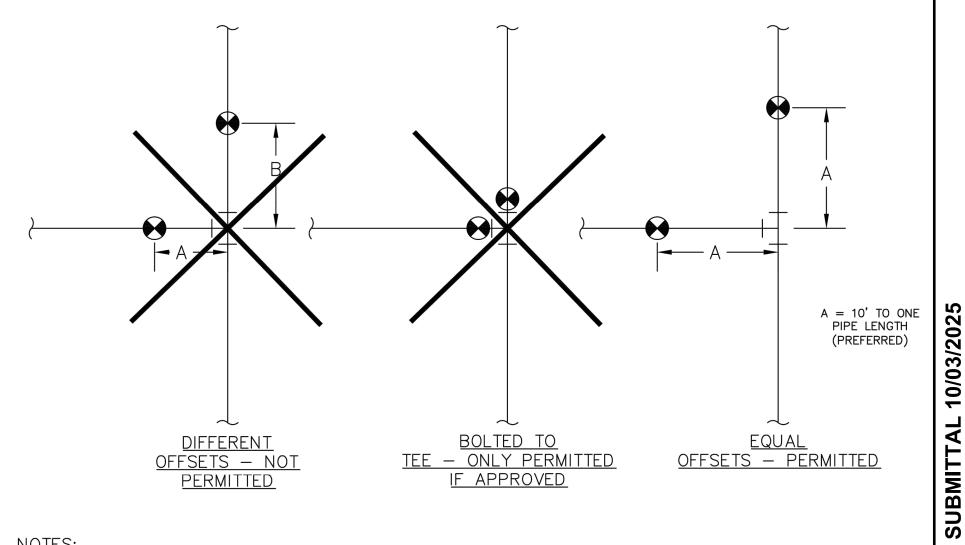

NOTES:


1. SPACE VALVES AN EQUAL DISTANCE FROM COMMON FITTING. PREFERRED DISTANCE IS 10'-18' DEPENDING ON SURFACE FEATURES (CURBS, VALLEY GUTTERS, ETC..).

2. UNEQUAL SPACING OF VALVES REQUIRES APPROVAL BY THE WATER DIVISION.

3. ALL JOINTS AT VALVES AND TEES SHALL BE RESTRAINED APPROVED JOINT RESTRAINTS USING "STAR-GRIP" OR MEG-A-LUG JOINT RESTRAINT

4. A FULL LENGTH OF PIPE SHALL EXTEND AWAY FROM EACH VALVE AND SHALL BE RESTRAINED AT THE VALVE.

STD DET QW301 - VALVE SPACING DETAIL NOT TO SCALE

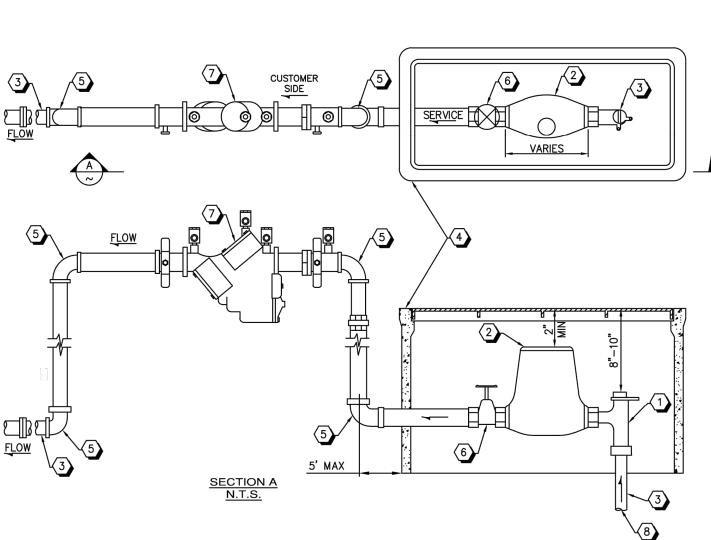

NOTES
1. TOP OF WATER METER SHALL BE A MINIMUM OF 2" BELOW UNDERSIDE OF COVER.

SEALED

DRAINAGE IMPROVEMENTS

2

ROAD

ROAD:

- 2. METERS SHALL NOT BE INSTALLED IN DRIVEWAYS OR IN A LOCATION INACCESSIBLE FOR MAINTENANCE.
- 3. ALL METERS SHALL BE SET BY THE TOQC WATER DIVISION.

LIST OF MATERIALS

- ANGLE METER VALVE (LOCKING TYPE) SIZE TO MATCH SERVICE- TOQC SIDE OF INLET SERVICE LINE.
- TOQC WILL PROVIDE AND INSTALL WATER METER. SEE NOTE 3 ABOVE.
- (3) TYPE K COPPER
- METER BOX AND COVER PER DCSM TABLE 4.6.2
 - (5) 2" COPPER 90" BEND SOLDERED 6 BALL VALVE
- REDUCED PRESSURE BACKFLOW PREVENTION DEVICE PER TOQC STD DTL QW407
- 8 WATER SERVICE PER QW403-1

STD DET QW404 - 2" AND SMALLER WATER METERS NOT TO SCALE

Contact Arizona 811 at least two full

orking days before you begin exca



TOWN OF

POWER ROAD: RIGGS ROAD TO CHANDLER HEIGHTS ROAD ROADWAY AND DRAINAGE IMPROVEMENTS

Stantec

Chandler, Arizona 85226 Tel. 480.687.6100

WATER DETAILS DESIGNED BY MH CIP PROJ NO. A1405

DRAWING NO.

SHEET 62 OF 297

PIPE SIZE AS

SHOWN ON

PLANS

GATE VALVE (SAME SIZE

AS PIPELINE)

NOT TO SCALE

NOT TO SCALE

TRACE WIRE SHALL BE LOOPED UP -THROUGH ALL IN-LINE VALVE BOXES

AND EXTEND A MINIMUM OF 12"

TRACER WIRE SHALL BE CAREFULLY COILED AND PLACED BENEATH THE

PROTECT WIRE DURING INSTALLATION.

BACKFILL & COMPACTION —

DENSITY IN ROAD R/W

90% EVERYWHERE ELSE

TRACER WIRE OUTSIDE OF BOTTOM CAN

TO 95% MAX DRY

VALVE BOX COVER. CONTRACTOR SHALL


ABOVE GROUND

STD DET QW302 - TYPICAL GATE VALVE

6" MIN -

DRAWN BY

UW101

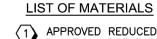

1 3 VENT SLOTS

STAINLESS STEEL-

4" THICK-

FRONT VIEW

BACK VIEW

RELEASE SCREW

ALIGNMENT

CONCRETE PAD CLASS C PER


PADLOCK BACKING

VALVE COVER, SEE APPROVED PRODUCTS LIST

1 APPROVED REDUCED PRESSURE PRINCIPLE BACKFLOW PREVENTION ASSEMBLY. TYPE "L" COPPER PIPE 3/4" THRU 2"

3 90° ELBOW COPPER 3/4" THRU 2"

4 PIPE UNION, BRASS OR COPPER

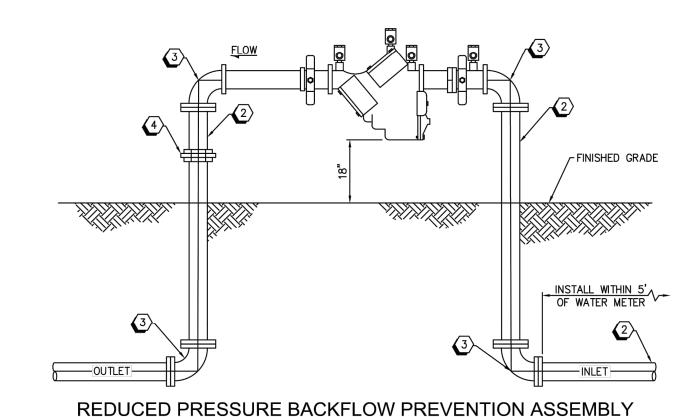

CONCRETE PAD


STRUCTURES.

- ½" HEX NUTS WITH 1" WASHERS ON 1" HEX BOLTS IN CONCRETE

- 1. THE BACKFLOW PREVENTION ASSEMBLY SHALL BE TESTED AND APPROVED BY A CERTIFIED TECHNICIAN DESIGNATED IN THE CURRENT TOQC LIST OF APPROVED INSPECTORS PRIOR TO THE REQUEST FOR FINAL INSPECTION.
- 2. ALL COPPER PIPE JOINTS SHALL BE SOLDERED. THE SOLDERED ALLOY SHALL COMPLY WITH ASTM B32 HAVING A SILVER CONTENT OF NOT LESS THAN 3.4% INTENDED FOR JOINING COPPER PIPES FOR POTABLE WATER SYSTEMS (GRADES SN 94, SN 95, OR SN 96). THE FLUX SHALL BE TYPE OA FOR GENERAL SOLDERING ON COPPER.
- 3. INSTALL BRASS PIPE PLUG IN EACH TESTCOCK ON THE ASSEMBLY.
- FINISHED GRADE UNDER THE BLACKFLOW PREVENTER SHALL BE COMPACTED TO 95% OF MAXIMUM DENSITY 5. PROVIDE 18-INCH MINIMUM CLEARANCE BETWEEN BACKFLOW PREVENTION ASSEMBLY AND PERMANENT
- 6. FOR OUTSIDE INSTALLATIONS, THE BACKFLOW PREVENTER AND COPPER PIPE SHALL BE PAINTED
- 7. BACKFLOW ASSEMBLIES INSTALLED ON A CONCRETE PAD WILL HAVE THE COPPER PIPE WRAPPED OR SLEEVED WHERE IN PENETRATES THE CONCRETE.

DARK GREEN (ALL EXCEPT THE NAME PLATE).

8. SCREENING SHALL BE AS REQUIRED BY TOQC.

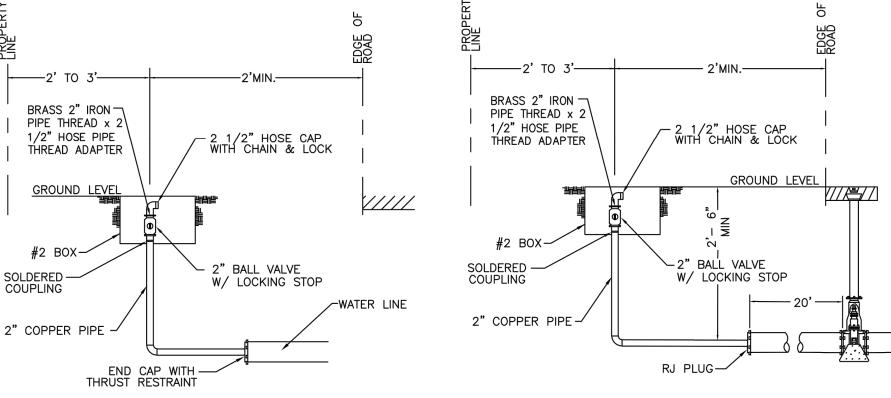

NOTE: THE CONTRACTOR SHALL INSTALL METER BOX A MINIMUM OF 2' FROM THE EDGE OF THE ROADWAY.

> TYPE A BLOW-OFF ASSEMBLY FOR PERMANENT DEAD-END LINES

TYPE B BLOW-OFF ASSEMBLY

FOR TEMPORARY DEAD-END LINES

STD DET QW407 - BACKFLOW PREVENTION - FOR ASSEMBLIES 2" AND SMALLER NOT TO SCALE


TOP VIEW (BASE)

FRONT VIEW (OPENED)

STD DET QW602 - BLOW-OFF ASSEMBLY NOT TO SCALE



- WHENEVER ROCK OR UNSUITABLE BEDDING MATERIAL IS ENCOUNTERED IN TRENCH BOTTOM, OVER EXCAVATION SHALL BE REQUIRED TO A MIN OF 6" DEPTH BELOW PIPE AND REPLACED WITH NATIVE MATERIAL. DUCTILE IRON PIPE BEDDING SHALL BE 2" MINUS
- MINIMUM COVER SHALL BE MEASURED FROM THE EXISTING OR PROPOSED GRADE , OR FROM NATURAL GROUND, WHICHEVER IS DEEPER.
- 3. CONTRACTOR SHALL CONFORM TO ALL OSHA STANDARDS AND REGULATIONS FOR TRENCH EXCAVATION AND PIPE INSTALLATION.
- 4. PVC PIPE BEDDING TYPE SHALL BE 1" MINUS GRANULAR MATERIAL.
- TRACER WIRE SHALL BE REQUIRED AT "OFF—SITE" INSTALLATIONS, IN UNDEVELOPED AND/OR CHANGING AREAS OR AS SPECIFICALLY REQUIRED BY THE WATER DIVISION.
- SPLICES FOR COPPER WIRE SHALL BE MADE USING SIZE 10 & 12 BUTT CONNECTORS TO SPLICE NUMBER 12 BLUE LOCATOR WIRE.
- 8. BLUE INSULATED COPPER WIRE (NUMBER 12 AWG) REQUIRED DIRECTLY ON TOP OF MAIN WATER LINE & TAPED EVERY JOINT WITH DUCT TAPE.

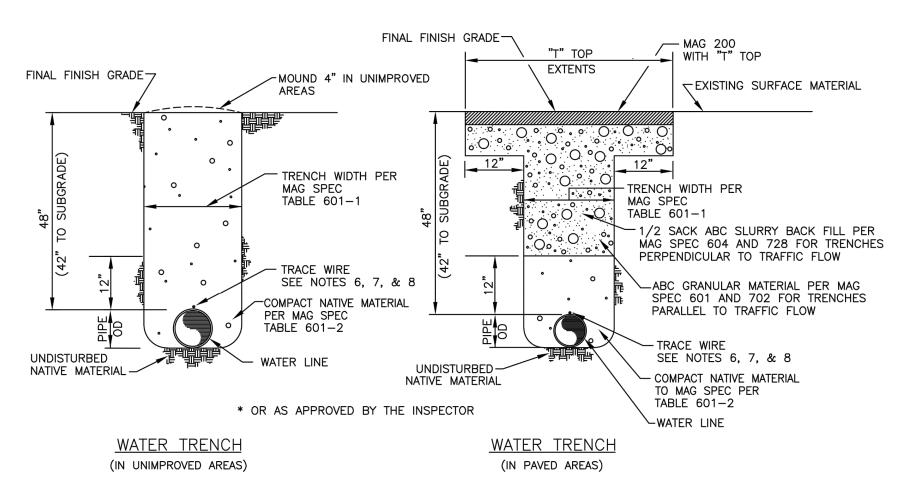




PLASTIC

1. CONCRETE PERIMETER EDGE SHALL HAVE A $\frac{1}{2}$ " CHAMFER.

2. BOLLARD POSTS, MAG STANDARD DETAIL 140, MAY BE REQUIRED, PER TOWN INSPECTOR.


3. PIPELINE PRODUCTS POLYETHYLENE VALVE ENCLOSURE PER APPROVED MATERIALS LIST.



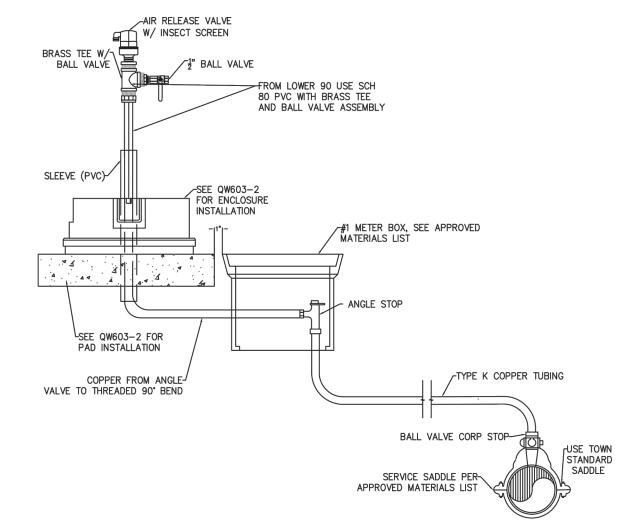


- 1. ARV, SERVICE TUBING, VALVES, FITTINGS, SLEEVE, AND APPURTENANCES SHALL MATCH SIZES. SIZES PER PLAN.
- 2. AIR RELEASES SHALL BE SET IN A FLAT STRIP OF LAND WHICH PARALLELS THE CURB, SIDEWALK OR WATERMAIN. SET THE AIR RELEASE 8" BACK OF CURB IN STREETS WITH CURBS, SET THE AIR RELEASE 3' FROM PROPERTY LINE IN STREETS WITHOUT CURBS, OR PER PLAN LOCATION.
- 3. 90° COMPRESSION FITTINGS MAY BE INSTALLED TO ACHIEVE POSSIBLE SLOPE.
- 4. ALL AIR RELEASE VALVE INSTALLATIONS REQUIRE A TRACER WIRE.
- AIR RELEASE VALVE SHALL BE PER APPROVED MATERIAL LIST.
- 6. ALL SERVICE LINES SHALL BE INSTALLED WITH A POSITIVE SLOPE TO ARV.

STD DET QW603 - AIR AND VACUUM RELEASE VALVE NOT TO SCALE

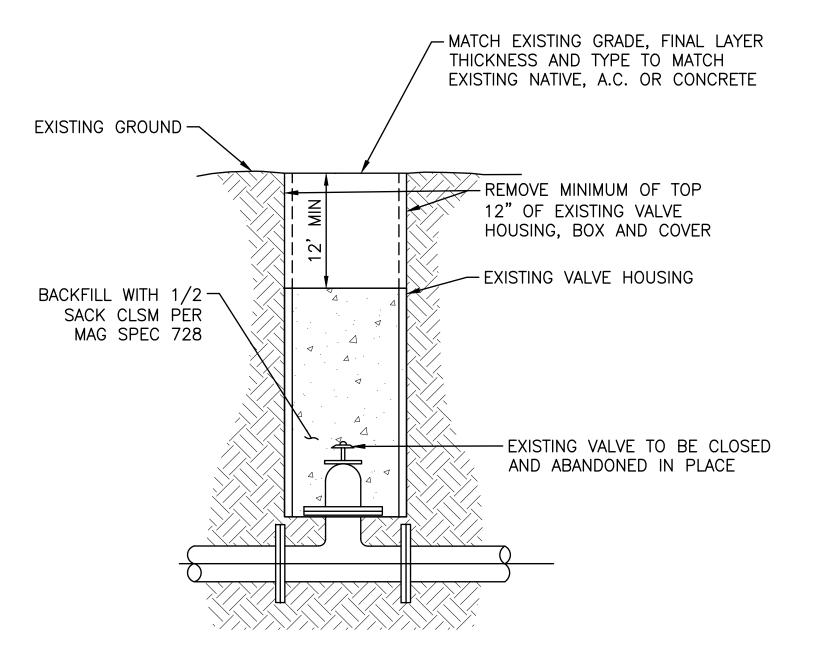



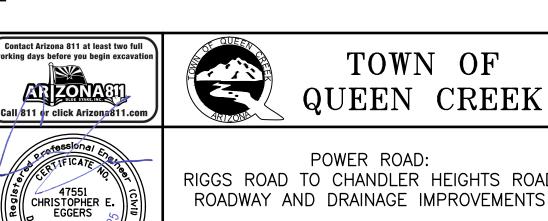

RIGGS ROAD TO CHANDLER HEIGHTS ROAD ROADWAY AND DRAINAGE IMPROVEMENTS

Stantec

WATER DETAILS

DESIGNED BY MH CIP PROJ NO. A1405 DRAWN BY BE


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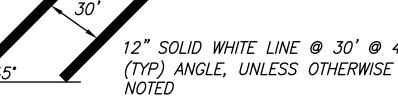
SHEET 63 OF 133

Chandler, Arizona 85226

Tel. 480.687.6100





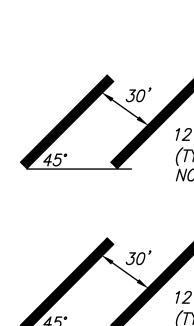











12" SOLID WHITE LEFT & RIGHT TURN ARROWS PER ADOT STANDARD DETAIL M-10



12" SOLID WHITE LEFT THRU ARROWS PER ADOT STANDARD DETAIL M-10



SCHOOL PAVEMENT MARKING PER ADOT STANDARD DETAIL M-6



24" SOLID WHITE MERGING RIGHT TO LEFT ARROW PER ADOT STANDARD DETAIL M—10



BEGIN RIGHT TURN LANE YIELD TO BIKES


Power RD







FLASHING HAND


STOP

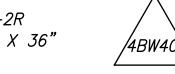


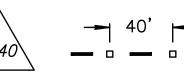

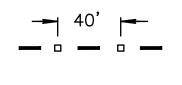



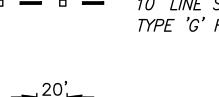


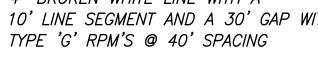



4" SOLID WHITE LINE


SEGMENT AND A 6' GAP

4" DASHED WHITE LINE WITH A 2' LINE

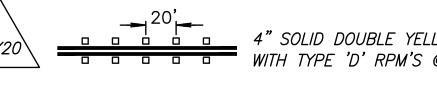

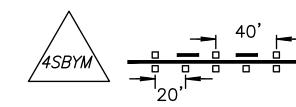

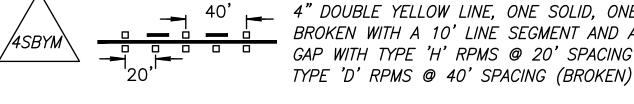


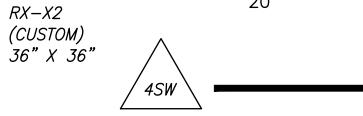

36" X 36"

DO NOT ENTER PUSH BUTTON AND WAIT FOR

W11-7 36" X 36"

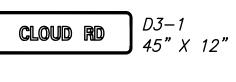


R4-4


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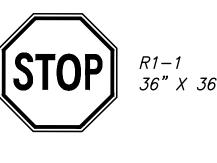








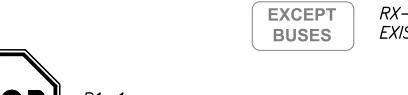

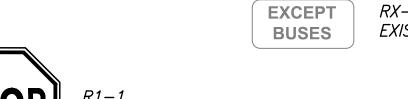

8

OM3—R EXISTING

OM3-L EXISTING

R8-3 30" X 30"

R4-7 EXISTING

OBJECT MARKER EXISTING

R2-1(45) 30" X 36"

R3-17 30" X 24"

R3-9B 24" X 36"

R10-6 24" X 36"

M-2

EXISTING

SPEED LIMIT 45

STOP HERE ON RED













TOWN OF QUEEN CREEK



POWER ROAD: RIGGS ROAD TO CHANDLER HEIGHTS ROAD ROADWAY AND DRAINAGE IMPROVEMENTS

Chandler, Arizona 85226 Tel. 480.687.6100 Stantec

SIGNING AND STRIPING LEGEND

DESIGNED BY MH CIP PROJ NO. A1405

DRAWING NO.

SHEET 64 OF 133 SG001



THRU
TRAFFIC
MERGE
LEFT

SPEED LIMIT 35

WHEN FLASHING

RICHT LAME

ONLY

PRIVATE ROAD

W9-101L EXISTING

R2-1(35) EXISTING

S4-4P

EXISTING

30" X 12"

R3-5R 30" X 36"

RX-X

RX-X EXISTING

36" X 36"

S4-3P **EXISTING**

EXISTING