4. THE CONTRACTOR SHALL COORDINATE WITH THE TOWN TRAFFIC ENGINEERING DIVISION PRIOR TO ORDERING ANY MATERIALS TO OBTAIN THE LATEST SIGNING REQUIREMENTS AND SPECIFICATIONS.

5. THE CONTRACTOR SHALL NOTIFY THE TOWN TRAFFIC ENGINEERING DIVISION AT (480) 358-3132 UPON COMPLETION OF ALL SIGNING WORK TO SCHEDULE A FINAL INSPECTION. THE CONTRACTOR SHALL SUPPLY ALL REQUIRED WARRANTY DOCUMENTS TO THE TOWN TRAFFIC ENGINEERING DIVISION PRIOR TO FINAL JOB

6. ALL EXISTING SIGNS TEMPORARILY REMOVED BY THE CONTRACTOR SHALL BE SALVAGED FOR REINSTALLATION BY THE CONTRACTOR. ALL SIGNS PERMANENTLY REMOVED BY THE CONTRACTOR SHALL BE SALVAGED AND RETURNED TO THE TOWN. THE CONTRACTOR SHALL BE SOLELY RESPONSIBLE FOR MAINTAINING EACH SIGN THAT IS REMOVED, ENSURING THAT THE SIGN'S INTEGRITY IS MAINTAINED. IN THE EVENT THE SIGN IS DAMAGED, THE CONTRACTOR SHALL BE RESPONSIBLE FOR ITS REPLACEMENT.

7. ALL POST MOUNTED SIGNS AND SIGN POSTS SHALL BE INSTALLED PER ADOT STANDARD DRAWING S-3. LIGHT POLE MOUNTED SIGNS SHALL BE INSTALLED PER ADOT STANDARD DRAWING S-9.

8. FINAL ACCEPTANCE OF ALL SIGNING SHALL BE PROVIDED BY THE TOWN TRAFFIC ENGINEERING DIVISION.

9. THE CONTRACTOR SHALL ENSURE THAT AT NO TIME A TRAFFIC SIGN IS INSTALLED IN SUCH A WAY AS TO BE BLOCKED BY TREES OR ANY TYPE OF VEGETATION. IN SUCH CASES, THE CONTRACTOR SHALL CONTACT THE TOWN'S TRAFFIC ENGINEERING SECTION TO PROVIDE AN ALTERNATIVE LOCATION FOR THE INSTALLATION OF SIGNING IN QUESTION.

10. ANY SIGNING THAT IS TO BE AFFIXED TO A STREET LIGHT POLE SHALL BE DONE SO USING A MINIMUM  $^3$ 4 INCH STAINLESS STEEL BANDING WITH APPROPRIATE FASTENERS.

11. ANY SIGNING INSTALLED WITHIN THE TOWN'S RIGHT OF WAY SHALL BE INSTALLED BY AN INDIVIDUAL THAT HAS A CURRENT CERTIFICATION IN SIGNING INSTALLATION OR INSPECTION FROM THE AMERICAN TRAFFIC SAFETY ASSOCIATION (ATSSA) OR INTERNATIONAL MUNICIPAL SIGNAL ASSOCIATION (IMSA). EQUIVALENTS WILL BE CONSIDERED BUT MUST BE SUBMITTED IN WRITING TO THE TOWN'S TRAFFIC ENGINEER 30 DAYS PRIOR TO INSTALLATION OF ANY SIGNING.

### SIGN MATERIAL REQUIREMENTS

1. ALL SIGNS SHALL BE FACED ON NEW .080 INCH ALUMINUM BLANKS.

2. SHEETING SHALL BE ASTM TYPE XI FOR ALL PERMANENT REGULATORY, WARNING, GUIDE, INFORMATION, AND OBJECT MARKER SIGNS (INCLUDING SIGN LEGENDS AND BORDERS).

3. ALL WARNING SIGNS (YELLOW SERIES) SHALL BE MANUFACTURED WITH ASTM TYPE XI 3M FLUORESCENT YELLOW 4081 DIAMOND GRADE REFLECTIVE SHEETING OR APPROVED EQUAL.

4. ALL SCHOOL SIGNS SHALL BE MANUFACTURED WITH ASTM TYPE XI 3M FLUORESCENT YELLOW GREEN 4083 DIAMOND GRADE REFLECTIVE SHEETING OR APPROVED EQUAL.

5. SHEETING SHALL BE MANUFACTURED BY 3M CORPORATION OR AN APPROVED EQUAL WITH EQUAL OR GREATER WARRANTY PERIODS. ALL SIGNS SHALL BE MANUFACTURED USING MATCHING COMPONENTS APPROVED BY THE SHEETING MANUFACTURER.

6. ALL SIGNS SHALL BE LABELED ON THE BACK BOTTOM RIGHT CORNER WITH A DECAL. THE DECAL SHALL STATE THE SIGN IS PROPERTY OF THE TOWN OF QUEEN CREEK AND IDENTIFY THE MANUFACTURER AND DATE OF INSTALLATION

### STREET NAME SIGN REQUIREMENTS

1. ALL REFLECTIVE SHEETING MATERIALS SHALL BE PRESSURE SENSITIVE ASTM TYPE XI 3M WHITE 4090 DIAMOND GRADE REFLECTIVE SHEETING OR APPROVED EQUAL.

2. ALL TRANSPARENT ACRYLIC, PRESSURE SENSITIVE FILM SHALL BE 3M SERIES 1177 GREEN ELECTRO CUT FILM (OR 3M SERIES 1175 BLUE ELECTRO CUT FILM) OR APPROVED EQUAL.

3. SIGNS SHALL BE MANUFACTURED BY APPLYING WHITE SHEETING TO THE ENTIRE ALUMINUM BLANK, THEN A GREEN (OR BLUE AS REQUIRED) TRANSLUCENT PRESSURE SENSITIVE FILM CONTAINING THE CUT OUT STREET NAME. THIS METHOD RESULTS IN A WHITE LEGEND ON A GREEN (OR BLUE) BACKGROUND.

4. LETTERING SHALL BE CLEARVIEW 2-W FONT (UPPER/LOWER CASE).

5. 8 INCH LETTER HEIGHTS SHALL BE USED FOR ALL INTERSECTIONS ALONG AN ARTERIAL STREET WITH 45 MPH OR HIGHER SPEED LIMITS. THESE SIGNS SHALL USE A 16 INCH HIGH BLADE AND SHALL NOT EXCEED 42 INCHES IN WIDTH WITHOUT PRIOR APPROVAL FROM THE TOWN TRAFFIC ENGINEER.

6. 6 INCH LETTER HEIGHTS SHALL BE USED FOR ALL INTERSECTIONS ALONG AN ARTERIAL OR COLLECTOR STREET WITH 30 MPH TO 40 MPH SPEED LIMITS. THESE SIGNS SHALL USE A 12 INCH HIGH BLADE AND SHALL NOT EXCEED 42 INCHES IN WIDTH WITHOUT PRIOR APPROVAL FROM THE TOWN TRAFFIC ENGINEER.

7. 4 INCH LETTER HEIGHTS SHALL BE USED FOR ALL INTERSECTIONS ALONG RESIDENTIAL STREETS WITH 25 MPH OR LESS SPEED LIMITS. THESE SIGNS SHALL USE AN 8 INCH HIGH BLADE AND SHALL NOT EXCEED 42 INCHES IN WIDTH WITHOUT PRIOR APPROVAL FROM THE TOWN TRAFFIC ENGINEER.

### STREET NAME SIGNS - NO OUTLET/DEAD END

1. ALL REFLECTIVE SHEETING MATERIALS SHALL BE PRESSURE SENSITIVE ASTM TYPE XI SERIES 4090 WHITE AND SERIES 4091 YELLOW DIAMOND GRADE REFLECTIVE SHEETING OR APPROVED EQUAL.

2. ALL ACRYLIC, PRESSURE SENSITIVE FILM SHALL BE 3M SERIES 1177 GREEN ELECTRO CUT FILM (OR 3M SERIES 1175 BLUE ELECTRO CUT FILM) AND 3M 1178 BLACK EC FILM OR APPROVED EQUAL.

3. THESE SIGNS ARE CONSTRUCTED BY APPLYING WHITE SHEETING TO THE UPPER HALF OF THE SIGN BLANK AND YELLOW SHEETING TO THE LOWER HALF OF THE SIGN BLANK. ON TOP OF THE WHITE SHEETING, A GREEN (OR BLUE) TRANSLUCENT PRESSURE SENSITIVE FILM CONTAINING THE CUT OUT STREET NAME IS APPLIED. ON TOP OF THE YELLOW SHEETING, THE BLACK "DEAD END" OR "NO OUTLET" AND BLACK ARROW ARE APPLIED.

4. LETTERING FOR THE STREET NAME SHALL BE CLEARVIEW 2-W FONT (UPPER/LOWER CASE) WITH 4 INCH, 6 INCH, OR 8 INCH LETTERING HEIGHT DEPENDING UPON THE LOCATION.

5. LETTERING FOR THE "DEAD END" OR "NO OUTLET" SHALL BE HIGHWAY GOTHIC SERIES C FONT.

6. SIGN HEIGHTS SHALL BE 16 INCHES OR 24 INCHES AND SHALL NOT EXCEED 42 INCHES IN WIDTH WITHOUT PRIOR APPROVAL FROM THE TOWN TRAFFIC ENGINEER.

7. THE CONTRACTOR MAY BE REQUIRED TO SUBMIT SIGNING PROOFS TO THE TOWN TRAFFIC ENGINEER FOR APPROVAL PRIOR TO MANUFACTURING.

### WARRANTY DOCUMENTS

1. THE MANUFACTURER OF THE SIGNING SHALL PROVIDE WARRANTY DOCUMENTS COVERING MATERIALS AND MANUFACTURING DEFECTS UP TO TEN (10) YEARS. THESE DOCUMENTS SHALL BE ADDRESSED TO THE TOWN OF QUEEN CREEK AND SHALL PROVIDE THE NAME OF THE SHEETING MANUFACTURER, TYPE OF SHEETING (BRAND AND TYPE), TYPE OF OVERLAY FILM (BRAND AND TYPE), NAME AND CONTACT INFORMATION OF THE COMPANY RESPONSIBLE PARTY MANUFACTURING THE SIGNS THAT SHALL BE RESPONSIBLE FOR ANY WARRANTY CLAIMS.

### PAVEMENT MARKING PLAN GENERAL NOTES

1. THE CONTRACTOR SHALL COORDINATE WITH THE TOWN TRAFFIC ENGINEERING DIVISION AT (480) 358-3132 FOR AN INSPECTION PRIOR TO THE APPLICATION OF ANY PAINT.

2. AFTER MEETING WITH THE TOWN TRAFFIC ENGINEER, THE CONTRACTOR SHALL SPOT MARK THE ENTIRE PROJECT AND HAVE THE LAYOUT APPROVED BY THE TOWN TRAFFIC ENGINEER PRIOR TO THE APPLICATION OF ANY PAINT. ONCE ALL PAVEMENT MARKINGS HAVE BEEN INSTALLED, THE CONTRACTOR SHALL NOTIFY THE TOWN TRAFFIC ENGINEER FOR A FINAL INSPECTION. AT COMPLETION OF THE FINAL INSPECTION, THE CONTRACTOR SHALL SUPPLY ALL REQUIRED WARRANTY DOCUMENTS TO THE TOWN TRAFFIC ENGINEER PRIOR TO FINAL JOB ACCEPTANCE.

3. THE TOWN TRAFFIC ENGINEER MAY REQUIRE THE CONTRACTOR TO ADJUST PAVEMENT MARKING LOCATIONS, OFFSETS AND TYPES OF MARKINGS PRIOR TO INSTALLATION.

4. ANY PAVEMENT MARKINGS APPLIED PRIOR TO INSPECTION AND APPROVAL BY THE TOWN TRAFFIC ENGINEERING DIVISION SHALL BE OBLITERATED, SEALED AND RESTRIPED AT THE CONTRACTOR'S EXPENSE.

5. ALL CONFLICTING PAVEMENT MARKINGS SHALL BE OBLITERATED BY MEANS OF WATER BLASTING TO BE COMPLETED BY THE CONTRACTOR.

6. A SEALANT APPROVED BY THE TOWN SHALL BE APPLIED BY THE CONTRACTOR TO ALL AREAS OF PAVEMENT MARKING OBLITERATION.

7. ALL PAVEMENT MARKING MATERIALS AND INSTALLATION SHALL CONFORM TO TOWN REQUIREMENTS, THE ARIZONA DEPARTMENT OF TRANSPORTATION STANDARD DRAWINGS AND SPECIFICATIONS, THE MANUAL ON UNIFORM TRAFFIC CONTROL DEVICES (LATEST ADOT APPROVED EDITION), AND DIRECTION FROM THE TOWN TRAFFIC ENGINEER AT THE TIME OF INSTALLATION.

8. PAVEMENT MARKINGS SHALL REQUIRE TWO (2) SEPARATE APPLICATIONS. THE INITIAL APPLICATION SHALL BE ENTIRELY IN PAINT TO INCLUDE ALL LANE LINES, HOLDING BARS, CROSSWALKS AND STOP BARS. ALL LEGENDS SHALL BE APPLIED WITH AN APPROVED TAPE PRODUCT AT THIS TIME. RAISED PAVEMENT MARKERS (RPM'S) SHALL BE INSTALLED WITH THE INITIAL PAINT INSTALLATION. THE CONTRACTOR SHALL RETURN 30-45 DAYS FOLLOWING THE INITIAL PAINT INSTALLATION AND RESTRIPE THE ENTIRE PROJECT IN THERMOPLASTIC OR AS DIRECTED BY THE TOWN TRAFFIC ENGINEER.

9. ALL PERMANENT PAVEMENT MARKING MATERIALS ON MAJOR ARTERIALS SHALL BE EXTRUDED THERMOPLASTIC. ALL OTHER ROADWAYS SHALL REQUIRE SPRAY THERMOPLASTIC AT A MINIMUM UNLESS OTHERWISE SPECIFIED BY THE TOWN TRAFFIC ENGINEER. PERMANENT PAVEMENT MARKINGS SHALL BE USED ONLY WHERE SPECIFIED OR NOTED.

10. ALL PAVEMENT MARKING TRANSVERSE LINES AND CHANNELIZING LINES SHALL BE EXTRUDED OR SPRAY THERMOPLASTIC. ALL PAVEMENT MARKING SYMBOLS AND LEGENDS SHALL BE 3M SERIES 380 TAPE OR APPROVED EQUIVALENT. THE TOWN TRAFFIC ENGINEER RESERVES THE RIGHT TO MODIFY THE PAVEMENT MARKING MATERIAL TO 3M SERIES 270 TAPE OR AN APPROVED EQUIVALENT AT THEIR SOLE DISCRETION.

11. ALL RAISED PAVEMENT MARKERS SHALL BE INSTALLED WITH CRAFCO PAVEMENT REFLECTOR ADHESIVE OR AN APPROVED EQUIVALENT.

12. ALL MEDIAN NOSES SHALL BE PAINTED PER MARICOPA COUNTY DEPARTMENT OF TRANSPORTATION (MCDOT) PAVEMENT MARKING MANUAL; STANDARD PAVEMENT MARKINGS, DRAWINGS 4-15 AND 4-16.

### PAVEMENT MARKING AND SIGNING NOTE PROVISIONS:

1. THE TOWN RESERVES THE RIGHT TO MODIFY THESE NOTES, TO REJECT ITEMS INCLUDED IN THE NOTES, OR TO ACCEPT ITEMS NOT INCLUDED IN THE NOTES, AT ANY TIME, WITHOUT PRIOR NOTICE, IF DETERMINED NECESSARY IN THE BEST INTERESTS OF THE TOWN.

2. PRODUCTS NOT COVERED BY THESE NOTES SHALL BE SUBMITTED TO THE TOWN TRAFFIC ENGINEERING DIVISION FOR REVIEW AND APPROVAL PRIOR TO ORDERING.

3. BRAND NAMES STATED MAY BE REGISTERED TRADEMARKS OF THEIR RESPECTIVE MANUFACTURERS.

Contact Arizona 811 at least two full working days before you begin excavation at least two full working days before you begin excavation at least two full working days before you begin excavation at least two full working days before you begin excavation at least two full working days before you begin excavation at least two full working days before you begin excavation at least two full working days before you begin excavation at least two full working days before you begin excavation at least two full working days before you begin excavation at least two full working days before you begin excavation at least two full working days before you begin excavation at least two full working days before you begin excavation at least two full working days before you begin excavation at least two full working days before you begin excavation at least two full working days before you begin excavation at least two full working days before you begin excavation at least two full working days at least two full working da



TOWN OF QUEEN CREEK



DESIGNED BY MH

POWER ROAD:
RIGGS ROAD TO CHANDLER HEIGHTS ROAD
ROADWAY AND DRAINAGE IMPROVEMENTS

Stantec Chandler, Arizona 85226 Tel. 480.687.6100 www.stantec.com

SIGNING AND STRIPING LEGEND

DRAWING NO. SG002 SHE

SHEET 65 OF 133

## ER ROAD: RIGGS ROAD TO CHANDLER HEIGHTS ROAD

		T			l -	<sup>1</sup>	SIGNING SI		<u> </u>			1				Ι	Γ
			WORK	Ι	OFF FR	OM	PAN	1	0.77			-	GRO	OUND MC		POLE MOUNT	
STA.	SIGN CODE	NEW	RELOCATE REMOVE & SALVAGE	SEE NOTES	Lt	P Rt (ft)	LEGEND		SIZE HEIGHT (in)	SHEETIN AREA H	NG TYPE (sq. ft.)	NO. POSTS	TYPE (	POSTS (length) U (ft)	FOUNDATIONS P (ea) U (ea)	TYPE.	NOTES
153+31	R3-5fP			Х			Right Lane (Plaque)										To Remain
153+31	R3-5R			Х			Mandatory Movement Lane Right										To Remain
153+48	R3-5fP			Х			Right Lane (Plaque)										To Remain
153+48	R3-5R			Х			Mandatory Movement Lane Right										To Remain
154+93	R3-17			X			Bicycle Lane Only (Symbol)										To Remain
155+07	R3-5fP			Х			Right Lane (Plaque)										To Remain
155+07	R3-5R			Х			Mandatory Movement Lane Right										To Remain
155+22	R3-5fP			Х			Right Lane (Plaque)										To Remain
155+22	R3-5R			Х			Mandatory Movement Lane Right										To Remain
155+60	W4-2R	X				4.5	Lane Ends	36	36	9.00		1.00	13.00		1.00		
156+61	R3-5fP	X		Х	13.3		Right Lane (Plaque)	30	12	2.50							Above R3-5R
156+61	R3-5R	X			13.3		Mandatory Movement Lane Right	30	36	7.50		1.00	13.00		1.00		
156+73	R3-5fP		X				Right Lane (Plaque)										
156+73	R3-5R		X				Mandatory Movement Lane Right										
157+28	R3-17	X		Х		4.5	Bicycle Lane Only (Symbol)	30	24	5.00						2	On Light Pole
159+52	S4-3P			Х			School										To Remain
159+52	R2-1-35			Х			Speed Limit 35										To Remain
159+52	S4-4P			Х			When Flashing										To Remain
161+64	R5-1			Х			Do Not Enter										To Remain
161+64	RX-X			Х			Except Buses										To Remain
161+95	R5-1			X			Do Not Enter										To Remain
161+95	RX-X			X			Except Buses										To Remain
161+96	R3-5fP			X			Right Lane (Plaque)										To Remain
161+96	R3-5R			Х			Mandatory Movement Lane Right										To Remain
163+28	R3-5fP	X		X		5.5	Right Lane (Plaque)	30	12	2.50						2	Above R3-5R, On Ligh Pole
163+28	R3-5R	X		X		5.5	Mandatory Movement Lane Right	30	36	7.50						2	On Light Pole
165+27	R3-5fP			Х			Right Lane (Plaque)										To Remain
165+27	R3-5R			X			Mandatory Movement Lane Right										To Remain
166+28	R3-17	X		X	4.5		Bicycle Lane Only (Symbol)	30	24	5.00						2	On Light Pole
166+28	R8-3	X		X	4.5		No Parking (Symbol)	30	30	6.25						2	On Light Pole
167+25	R3-5fP	X		X		10	Right Lane (Plaque)	30	12	2.50						2	Above R3-5R, On Ligh Pole
167+25	R3-5R	X		X		10	Mandatory Movement Lane Right	30	36	7.50						2	On Light Pole
167+68 ×××××			X * × × × × × × × × × × × × × × × × × × ×				Power Road  ***********************************										

55.25 | 0.00 | 2.00 | 26.00 |

0.0

2.00

14.0

SUB-TOTAL

H= HIGH INTENSITY PRISMATIC SHEETING

D= DIAMOND GRADE SHEETING

DESIGN SPEED= 55 MPH

P= PERFORATED POSTS

U= U-CHANNEL POST

C= BAND-TYPE CLAMP







POWER ROAD:
RIGGS ROAD TO CHANDLER HEIGHTS ROAD
ROADWAY AND DRAINAGE IMPROVEMENTS

**Stantec** 

3133 West Frye Road Chandler, Arizona 85226 Tel. 480.687.6100 www.stantec.com

SIGNING SUMMARY DESIGNED BY MH CIP PROJ NO. A1405 DRAWN BY BE

> SG003 DRAWING NO.

SHEET 66 OF 133

# SIGNAL SHEETS NSITY PRISMATIC SHEETING GRADE SHEETING :D= \_\_55 MPH IED POSTS EL POST PE CLAMP TOWN OF QUEEN CREEK POWER ROAD: RIGGS ROAD TO CHANDLER HEIGHTS ROAD ROADWAY AND DRAINAGE IMPROVEMENTS RIGGS ROAD TO CHANDLER HEIGHTS ROAD ROADWAY AND DRAINAGE IMPROVEMENTS 1338 West Frye Road Chandle A streem 9 67014

								SIGNING S	<u>UMM</u>	<u>ARY</u>									
			,	WORK			SET	PAN	EL					GRO	DUND MOUNT	Γ		POLE	
	SIGN			TING			OM P	LEOEND		N SIZE		NG TYPE	<u> </u>		POSTS			MOUNT	NOTES
STA.	CODE	NEW	RELOCATE	REMOVE & SALVAGE	SEE NOTES	Lt (ft)	Rt (ft)	LEGEND	WIDTH (in)	HEIGHT (in)	AREA H	(sq. π.)	NO.	TYPE (P)		OUNDAT (ea)		TYPE. C (ea)	
167+68	R10-6			Х				Stop Here On Red (With Oblique	+					( )	J (13)		, ,		
167+68	RX-X			X				Arrow) Private Road											
170+26	S4-3P		X		X	3.7		School											Relocate Existing
170+26			X		X	3.7		Speed Limit 35											Relocate Existing
170+26	S4-4P		X		X	3.7		When Flashing											Relocate Existing
170+78					X	3.7		Right Lane (Plaque)											To Remain
170+78	R3-5R							Mandatory Movement Lane											To Remain
					^ 			Right											
172+05	R1-1	X				<i>1</i> E		Stop School Sign	36	36		9.00						2	To Remain On Light Pole
172+15	S1-1					4.5				1								2	On Light Pole On Light Pole
172+15	S4-3P	X		V	X	4.5		School Sign	36	12		3.00						2	On Light Pole
172+36	S1-1			^				School Sign											
172+36	S4-3P			X				School										_	Above R3-5R, On Ligh
173+35	R3-5fP	X			X		5.6	Right Lane (Plaque)	30	12	2.50							2	Pole
173+35	R3-5R	X			Χ		5.6	Mandatory Movement Lane Right	30	36	7.50							2	On Light Pole
175+57	R1-1				Χ			Stop											To Remain
177+10	R3-9b	X			Χ	4.5		Two-Way Left Turn Only	24	36	6.00							2	On Light Pole
178+38	W11-7	X			X		4.4	Equestrian	36	36	9.00							2	On Light Pole
179+60	R3-17	X			Χ	4.5		Bicycle Lane Only (Symbol)	30	24	5.00							2	On Light Pole
179+60	R8-3	X			Χ	4.5		No Parking (Symbol)	30	30	6.25							2	On Light Pole
180+05	OM3-R			Х				Type 3 Object Marker Right											
180+96	RX-X2*	X			Χ			Flashing Hand Stop Do Not Enter	36	36	9.00							2	Custom Sign, On Traffi
181+15	OM1-3			X				Crosswalk Object Marker											Signal Pole
181+21	D3-1			X				Power Road											
181+21	D3-1			X				Cloud Road											
181+21	R1-1			Х				Stop											
181+34	OMX-X			Х				Object Marker											
181+34	OMX-X			Х				Object Marker											
181+35	M-2			Х				Type 2 Object Marker											
181+35	OMX-X			Х				Object Marker											
181+35	OMX-X			Х				Object Marker											
181+70	D3-1			X				Power Road											
181+70	R1-1			Х				Stop											
181+70	OM1-3			X				Object Marker											
181+70	OM1-3			X				Object Marker											

45.25 | 12.00 | 0.00

0.00

0.00

0.00

0.00

18.00

SUB-TOTAL

\*SEE TRAFFIC SIGNAL SHEETS

H= HIGH INTENSITY PRISMATIC SHEETING D= DIAMOND GRADE SHEETING

DESIGN SPEED= <u>55 MPH</u>

P= PERFORATED POSTS

U= U-CHANNEL POST

C= BAND-TYPE CLAMP



**Stantec** 

SIGNING SUMMARY

DESIGNED BY MH CIP PROJ NO. A1405 DRAWN BY

> SG004 DRAWING NO.

SHEET 67 OF 133

3133 West Frye Road Chandler, Arizona 85226 Tel. 480.687.6100 www.stantec.com

### ROAD TO CHANDLER HEIGHTS ROAD

SIGNING S	SUMMARY
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			Ι	VORK	Ī	FR	SET OM	PANE	Γ	0.177			-	GRC	OUND MO	UNT		POLE MOUNT	
	SIGN		EXIST	REMOVE & SEE Lt Rt (ft) Flas  X  X  Flas	LEGEND	SIGN WIDTH		SHEETIN AREA		NO.	TYPE (	POSTS length)	FOLIND	ATIONS	TYPE.	NOTES			
STA.	CODE	NEW	RELOCATE	SALVAGE		(ft)			(in)	(in)	Н	D	POSTS		U (ft)	P (ea)	U (ea)	C (ea)	
181+73	RX-X2*	X						Flashing Hand Stop Do Not Enter Crosswalk	36	36	9.00							2	Custom Sign, On Traff Signal Pole
181+75	RX-X2*	X			X			Flashing Hand Stop Do Not Enter Crosswalk	36	36	9.00							2	Custom Sign, On Traf Signal Pole
l81+75	RX-X2*	X			X			Flashing Hand Stop Do Not Enter Crosswalk	36	36	9.00							2	Custom Sign, On Traf Signal Pole
L83+35	R3-17	X			X		4.4	Bicycle Lane Only (Symbol)	30	24	5.00							2	On Light Pole
.83+35	R8-3	X			X		4.4	No Parking (Symbol)	30	30	6.25							2	On Light Pole
L84+55	W11-7	X			X	4.5		Equestrian	36	36	9.00							2	On Light Pole
.85+85	R2-1-45	X			X		4.4	Speed Limit 45	30	36	7.50							2	On Light Pole
.86+45	R2-1-45			X				Speed Limit 45											
L92+09	R2-1-45	X			X	4.4		Speed Limit 45	30	36	7.50							2	On Light Pole
.93+35	R3-9b	X			X		4.4	Two-Way Left Turn Only	24	36	6.00							2	On Light Pole
.94+58	R3-17	X			X	4.4		Bicycle Lane Only (Symbol)	30	24	5.00							2	On Light Pole
.94+58	R8-3	X			Х	4.4		No Parking (Symbol)	30	30	6.25							2	On Light Pole
196+19	R1-1				Х			Stop											To Remain
.96+80	RX-X			Х				Bike Lane Ends											
.99+23	R1-1				Х			Stop											To Remain
.99+72	R3-5R				Х			Mandatory Movement Lane Right											To Remain
.00+55	R3-5fp				X			Right Lane (Plaque)											To Remain
200+55	R3-5R				Х			Mandatory Movement Lane Right											To Remain
01+70	R1-1				X			Stop											To Remain
202+30	R3-5R				Х			Mandatory Movement Lane Right											To Remain
202+29	R3-17	X			X		14	Bicycle Lane Only (Symbol)	30	24	5.00							2	On Light Pole
202+29	R8-3	X			X		14	No Parking (Symbol)	30	30	6.25							2	On Light Pole
04+00	R3-5fp				X			Right Lane (Plaque)											To Remain
204+00	R3-5R				Х			Mandatory Movement Lane Right											To Remain
204+21	R4-7				X			Keep Right (Symbol)											To Remain
04+21	OM3-L				X			Type 3 Object Marker Left											To Remain
04+34	R2-1-45				X			Speed Limit 45											To Remain
04+34	R4-4				X			Begin Right Turn Yield To Bikes											To Remain
04+78	R1-1				X			Stop											To Remain
05+37	R3-5R				X			Mandatory Movement Lane Right											To Remain
07+31	R4-4				Х			Begin Right Turn Yield To Bikes											To Remain
207+53	W9-101L				X			Thru Traffic Merge Left											To Remain
07+79	R4-7				Х			Keep Right (Symbol)											To Remain
207+79	OM3-L				X			Type 3 Object Marker Left											To Remain
											90.75	0.00	0.00	0.0	0.0	0.0	0.0	26.0	SUB-TOTAL
$\not\longleftrightarrow\!$										XXXXX	191.25	12.00	2.00	26.00	0.00	2.00	0.00	58.00	TOTAL (A1405)

H= HIGH INTENSITY PRISMATIC SHEETING

D= DIAMOND GRADE SHEETING

DESIGN SPEED= 55 MPH

P= PERFORATED POSTS

U= U-CHANNEL POST

C= BAND-TYPE CLAMP

\*= FOR CUSTOM SIGN ON TRAFFIC SIGNAL POLE, SEE DRAWING NO. TS004 FOR DETAILS.







POWER ROAD:
RIGGS ROAD TO CHANDLER HEIGHTS ROAD
ROADWAY AND DRAINAGE IMPROVEMENTS

Stantec

SIGNING SUMMARY

DESIGNED BY MH
DRAWN BY BE


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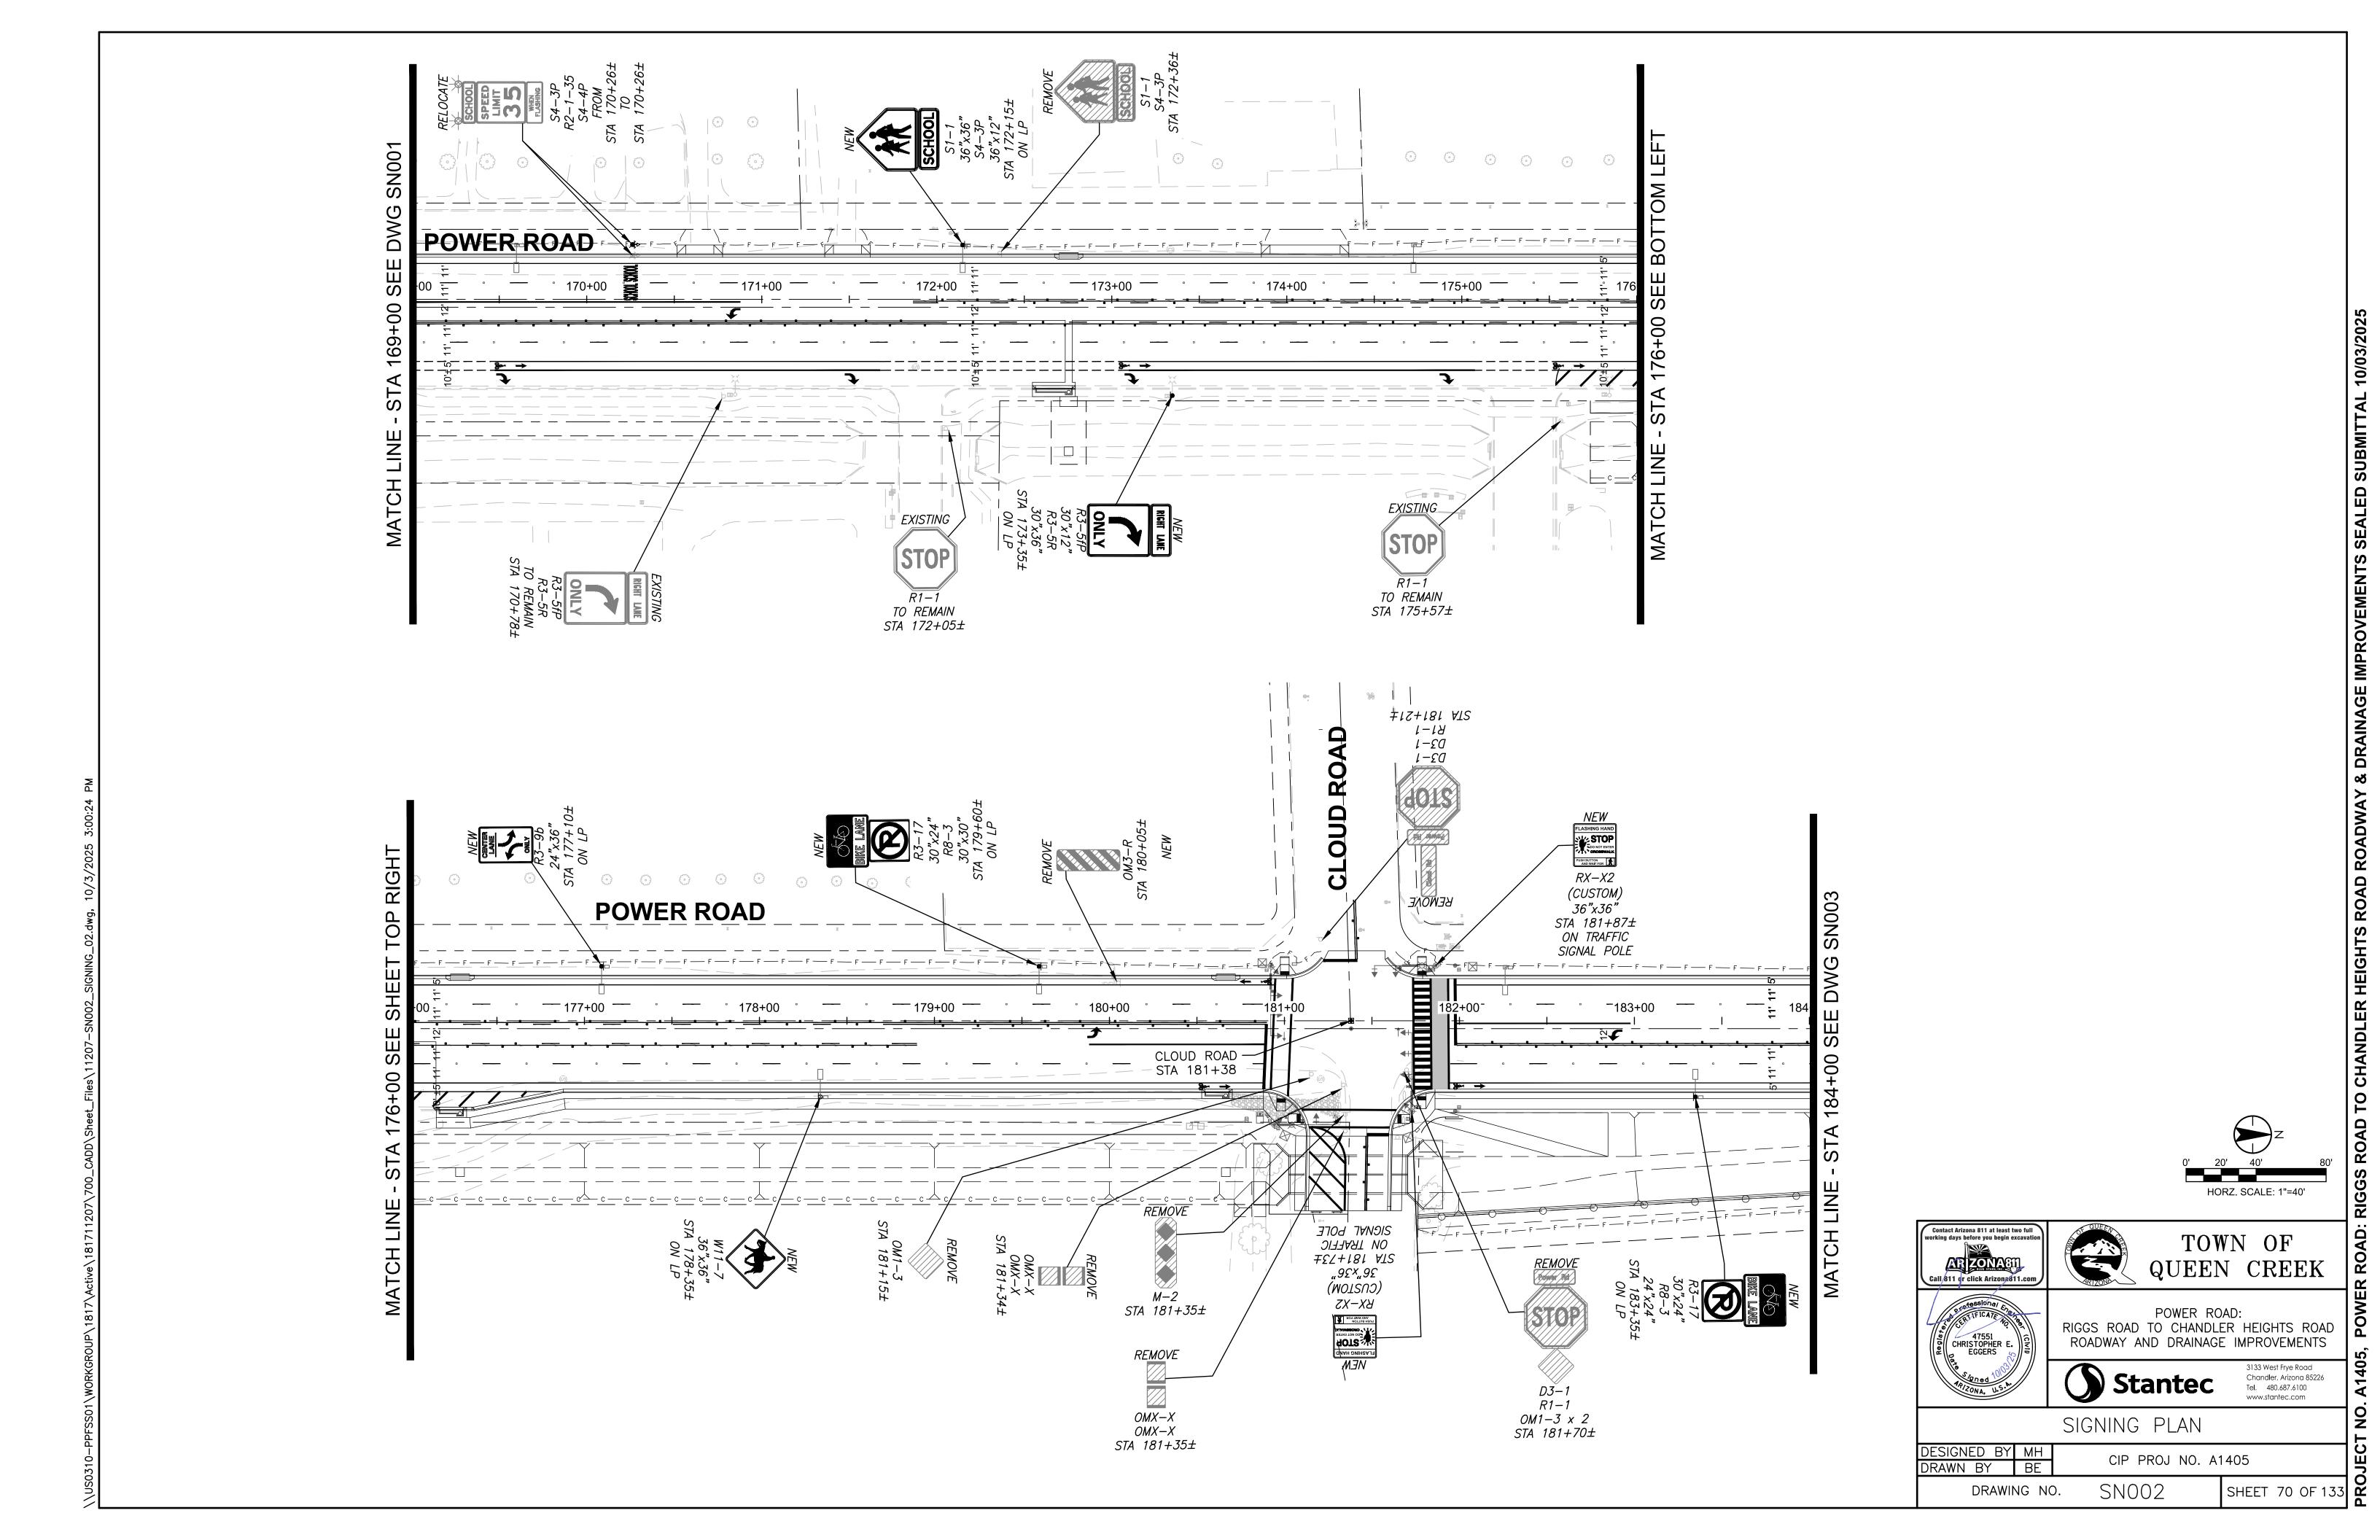
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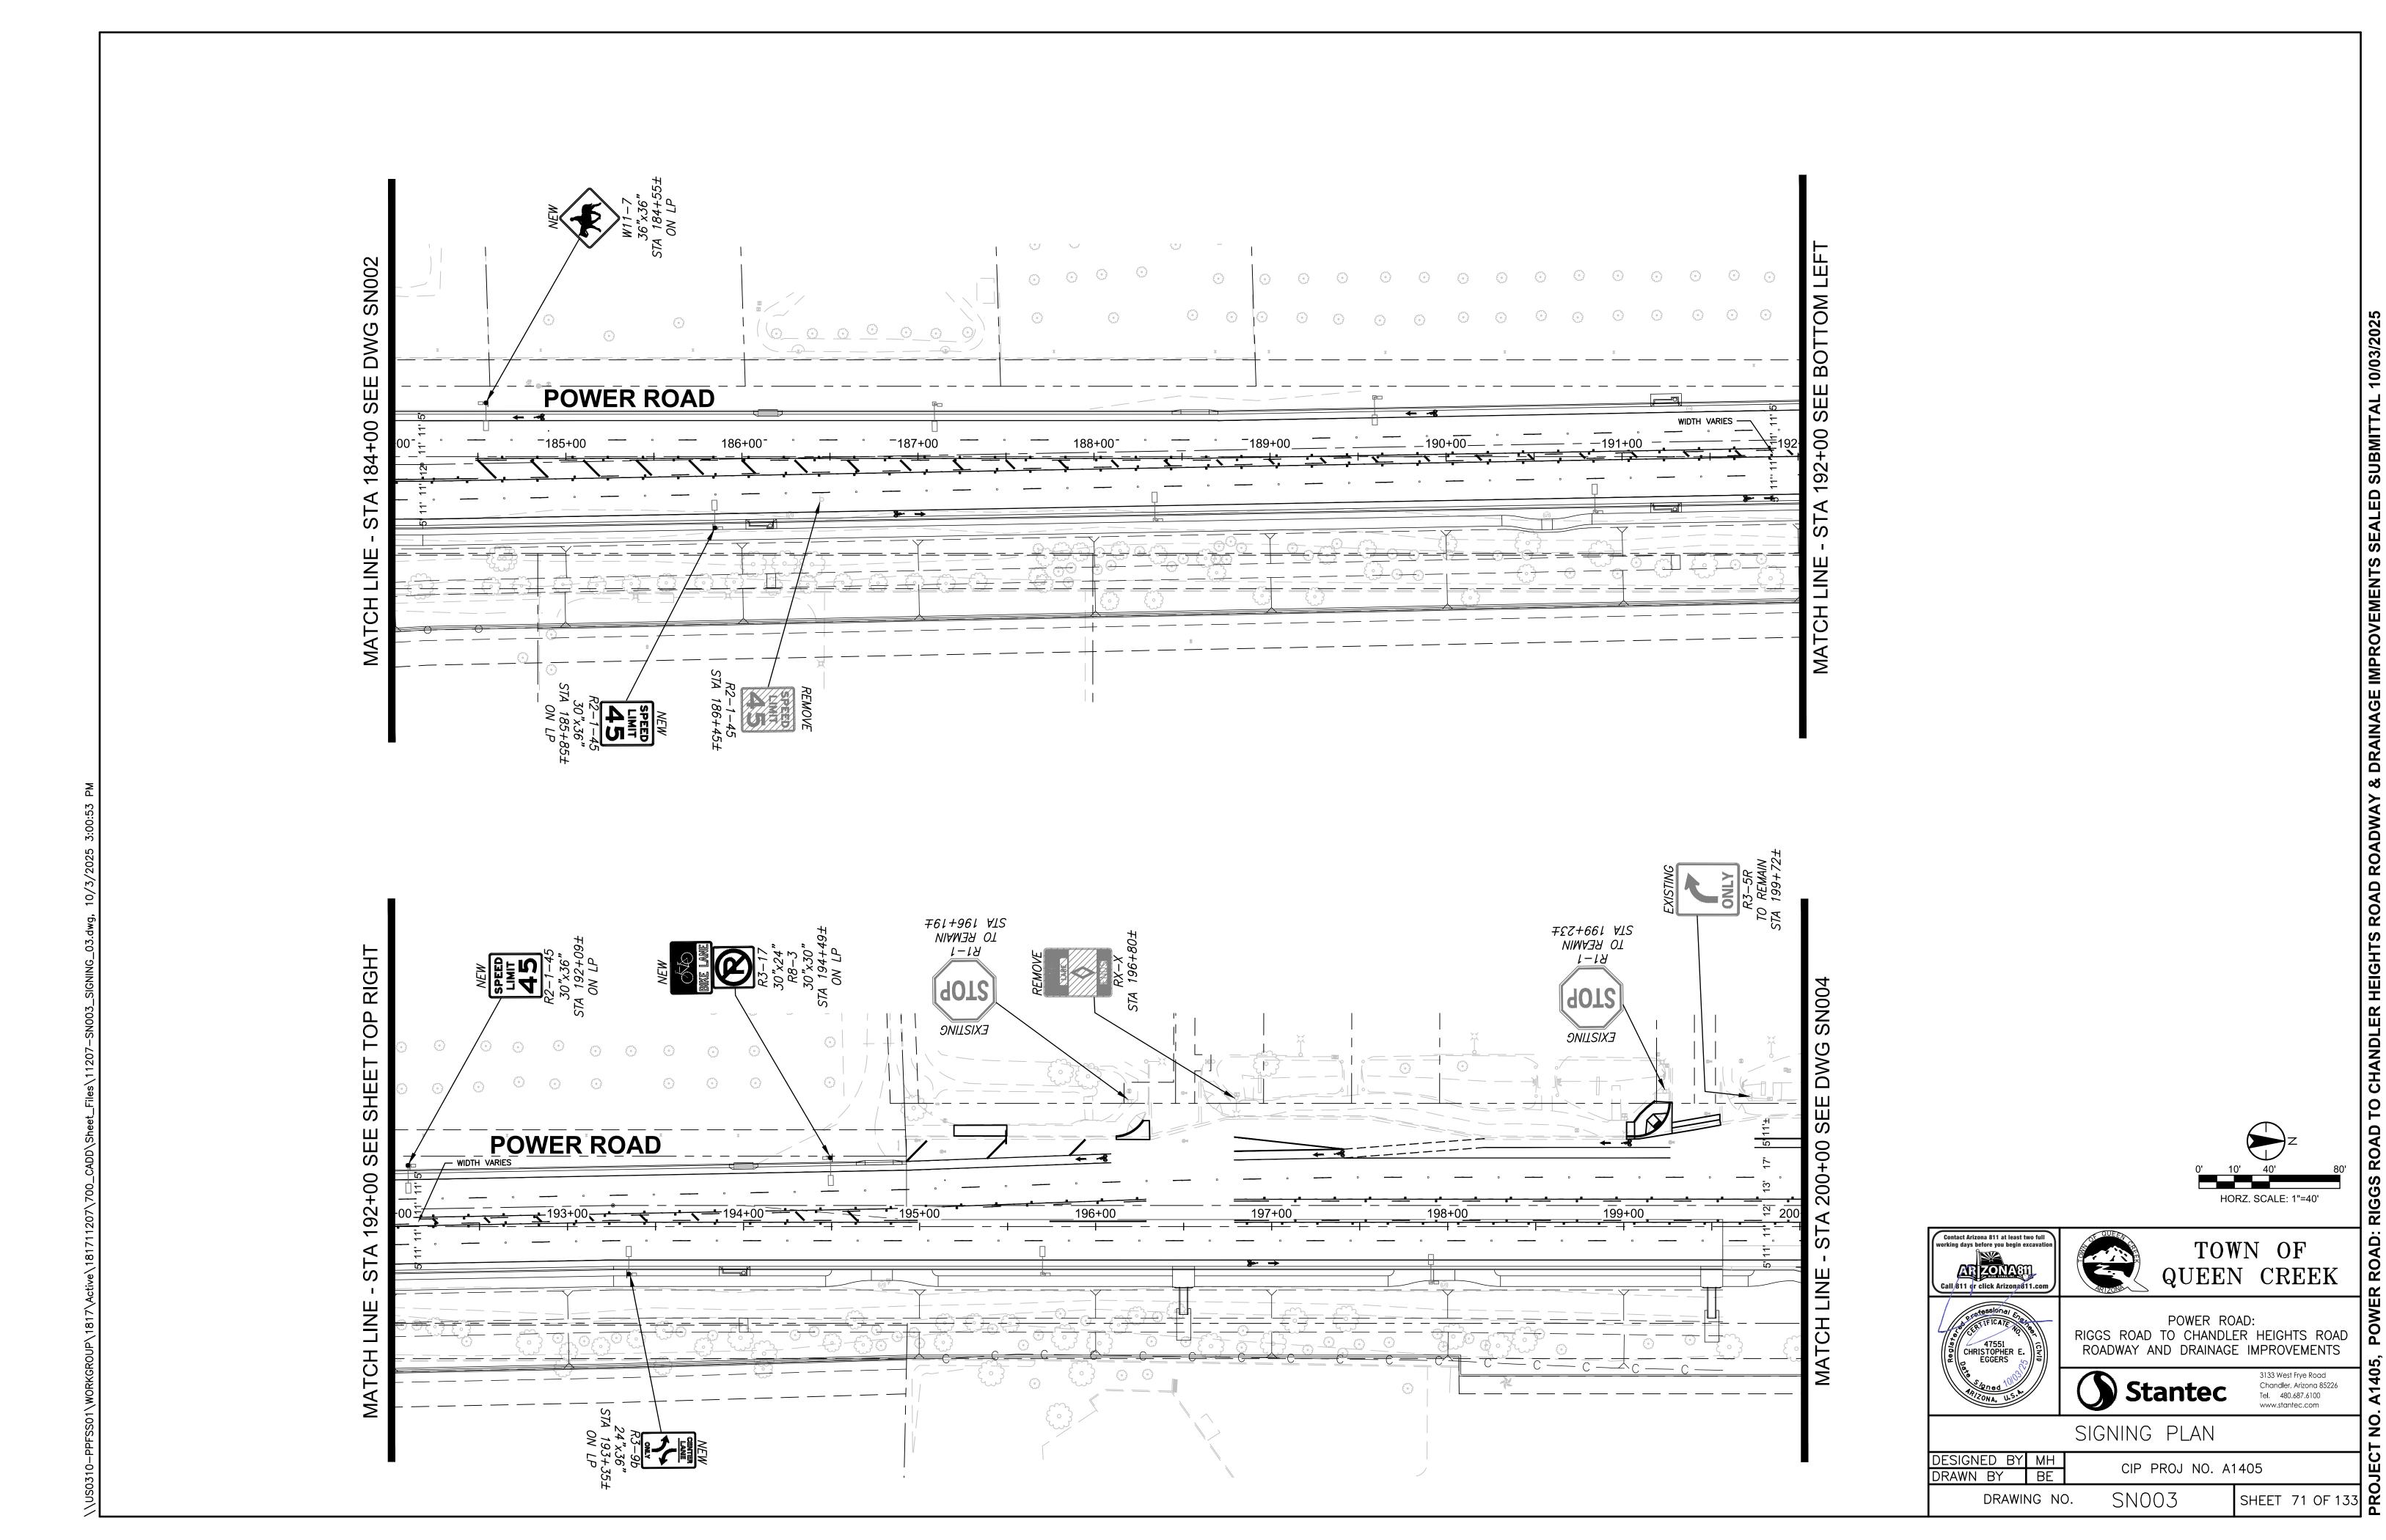
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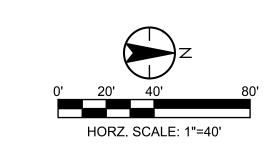
SHEET 68 OF 133

3133 West Frye Road Chandler, Arizona 85226 Tel. 480.687.6100 www.stantec.com







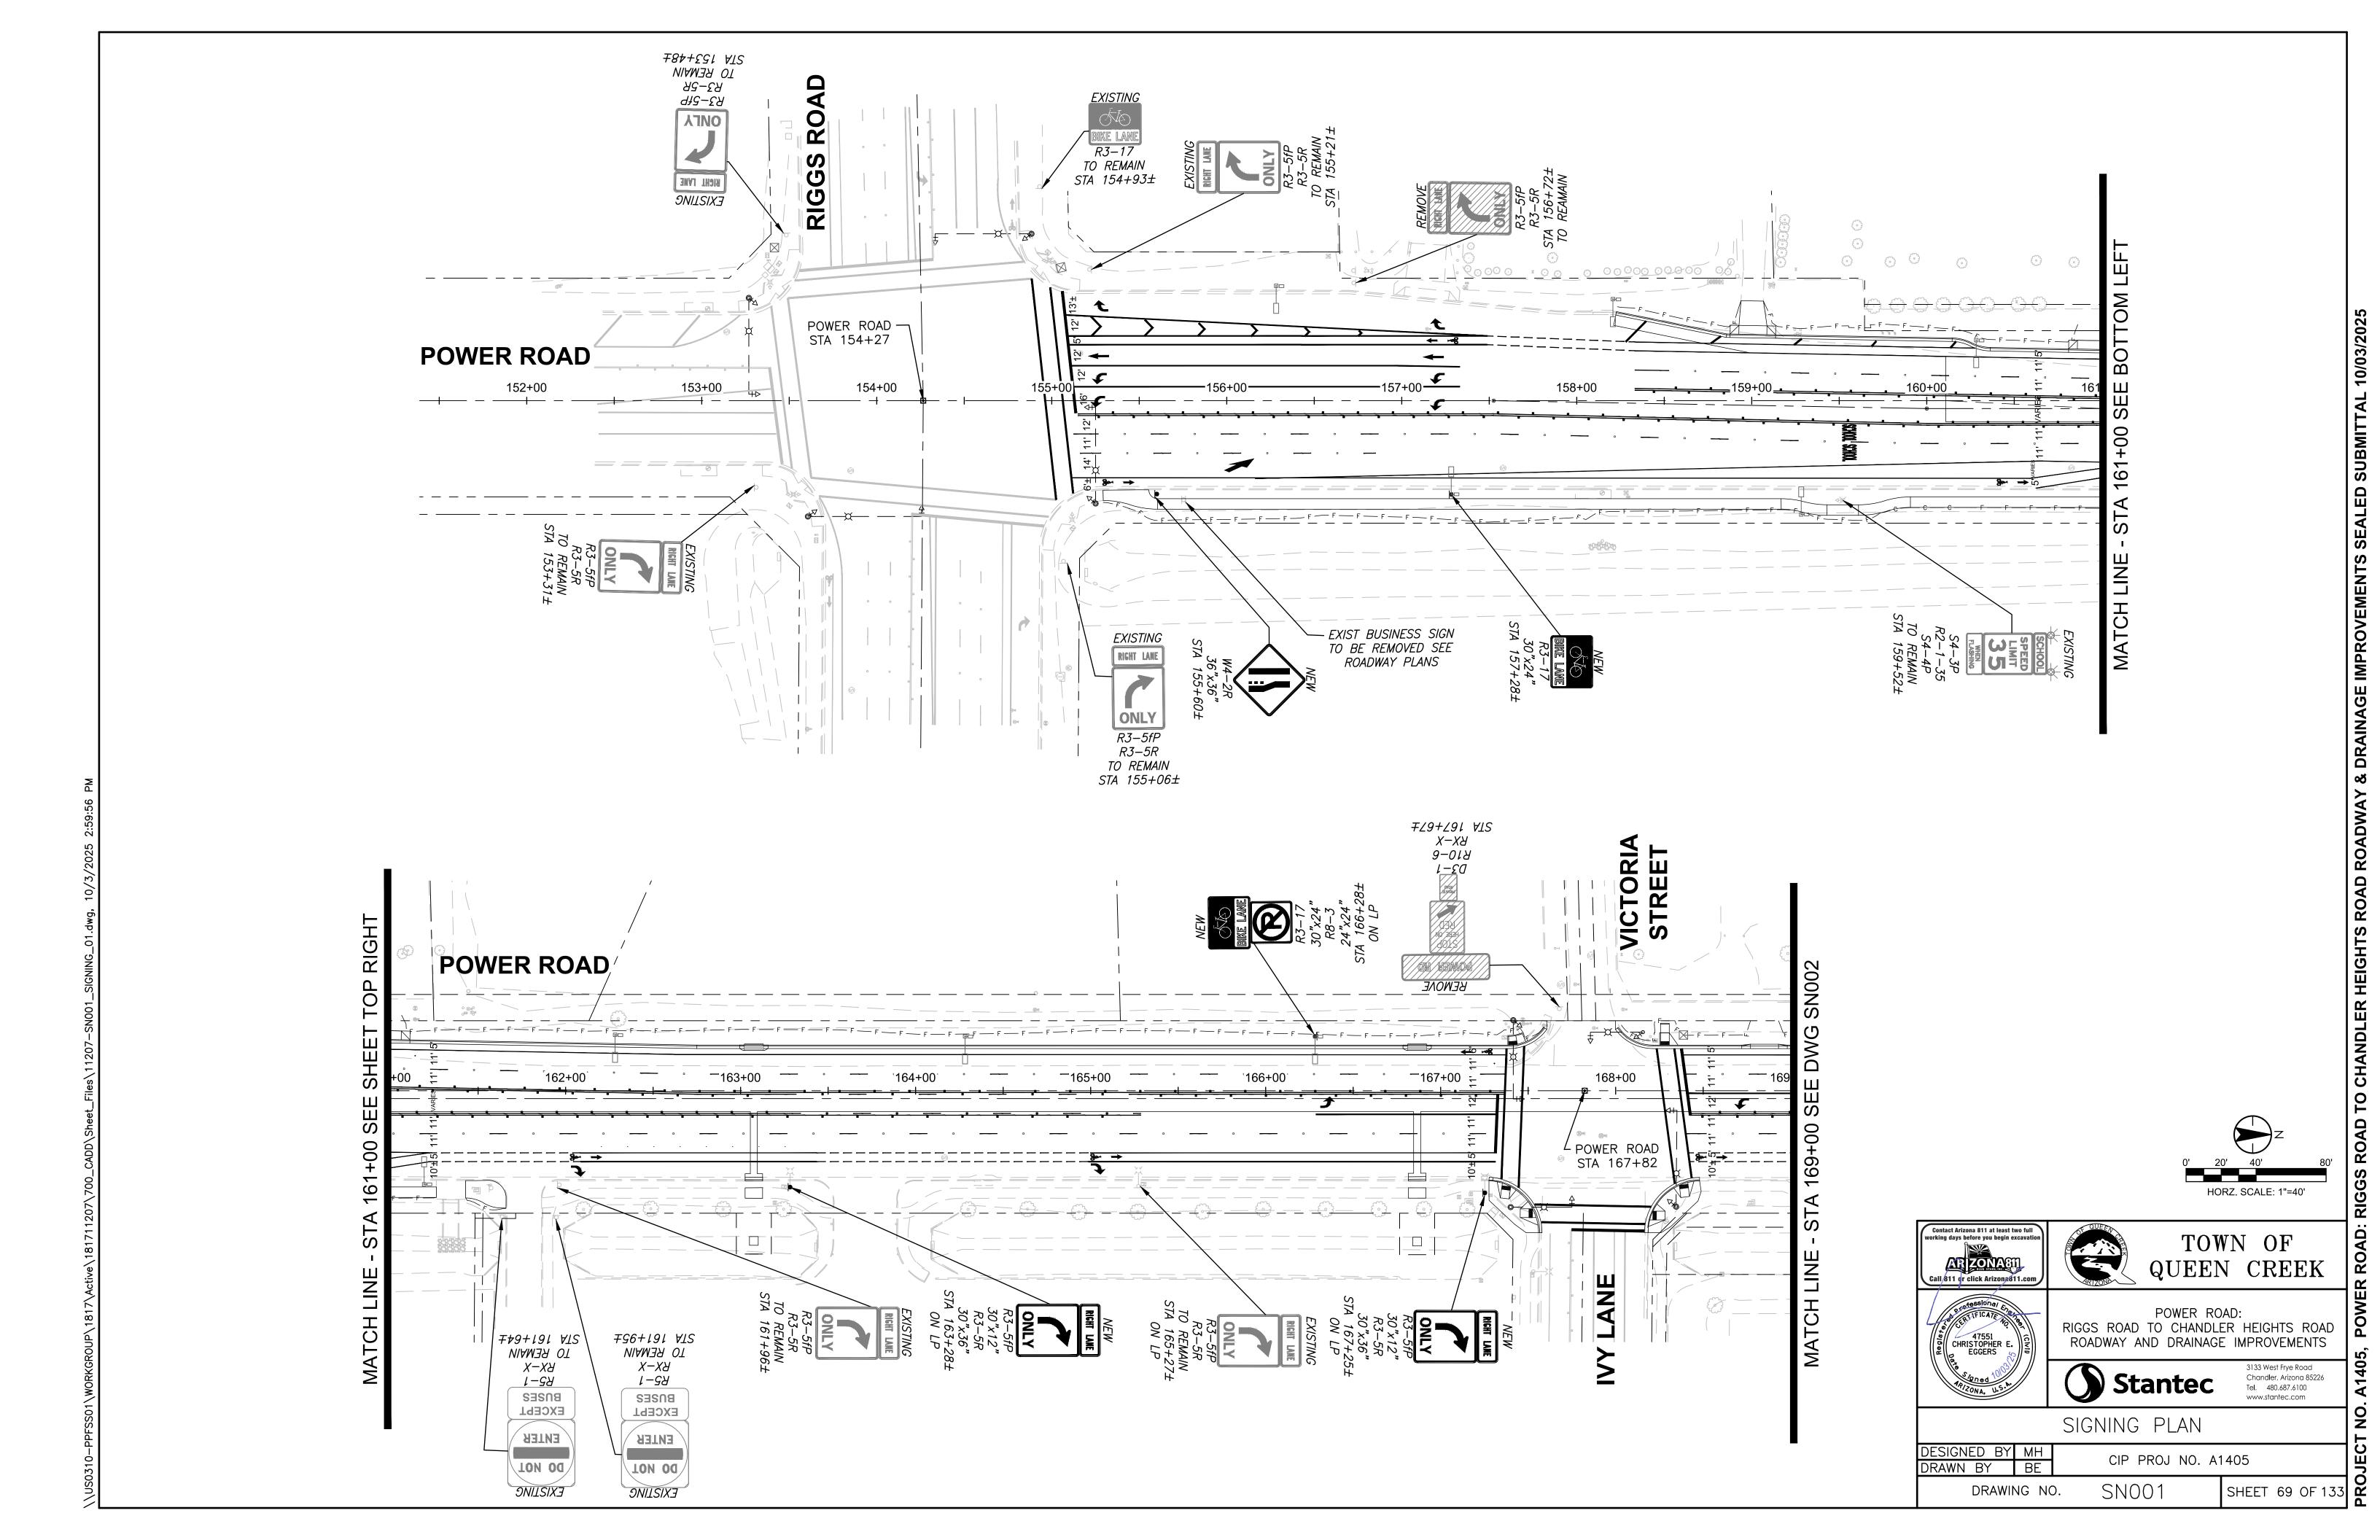

RIGGS ROAD TO CHANDLER HEIGHTS ROAD




POWER ROAD:
RIGGS ROAD TO CHANDLER HEIGHTS ROAD
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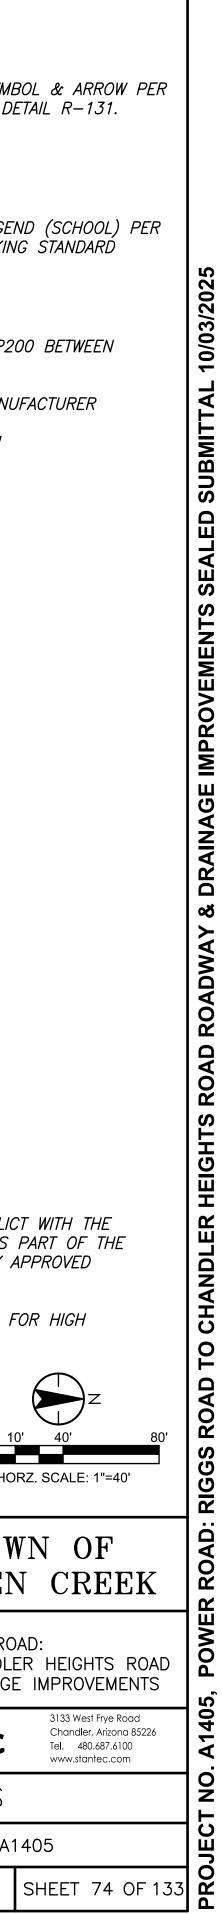
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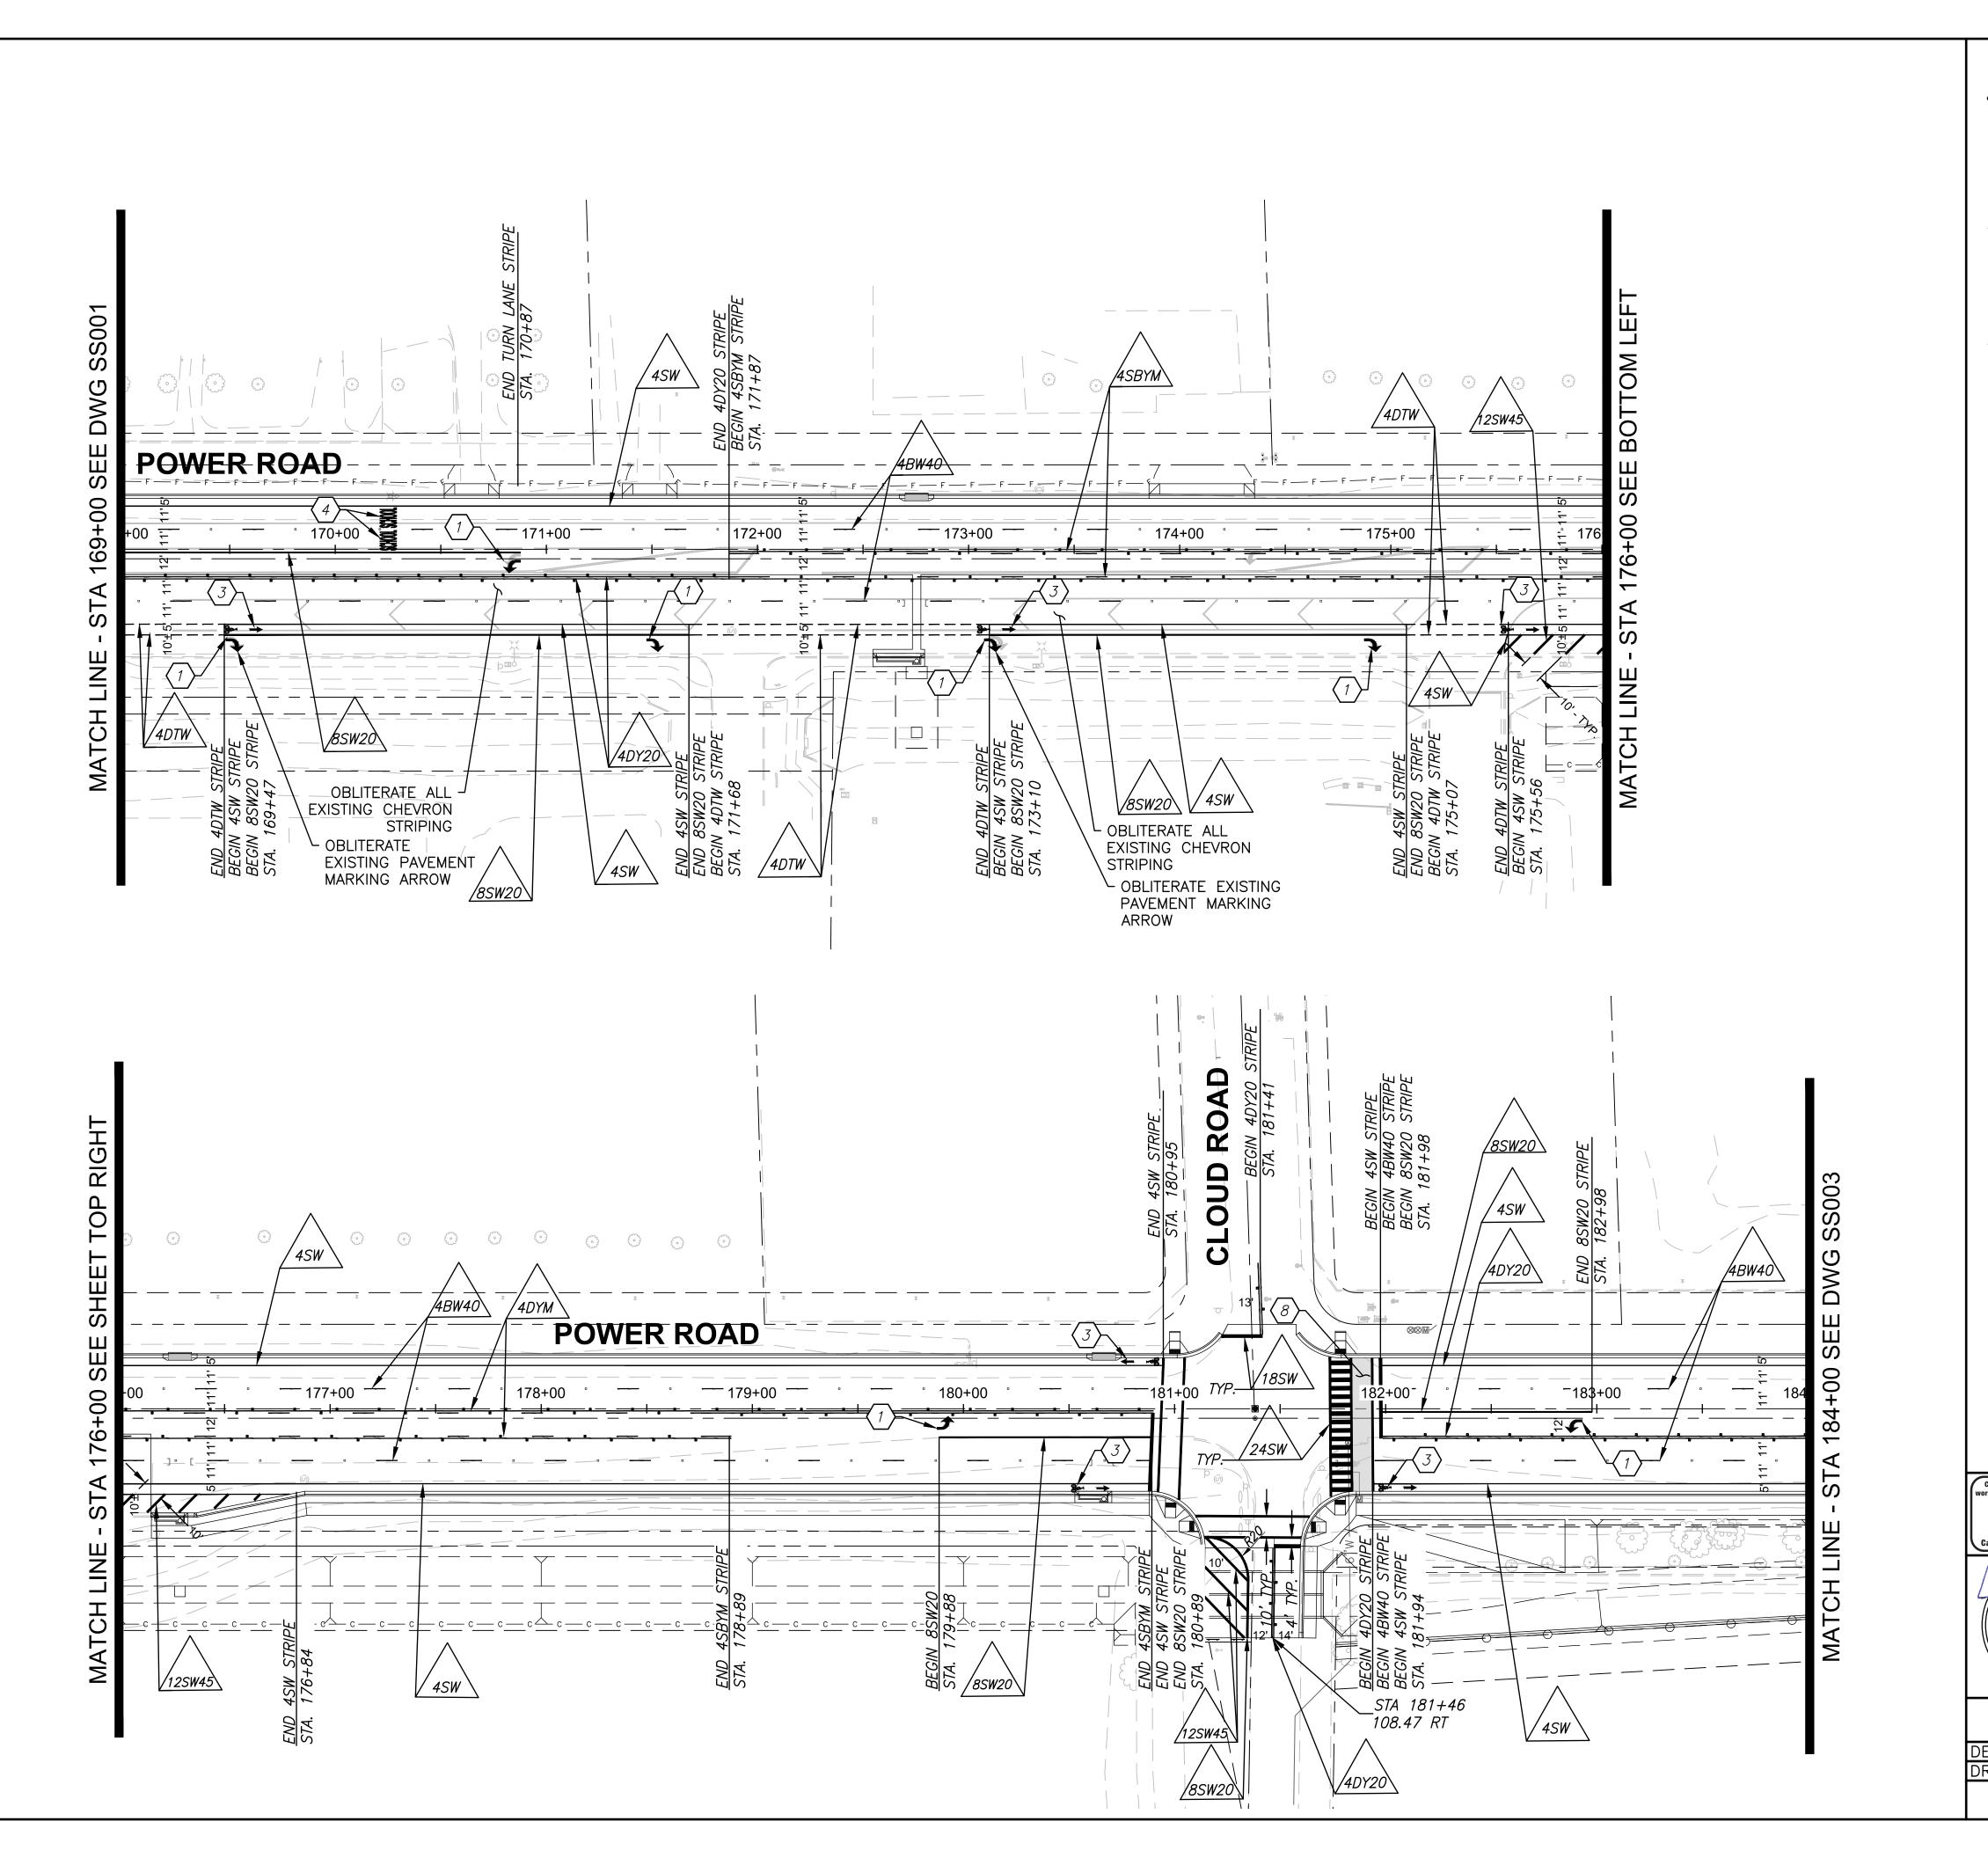
SN004 DRAWING NO.

SHEET 72 OF 133



SUBMITTAL SEALED : & DRAINAGE IMPROVEMENTS ROADWAY CHANDLER HEIGHTS



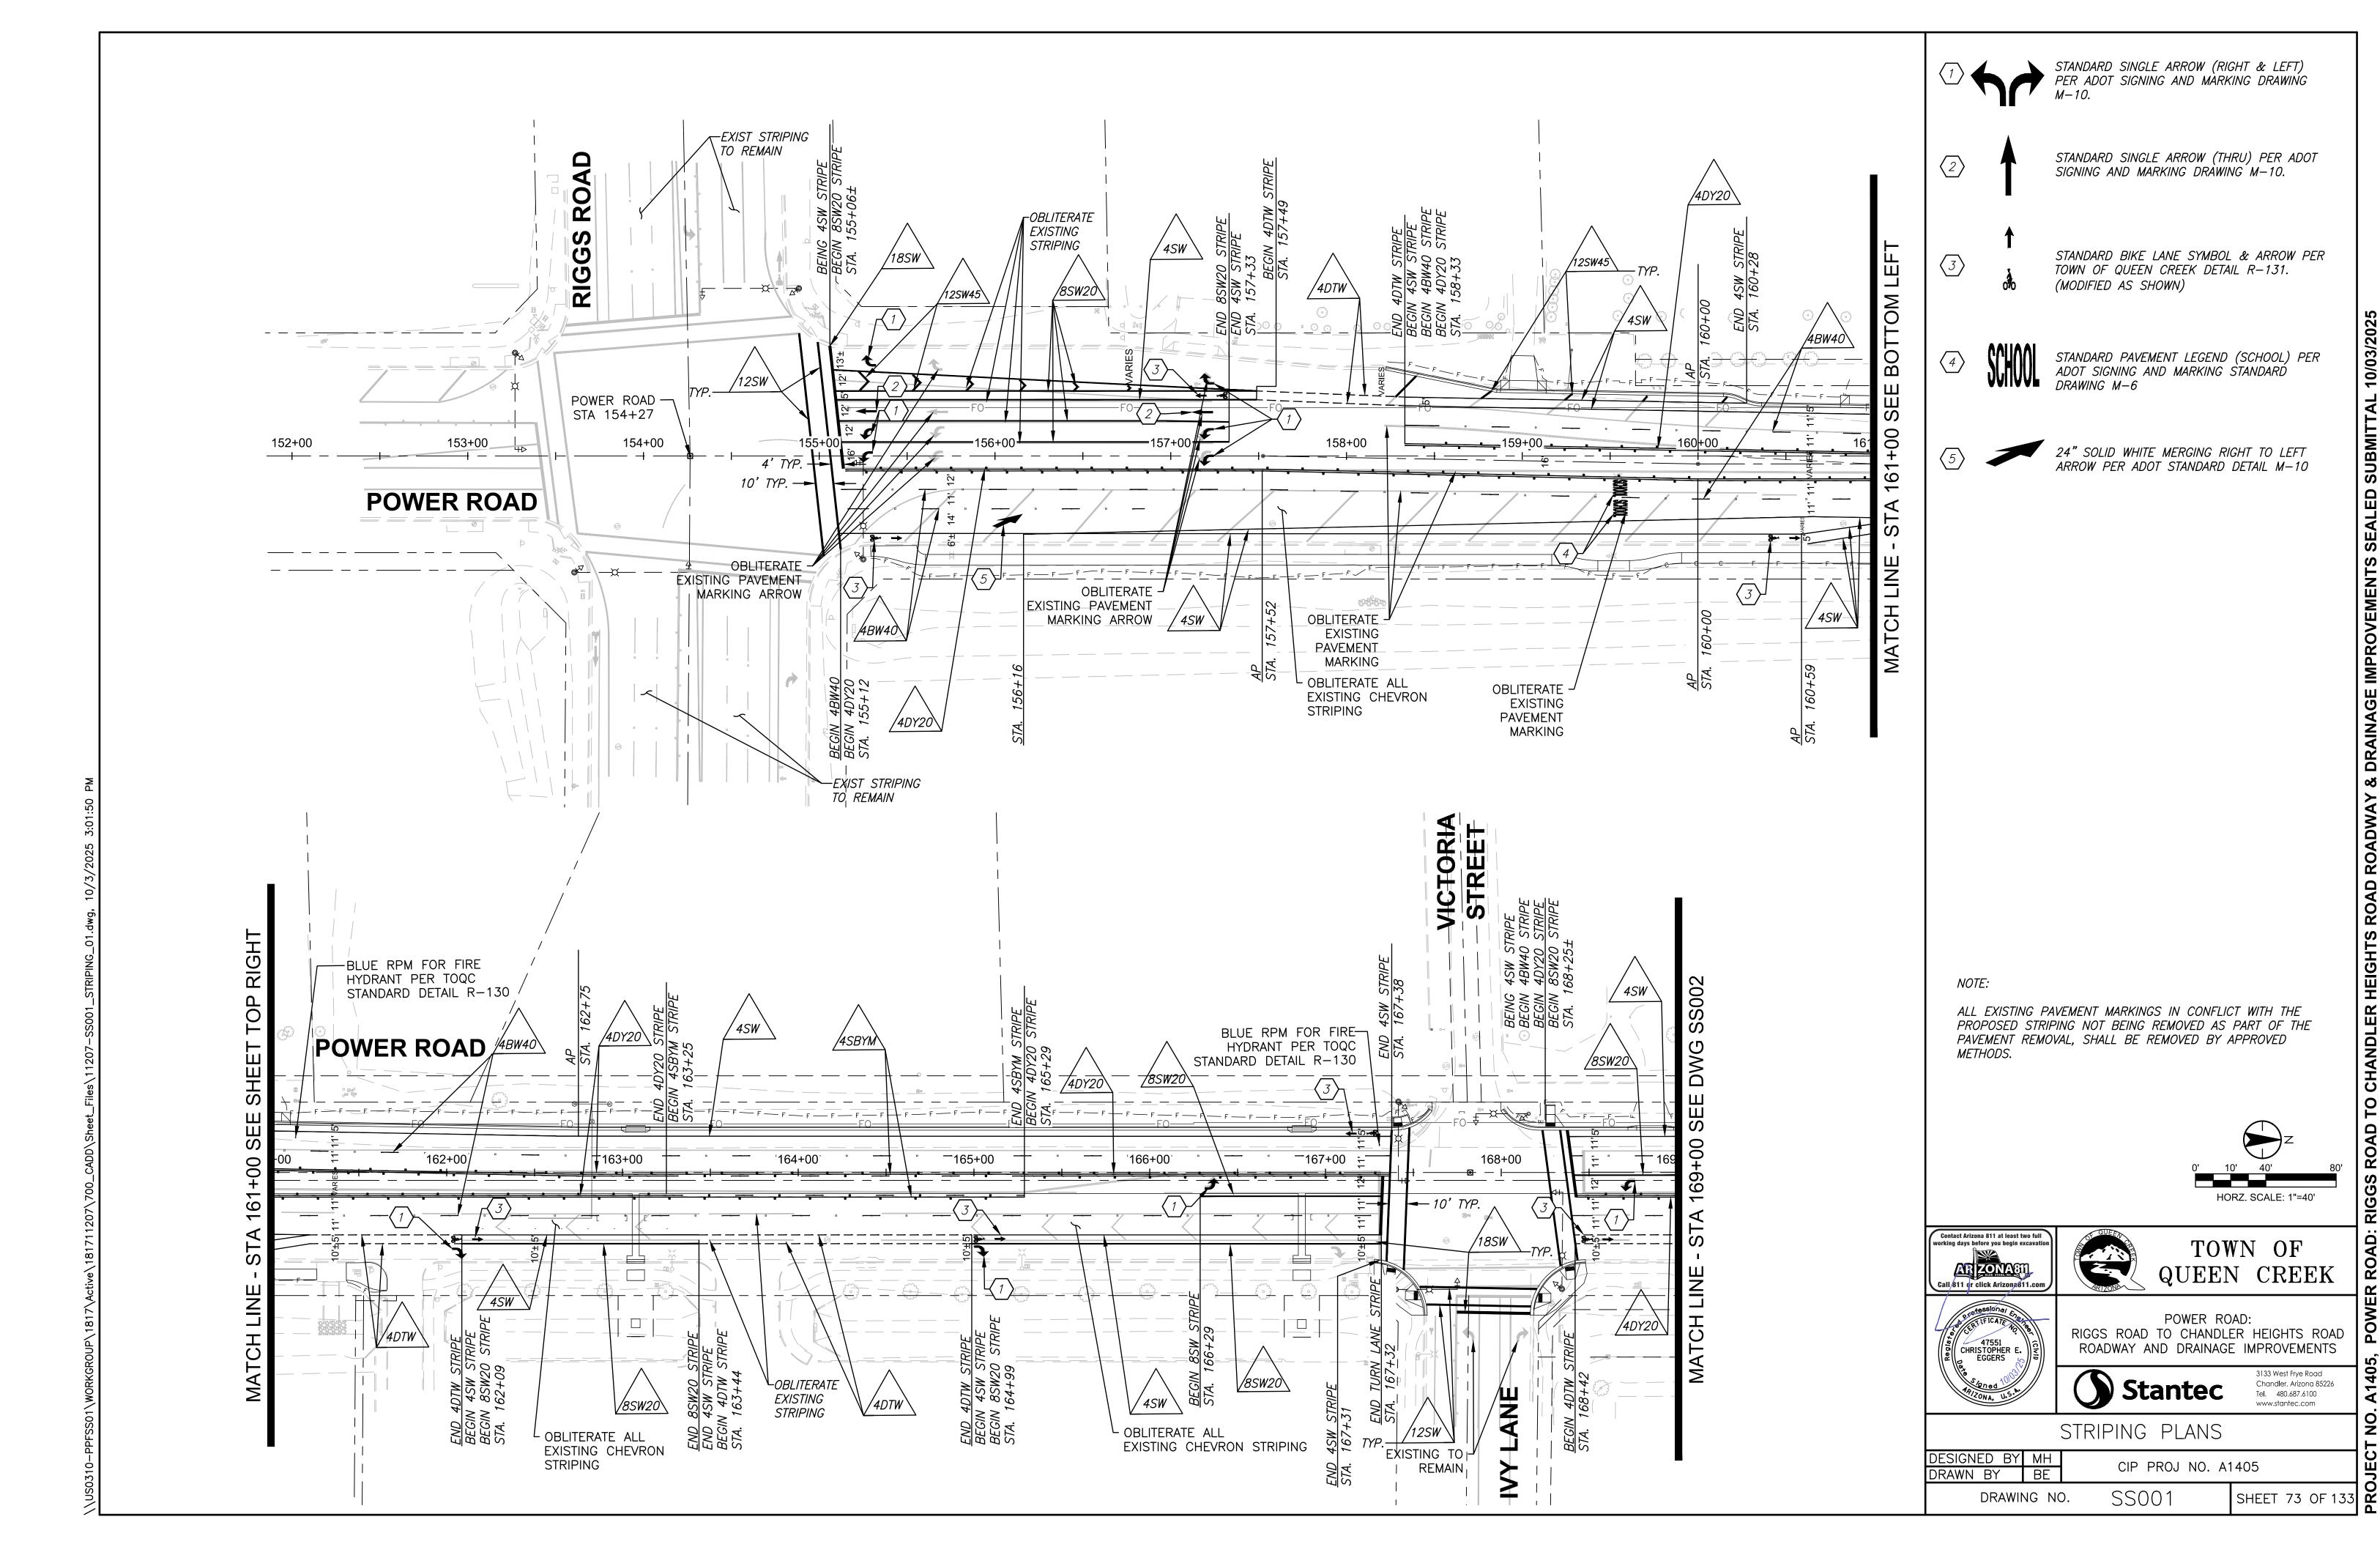



STANDARD SINGLE ARROW (RIGHT & LEFT) PER ADOT SIGNING AND MARKING DRAWING M-10.



STANDARD BIKE LANE SYMBOL & ARROW PER TOWN OF QUEEN CREEK DETAIL R-131. (MODIFIED AS SHOWN)




STANDARD PAVEMENT LEGEND (SCHOOL) PER ADOT SIGNING AND MARKING STANDARD DRAWING M-6

APPLY DECOCOAT POLYMER SYSTEM DP200 BETWEEN CROSSWALK LINES. COLOR: TERRA-COTTA THICKNESS: 5 LAYER MINIMUM PER MANUFACTURER APPLICATION REQUIREMENTS. SUPPLIER: WWW.DECOCOATSYSTEMS.COM

NOTE:

ALL EXISTING PAVEMENT MARKINGS IN CONFLICT WITH THE PROPOSED STRIPING NOT BEING REMOVED AS PART OF THE PAVEMENT REMOVAL, SHALL BE REMOVED BY APPROVED METHODS.

SEE TOWN OF QUEEN CREEK DETAIL PM-10 FOR HIGH VISIBILITY CROSSWALK DIMENSIONS.

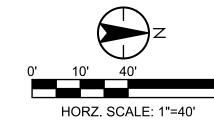



TOWN OF QUEEN CREEK




POWER ROAD: RIGGS ROAD TO CHANDLER HEIGHTS ROAD ROADWAY AND DRAINAGE IMPROVEMENTS


Stantec


STRIPING PLANS


DESIGNED BY MH CIP PROJ NO. A1405 DRAWN BY

> SS002 DRAWING NO.

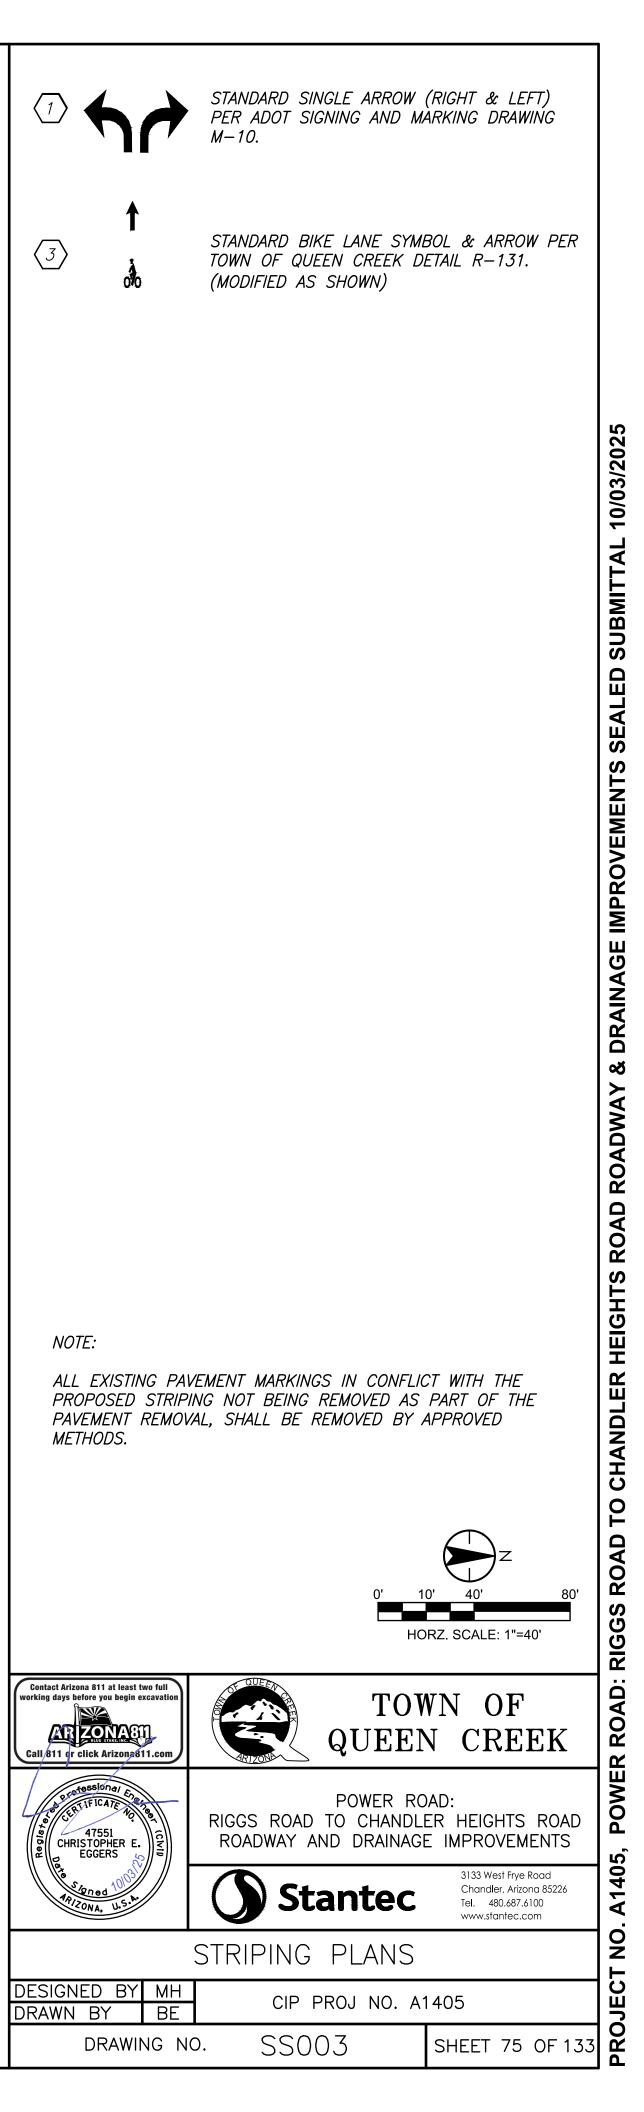


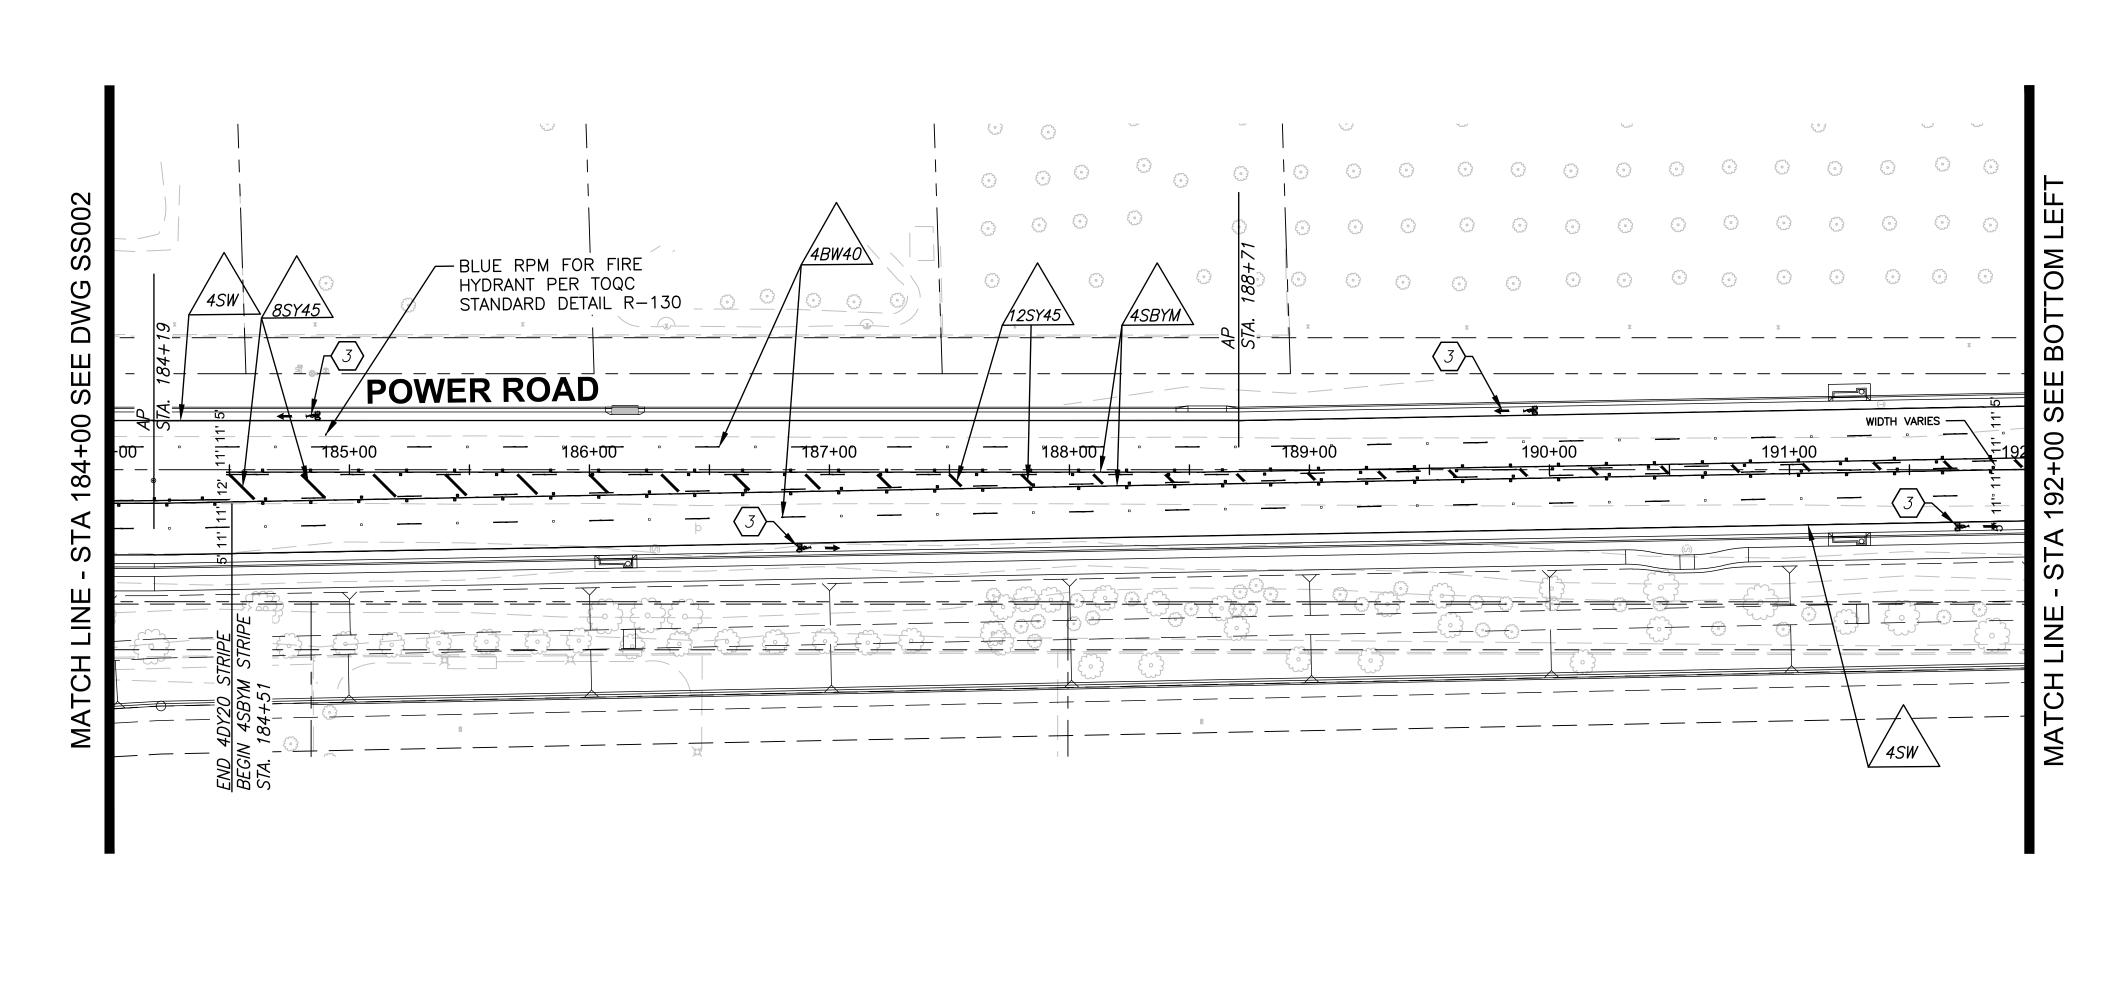

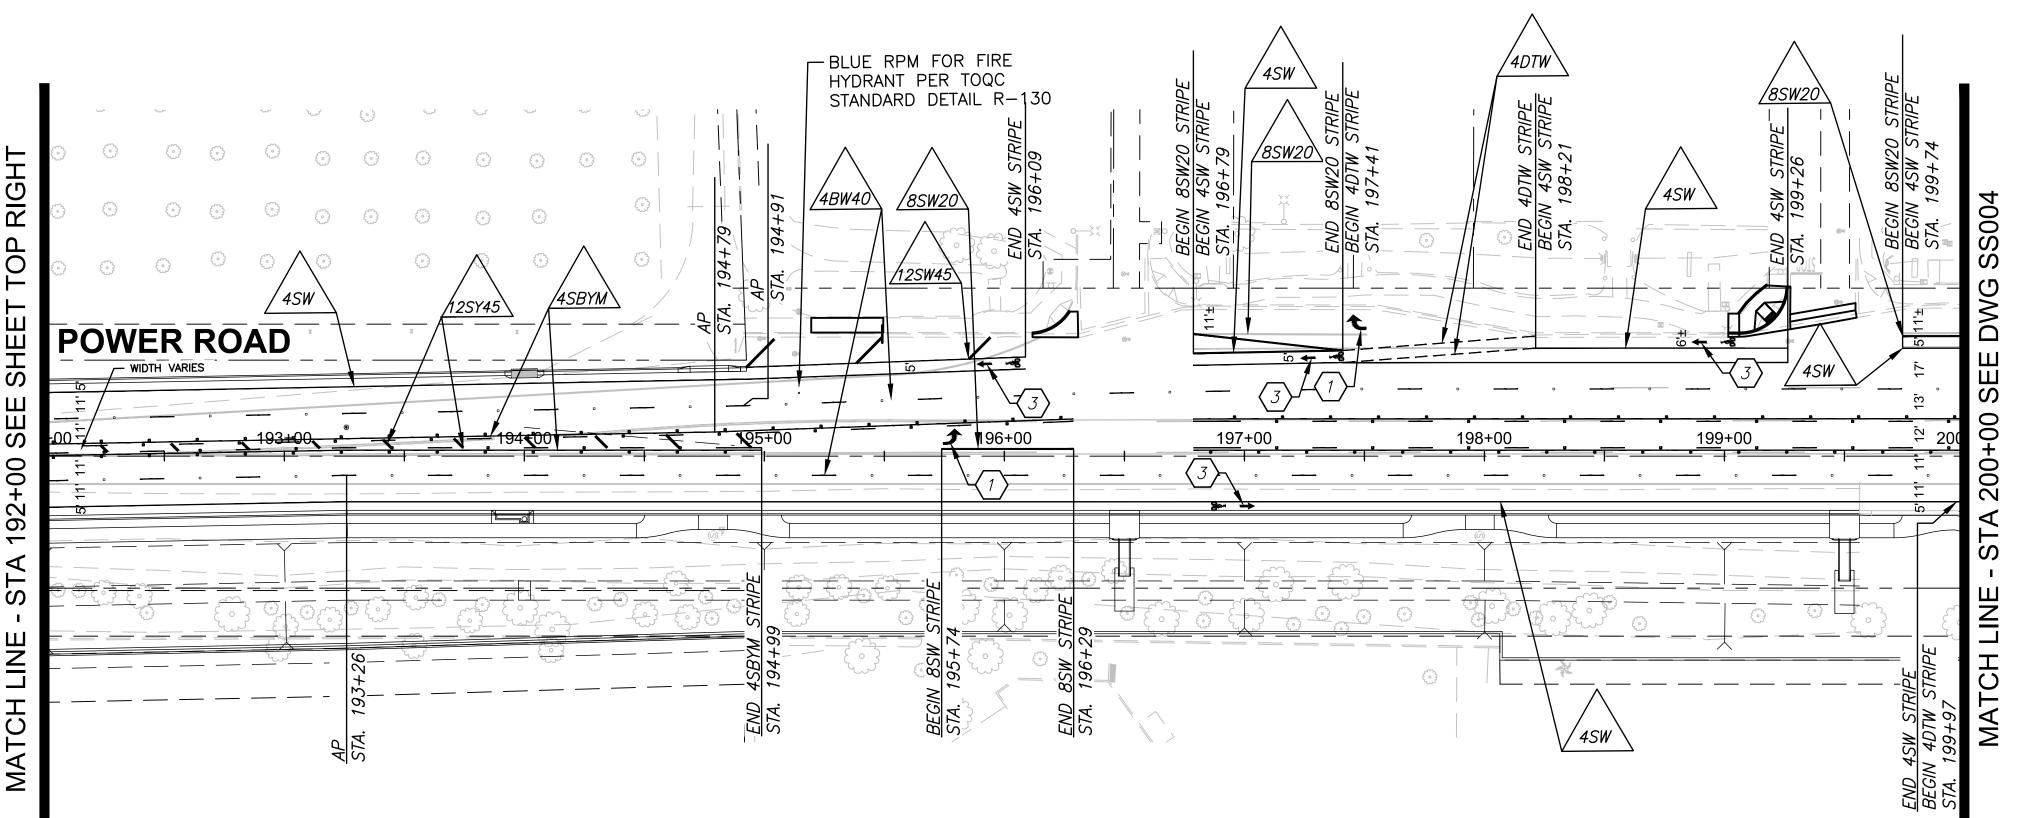

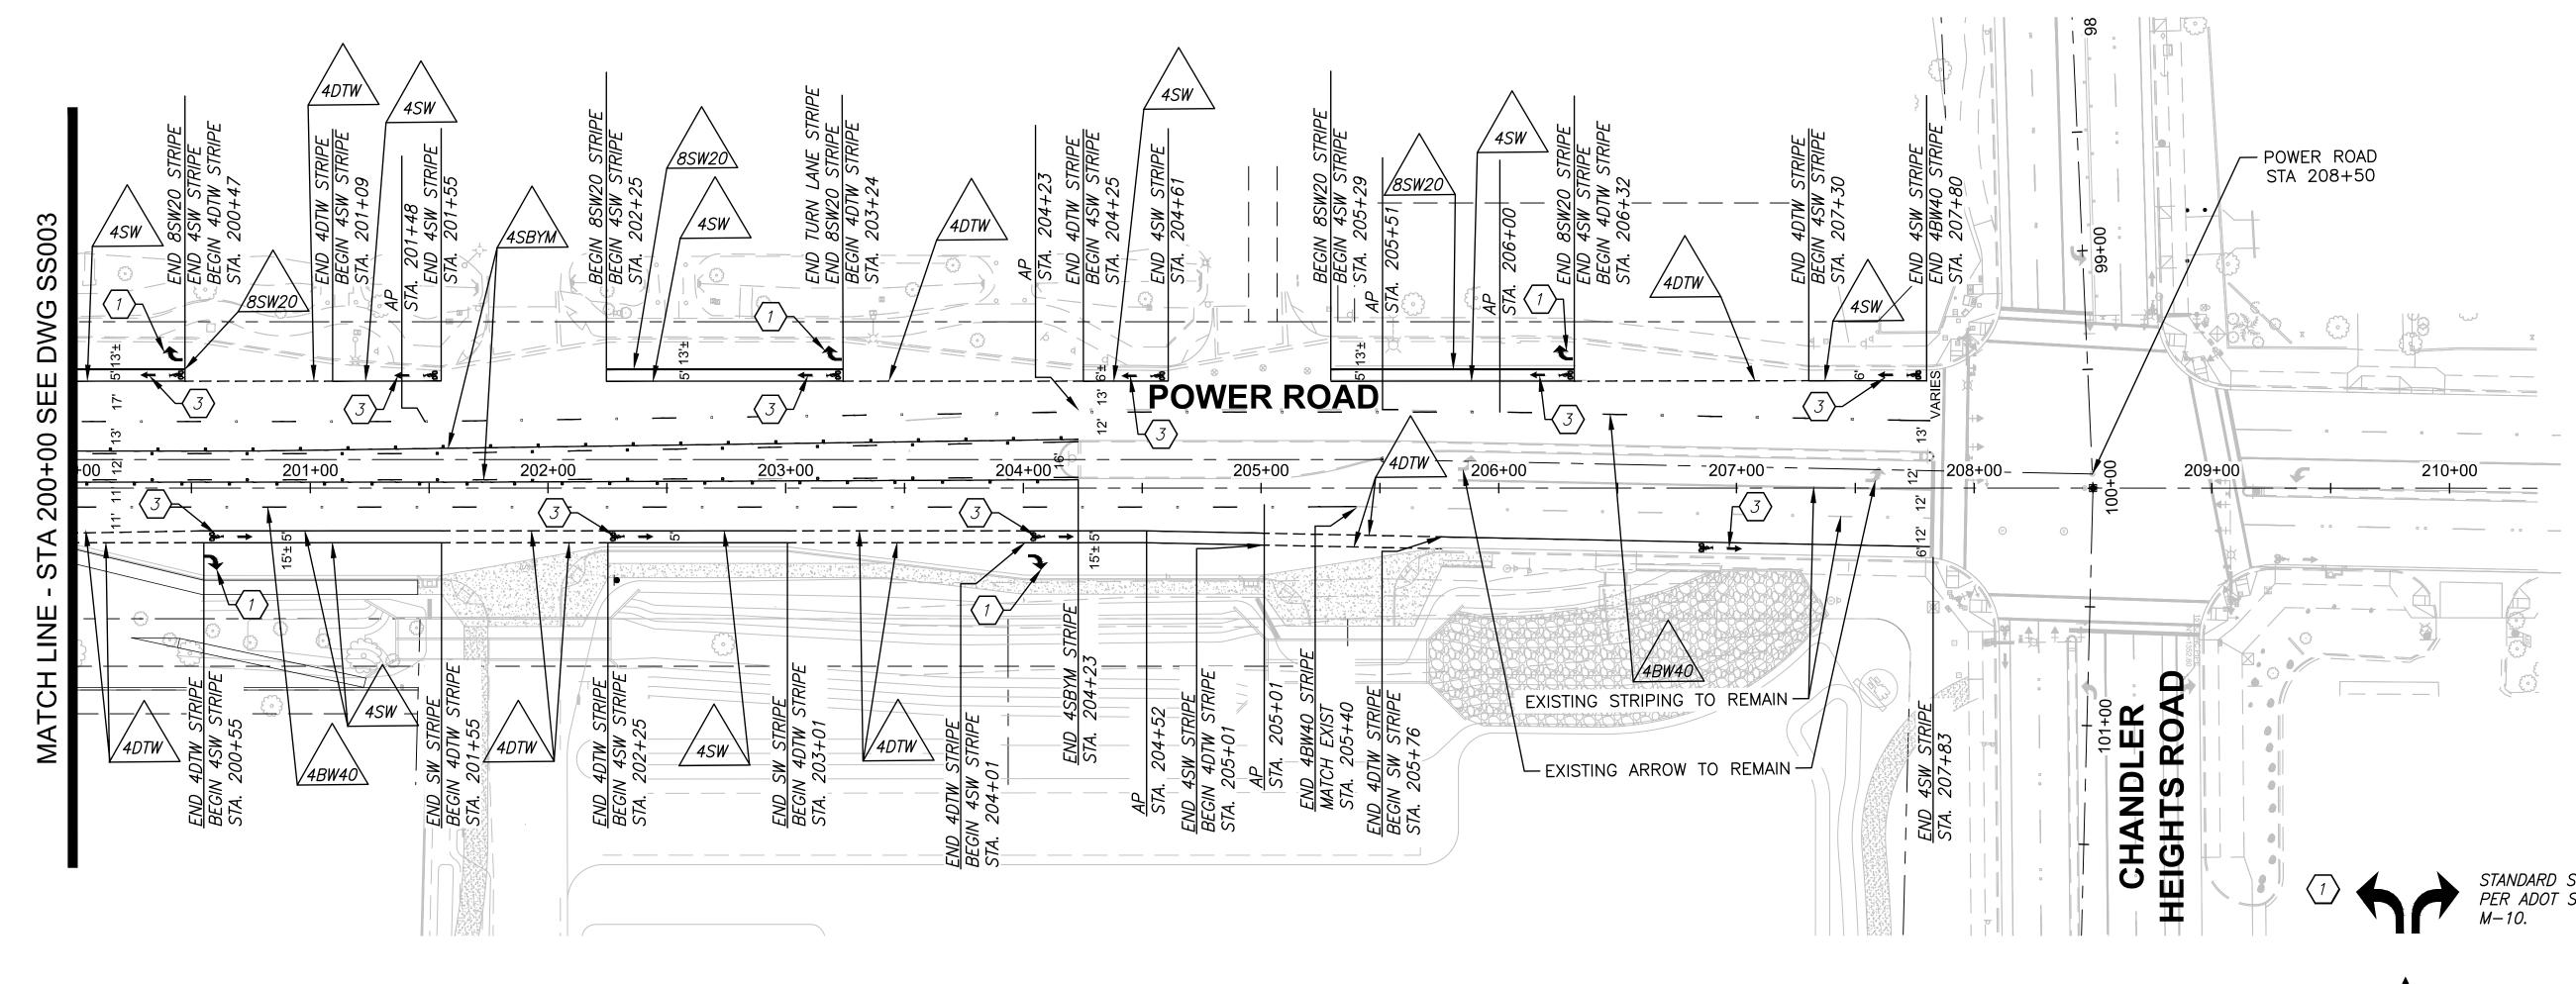


STANDARD SINGLE ARROW (RIGHT & LEFT) PER ADOT SIGNING AND MARKING DRAWING M-10.

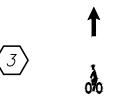

STANDARD BIKE LANE SYMBOL & ARROW PER TOWN OF QUEEN CREEK DETAIL R—131. (MODIFIED AS SHOWN)

NOTE:

ALL EXISTING PAVEMENT MARKINGS IN CONFLICT WITH THE PROPOSED STRIPING NOT BEING REMOVED AS PART OF THE PAVEMENT REMOVAL, SHALL BE REMOVED BY APPROVED METHODS.

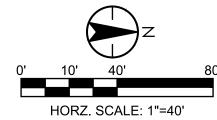



TOWN OF QUEEN CREEK



POWER ROAD: RIGGS ROAD TO CHANDLER HEIGHTS ROAD ROADWAY AND DRAINAGE IMPROVEMENTS

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STRIPING PLANS

DESIGNED BY MH CIP PROJ NO. A1405 DRAWING NO.

SHEET 76 OF 133 SS004

- 3. PRIOR TO CONSTRUCTION THE CONTRACTOR SHALL POTHOLE EXISTING FACILITIES AT ALL CONDUIT CROSSINGS.
- 4. WHEN INSTALLED ADJACENT TO A SIDEWALK RAMP, TOPS OF POLE FOUNDATIONS SHALL BE PER TOQC STANDARD DETAIL TS-08. OTHERWISE, THEY SHALL BE THE SAME ELEVATION AS EXISTING ADJACENT SIDEWALK OR TOP OF CURB. IF CURB/GUTTER DOES NOT EXIST, NOR IS IT PLANNED FOR CONSTRUCTION ADJACENT TO THE NEW POLE FOUNDATION, THE TOP OF FOUNDATION SHALL BE SET A MINIMUM OF 4 INCHES ABOVE THE ADJACENT ROADWAY CROWN.
- CONTRACTOR SHALL REPLACE ALL LANDSCAPING AND/OR IRRIGATION FACILITIES THAT MAY BE DISTURBED OR DAMAGED DURING TRAFFIC SIGNAL CONSTRUCTION AT HIS OWN EXPENSE. CONTACT THE PROPERTY OWNER FOR INFORMATION ON THE LOCATION OF IRRIGATION EQUIPMENT.
- THE CONTRACTOR IS RESPONSIBLE FOR TRIMMING EXISTING LANDSCAPING AND VEGETATION ADJACENT TO PROPOSED SIGNAL EQUIPMENT TO ENSURE CLEAR VISIBILITY OF ALL PEDESTRIAN AND SIGNAL HEADS. ALL WORK ASSOCIATED WITH THIS ITEM SHALL BE CONSIDERED INCIDENTAL TO THE INSTALLATION OF SIGNAL AND PEDESTRIAN HEADS.
- 7. ALL NEW FIELD EQUIPMENT SHALL BE LOCATED BY A REGISTERED LAND SURVEYOR CURRENTLY LICENSED IN THE STATE OF ARIZONA.
- PRIOR TO INSTALLATION, THE CONTRACTOR SHALL CONTACT THE TOQC TRAFFIC DEPARTMENT AT 480-358-3132 FOR INSPECTION AND APPROVAL OF EQUIPMENT LOCATIONS.
- TRAFFIC SIGNAL PULL BOXES SHALL BE LEFT IN CLEAN CONDITION
- 10. WHERE THE EXISTING PULL BOX IS TO BE REMOVED AND REPLACED WITH A NEW PULL BOX OR SPLICE VAULT, THE CONTRACTOR SHALL ADJUST THE EXISTING CONDUIT SWEEPS TO ENTER THE NEW PULL BOX OR SPLICE VAULT INSTALLATION PER TOQC STANDARD DETAIL TS-02, TS-03 AND ITS-06.
- 11. THE CONTRACTOR IS RESPONSIBLE FOR CONTACTING STEPHEN DURAN AT SALT RIVER PROJECT (SRP) AT 602-236-4199, A MINIMUM OF 4 WEEKS PRIOR TO START OF CONSTRUCTION, FOR POWER SOURCE POINT OF DELIVERY (POD) LOCATION AND INSTALLATION REQUIREMENTS, CONTRACTOR SHALL COORDINATE WITH THE TOQC TRAFFIC DEPARTMENT AT 480-358-3132 PRIOR TO MAKING CONTACT WITH SRP.
- 12. THE CONTRACTOR IS RESPONSIBLE FOR PROVIDING AND INSTALLING THE SERVICE CONDUIT RUN FROM THE SRP POWER SOURCE POD TO THE SIGNAL METER PEDESTAL SRP IS RESPONSIBLE FOR INSTALLING SERVICE WIRE FROM THE SRP POWER SOURCE POD TO THE METER PEDESTAL.
- 13. ALL CONDUITS SHALL BE SCHEDULE 40 PVC.
- 14. THE CONTRACTOR IS RESPONSIBLE FOR RETURNING ALL SALVAGED MATERIAL TO THE TOQC.
- 15. ALL CONDUIT RUNS UNDER EXISTING PAVEMENT OR DRIVEWAYS SHALL BE INSTALLED BY DIRECTIONAL BORING UNLESS PRIOR APPROVAL IS OBTAINED FROM THE TOQC TRAFFIC DEPARTMENT.
- 16. THE CONTRACTOR SHALL CONTACT THE TOQC TRAFFIC DEPARTMENT AT 480-358-3132 TO COORDINATE THE EMERGENCY VEHICLE PREEMPTION DETECTOR LINE OF SIGHT.
- 17. THE CONTRACTOR SHALL COMPLY WITH ALL PROVISIONS FOR TEMPORARY TRAFFIC CONTROL AND SIGNING AND PAVEMENT MARKING AS PER THE MANUAL ON UNIFORM TRAFFIC CONTROL DEVICES (MUTCD) LATEST APPROVED EDITION, THE ARIZONA SUPPLEMENT TO THE MUTCD, AND TOWN OF QUEEN CREEK REQUIREMENTS.
- 18. THE CONTRACTOR SHALL PROVIDE MATERIAL SUBMITTALS TO THE TOWN OF QUEEN CREEK TRAFFIC ENGINEERING DEPARTMENT PRIOR TO ORDERING ANY MATERIALS. UPON WRITTEN APPROVAL BY THE TOWN, SUBMITTED MATERIALS MAY BE ORDERED.
- 19. THE CONTRACTOR SHALL CONTACT THE TOWN OF QUEEN CREEK TRAFFIC DEPARTMENT AT 480-358-3132 TO SCHEDULE THE TURN-ON A MINIMUM OF 10 WORKING DAYS IN ADVANCE, THE CONTRACTOR SHALL PROVIDE AN OFF-DUTY DEPUTY FROM THE QUEEN CREEK DISTRICT OF THE MARICOPA COUNTY SHERIFF'S OFFICE TO CONTROL TRAFFIC DURING THE SIGNAL TURN-ON.
- 20. SEE SIGNING AND PAVEMENT MARKING PLANS FOR ACTUAL LANE DIMENSIONS, STOP BAR LOCATIONS AND REQUIREMENTS.
- 21. MOUNTING HEIGHT FOR TRAFFIC SIGNAL FACES SHALL COMPLY WITH THE CURRENTLY APPROVED EDITION OF THE MANUAL ON UNIFORM TRAFFIC CONTROL DEVICES HANDBOOK.
- 22. THE CONTRACTOR SHALL INSTALL A 2" FLUORESCENT YELLOW PRISMATIC ASTM D4956 TYPE XII, IX, OR XI RETRO REFLECTIVE BORDER AROUND THE ENTIRE PERIMETER OF EACH BACK PLATE FOR ALL HEADS. NO ADDITIONAL PAYMENT WILL BE MADE FOR SUPPLYING AND INSTALLING THE RETRO REFLECTIVE TAPE.

### **CONSTRUCTION NOTES:**

- TOP OF FOUNDATION ELEVATIONS SHALL BE THE SAME ELEVATION AS EXISTING ADJACENT SIDEWALK OR TOP OF CURB. IF CURB/GUTTER DOES NOT EXIST NOR IS IT PLANNED FOR CONSTRUCTION ADJACENT TO THE NEW POLE FOUNDATION, THE CONTRACTOR SHALL INSTALL THE POLE FOUNDATIONS A MINIMUM OF 4 INCHES ABOVE THE ADJACENT ROADWAY CROWN.
- CONTRACTOR SHALL PROVIDE AND INSTALL ALL MATERIALS.
- PULL BOXES FALLING IN SIDEWALK/RAMP AREA SHALL BE FLUSH-FINISHED WITH SIDEWALK/RAMP FINISHED SURFACE.

### TRAFFIC SIGNAL POLE SCHEDULE NOTES:

- 1. THE CONTRACTOR SHALL PROVIDE AND INSTALL LUMINAIRES. ALL LUMINAIRES SHALL HAVE SHORTING CAPS INSTALLED.
- 2. INTERNALLY ILLUMINATED STREET NAME SIGNS (IISNS) SHALL BE PROVIDED AND INSTALLED BY THE CONTRACTOR, PRIOR TO ORDERING OR MANUFACTURING IISNS. THE CONTRACTOR SHALL PROVIDE SHOP DRAWINGS FOR REVIEW AND APPROVAL TO TOQC TRAFFIC DEPARTMENT. SHOP DRAWINGS SHALL INCLUDE FRONT AND BACK FACE LAYOUT, CABINET DETAILS, LIGHTING SPECIFICATIONS MOUNTING SPECIFICATIONS, COLOR AND FONT SPECIFICATIONS. ADDRESSES FOR THE SIGNS WILL BE PROVIDED BY THE TOQC TRAFFIC DEPARTMENT.
- 3. THE CONTRACTOR SHALL PROVIDE AND INSTALL EMERGENCY VEHICLE PRE-EMPTION. TERMINATIONS SHALL BE PER TOQC STANDARD DETAIL TS-02 AND TS-04. THE CONDUCTOR CABLE FOR THE EMERGENCY VEHICLE PRE-EMPTION CABLE SHALL RUN UNSPLICED FROM THE DETECTOR TO THE CONTROLLER CABINET.
- 4. THE CONTRACTOR SHALL SUPPLY A COMPLETE CABINET ASSEMBLY, SIGNAL POLES (INCLUDING ANCHOR BOLTS), MAST ARMS, SIGNAL AND PEDESTRIAN HEADS (INCLUDING MOUNTING BRACKETS) AND PEDESTRIAN PUSH BUTTONS.
- 5. THE CONTRACTOR SHALL INSTALL PEDESTRIAN PUSH BUTTONS PER ADOT STANDARD DETAIL TS 11-1. PEDESTRIAN PUSH BUTTONS SHALL BE MOUNTED WITH THE CENTERS OF THE PUSH BUTTON NOT EXCEEDING A MAXIMUM OF 42" ABOVE THE ADJACENT FINISHED SIDEWALK. ALL PUSH BUTTONS SHALL BE ETCHED WITH TOWN LOGO. CONTRACTOR SHALL PROVIDE (2) SPARE PUSH BUTTONS PER INTERSECTION.
- 6. THE TOWN WILL PROVIDE AND THE CONTRACTOR SHALL INSTALL A VIDEO DETECTION (4) CAMERA SYSTEM, PER TOWN OF QUEEN CREEK SPECIFICATIONS. INSTALLATION OF THE VIDEO DETECTION POWER/DATA CONDUCTORS SHALL RUN UNSPLICED FROM EACH CAMERA TO THE CONTROLLER CABINET. CONTRACTOR SHALL PROVIDE (1) SPARE CAMERA AND MOUNTING ASSEMBLY PER INTERSECTION.
- 7. ALL SIGNAL HEADS WITH TYPE XI SIDE MOUNTS SHALL HAVE A 12" ARM. PEDESTRIAN HEADS SHALL BE ADOT STANDARD.
- 8. REFER TO TOWN OF QUEEN CREEK APPROVED MATERIAL LIST FOR MORE DETAILS.
- 9. ALL TRAFFIC SIGNAL, ITS, AND LIGHTING EQUIPMENT SHALL CONFORM TO THE TOQC AML. SHOP DRAWINGS SHALL BE SUBMITTED AND APPROVED BY THE TOQC BEFORE ORDERING.
- 10. THE CONTRACTOR SHALL INSTALL EQUESTRIAN PEDESTRIAN PUSH BUTTONS PER THE EQUESTRIAN DESIGN GUIDELINES FOR TRAILS, TRAILHEADS, AND STRUCTURES WITH THE CENTER OF THE PUSH BUTTON A MAXIMUM OF 70" ABOVE THE ADJACENT FINISHED SIDEWALK, ALL PUSH BUTTONS SHALL BE ETCHED WITH TOWN LOGO.





TOWN OF QUEEN CREEK



POWER ROAD: RIGGS ROAD TO CHANDLER HEIGHTS ROAD ROADWAY AND DRAINAGE IMPROVEMENTS

Stantec

Chandler, Arizona 85226 Tel. 480.687.6100

TRAFFIC SIGNAL NOTES DESIGNED BY MH


CIP PROJ NO. A1405 BE DRAWN BY

TS001

SHEET 77 OF 133 €

SUBMITTAL

DRAINAGE

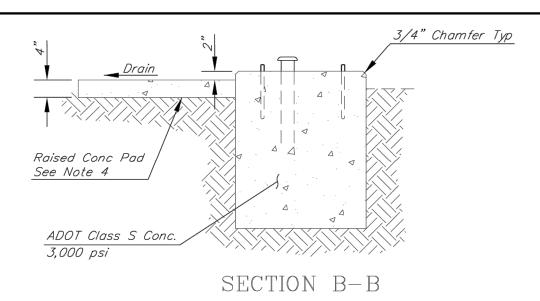

1. Location of control cabinet foundation shall be approved by the Engineer

- 2. Location of conduit placement within the foundation shall be inspected by the Engineer prior to pouring foundation.
- 3. Conduit projection above foundation shall be 2" Min to 4" Max. Conduits shall have bell ends attached prior to conductor installation.
- 4. In unpaved areas a raised concrete pad shall be placed in front of the cabinet. The pad shall be set 2" below the foundation elevation. Slope pad away from cabinet at 2% Min. slope.
- 5. 1" sleeve (for ground rod) shall be inserted when foundation is poured. Install a  $\frac{5}{8}$ "  $\phi$  x 8' long bonded copper rod in 1" sleeve.
- 6. Anchor bolts shall be galvanized ¾"x12"x4" complete with nuts and washers. Anchor bolt projection above foundation shall be 1½" Min. to 2½"
- 7. Place an approved silicone RTV type sealer between the cabinet and the foundation. Sealer shall be gray in color or clear.
- 8. 3" conduit to be installed for Interconnect, when shown on plans. If interconnect conduit is not called for, install 3" conduit, stubbed out 24" past edge of foundation, in direction selected by Engineer, & cap for future use.

48"	
Anchor Bolts Typ	
3" Interconnect or Future	
Control Cabinet  3" Detection,  EVP, CCTV  1" Ground Rod Sleeve See Note 5	
Front of Cabinet (Door Side)	
PLAN	
re use.	

SECTION A-A

CABLE	CABLE		NDUCTOR COLOR	SIGNAL
#1	#2	BASIC COLOR	TRACER STRIPE	INTERVAL
		RED	WHITE	RED
41	4.5	BLACK	WHITE	YELLOW
Ø1	ø5	GREEN	WHITE	GREEN
		BLACK	WHITE/RED	SPARE
		RED		RED
ø2	ø6	ORANGE		YELLOW
		GREEN		GREEN
		BLACK	RED	RED
ø3	ø7	ORANGE	RED	YELLOW
ΨϽ	Ψ/	BLUE	RED	GREEN
		WHITE	BLACK/RED	SPARE
		RED	BLACK	RED
ø4	ø8	ORANGE	BLACK	YELLOW
		GREEN	BLACK	GREEN
		BLUE		WALK
ø2 PED.	ø6 PED.	BLACK		DON'T WALK
		WHITE	BLACK	PUSH BUTTON
		BLUE	WHITE	WALK
ø4 PED.	ø8 PED.	RED	GREEN	DON'T WALK
		WHITE	RED	PUSH BUTTON
COMMON	COMMON	WHITE		P.B. COMMON
SPARE	SPARE	BLUE	BLACK	SPARE
SPARE	SPARE	RED	BLACK/WHITE	SPARE
SPARE	SPARE	GREEN	BLACK/WHITE	SPARE
SPARE	SPARE	ORANGE	GREEN	SPARE

	IMSA CA	BLE 19-1, #	14 AWG	, 4 & 7-COM	NDUCTOR
	SIGNA OUTSIDE MAST	L HEADS ARM & 5-SECTI	ON		HEADS CTION
	7-CONDU	CTOR CABLE		4-CONDUC	TOR CABLE
	BASIC COLOR	SIGNAL INTERVAL		BASIC COLOR	SIGNAL INTERVAL
_	RED	RED		RED	RED
4	BLACK	YELLOW		BLACK	YELLOW
$\dashv$	GREEN	GREEN		GREEN	GREEN
$\dashv$	ORANGE	YELLOW ARRO	W	WHITE	VEH. COM
$\dashv$	BLUE	GREEN ARROV	V		
$\dashv$	WHITE	VEH. COM.			
$\dashv$	WHT/BLK TR	SPARE			
	PEDESTRI <i>A</i>	N HEADS		PUSH	BUTTON
┪	4-CONDUC	TOR CABLE		4-CONDUC	TOR CABLE
	BASIC COLOR	SIGNAL INTERVAL		BASIC COLOR	SIGNAL INTERVAL
	RED	DON'T WALK		RED	PUSH BUTTON
	BLACK	SPARE		BLACK	SPARE
	GREEN	WALK		GREEN	SPARE

PRE-E	MPTION	<u>NOTE:</u> Pre-emption cable shall be
4-CONDUC	TOR CABLE	M913 Strobecom Detector Cable
BASIC COLOR	CIRCUIT	or approved equal.
YELLOW	A,B,C,D	
ORANGE	26V	
BLUE	GROUND	
BARE	EARTH GROUND	

ø8 PED

ø4 PED

ø5 ø2

CH A

PΕ

СН В

WHITE PED. COM

REV. 01/2017



### TOWN OF QUEEN CREEK STANDARD DETAIL

**CONTROL CABINET** FOUNDATION DETAIL

TS-01

REV. 06/2016

### TOWN OF QUEEN CREEK STANDARD DETAIL

Phase 2 is always Northbound,

regardless of street classification.

### TRAFFIC SIGNAL CONDUCTOR **COLOR CODING**

WHITE P.B. COM.

TS-02

### Phase Colors:

Ø2 (NB)=Red, Ø4 (EB)=Yellow, Ø6 (SB)=Green, Ø8 (WB)=Blue

### <u>25—Conductor Cables</u>

SE corner to NE corner — Cable 1 = 1 Red Band, Cable 2 = 2 Red Bands SW corner to SE corner — Cable 1 = 1 Yellow Band, Cable 2 = 2 Yellow Bands NW corner to SW corner - Cable 1 = 1 Green Band, Cable 2 = 2 Green Bands NE corner to NW corner - Cable 1 = 1 Blue Band, Cable 2 = 2 Blue Bands

### <u>Mast Arm Signal Heads</u>

Outermost head = 1 band of through phase color. (No Lt Turn tape.)
Apply one additional band of phase color for each additional head, heading toward the support pole.

### Pole-Mounted Items

Signal Heads

1 band of through phase color plus 1 band of white. (No Lt Turn tape.) <u>Pedestrian Heads</u>


1 band of phase color plus 1 band of white and 1 band of orange.

<u>Ped Push Buttons</u>

1 band of phase color plus 1 band of orange.


### <u>Other</u>

- \* Place 1 band of phase color on pre-emption and video detection
- cables in each pull box.
- \* 1 brown band on illuminated street name sign conductors in each pull
- \* 1 red band on luminaire conductors in each pull box.

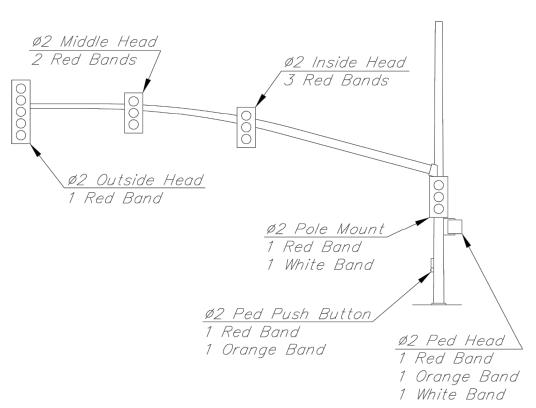

### TAPING EXAMPLE - USING Ø 2

Note: Phase 2 uses RED as its "phase color" for cable tapes

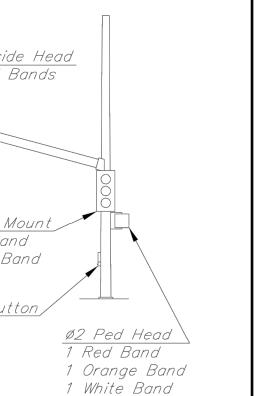

### REV. 06/2016

TOWN OF QUEEN CREEK

PRE-EMPTION PHASING

TS-04



TOWN OF QUEEN CREEK STANDARD DETAIL

CABLE TAPE COLOR CODING

TS-03

Call 811 or click Arizona811.co

### TOWN OF QUEEN CREEK



POWER ROAD: RIGGS ROAD TO CHANDLER HEIGHTS ROAD ROADWAY AND DRAINAGE IMPROVEMENTS

Stantec

TRAFFIC SIGNAL DETAILS

DESIGNED BY MH CIP PROJ NO. A1405 DRAWN BY

> TS002 DRAWING NO.

TRAFFIC SIGNAL CONDUCTOR

STANDARD DETAIL

PRE-EMPTION (EVP) CHANNELS

EVP Channel A = SB ( $\emptyset$ 6) = Controller Priority 3 EVP Channel B = WB ( $\emptyset$ 8) = Controller Priority 4 EVP Channel C = NB ( $\emptyset$ 2) = Controller Priority 5

EVP Channel D = EB  $(\phi 4)$  = Controller Priority 6

STANDARD TRAFFIC SIGNAL AND

REV. 06/2016


Contact Arizona 811 at least two full



Chandler, Arizona 85226 Tel. 480.687.6100

SHEET 78 OF 133



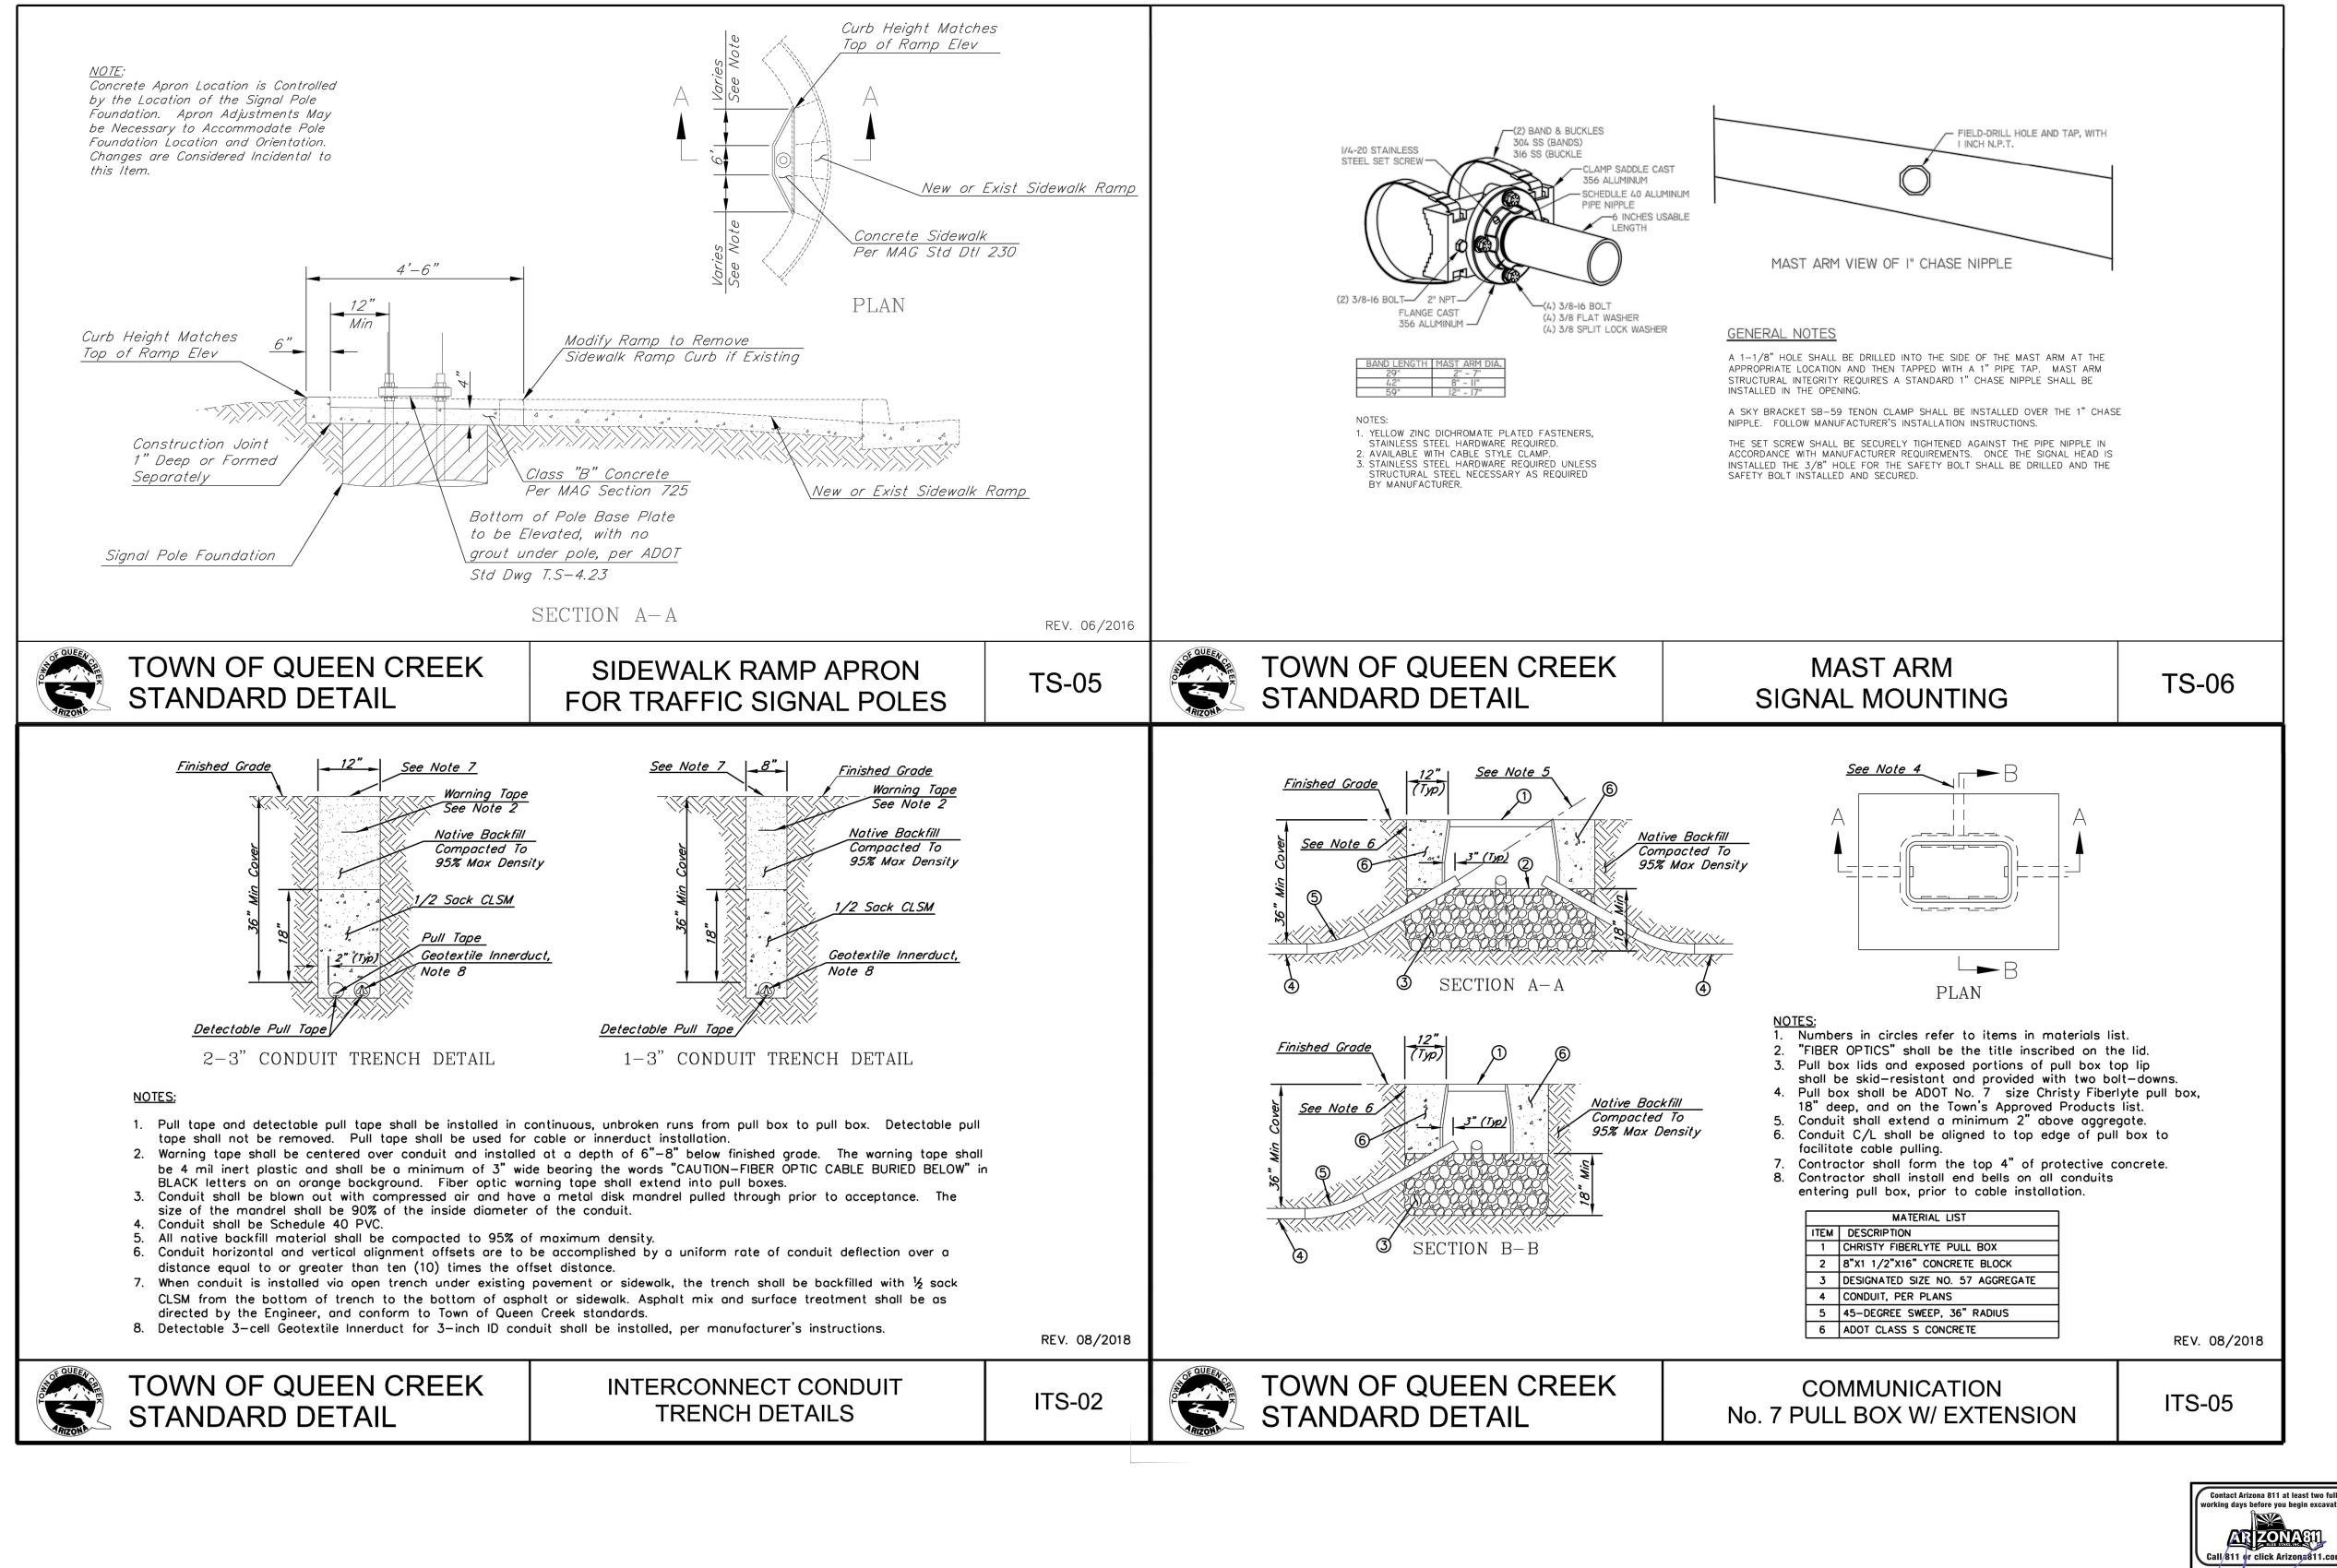



TOWN OF QUEEN CREEK



POWER ROAD: RIGGS ROAD TO CHANDLER HEIGHTS ROAD ROADWAY AND DRAINAGE IMPROVEMENTS

Stantec


TRAFFIC SIGNAL DETAILS

DESIGNED BY MH CIP PROJ NO. A1405


> TS003 DRAWING NO.

SHEET 79 OF 133

Chandler, Arizona 85226 Tel. 480.687.6100

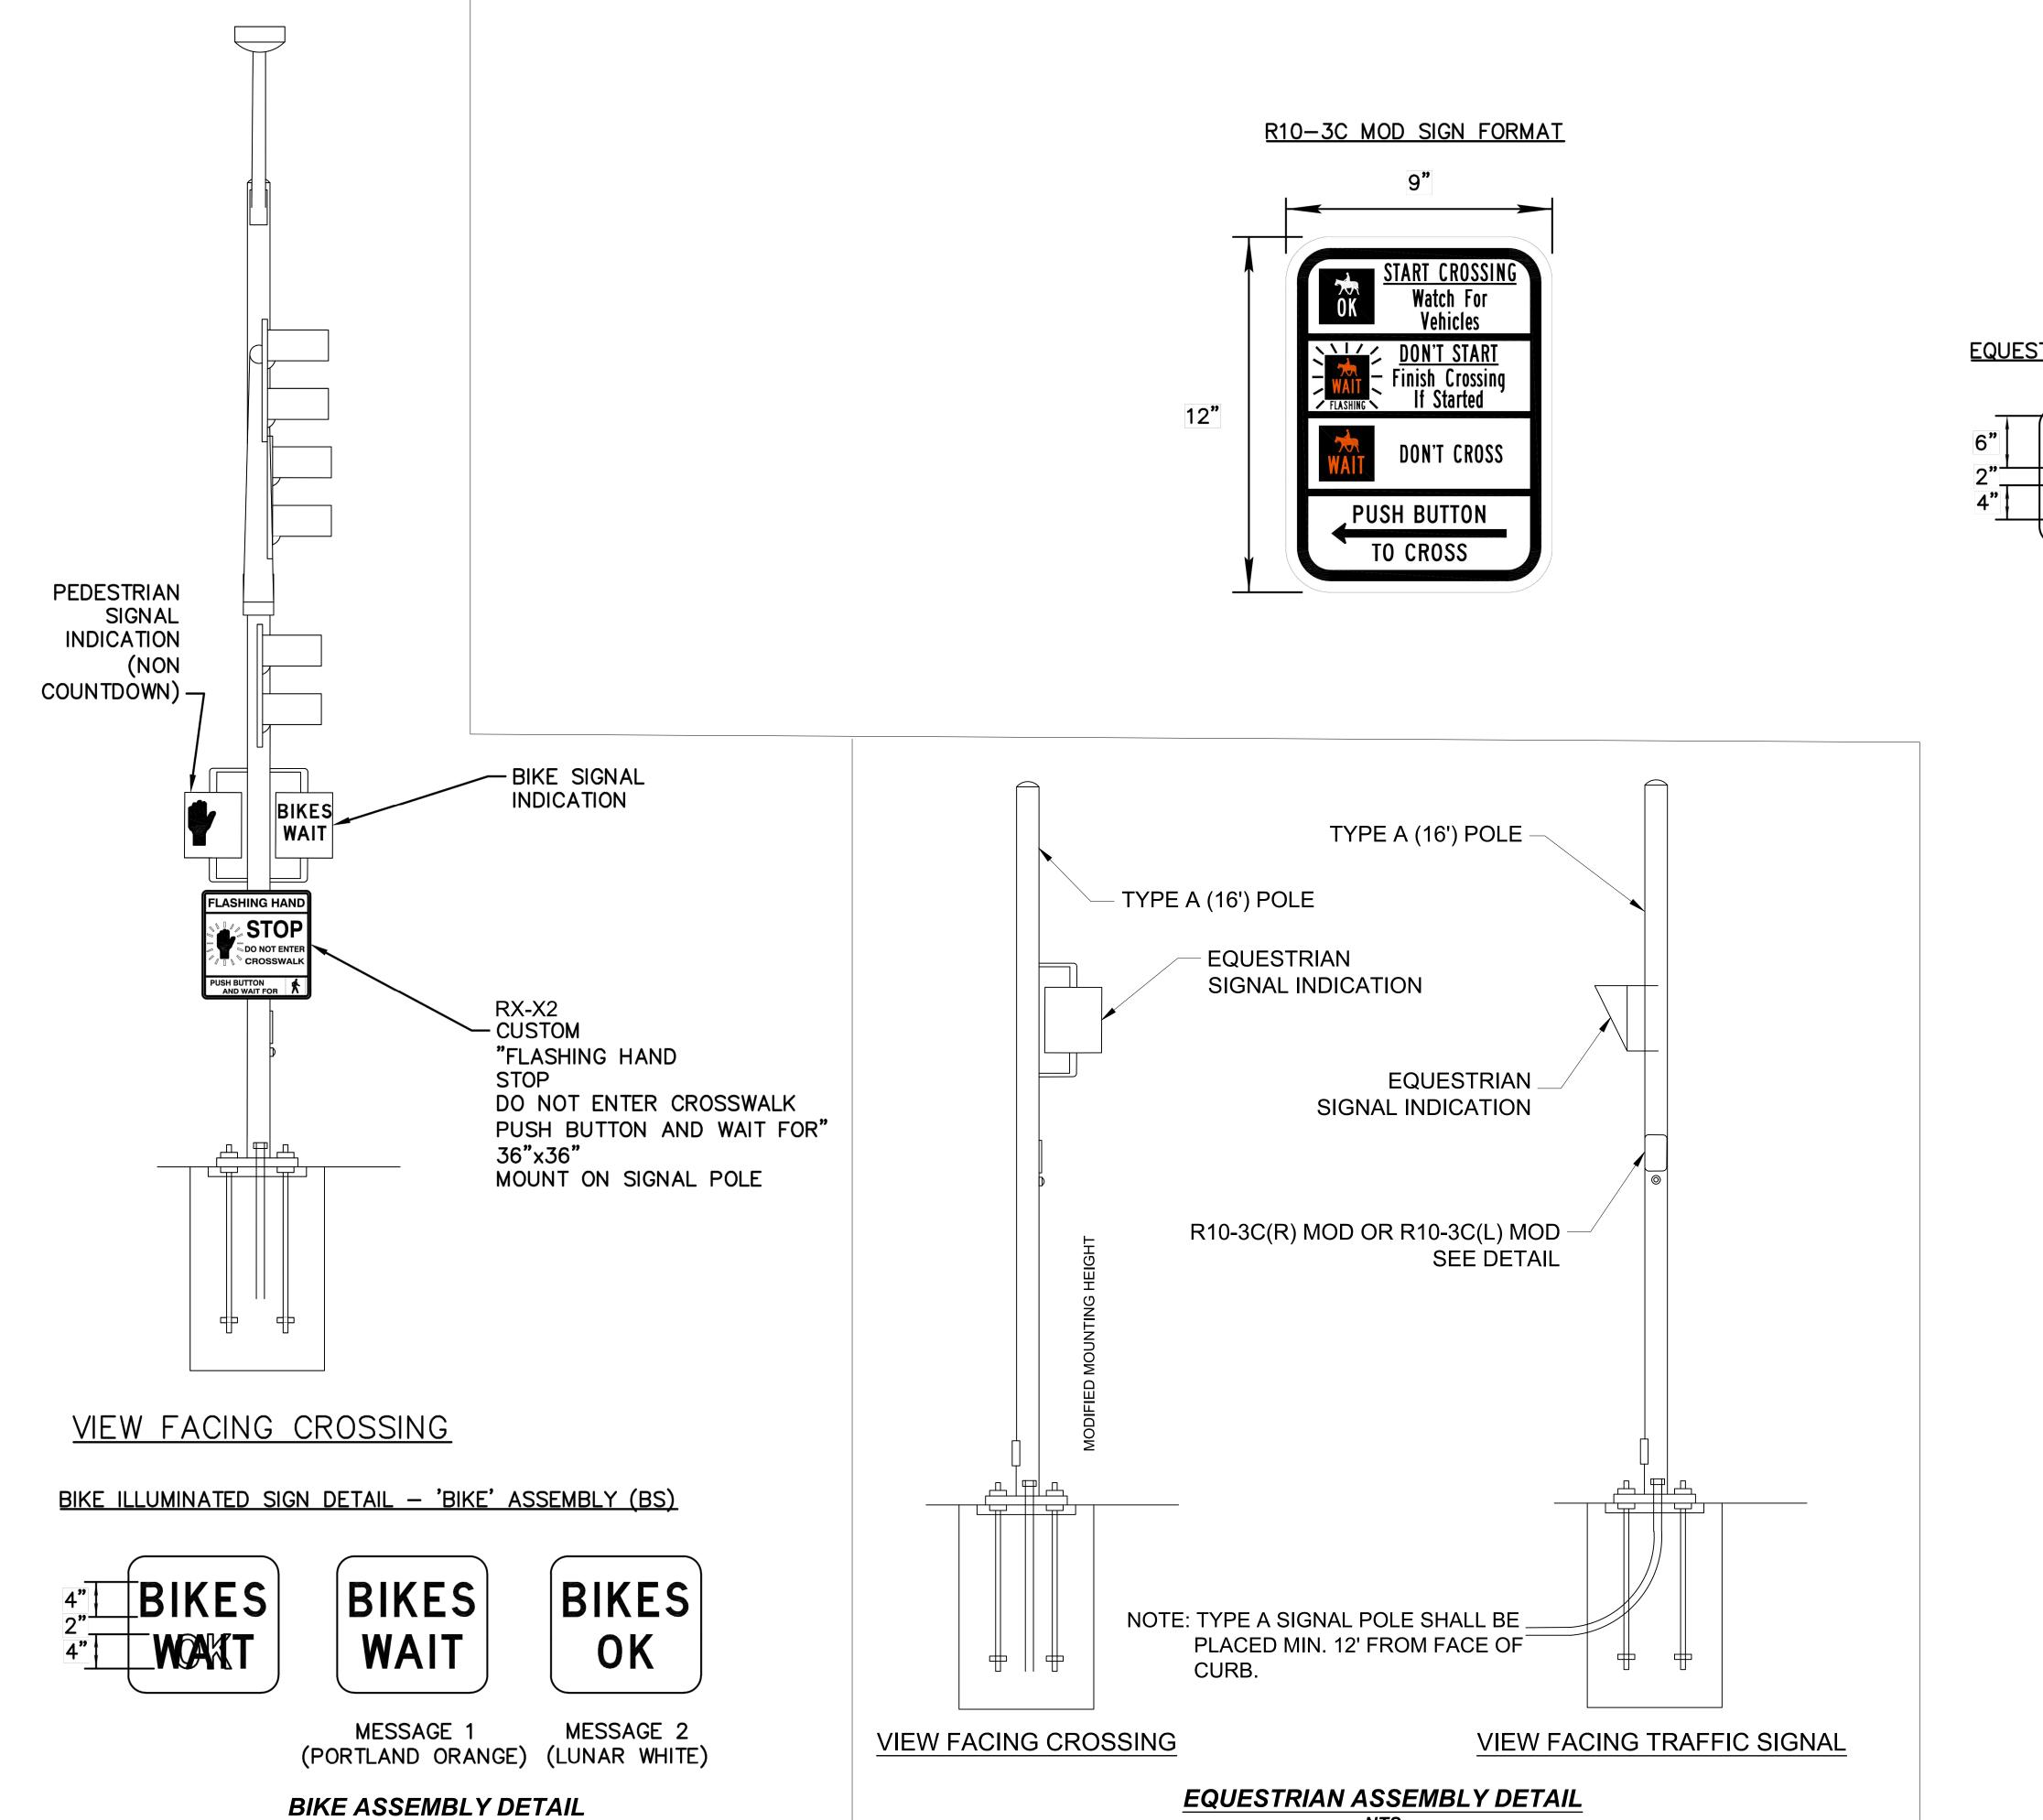

EQUESTRIAN ILLUMINATED SIGN DETAIL - 'EQUESTRIAN' ASSEMBLY (ES)

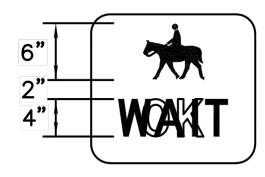






ROADWAY & DRAINAGE IMPROVEMENTS SEALED SUBMITTAL 10/03/2025

MESSAGE 1 MESSAGE 2 (PORTLAND ORANGE) (LUNAR WHITE)



TOWN OF QUEEN CREEK

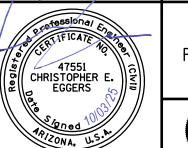

POWER ROAD: RIGGS ROAD TO CHANDLER HEIGHTS ROAD ROADWAY AND DRAINAGE IMPROVEMENTS

**Stantec** 

TRAFFIC SIGNAL DETAILS

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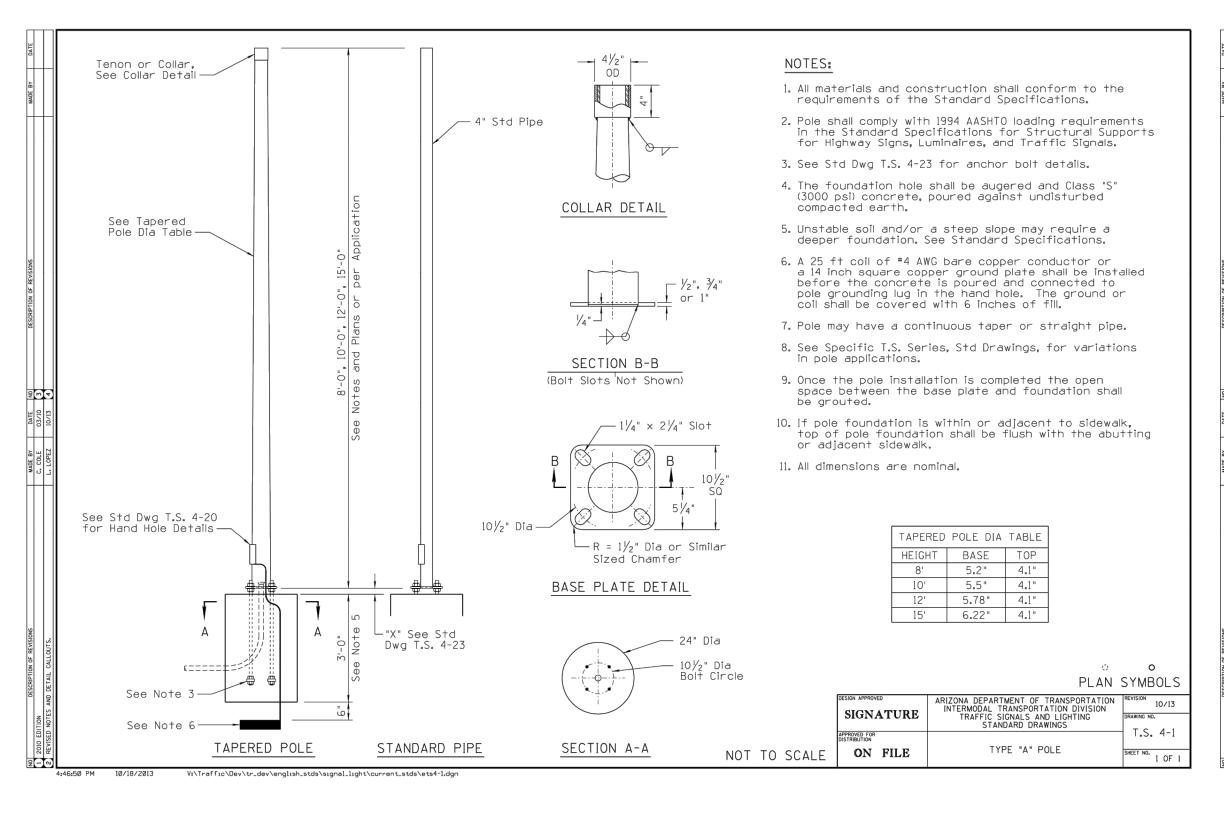
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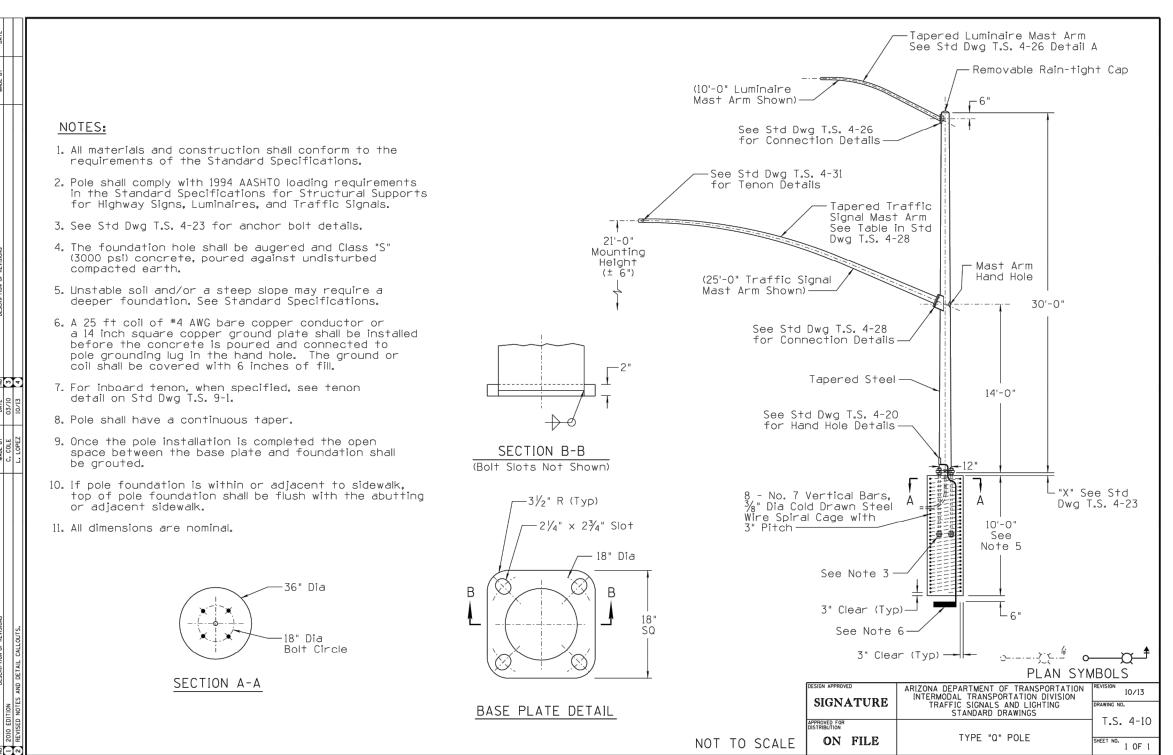
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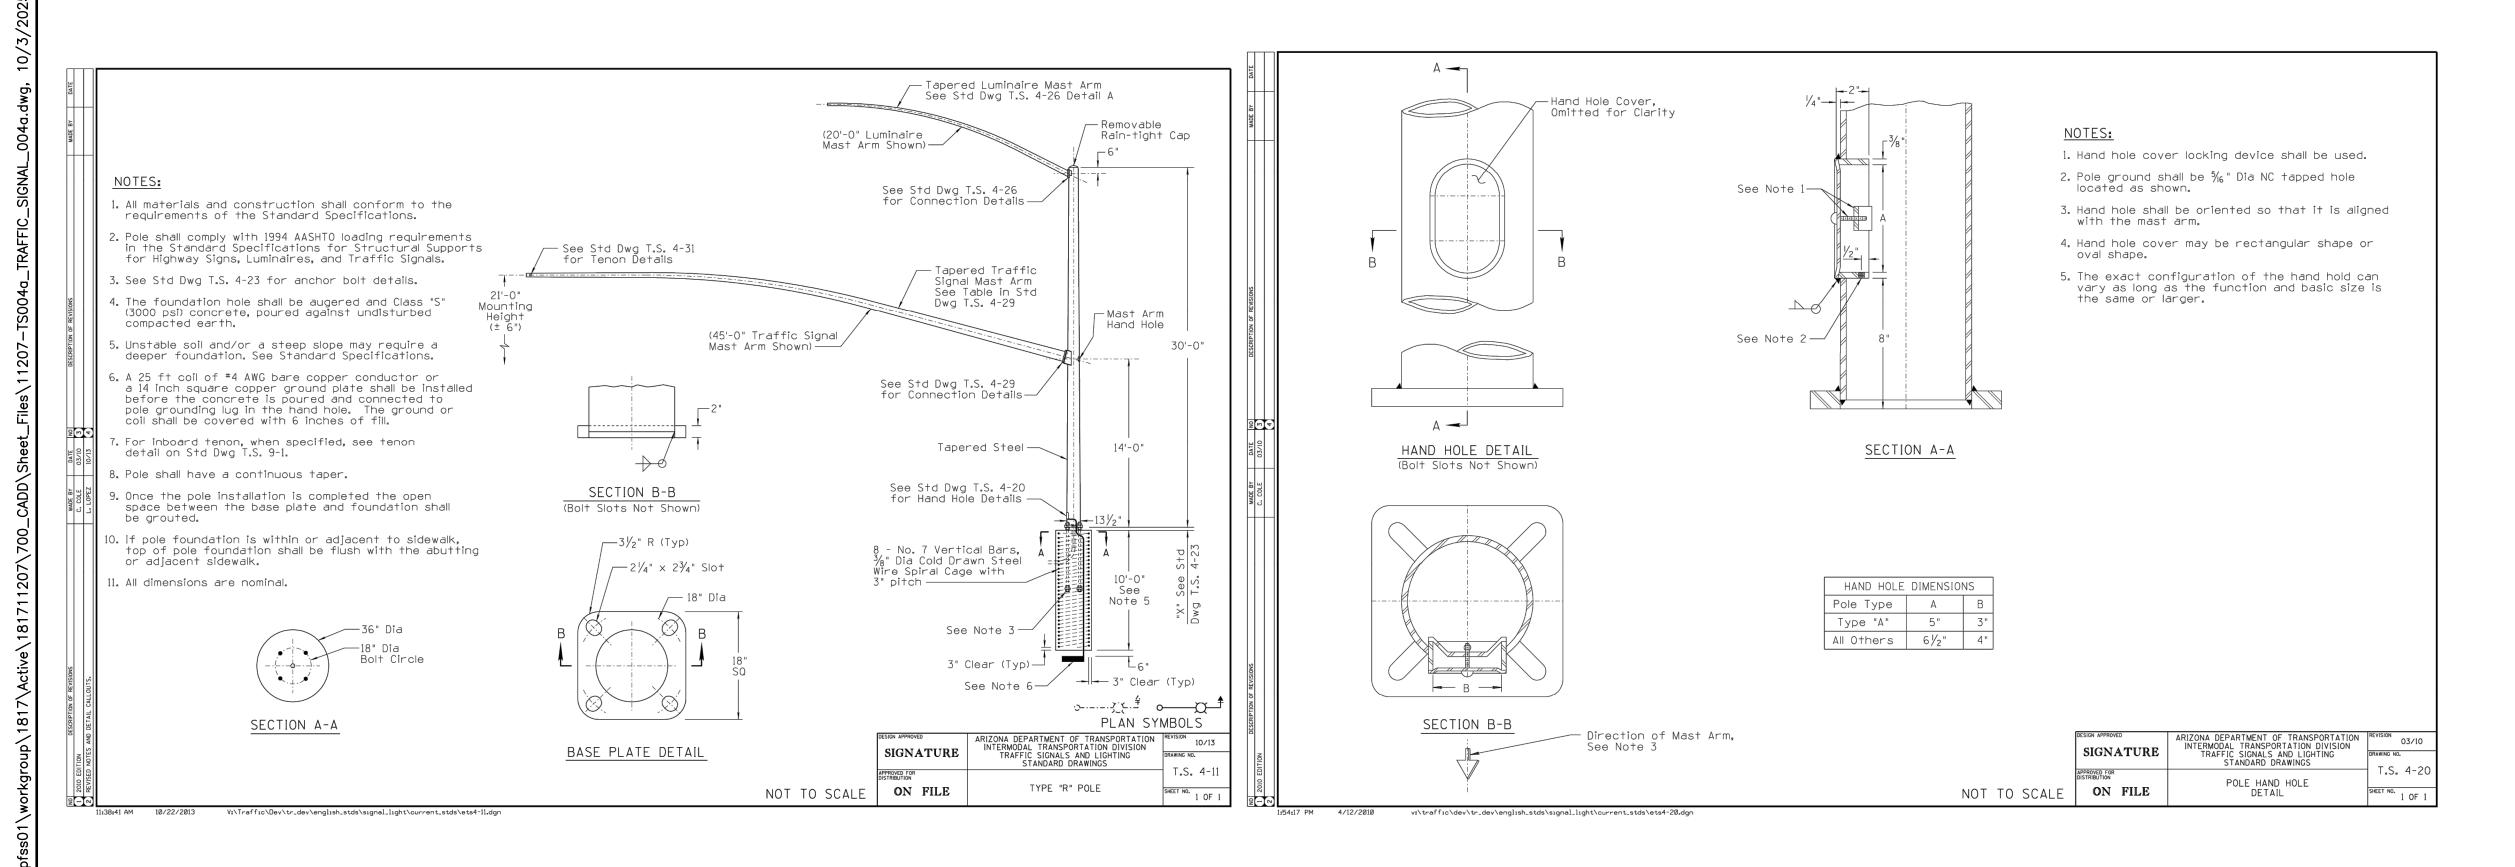
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10/03/202





V:\Traffic\Dev\tr\_dev\english\_stds\signal\_light\current\_stds\ets4-10.dgn







TOWN OF QUEEN CREEK



POWER ROAD: RIGGS ROAD TO CHANDLER HEIGHTS ROAD ROADWAY AND DRAINAGE IMPROVEMENTS


Chandler, Arizona 85226


Tel. 480.687.6100


TRAFFIC SIGNAL DETAILS DESIGNED BY MH CIP PROJ NO. A1405 DRAWN BY


TS004a SHEET 81 OF 133 DRAWING NO.

10/03/2025

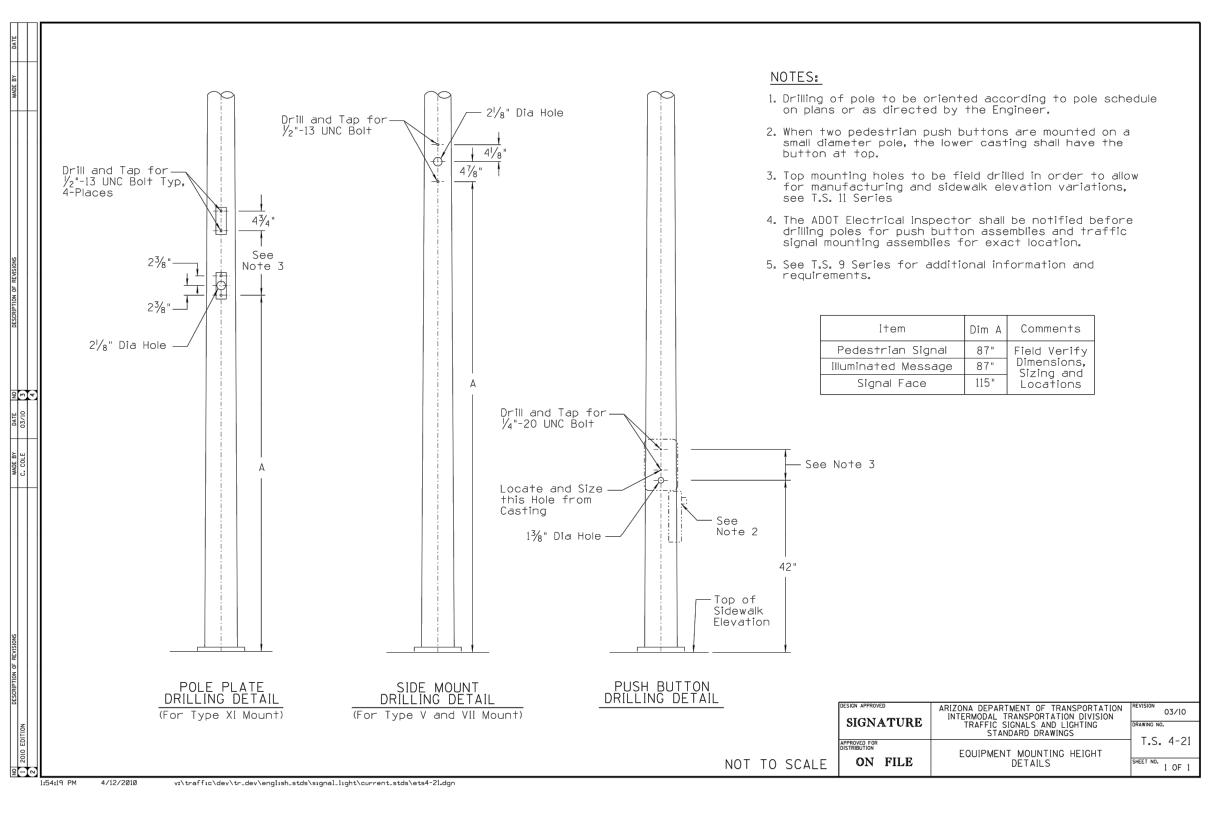

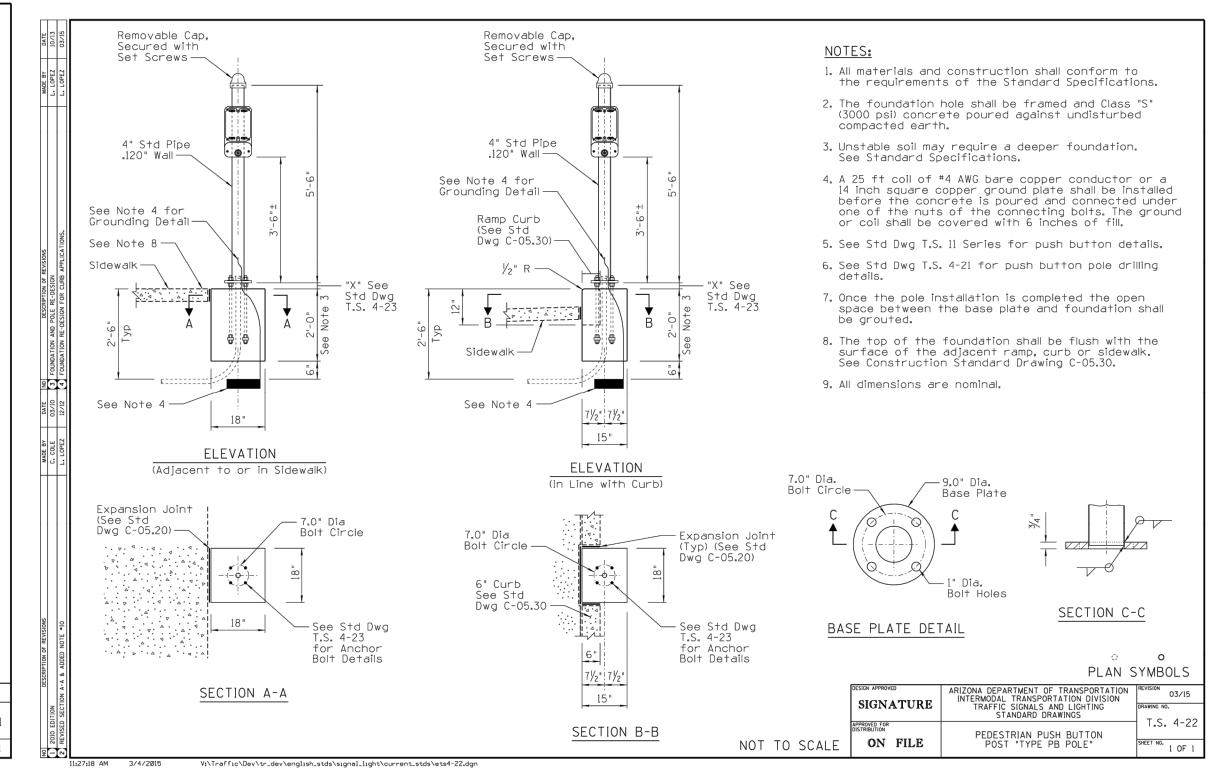

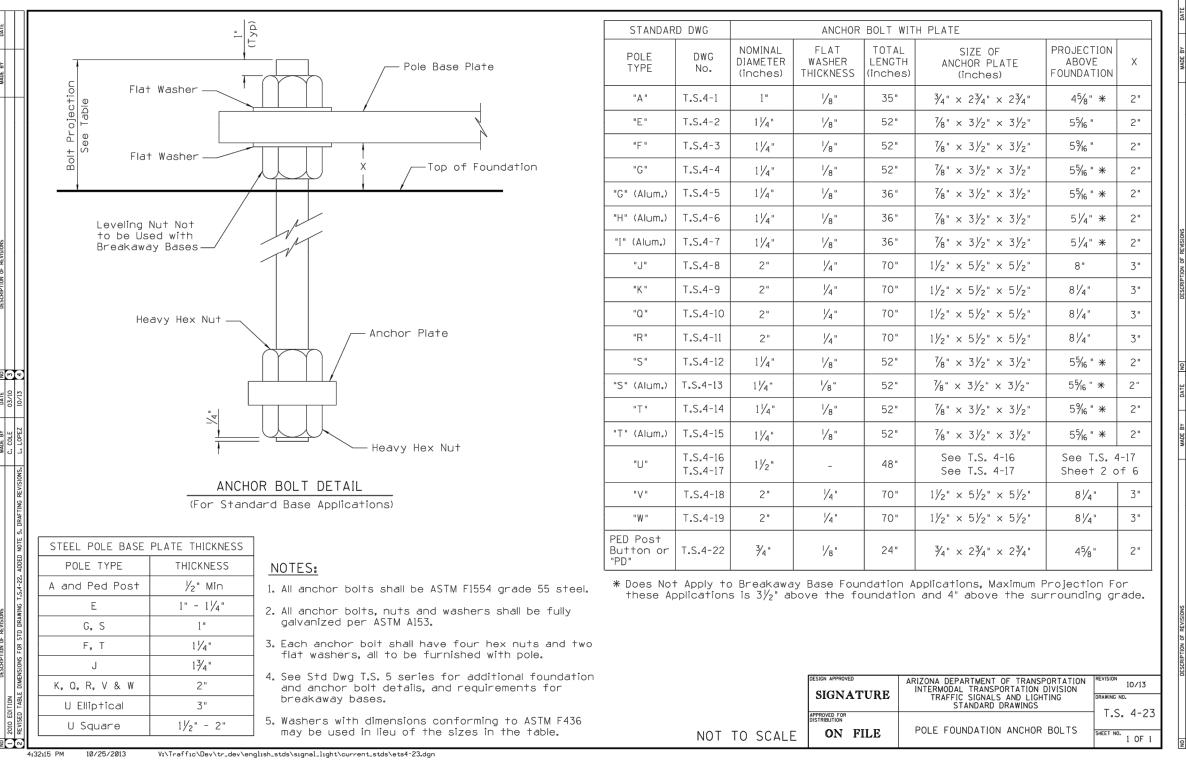

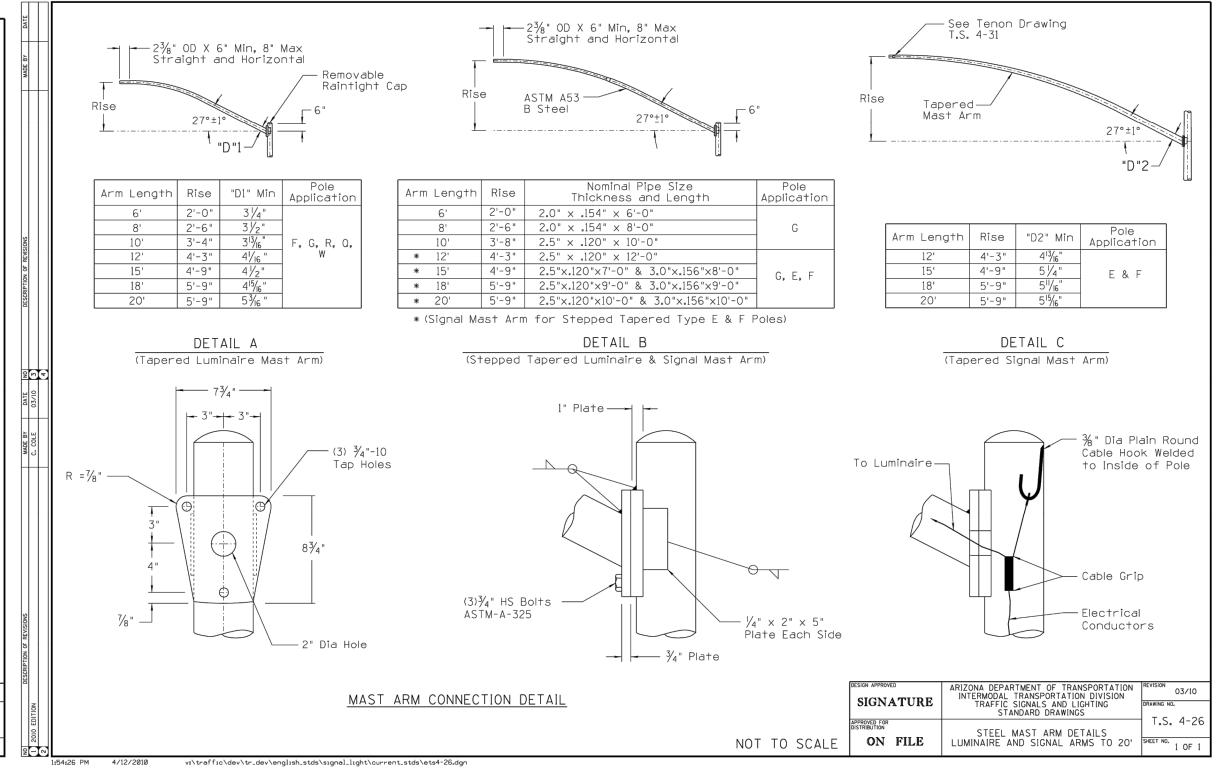





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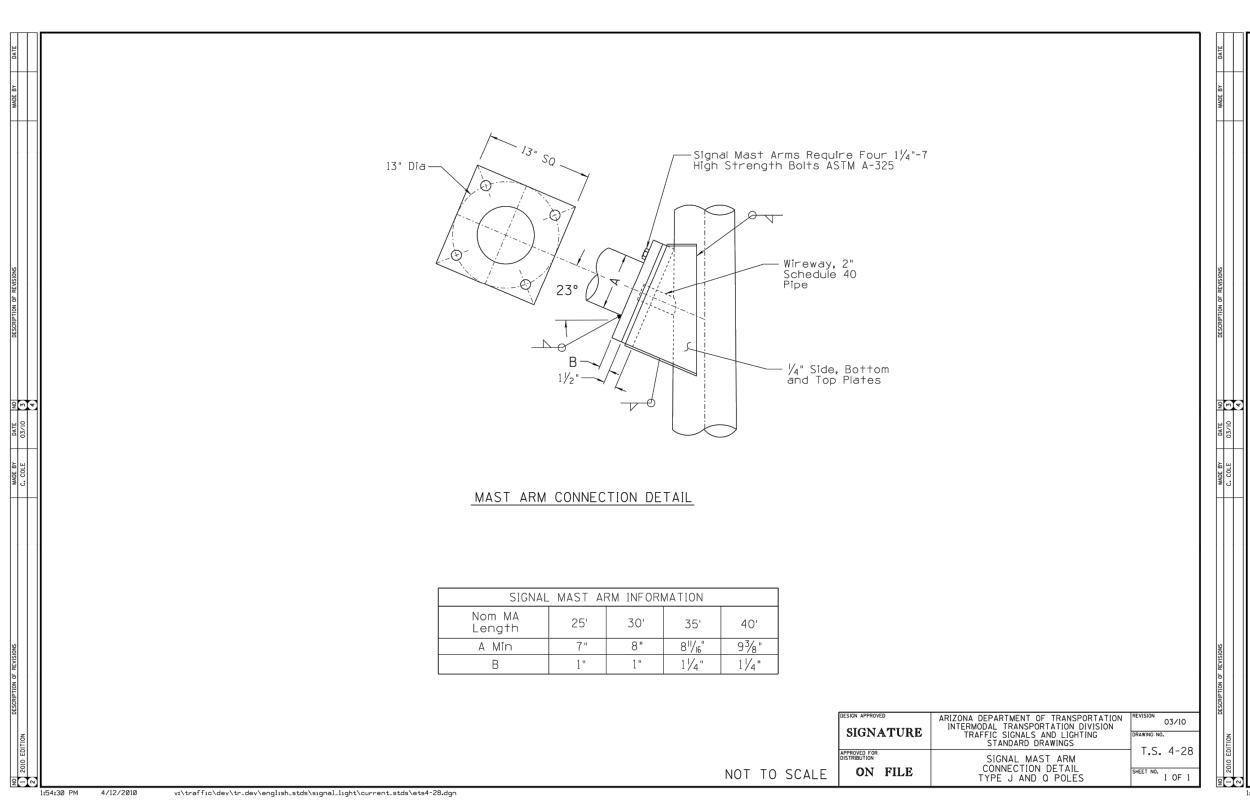



POWER ROAD: RIGGS ROAD TO CHANDLER HEIGHTS ROAD ROADWAY AND DRAINAGE IMPROVEMENTS


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. 10/03/2025







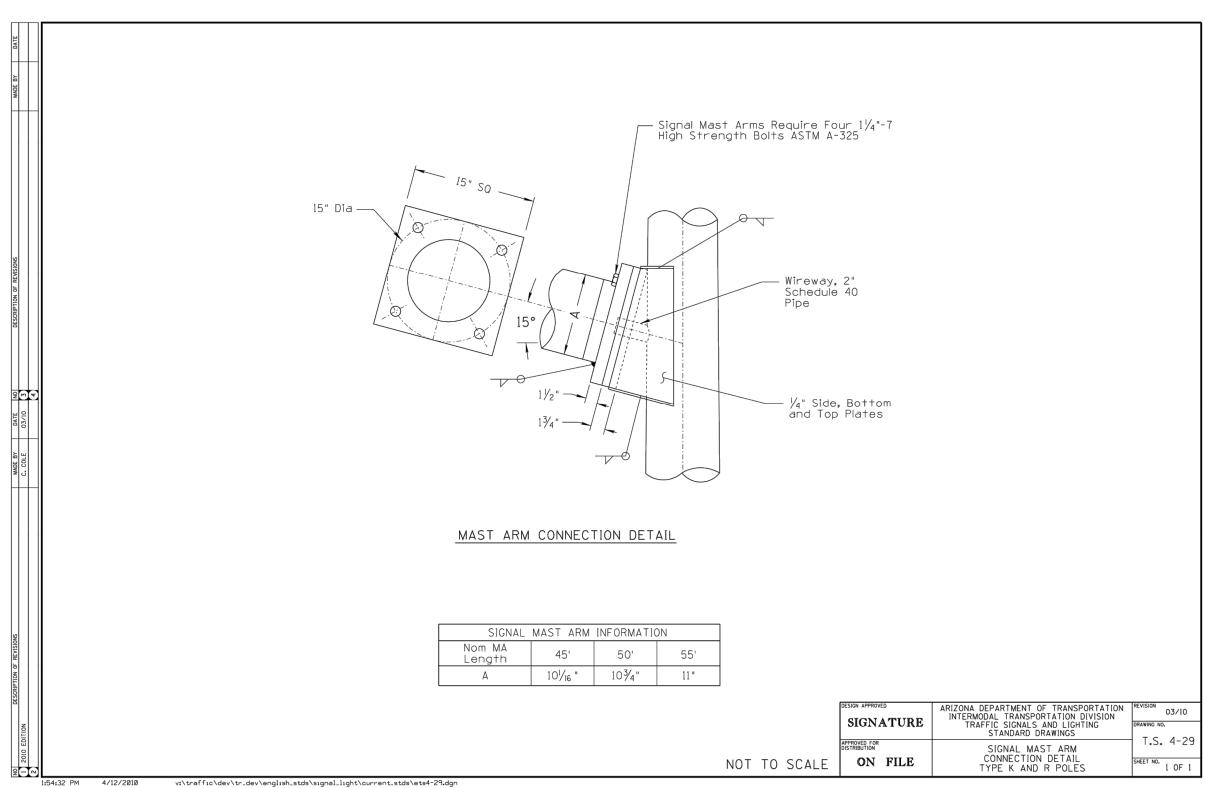

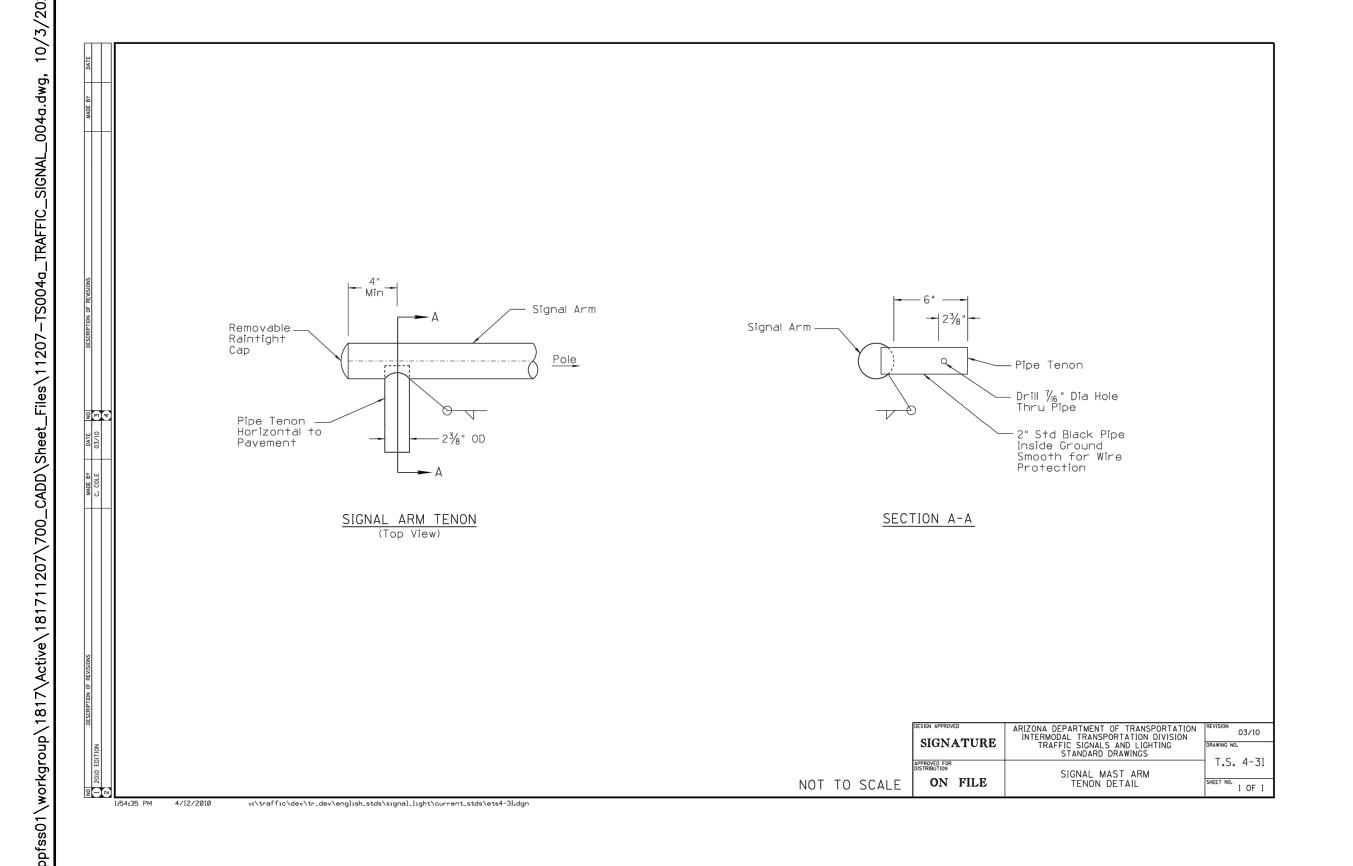

TOWN OF QUEEN CREEK




POWER ROAD:
RIGGS ROAD TO CHANDLER HEIGHTS ROAD
ROADWAY AND DRAINAGE IMPROVEMENTS

Stantec

Chandler, Arizona 85226 Tel. 480.687.6100 www.stantec.com

TRAFFIC SIGNAL DETAILS DESIGNED BY MH

SHEET 83 OF 133 CIP PROJ NO. A1405 DRAWN BY TS004c DRAWING NO.

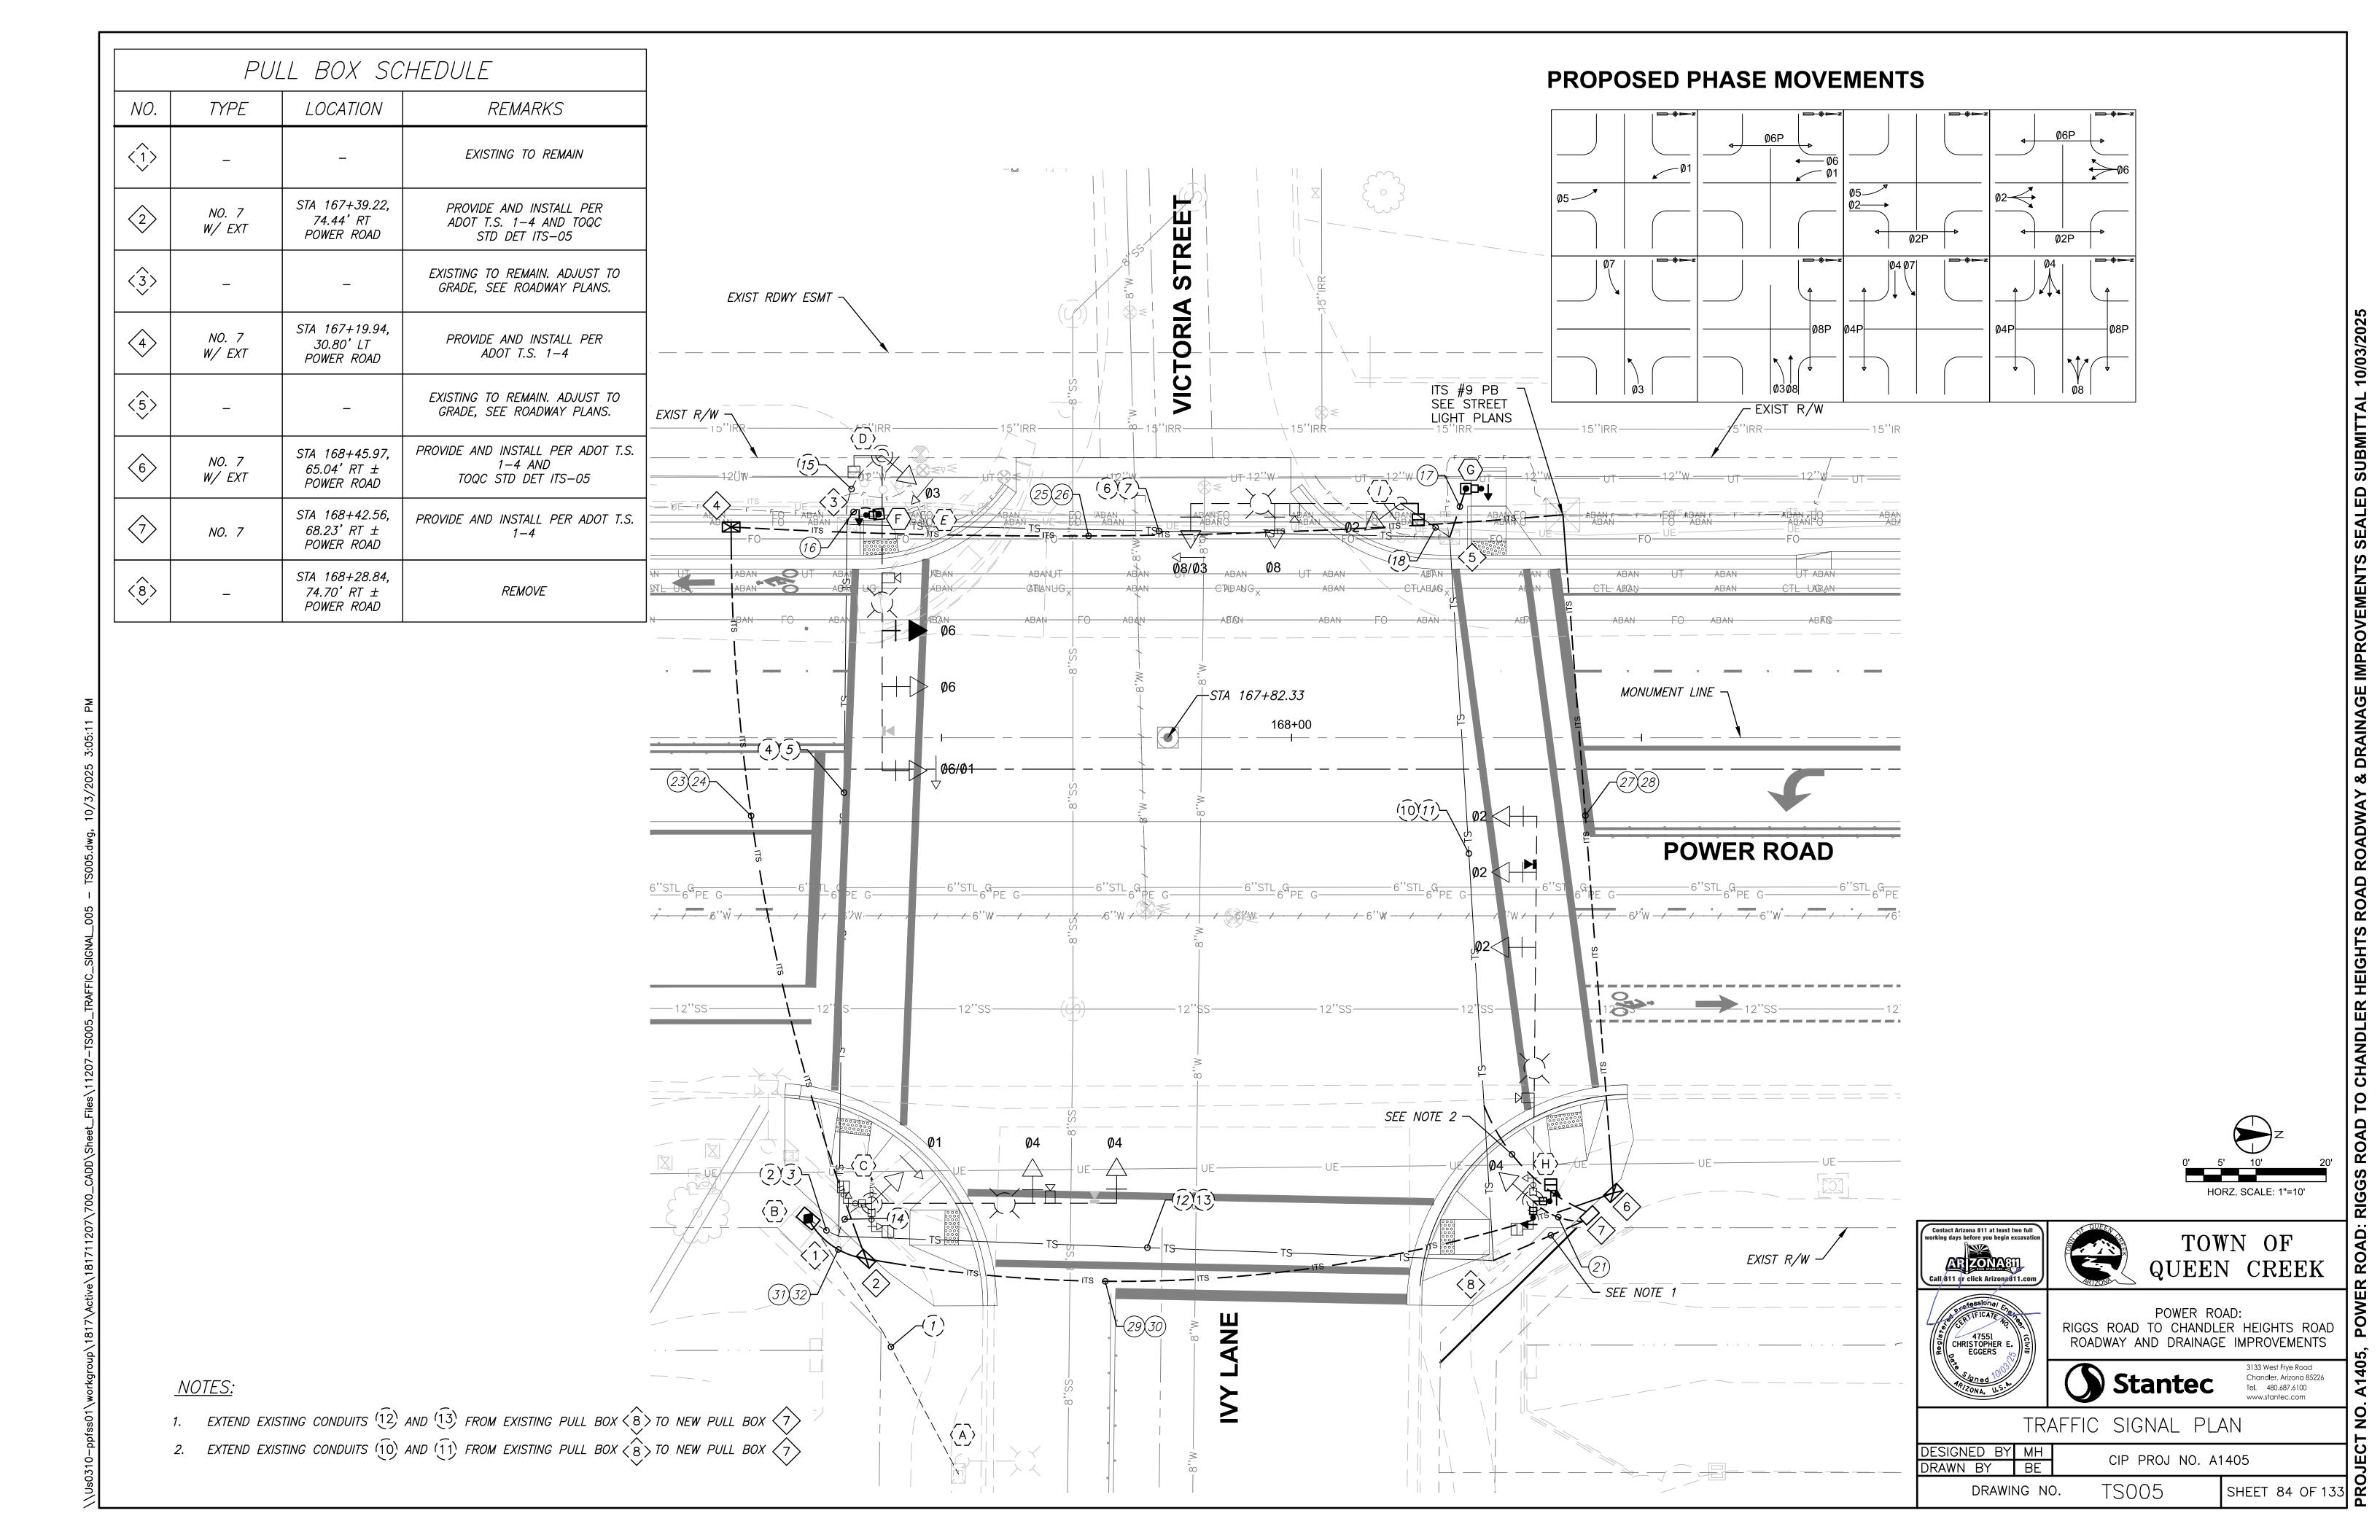

FULL SUITLUULL								
Т	RAFFIC SIGNAL	CONTROLLE	IR .				DEMARKS	
CABINET	TYPE	CON	TROLLER		AUX. CC	NTROL	REMARKS	LOCATION
(A)	-		_		-		EXISTING TO REMAIN	_
(B)	ADOT TYPE V	l .	NOLITE ATC 1 COBALT		_		NEW CONTROLLER CABINET ON EXISTING FOUNDATION. PER TOQC STD DET TS-01. INSTALL NEW BATTERY BACKUP SYSTEM. SEE TOQC AML. REMOVE AND SALVAGE EXISTING CONTROLLER CABINET.	_
POLE		MAST	ARM	SIG	NALS	P.B.	DEMARKS	LOCATION
NO.	TYPE	SIG.	LUM.	MTG.	FACE	SIGN	- REMARKS	LOCATION
(C)	_	_	_	_	_	_	1. EXISTING TRAFFIC SIGNAL POLE, MAST ARM, LUMINAIRE AND ALL OTHER FIXTURES TO REMAIN.	_
(D)   8'     -F	_	_	_	1-//	1-F	_	1. EXISTING TRAFFIC SIGNAL POLE, MAST ARM, LUMINAIRE AND ALL OTHER FIXTURES TO REMAIN, UNLESS OTHERWISE NOTED. 2. INSTALL (1) NEW TYPE F SIGNAL HEAD 3. REMOVE EXISTING VICTORIA SIGN 4. FURNISH AND INSTALL NEW BLUE IISNS	_
(E)	-	_	_	_	_	_	1. REMOVE EXISTING PUSH BUTTON POLE, FOUNDATION AND PUSH BUTTON	STA. 167+41.02, 31.9 <u>3</u> 'LT
F ↓•Φ	PB	_	_	_	_	R10-3 (R)	1. INSTALL NEW "PB" POLE PER ADOT STD DTL T.S. 4-22 2. INSTALL (1) NEW ADA PEDESTRIAN PUSH BUTTON WITH TOWN LOGO AND SIGNAGE	STA. 167+41.02, 31.93'LT
<b>G</b>	PB	_	_	_	_	R10-3 (L)	1. INSTALL NEW "PB" POLE PER ADOT STD DTL T.S. 4-22 2. INSTALL (1) NEW ADA PEDESTRIAN PUSH BUTTON WITH TOWN LOGO AND SIGNAGE	STA. 168+24.91, 35.59'LT
(H)	-	_	_	1 – VII	1-M/H* 1-M/H	R10-3 (R) R10-3 (L)	1. EXISTING TRAFFIC SIGNAL POLE, MAST ARM, LUMINAIRE AND ALL OTHER FIXTURES TO REMAIN, UNLESS OTHERWISE NOTED. 2. REMOVE EXISTING PUSH BUTTON 3. INSTALL (1) NEW M/H W/COUNTDOWN, AND REINSTALL (1) EXISTING M/H. 4. INSTALL (2) NEW ADA PEDESTRIAN PUSH BUTTON WITH TOWN LOGO & SIGNAGE	-
EVD* VDC*	_	_	_	1 – VII	1-M/H	_	1. EXISTING TRAFFIC SIGNAL POLE, MAST ARM, LUMINAIRE AND ALL OTHER FIXTURES TO REMAIN, UNLESS OTHERWISE NOTED. 2. INSTALL (1) NEW M/H W/COUNTDOWN	_

TRAFFIC SIGNAL CONDUCTOR NOTES:

- 1. IMSA 25, 7, AND 4 CONDUCTOR CABLES SHALL BE NO. 14 AWG IMSA 19-1. ALL IMSA CONDUCTORS SHALL BE SOLID.
- 2. ALL NEW WIRE (BOTH UNDERGROUND AND OVERHEAD) SHALL BE PROVIDED AND INSTALLED BY THE CONTRACTOR.
- CONTRACTOR SHALL BE RESPONSIBLE FOR PROVIDING MULTI-COLORED CONDUCTORS WHICH MEET THE COLOR CODING IDENTIFIED IN TOWN OF QUEEN CREEK STANDARD DETAIL TS-02.
- 4. WHEN SPLICING 25 CONDUCTOR CABLES IN PULL BOXES, ONLY THOSE CONDUCTORS THAT WILL BE UTILIZED IN THE SPECIFIC PULL BOX ARE TO BE CUT. ALL OTHER CONDUCTORS SHALL RUN THROUGH THE PULL BOX UNCUT. 25 CONDUCTOR SHALL RUN CONTINUOUSLY FROM CONTROLLER CABINET THROUGH ALL PULL BOXES.
- INSTALL NO. 8 BARE BOND IN ALL EMPTY CONDUITS.

→ 18400 E

ALL LUMINAIRES AND ILLUMINATED STREET NAME SIGNS SHALL HAVE SEPARATE FUSES INSTALLED IN PULL BOXES AT THE BASE OF THE POLE.

Front

<u></u> 24830 S

18400 E

- ALL PULL BOXES AND LIDS SHALL BE "CHRISTY FIBERLITE". LIDS SHALL BE PROVIDED WITH LOCKING DEVICES AND APPROPRIATE WORDING ON LIDS "TRAFFIC SIGNAL".
- 8. WHEN INSTALLING TWO PEDESTRIAN SIGNAL HEADS ON ONE SUPPORT POLE, A 4 CONDUCTOR CABLE SHALL BE RAN TO EACH SIGNAL HEAD.
- 9. SPLICES IN PULL PULL BOXES SHALL BE MADE WITH IDEAL (OR APPROVED EQUAL) SILICONE FILLED WIRE NUTS.
- 10. CONTRACTOR SHALL USE COLORED TAPE TO CODE ALL TRAFFIC SIGNAL CONDUCTOR CABLES, EMERGENCY VEHICLE PRE-EMPTION CABLES, AND VIDEO DETECTION CABLES IN EACH PULL BOX PER TOWN OF QUEEN CREEK STANDARD DETAIL TS-03.
- 11. SPLICING OF CONDUCTORS SHALL NOT BE ALLOWED INSIDE CONDUITS.
- 12. ALL SIGNAL COMMON'S SHALL BE CRIMPED OR SPLIT BOLT.

### TRAFFIC SIGNAL ITS NOTES:

- 1. THE CONTRACTOR SHALL PROVIDE AND INSTALL (1) CCTV CAMERA AT THE LOCATION INDICATED ON THE PLANS. CATSE CABLE SHALL RUN UN-SPLICED FROM THE CAMERA TO THE CONTROLLER CABINET. CONTRACTOR SHALL PROVIDE (1) SPARE CCTV CAMERA WITH MOUNTING BRACKET AND SURGE PROTECTION SHALL BE PROVIDED TO THE TOWN.
- THE CONTRACTOR SHALL PROVIDE (1) 12 SMFO GATOR PATCH CABLE THAT EXTENDS FROM THE NEAREST NO. 9 PULL BOX TO THE CONTROLLER CABINET, WITH (2) FIBER OPTIC GEL SPLICE CLOSURE.
- 3. THE CONTRACTOR SHALL PROVIDE AND INSTALL (1) ARID DEVICE (BLUETOAD) WITH ETHERNET COMM.
- 4. THEN CONTRACTOR SHALL PROVIDE (1) ETHERNET SWITCH.
- 5. SURGE PROTECTION IS REQUIRED FOR THE CCTV CAMERA AND RADIOS.
- 6. THE CONTRACTOR SHALL DELIVER THE CCTV CAMERA, WIRELESS RADIO, AND ETHERNET SWITCH TO THE TOQC TRAFFIC DEPARTMENT (480-358-3132) FOR CONFIGURATION A MINIMUM OF 10 WORKING DAYS PRIOR TO INSTALLATION.
- PRIOR TO INSTALLATION OF ANY ITS DEVICES EITHER ON THE POLE OR IN THE CONTROLLER CABINET, THE CONTRACTOR SHALL CONTACT THE TOQC TRAFFIC DEPARTMENT AT 480-358-3132 FOR APPROVAL OF INSTALLATION LOCATION.
- 8. ALL #9 VAULT LIDS SHALL BE INSCRIBED "QUEEN CREEK FIBER OPTIC"
- MATERIALS, WORKMANSHIP SHALL ADHERE TO THE REQUIREMENTS OF THE TOWN OF QUEEN CREEK TRAFFIC APPROVED MATERIAL LIST.

### Front Power Rd Victoria st Back Back Power Rd Victoria st (BLUE IISNS) (D) 24830 S -> 18400 E <del>---</del> Front Front Power Rd VY Lane Back Back Power Rd INTERNALLY ILLUMINATED STREET SIGN DETAIL

### CONDUCTOR SCHEDULE

	CONDUIT RUN NUMBERS	(1)	(2)	(3)	(4)	(5)	$(\widehat{6})$	(7)	8 (	9	(10) (1	1) (12	) (13)	(14)	(15)	16)	17	18)	19	20	21	22	23	24	25)	26	27	28	29	30 (	31 32
	CONDUIT SIZE IN INCHES	Ε	Ε	Ε	Ε	Ε	Ε	Ε			Ε	ΕΕ	Ε	Ε	Ε	2	2	Ε			3		3	3	3	3	3	3	3	3	3 3
	#14, IMSA 19-1, 25 CONDUCTOR		2		2		2				2	2																			
SIGNAL HEADS	#14, IMSA 19-1, 7 CONDUCTOR									] ۾									9	<u>a</u> [	1	$Q_{i}$									
PUSH BUTTONS	#14, IMSA 19-1, 4 CONDUCTOR								is	USE					1	2	1	1	USE	USED	7	USE									
	#8, WHITE THW, COMMON, STRANDED				1		1		$\vdash$	$\perp$	1	1 1																			
	#8, GREEN THW		1		1	1	1	•		8	1	1 1	1		1	1	1	1	NOT	NO1	1	NOT	1	1	1	1	1	1	1	1	1 1
LUMINAIRES (120V)	#10, BLACK XHHW, RED				1		1		NUMBER	1BER	1	1							3ER	NUMBER	1	3ER									
LOWINAINES (1207)	#10, WHITE XHHW				1		1	;	ME	ME [	1	1							NUMBER	JME	1	NUMBEI									
INTERNALLY ILLUMINATED STREET	#10, BLACK XHHW, BROWN				1		1			N	1	1									1	M									
NAME SIGNS (IISNS)									RUN	<i>RU</i> №									<u>}</u>	RUN		Nn.									
	#6 (120/240)								.	.									7			T R									
SERVICE	#10 (120/240)							:	ONDUIT	CONDUIT									INDANO	CONDUIT		INDUN									
	#12 (120/240)								Š	§ [									NO	ŏ.		NO.									
PRE-EMPTION	DETECTOR CABLE			3		2		1 '					1						0	0	1										
OTHER	#8 BARE BOND(ONLY IN EMPTY CONDUIT)																														
OTTEN	VIDEO DETECTION CABLE**			3		2		1					1								1								, l		

<sup>\*\*</sup> AUTOSCOPE CABLE, 3 CONDUCTOR, 18AWG, 600V, POLYETHYLENE JACKET, CONDUIT RATE

*VDC* = *VIDEO DETECTION CAMERA* SIGNAL MAST ARM

LMA = LUMINAIRE MAST ARM

EVD = EMERGENCY VEHICLE DETECTION

CCTV = DOME PTZ CAMERA

IISNS = INTERNALLY ILLUMINATED STREET NAME SIGN WRA = WIRELESS RADIO/ANTENNA

\* = EXISTING

AML = APPROVED MATERIAL LIST



Contact Arizona 811 at least two full

### TOWN OF QUEEN CREEK

POWER ROAD: RIGGS ROAD TO CHANDLER HEIGHTS ROAD ROADWAY AND DRAINAGE IMPROVEMENTS

Stantec


TRAFFIC SIGNAL EQUIPMENT SHEET

DESIGNED BY MH CIP PROJ NO. A1405

> TS006 DRAWING NO.

SHEET 85 OF 133

Tel. 480.687.6100

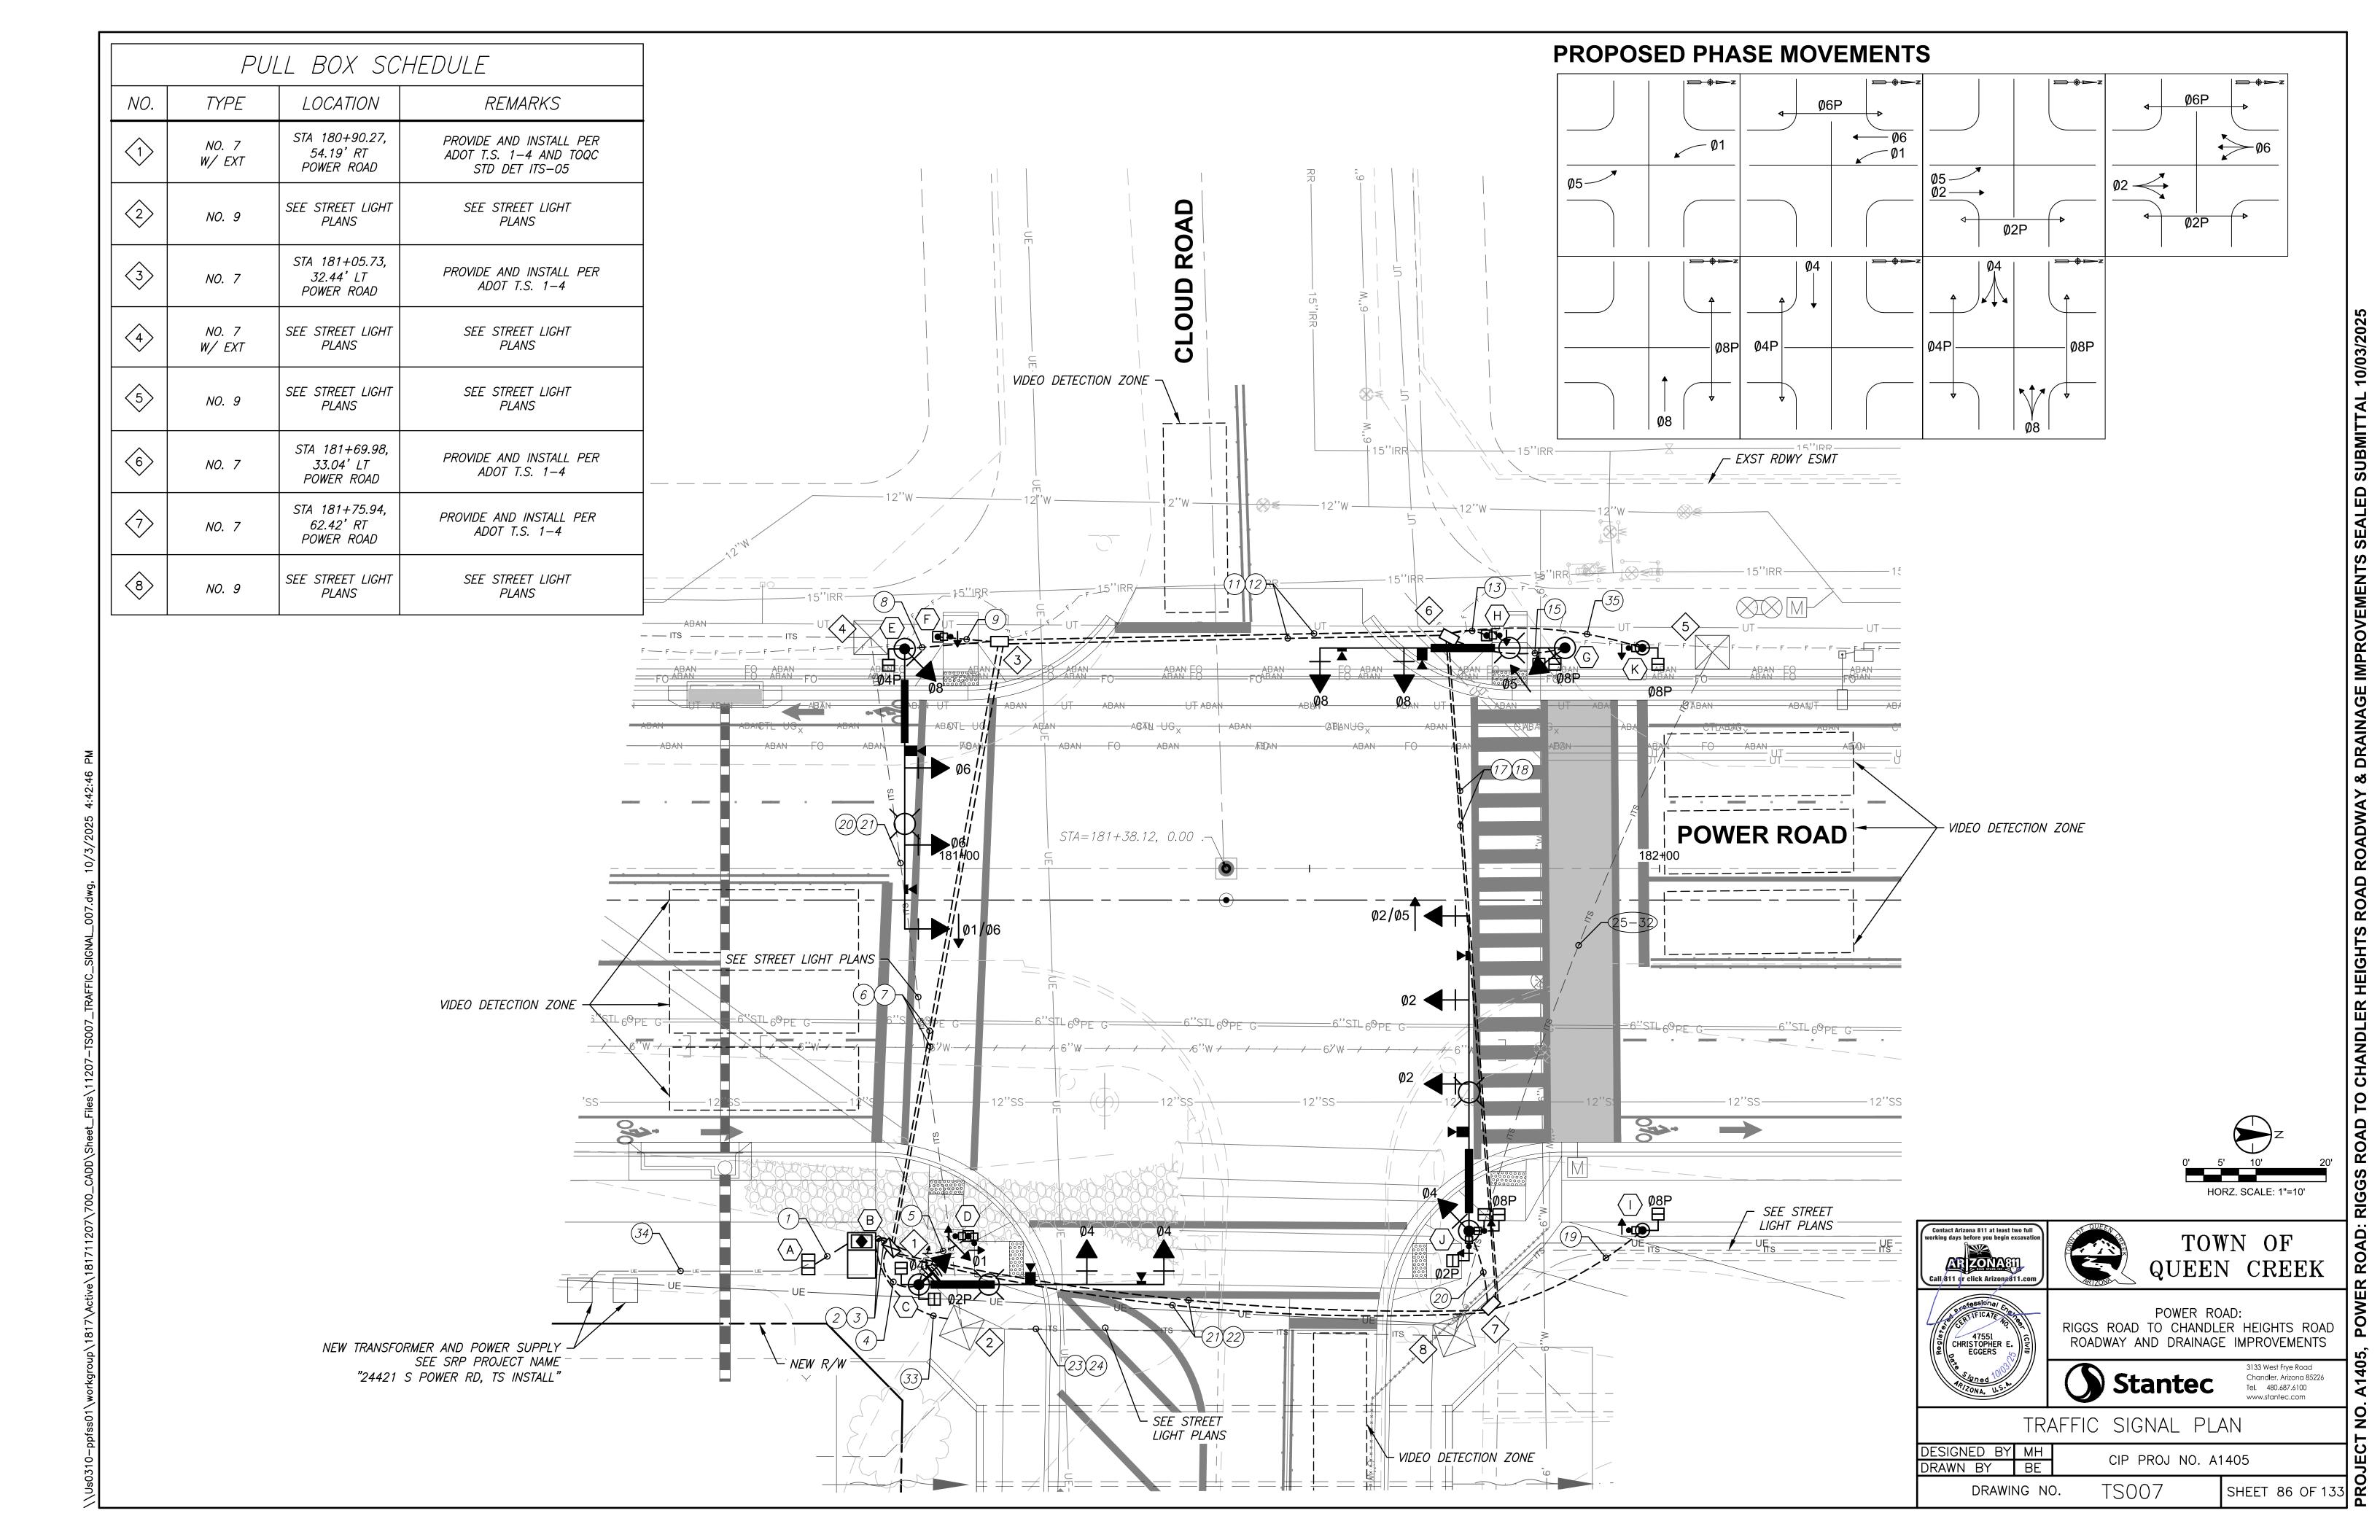

TRAFFIC SIGNAL CONTROLLER

NOTE: TYPE G SIGNAL HEADS SHALL HAVE 12" GREEN/YELLOW BI-MODAL ARROW

12

TRAFFIC SIGNAL CONDUCTOR NOTES:


IMSA 25, 7, AND 4 CONDUCTOR CABLES SHALL BE NO. 14 AWG IMSA 19-1. ALL IMSA CONDUCTORS SHALL BE SOLID.

- ALL NEW WIRE (BOTH UNDERGROUND AND OVERHEAD) SHALL BE PROVIDED AND INSTALLED BY THE CONTRACTOR.
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- WHEN SPLICING 25 CONDUCTOR CABLES IN PULL BOXES, ONLY THOSE CONDUCTORS THAT WILL BE UTILIZED IN THE SPECIFIC PULL BOX ARE TO BE CUT. ALL OTHER CONDUCTORS SHALL RUN THROUGH THE PULL BOX UNCUT. 25 CONDUCTOR SHALL RUN CONTINUOUSLY FROM CONTROLLER CABINET THROUGH ALL PULL BOXES.
- INSTALL NO. 8 BARE BOND IN ALL EMPTY CONDUITS.
- ALL LUMINAIRES AND ILLUMINATED STREET NAME SIGNS SHALL HAVE SEPARATE FUSES INSTALLED IN PULL BOXES AT THE BASE OF THE POLE.

- ALL PULL BOXES AND LIDS SHALL BE "CHRISTY FIBERLITE". LIDS SHALL BE PROVIDED WITH LOCKING DEVICES AND APPROPRIATE WORDING ON LIDS "TRAFFIC SIGNAL".
- WHEN INSTALLING TWO PEDESTRIAN SIGNAL HEADS ON ONE SUPPORT POLE, A 4 CONDUCTOR CABLE SHALL BE RAN TO EACH SIGNAL HEAD.
- SPLICES IN PULL PULL BOXES SHALL BE MADE WITH IDEAL (OR APPROVED EQUAL) SILICONE FILLED WIRE NUTS.
- CONTRACTOR SHALL USE COLORED TAPE TO CODE ALL TRAFFIC SIGNAL CONDUCTOR CABLES, EMERGENCY VEHICLE PRE-EMPTION CABLES, AND VIDEO DETECTION CABLES IN EACH PULL BOX PER TOWN OF QUEEN CREEK STANDARD DETAIL TS-03.
- 11. SPLICING OF CONDUCTORS SHALL NOT BE ALLOWED INSIDE CONDUITS
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### TRAFFIC SIGNAL ITS NOTES.

- 1. THE CONTRACTOR SHALL PROVIDE AND INSTALL (1) CCTV CAMERA AT THE LOCATION INDICATED ON THE PLANS. CATSE CABLE SHALL RUN UN-SPLICED FROM THE CAMERA TO THE CONTROLLER CABINET. CONTRACTOR SHALL PROVIDE (1) SPARE CCTV CAMERA WITH MOUNTING BRACKET AND SURGE PROTECTION SHALL BE PROVIDED TO THE TOWN.
- THE CONTRACTOR SHALL PROVIDE (1) 12 SMFO GATOR PATCH CABLE THAT EXTENDS FROM THE NEAREST NO. 9 PULL BOX TO THE CONTROLLER CABINET, WITH (2) FIBER OPTIC GEL SPLICE CLOSURE.
- 3. THE CONTRACTOR SHALL PROVIDE AND INSTALL (1) ARID DEVICE (BLUETOAD) WITH ETHERNET COMM.
- 4. THEN CONTRACTOR SHALL PROVIDE (1) ETHERNET SWITCH.
- 5. SURGE PROTECTION IS REQUIRED FOR THE CCTV CAMERA AND RADIOS.
- THE CONTRACTOR SHALL DELIVER THE CCTV CAMERA, WIRELESS RADIO, AND ETHERNET SWITCH TO THE TOQC TRAFFIC DEPARTMENT (480-358-3132) FOR CONFIGURATION A MINIMUM OF 10 WORKING DAYS PRIOR TO INSTALLATION.
- PRIOR TO INSTALLATION OF ANY ITS DEVICES EITHER ON THE POLE OR IN THE CONTROLLER CABINET, THE CONTRACTOR SHALL CONTACT THE TOQC TRAFFIC DEPARTMENT AT 480-358-3132 FOR APPROVAL OF INSTALLATION LOCATION.
- 8. ALL #9 VAULT LIDS SHALL BE INSCRIBED "QUEEN CREEK FIBER OPTIC"
  - MATERIALS, WORKMANSHIP SHALL ADHERE TO THE REQUIREMENTS OF THE TOWN OF QUEEN CREEK TRAFFIC APPROVED MATERIAL LIST.

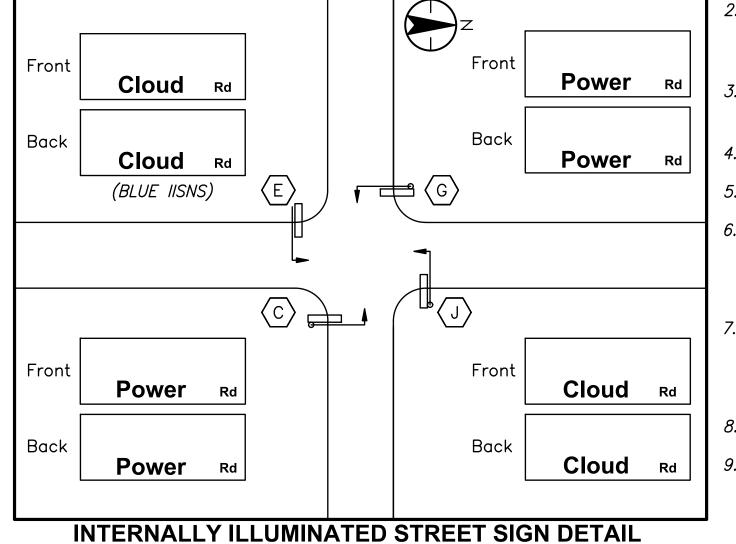

CONDUCTOR SCHEDULE

	CONDUIT RUN NUMBERS	1	2 3	) 4	(5)	6 7	) (8)	9	10	11)	12	13)(	14 (1	5) (16)	17	18	19	20	21	22 (	23	24	25)	26	27	28	29	30 (	31 (3	) (33	3) (34	<u>J</u> ) (3:
	CONDUIT SIZE IN INCHES	2 1/2	3 3	3	2	3 3	3	2		3	3	2		3	3	3	2	3	3	3	3	3	1 1/4		1 1/4	_		_	1/4 1 3		2 1/	<b>2</b> 2
	#14, IMSA 19-1, 25 CONDUCTOR		2			2				2					2				2													
SIGNAL HEADS	#14, IMSA 19-1, 7 CONDUCTOR			2			2		] ۾ [				$a \perp$	2 9				2														
SIGNAL HEADS	#14, IMSA 19-1, 4 CONDUCTOR			2	2		2	1	]    - 			1	USE  -	USED			2	7														2
	#8, WHITE THW, COMMON		1	1	1	1	1	1	]	1		1	, <u> </u>	1			1	1	1													1
	#8, GREEN THW		1	1	1	1	1	1	<b>8</b>	1		1	8	1 8			1	1	1													1
LUMINAIRES (120V)	#10, BLACK THW, RED		1	1		1	1		] ER		1		ER	1 23	1			1		1												
LOMINAINES (1207)	#10, WHITE THW		1	1		1	1		] WB [		1		JME	T T T NUMBER	1			1		1												
INTERNALLY ILLUMINATED STREET	#10, BLACK THW, BROWN		1	1		1	1		] 🕺 [		1		≥ [	1 ≥	1			1		1												
NAME SIGNS (IISNS)									RUN				<u></u>	§																		
	#6 (120/240)	2							┧╷				7 F																			
SERVICE	<i>#10 (120/240)</i>	2							INGNO																							
	#12 (120/240)	3											<i>™</i> _																			
PRE-EMPTION	DETECTOR CABLE		4	1		2	1		S	1				1				1	1													
OTHER	#8 BARE BOND (ONLY IN EMPTY CONDUIT)	)														1					1											
OTTEN	VIDEO DETECTION CABLE*		4	1		2	1			1				1				1	1													

10. INSTALL NEW BIKE ASSEMBLY (BS)—SEE SHEET TS004 FOR DETAILS

*VDC* = *VIDEO DETECTION CAMERA* SMA = SIGNAL MAST ARM

LMA = LUMINAIRE MAST ARMEVD = EMERGENCY VEHICLE DETECTION CCTV = DOME PTZ CAMERA

IISNS = INTERNALLY ILLUMINATED STREET NAME SIGN

WRA = WIRELESS RADIO/ANTENNA \* = EXISTING

APPROVED MATERIAL LIST AML =



Contact Arizona 811 at least two full



47551 CHRISTOPHER E.

POWER ROAD: RIGGS ROAD TO CHANDLER HEIGHTS ROAD ROADWAY AND DRAINAGE IMPROVEMENTS

Stantec

TRAFFIC SIGNAL EQUIPMENT SHEET

DESIGNED BY MH CIP PROJ NO. A1405 DRAWN BY


> TS008 DRAWING NO.

SHEET 87 OF 133

Chandler, Arizona 85226

Tel. 480.687.6100

### TOWN OF QUEEN CREEK C.I.P PROJECT NO. A I 405 POWER ROAD: CHANDLER HEIGHTS ROAD TO RIGGS ROAD STREET LIGHTING AND ITS PLANS

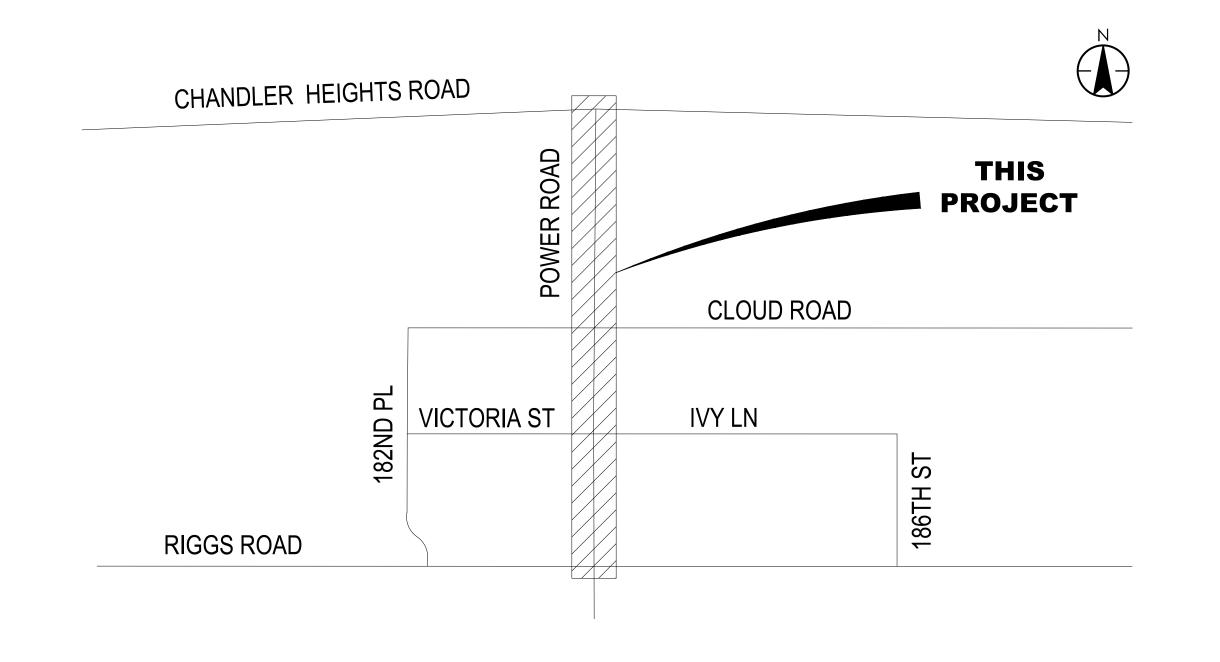

### GENERAL NOTE


- ALTERNATIVES SHALL BE PRE-APPROVED BY THE TRANSPORTATION DIRECTOR. APPROVAL OF ALTERNATIVE PRODUCTS SHALL BE ON AN EQUAL BASIS WITH THE PRODUCT SPECIFIED AND SHALL BE SUBMITTED A MINIMUM OF TEN (10) DAYS PRIOR TO BID OPENING. STRUCTURAL CALCULATIONS SHALL BE FURNISHED FOR ALTERNATE PRODUCTS AND CERTIFIED BY A STRUCTURAL ENGINEER, REGISTERED IN THE STATE OF ARIZONA. LUMINAIRES AND LAMPS SHALL MEET OR EXCEED THE PHOTOMETRIC, ELECTRICAL, AND MECHANICAL REQUIREMENTS FOR THE SPECIFIED PRODUCTS.
- 2. THE SUBMITTAL PACKAGE SHALL CONSIST OF THREE (3) COPIES OF THE SPECIFICATIONS FOR MATERIALS AND EQUIPMENT TO BE FURNISHED AND INSTALLED, AND SHALL BE BOUND IN A FOLDER AND SUBMITTED AT THE TIME OF PERMIT APPLICATION.
- 3. THE ELECTRICAL CONTRACTOR SHALL COMPLY WITH ALL LICENSING REQUIREMENTS SET FORTH BY THE STATE REGISTRAR OF CONTRACTORS' OFFICE TO PERFORM WORK RELATING TO STREETLIGHT INSTALLATION IN THE TOWN RIGHT-OF-WAY.
- 4. THE CONTRACTOR SHALL OBTAIN ALL REQUIRED PERMITS PRIOR TO THE INSTALLATION OF STREET LIGHTING.


### WARRANTY:


THE CONTRACTOR SHALL GUARANTEE ALL WORK FOR A PERIOD OF ONE YEAR FROM THE DATE OF FINAL ACCEPTANCE BY THE ENGINEERING MANAGER, AGAINST IMPERFECT WORKMANSHIP, FAILURE, MALFUNCTION OF MATERIALS AND/OR EQUIPMENT DUE TO FAULTY OR IMPERFECT WORKMANSHIP. THIS GUARANTEE IS TO BE IN WRITING TO THE TOWN AT THE TIME OF ISSUING FINAL ACCEPTANCE. WORK FOUND TO BE DEFECTIVE WITHIN THE WARRANTY PERIOD SHALL BE REPLACED WITHOUT COST TO THE TOWN.


	LIGHTING FIXTURE SCHEDULE								
SYMBOL	TYPE	DESCRIPTION	FIXTURE TYPE	VOLTS	WATTAGE	MANUFACTURER CATALOG No.	REMARKS		
	Q1	EVOLVE LED STREET LAMP FOR USE WITH 12500 LUMENS PACKAGE. BRONZE FINISH. TOOL—LESS ENTRY. 10kA SURGE PROTECTION.	LED	120-277V	125	GE LIGHTING ERLH-0-13-C3-30-A-DKBZ-GLRX-(LABEL) OR APPROVED EQUAL	POLE PER QUEEN CREEK ARTERIAL STREET LIGHTING STANDARDS. LIGHT FIXTURE SHALL BE LABELED PER QUEEN CREEK STANDARDS.		

SHE	ET INDEX
SHEET NUMBER	SHEET NAME
SL001	STREET LIGHT PLANS COVER SHEET
SL002	STREET LIGHT PLANS
SL003	STREET LIGHT PLANS
SL004	STREET LIGHT PLANS
SL005	STREET LIGHT PLANS
SL006	STREET LIGHT DETAILS
SL007	STREET LIGHT DETAILS
SL008	STREET LIGHT DETAILS
SL009	ITS DETAIL
SL010	ITS DETAIL

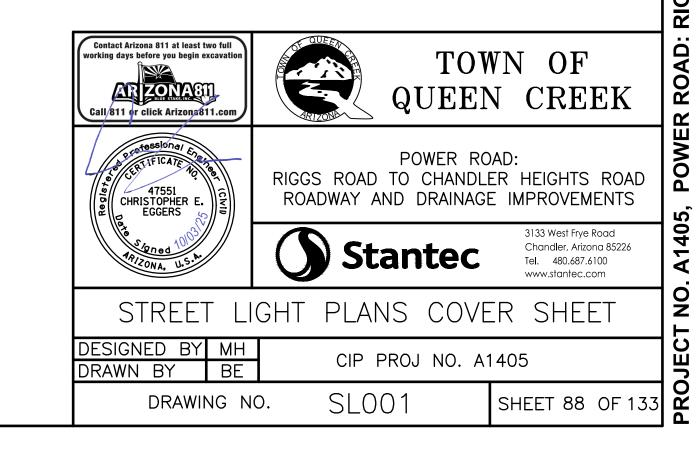

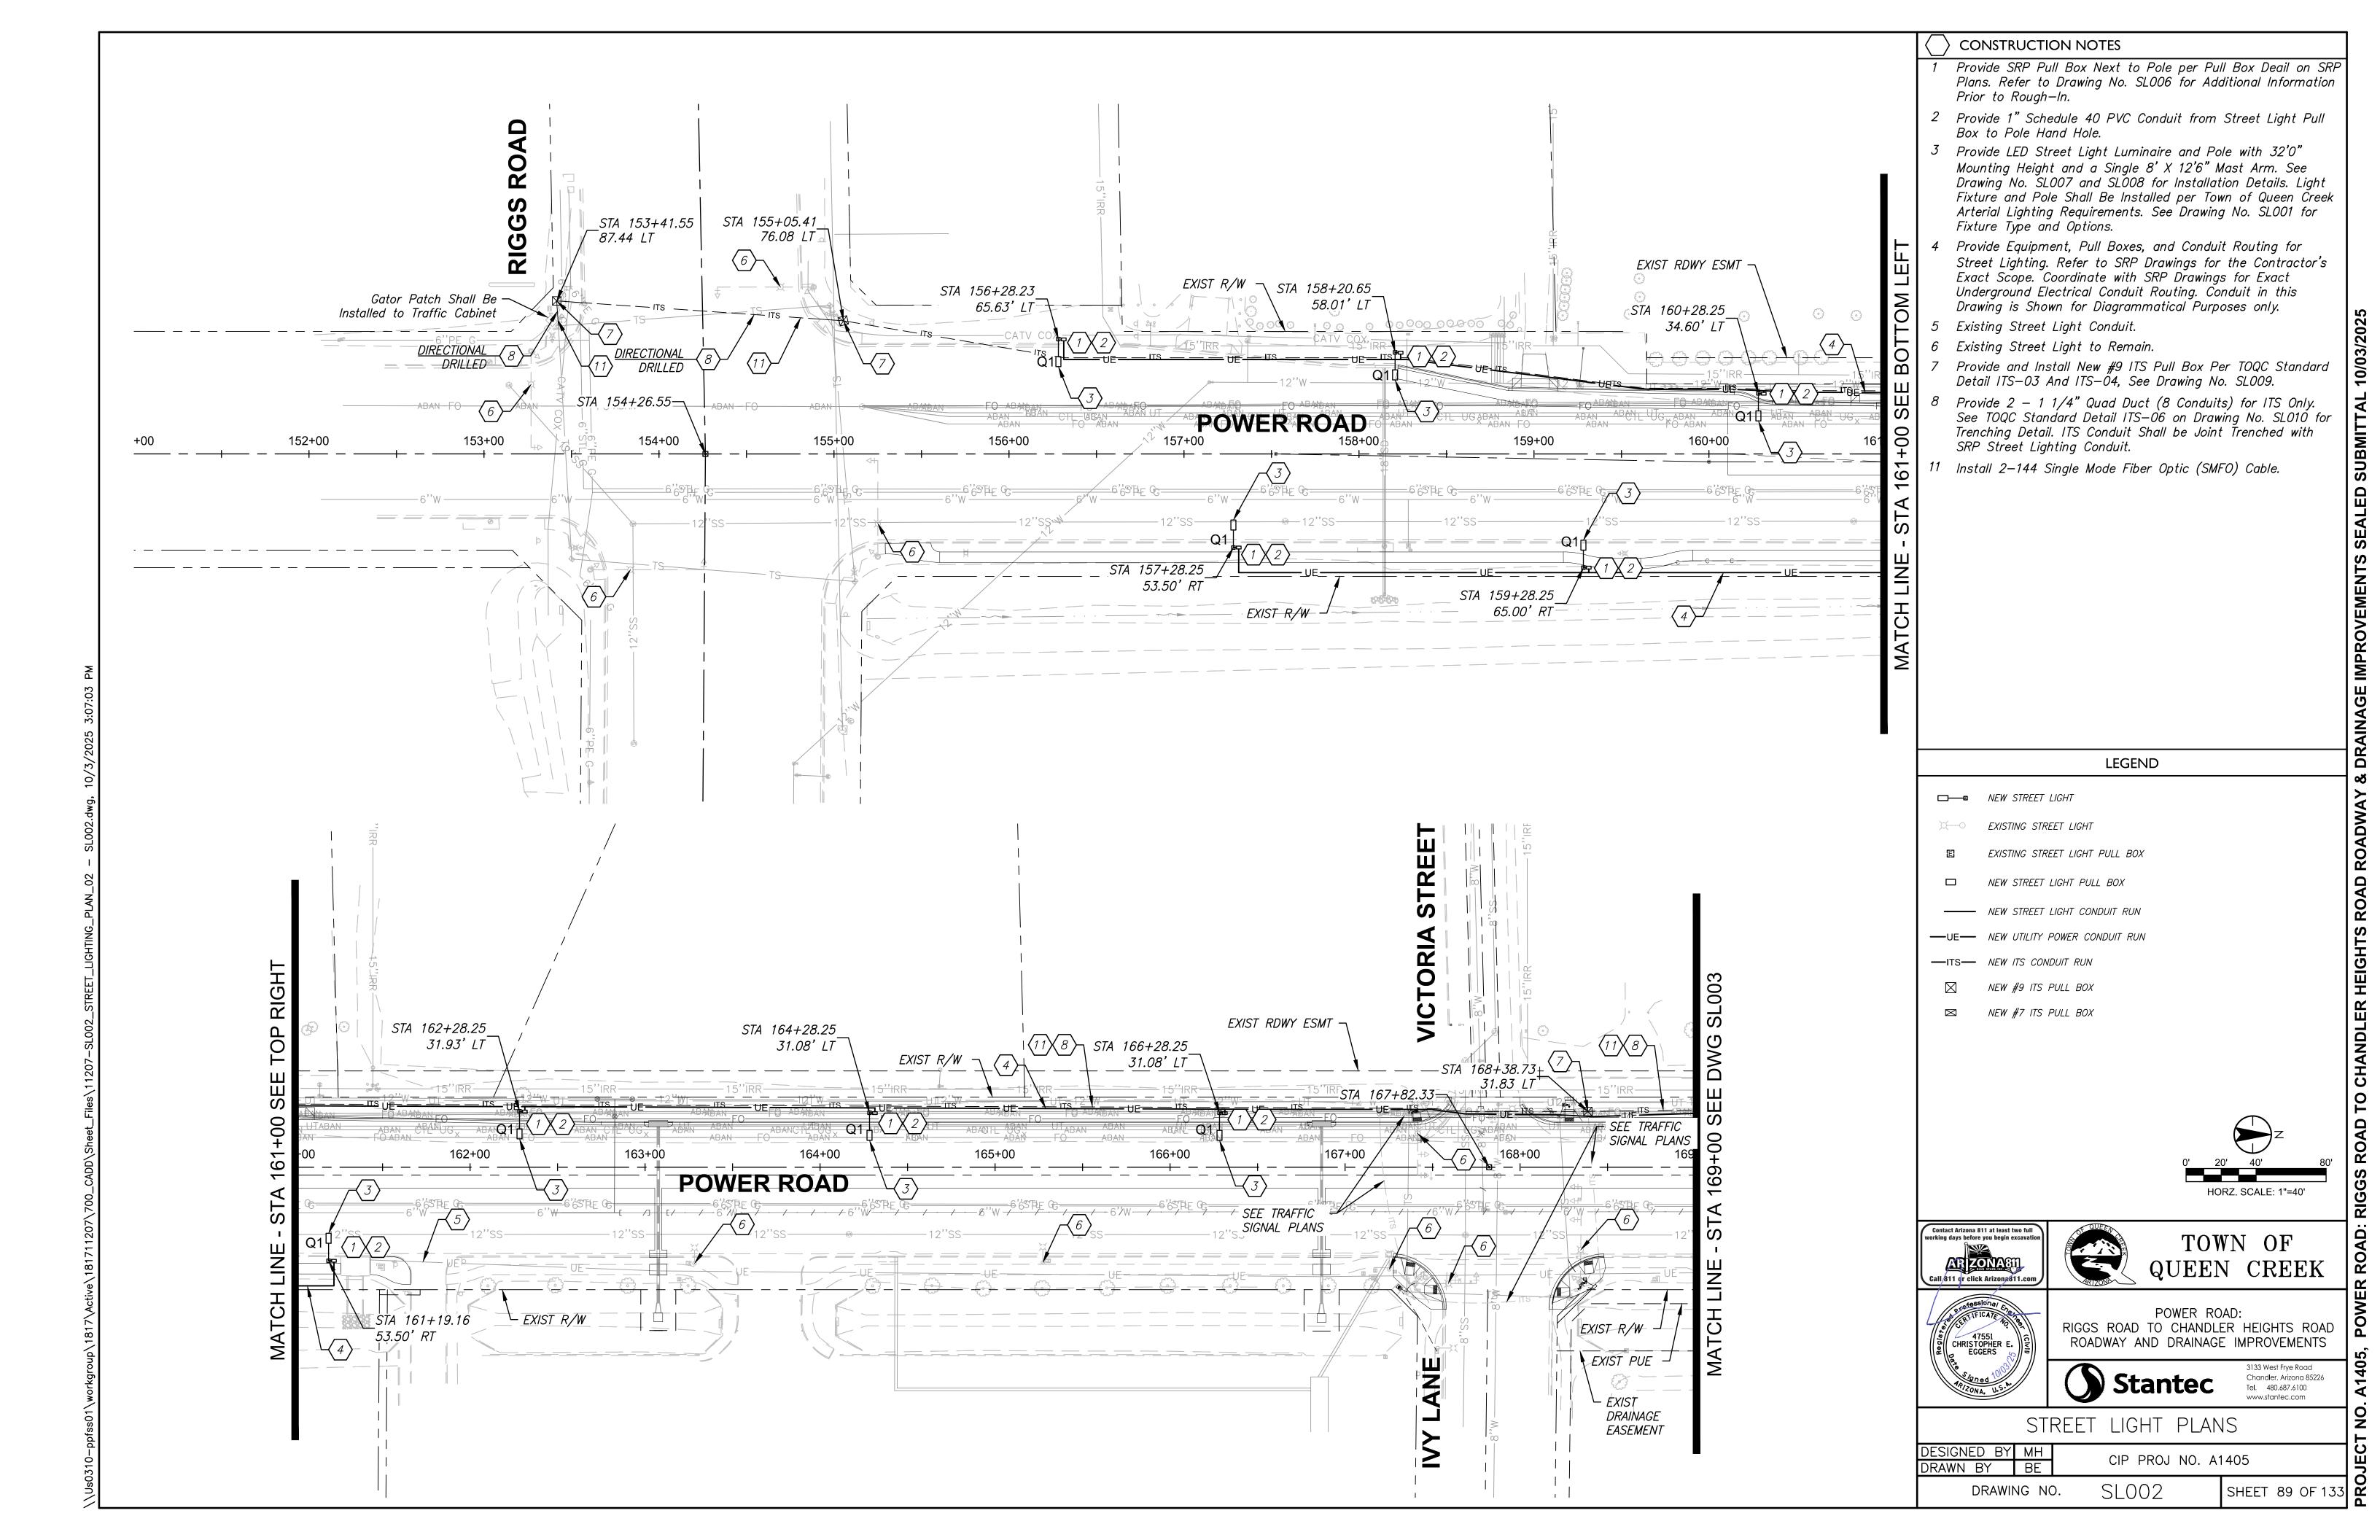

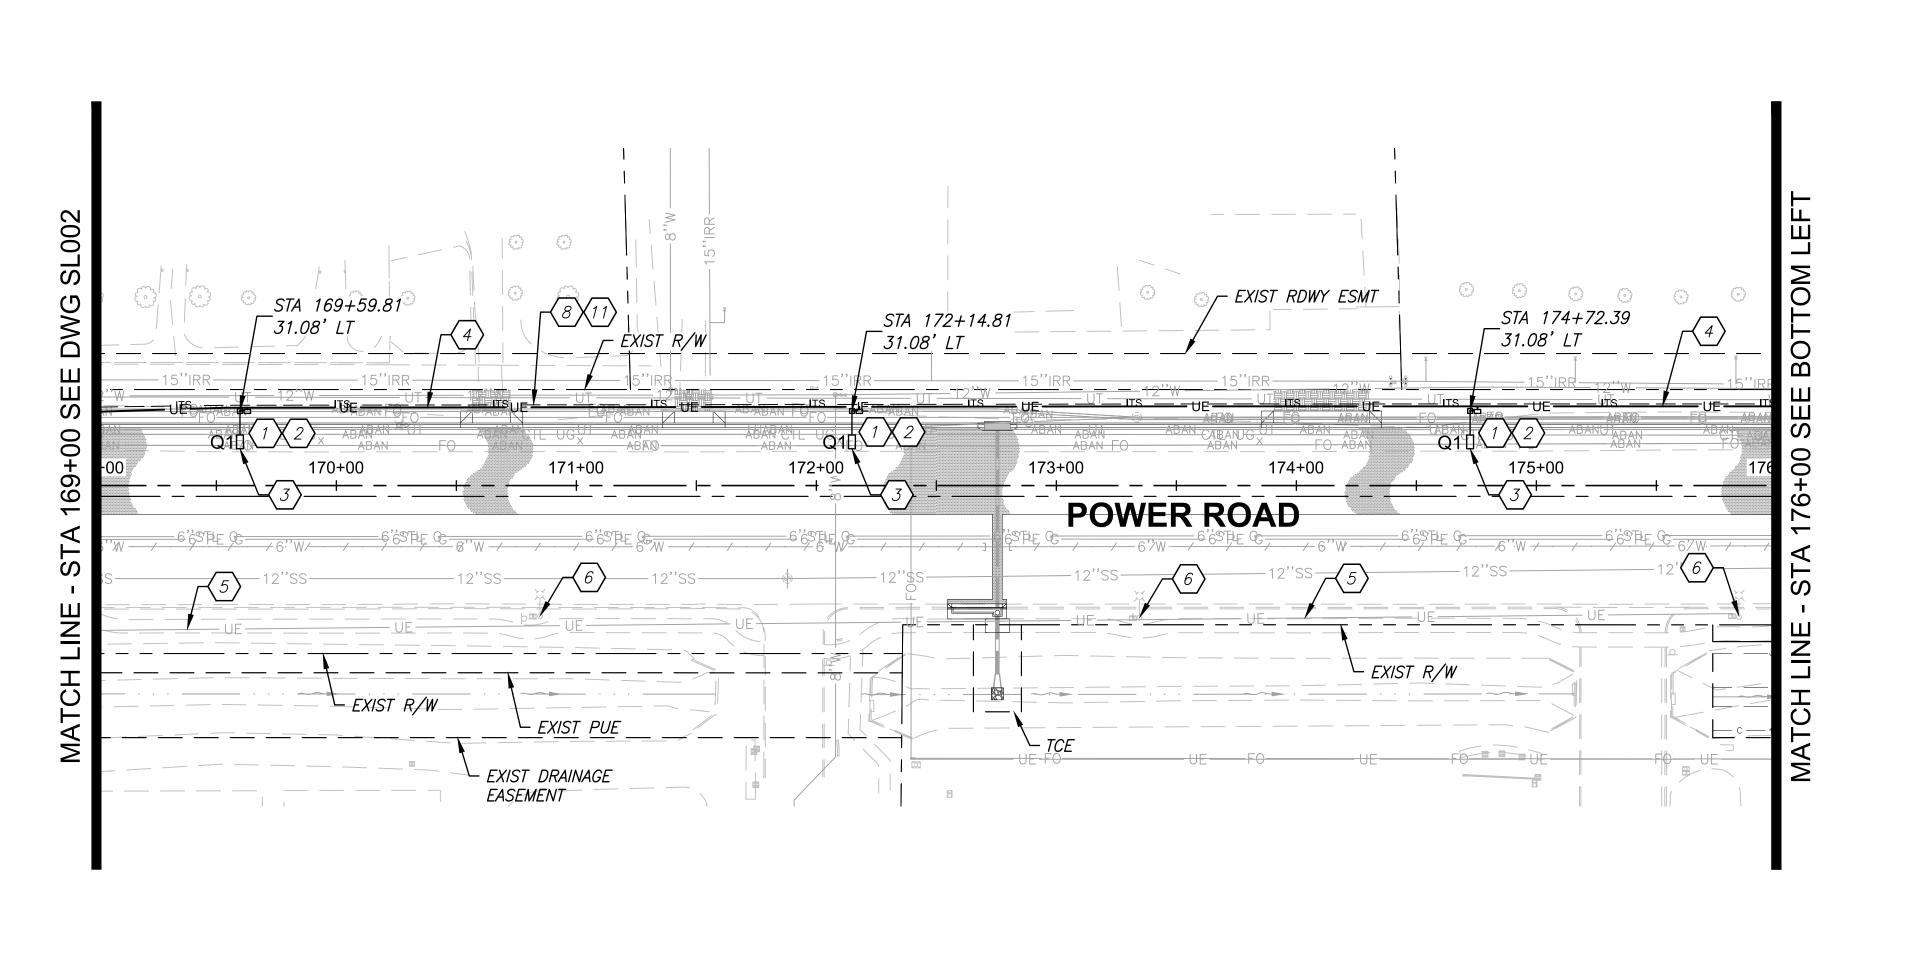

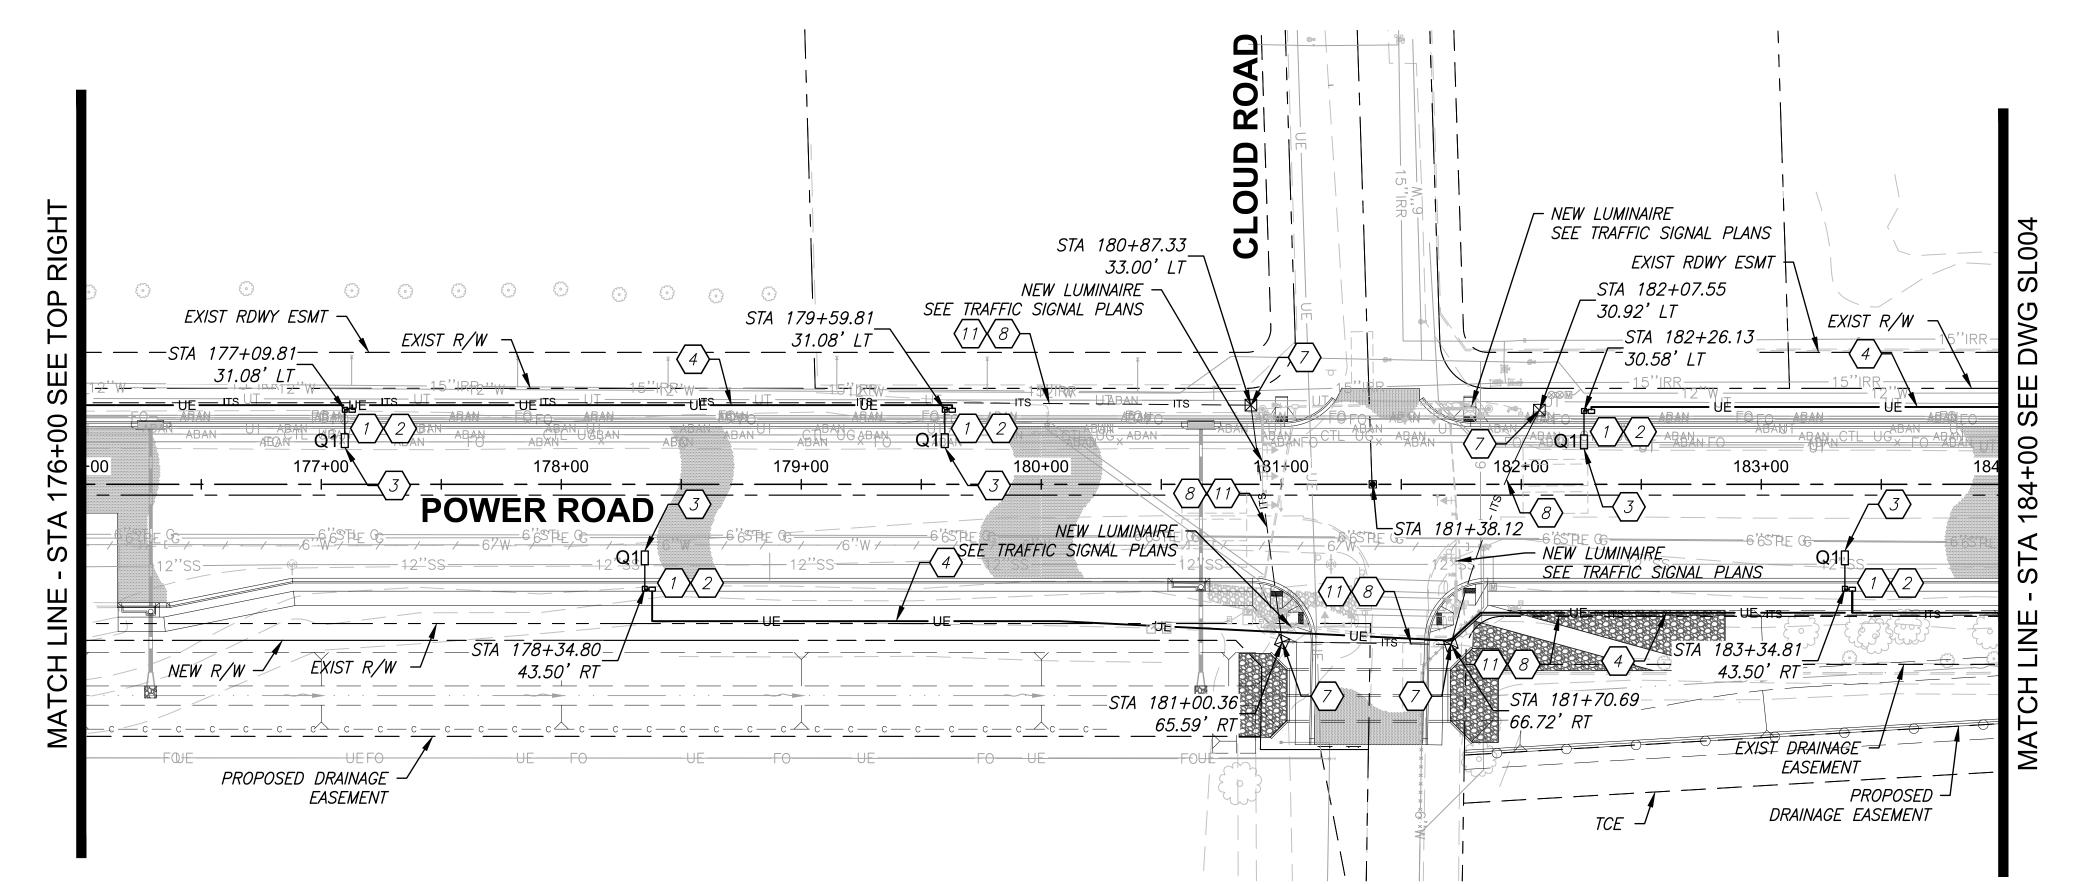

- Provide SRP Pull Box Next to Pole per Pull Box Deail on SRP Plans. Refer to Drawing No. SL006 for Additional Information Prior to Rough—In.
- Box to Pole Hand Hole.
- 3 Provide LED Street Light Luminaire and Pole with 32'0" Arterial Lighting Requirements. See Drawing No. SL001 for Fixture Type and Options.
- Exact Scope. Coordinate with SRP Drawings for Exact Underground Electrical Conduit Routing. Conduit in this
- 5 Existing Street Light Conduit.


- Trenching Detail. ITS Conduit Shall be Joint Trenched with


□──■ NEW STREET LIGHT





DESIGNED BY MH DRAWN BY

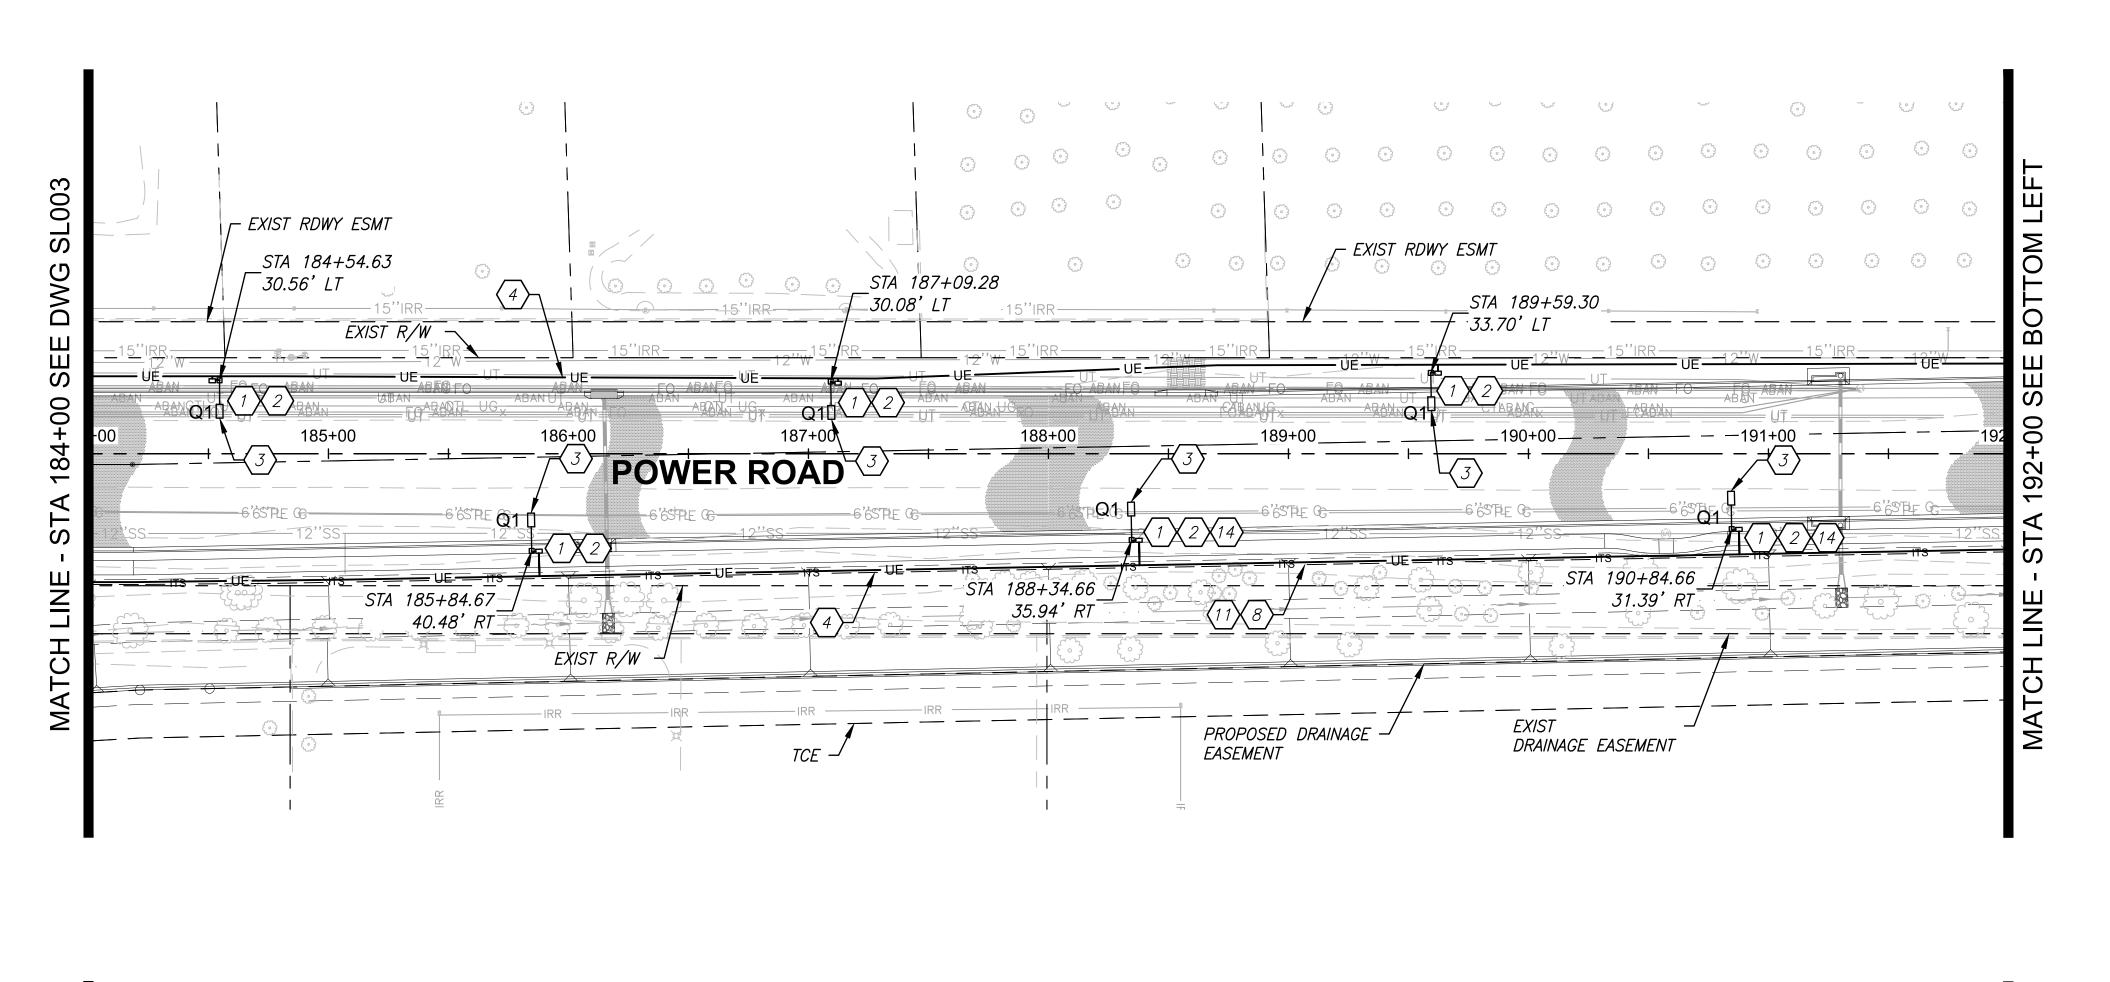

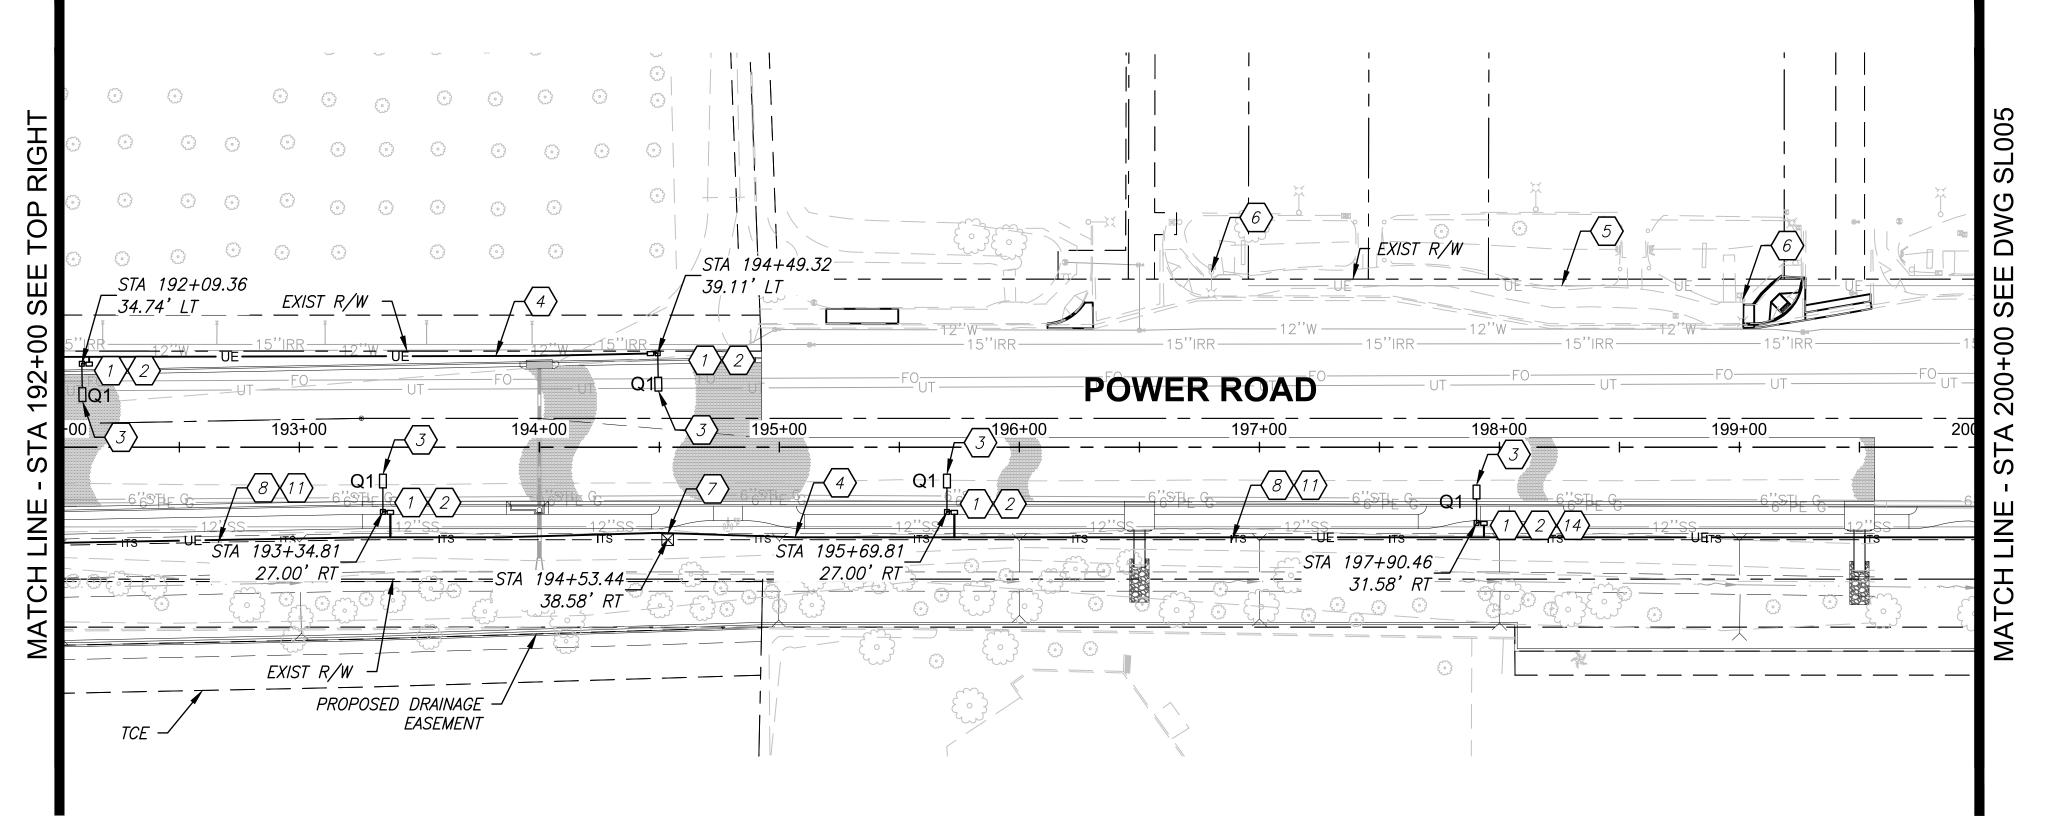

### CONSTRUCTION NOTES

- Provide SRP Pull Box Next to Pole per Pull Box Deail on SRP Plans. Refer to Drawing No. SL006 for Additional Information Prior to Rough—In.
- 2 Provide 1" Schedule 40 PVC Conduit from Street Light Pull Box to Pole Hand Hole.
- 3 Provide LED Street Light Luminaire and Pole with 32'0" Mounting Height and a Single 8' X 12'6" Mast Arm. See Drawing No. SL007 and SL008 for Installation Details. Light Fixture and Pole Shall Be Installed per Town of Queen Creek Arterial Lighting Requirements. See Drawing No. SL001 for Fixture Type and Options.
- 4 Provide Equipment, Pull Boxes, and Conduit Routing for Street Lighting. Refer to SRP Drawings for the Contractor's Exact Scope. Coordinate with SRP Drawings for Exact Underground Electrical Conduit Routing. Conduit in this Drawing is Shown for Diagrammatical Purposes only.
- 5 Existing Street Light Conduit.
- 6 Existing Street Light to Remain.
- 7 Provide and Install New #9 ITS Pull Box Per TOQC Standard Detail ITS-03 And ITS-04, See Drawing No. SL009.
- 8 Provide 2 1 1/4" Quad Duct (8 Conduits) for ITS Only. See TOQC Standard Detail ITS—06 on Drawing No. SL010 for Trenching Detail. ITS Conduit Shall be Joint Trenched with SRP Street Lighting Conduit.
- 11 Install 2-144 Single Mode Fiber Optic (SMFO) Cable.
- 14 Provide Spread Footing for Street Light in Lieu of Typical Street Light Footing. See Drawing No. SL008.

□──■ NEW STREET LIGHT

EXISTING STREET LIGHT

EXISTING STREET LIGHT PULL BOX

□ NEW STREET LIGHT PULL BOX

NEW #9 ITS PULL BOX

NEW #7 ITS PULL BOX








ROADWAY AND DRAINAGE IMPROVEMENTS

STREET LIGHT PLANS

DESIGNED BY MH CIP PROJ NO. A1405 DRAWN BY

> SL004 DRAWING NO.

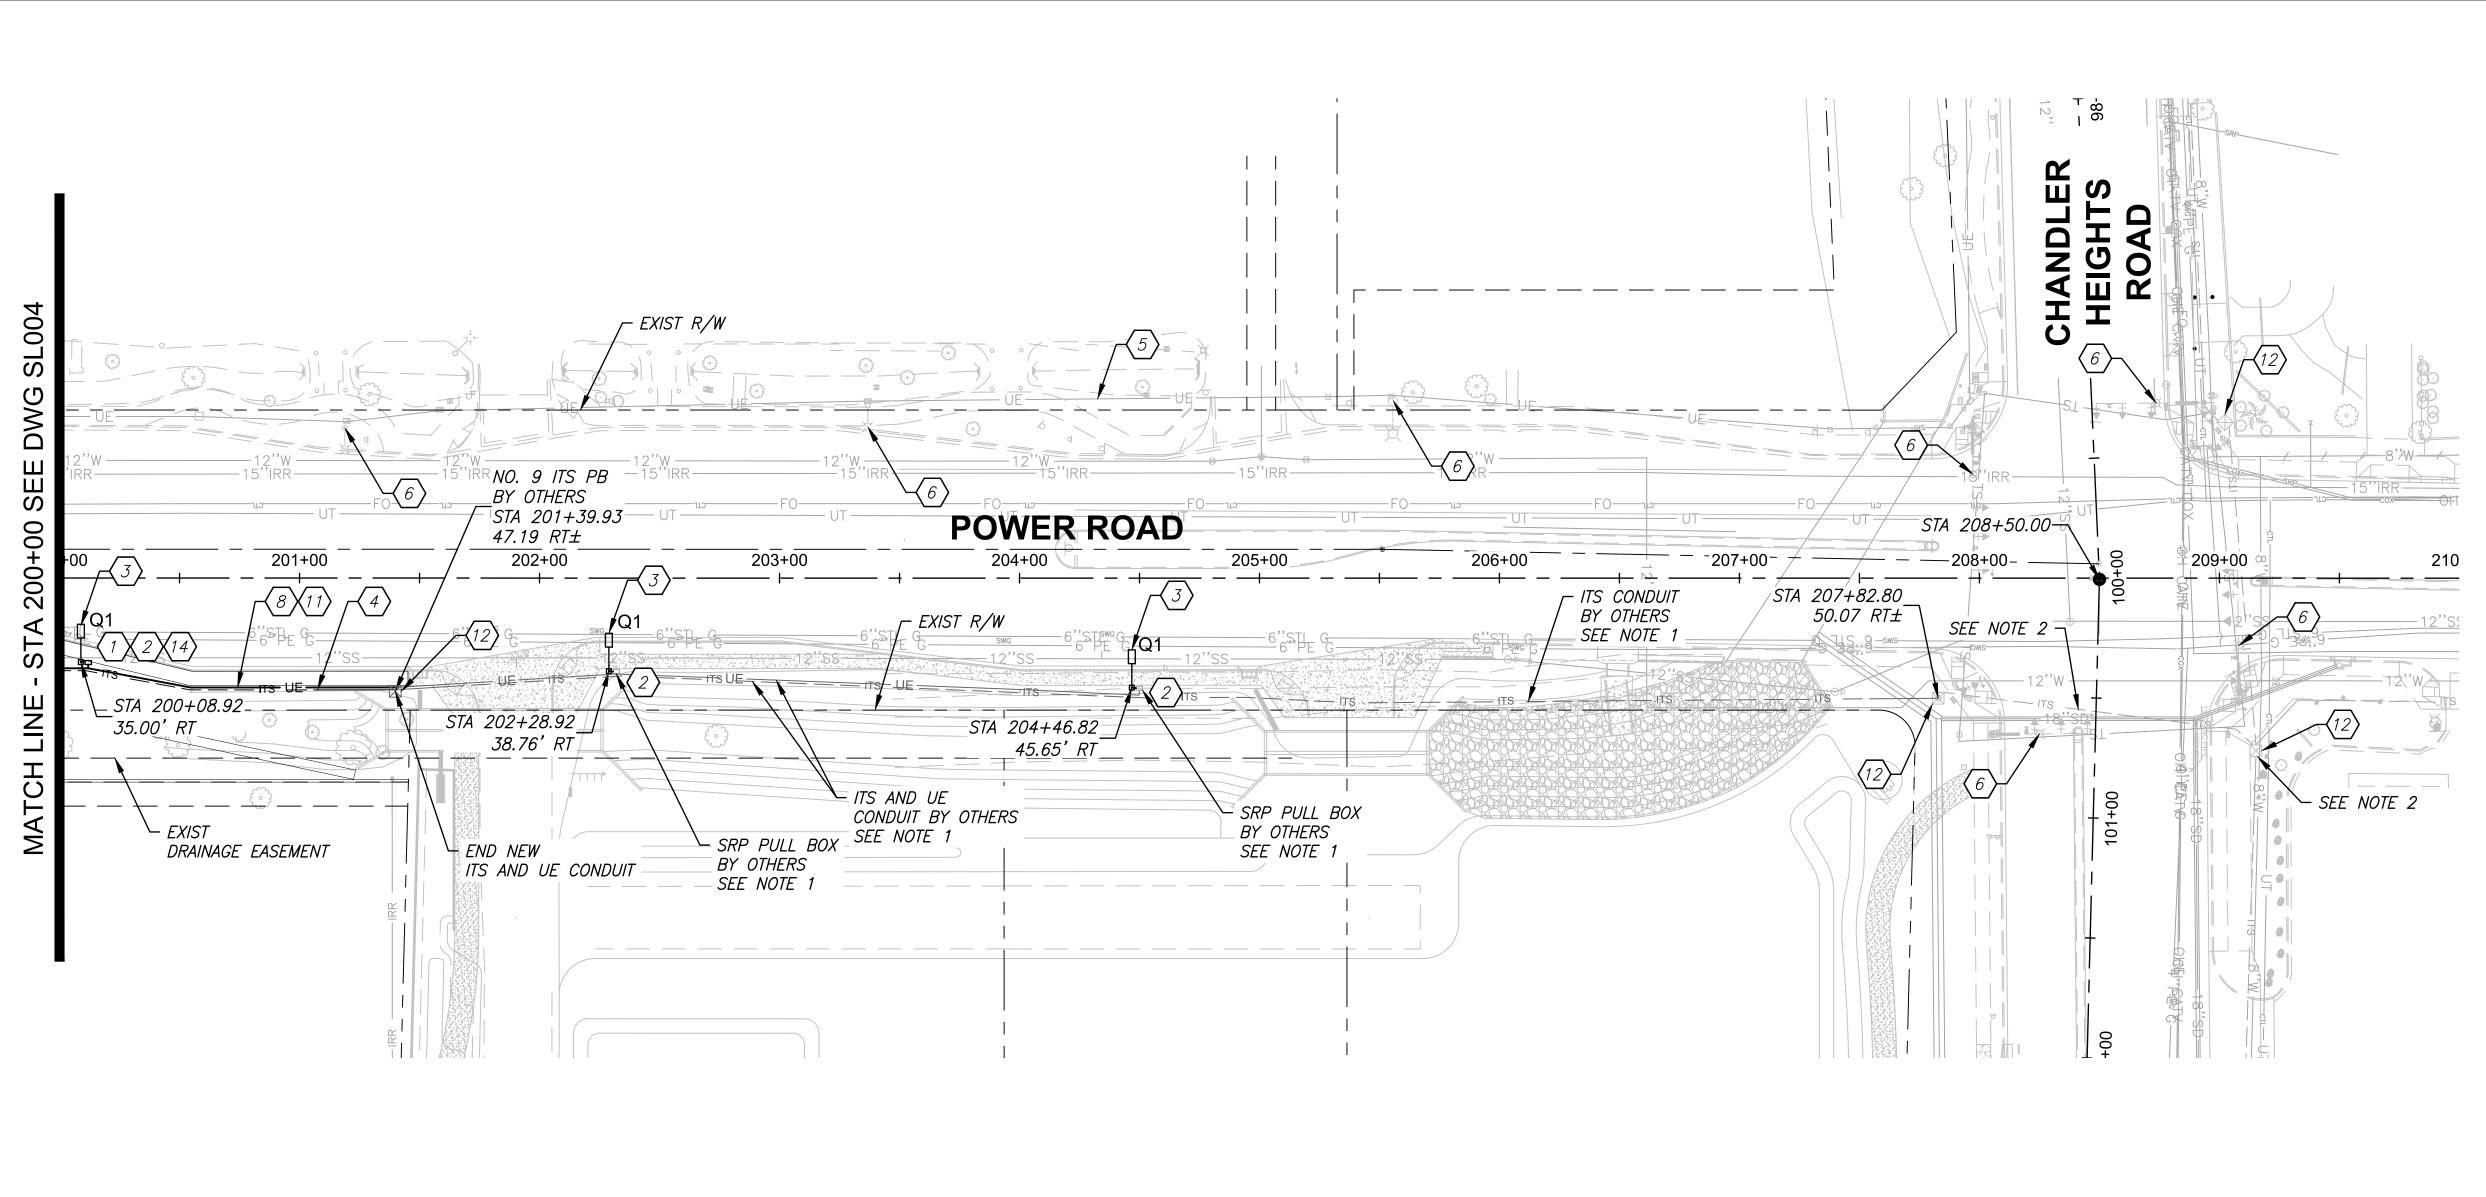

### **CONSTRUCTION NOTES**

- Provide SRP Pull Box Next to Pole per Pull Box Deail on SRP Plans. Refer to Drawing No. SL006 for Additional Information Prior to Rough—In.
- 2 Provide 1" Schedule 40 PVC Conduit from Street Light Pull Box to Pole Hand Hole.
- 3 Provide LED Street Light Luminaire and Pole with 32'0" Mounting Height and a Single 8' X 12'6" Mast Arm. See Drawing No. SL007 and SL008 for Installation Details. Light Fixture and Pole Shall Be Installed per Town of Queen Creek Arterial Lighting Requirements. See Drawing No. SL001 for Fixture Type and Options.
- 4 Provide Equipment, Pull Boxes, and Conduit Routing for Street Lighting. Refer to SRP Drawings for the Contractor's Exact Scope. Coordinate with SRP Drawings for Exact Underground Electrical Conduit Routing. Conduit in this
- 5 Existing Street Light Conduit.
- 6 Existing Street Light to Remain.
- 8 Provide 2 1 1/4" Quad Duct (8 Conduits) for ITS Only. See TOQC Standard Detail ITS—06 on Drawing No. SL010 for Trenching Detail. ITS Conduit Shall be Joint Trenched with SRP Street Lighting Conduit.
- 11 Install 2-144 Single Mode Fiber Optic (SMFO) Cable.
- 12 Existing ITS Pull Box.
- 14 Provide Spread Footing for Street Light in Lieu of Typical Street Light Footing. See Drawing No. SL008.

- only, refer to Town of Queen Creek Project Number 6862 - "SEC Power Road & Chandler Heights Road", for details.
- installed to existing #9 PB on the north east corner of Power Road and Chandler Heights Road.

□──■ NEW STREET LIGHT

EXISTING STREET LIGHT

EXISTING STREET LIGHT PULL BOX

□ NEW STREET LIGHT PULL BOX

---- NEW STREET LIGHT CONDUIT RUN

--- UE--- NEW UTILITY POWER CONDUIT RUN

— ITS— NEW ITS CONDUIT RUN

NEW #9 ITS PULL BOX

✓ NEW #7 ITS PULL BOX





STREET LIGHT PLANS

DESIGNED BY MH

SL005 DRAWING NO.

THE FOLLOWING INFORMATION IS PROVIDED TO EMPHASIZE CRITICAL WORK AND IS INTENDED TO SUPPLEMENT THE SPECIFICATIONS. SHOULD THERE BE A CONFLICT WITH THE SPECIFICATIONS, THIS DOCUMENT SHALL TAKE PRECEDENCE.

THE CONTRACTOR SHALL COMPLY WITH STATE AND TOWN STATUTES, AND MANUFACTURER'S RECOMMENDATIONS.

EQUIPMENT SUBMITTALS SHALL BE NEATLY GROUPED AND ORGANIZED. PERTINENT INFORMATION SHALL BE HIGHLIGHTED, AND THE SPECIFIC PRODUCT SHALL BE IDENTIFIED. ALL SUBMITTALS SHALL BE COMPLETE, AND PRESENTED IN ONE ELECTRONIC PDF PACKAGE. THE SUBMITTAL SHALL INCLUDE A COMPLETE LIST OF THE EQUIPMENT AND MATERIALS, INCLUDING THE MANUFACTURER'S NAME, PRODUCT SPECIFICATION, & CATALOG NUMBERS.

PRIOR TO SUBMITTING A PROPOSAL, THE BIDDER SHALL EXAMINE ALL GENERAL CONSTRUCTION DRAWINGS AND VISIT THE CONSTRUCTION SITE TO BECOME FAMILIAR WITH EXISTING CONDITIONS UNDER WHICH HE WILL OPERATE AND WHICH WILL IN ANY WAY AFFECT THE WORK UNDER THE CONTRACT. NO SUBSEQUENT ALLOWANCE WILL BE MADE IN THIS CONNECTION IN THE BEHALF OF THE CONTRACTOR FOR ANY ERROR OR NEGLIGENCE ON HIS PART.

PRIOR TO ORDERING ANY MATERIALS OR DOING ANY WORK, THE CONTRACTOR SHOULD VERIFY DIMENSIONS AT THE SITE. IMMEDIATELY REPORT DIFFERENCES TO THE ENGINEERING MGR. AND SHOULD NOT PROCEED WITH WORK UNTIL THE ENGINEERING MGR. RENDERS A DECISION. NO EXTRA CHARGES OR COMPENSATION WILL BE ALLOWED FOR DIFFERENCES IN ACTUAL DIMENSIONS AND DIMENSIONS INDICATED ON THE DRAWINGS.

THE ELECTRICAL CONTRACTOR SHALL COMPLY WITH ALL LICENSING REQUIREMENTS SET FORTH BY THE STATE REGISTRAR OF CONTRACTORS OFFICE TO PERFORM WORK RELATING TO STREET LIGHT INSTALLATION IN THE TOWN RIGHT-OF-WAY.

ONE PROJECT UNDERGROUND UTILITIES (RIGHT OF WAY) PERMIT AND ONE STREETLIGHT PERMIT FOR EACH STREET LIGHT POLE SHALL BE OBTAINED BY THE CONTRACTOR PRIOR TO CONSTRUCTION.

THE OWNER OR CONTRACTOR SHALL PROVIDE THE TOWN WITH THE SRP JOB NUMBER, SRP CONTACT NAME, AND ADDRESS THAT THE LETTER OF AUTHORIZATION SHALL REFERENCE.

### 1.02 WORKING / "AS BUILT" PLANS:

ACCEPTANCE OF THE COMPLETED IMPROVEMENTS WILL NOT BE GIVEN UNTIL 4 MIL PHOTO MYLAR REPRODUCIBLE "AS BUILT" PLANS HAVE BEEN SUBMITTED TO AND APPROVED BY THE TOWN ENGINEER.

### 1.03 LIGHT POLES:

FINAL STREET LIGHT LOCATIONS SHALL BE COORDINATED WITH TOWN ENGINEERING INSPECTOR. LIGHT POLES SHALL BE INSTALLED PLUMB, BE ADJUSTED TO PROVIDE PROPER ALIGNMENT TO THE ROADWAY BEING LIGHTED AND BE PROPERLY GROUNDED WHEN THE INSTALLATION IS COMPLETED.

### 1.04 FOUNDATION:

THE HOLE FOR THE FOUNDATION SHALL BE AUGURED OR HAND DUG, ANY EXCEPTION SHALL BE PRE-APPROVED BY THE TOWN'S STREETLIGHT MANAGEMENT SECTION. ANCHOR BOLTS INSTALLED IN FOUNDATIONS SHALL BE PROVIDED WITH DOUBLE NUTS AND WASHERS. ANCHOR BOLTS WILL BE SET IN PLACE AND SUPPORTED BY THE USE OF A TEMPLATE (SUPPLIED BY THE CONTRACTOR) TO MAINTAIN THE TRUE BOLT CIRCLE BEFORE THE CONCRETE IS POURED.

STREETLIGHT MANAGEMENT SHALL INSPECT THE WORK BEFORE THE CONCRETE IS POURED AND MUST BE CONTACTED 48 HOURS BEFORE THE SCHEDULED POURING. THE TOP OF THE FOUNDATION SHALL BE FLUSH WITH TOP OF SIDEWALK, TROWEL FINISHED AND LEVEL. SURPLUS EXCAVATION SHALL BE LEGALLY DISPOSED OF BY THE CONTRACTOR.

LUMINAIRES SHALL BE INSTALLED LEVEL AND INCLUDE A LAMP AND PHOTOCELL. CONTRACTOR SHALL ASSURE THAT THE LUMINAIRES SHALL BE FREE OF DUST, DIRT OR ANYTHING THAT WOULD IMPAIR THE OUTPUT OF THE LIGHT BEFORE

LEAVING THE SITE. LUMINAIRES FURNISHED WITH MULTI-TAP BALLASTS SHALL BE REWIRED OR RECONNECTED TO MATCH THE VOLTAGE SUPPLIED BY THE ELECTRIC UTILITY COMPANY.

WIRING SHALL BE INSTALLED PER UTILITY STANDARDS.

EACH POLE SHALL HAVE A 8' X 5/8" COPPER CLAD GROUND ROD DRIVEN BENEATH PULL BOX. INSTALL #6 BARE COPPER LEAD FROM THE GROUND ROD IN PULL BOX TO LANDING LUG IN STREET LIGHT POLE HAND HOLE.

EXCAVATION FOR PULL BOXES AND MATERIAL SPECIFICATION SHALL BE PER THE ELECTRIC UTILITY COMPANY STANDARDS.

TRENCH SHALL BE INSTALLED PER THE UTILITY COMPANY PLANS AND STANDARDS. THE USE OF A COMMON ELECTRIC UTILITY COMPANY TRENCH IS PERMITTED. IT IS THE CONTRACTOR'S RESPONSIBILITY TO CONTACT THE UTILITY COMPANY FOR COORDINATION OF TRENCHING AND THE INSTALLATION OF CONDUIT.

MAINLINE CONDUIT SHALL BE PER UTILITY COMPANY STANDARDS. CONDUIT FROM PULL BOX TO POLE SHALL BE 1 INCH

PVC CONDUIT OR EQUAL. CONDUIT MUST BE UL RATED AND SUITABLE FOR UNDERGROUND USE.

1.11 CONNECTIONS: CONNECTIONS SHALL BE PER UTILITY STANDARDS.

### 1.12 LIGHT POLE IDENTIFICATION:

THE CONTACTOR SHALL FURNISH AND INSTALL A NUMBER ON EACH LIGHT POLE. STREET LIGHT POLE IDENTIFICATION AND SPECIFICATIONS WILL BE PROVIDED BY THE TOWN.

### 1.13 RESTORATION:

IT IS THE CONTRACTOR'S RESPONSIBILITY TO RESTORE ALL PROPERTY, LANDSCAPING, PAVING AND DRIVEWAYS THAT ARE DISTURBED DURING STREET LIGHT CONSTRUCTION TO THEIR ORIGINAL CONDITION IN CONFORMANCE WITH "MAG" SPECIFICATION SECTION 107.9.

1.14 PERFORMANCE TEST: PRIOR TO ACCEPTANCE, THE DEVELOPER SHALL ENERGIZE AND OPERATE THE ENTIRE ROADWAY LIGHTING SYSTEM, FROM SUNSET TO SUNRISE FOR TWO CONSECUTIVE DAYS WITHOUT INTERRUPTION OR FAILURE. IF A LUMINAIRE SHOULD FAIL, IT SHALL BE IMMEDIATELY REPLACED.


### 1.15 WARRANTY:

THE CONTRACTOR SHALL GUARANTEE ALL WORK FOR A PERIOD OF ONE YEAR FROM THE DATE OF FINAL ACCEPTANCE BY THE ENGINEERING MANAGER, AGAINST IMPERFECT WORKMANSHIP, FAILURE, MALFUNCTION OF MATERIALS AND/OR EQUIPMENT DUE TO FAULTY OR IMPERFECT WORKMANSHIP. THIS GUARANTEE IS TO BE IN WRITING TO THE TOWN AT THE TIME OF ISSUING FINAL ACCEPTANCE. WORK FOUND TO BE DEFECTIVE WITHIN THE WARRANTY PERIOD SHALL BE REPLACED WITHOUT COST TO THE TOWN.



STREET LIGHT **GENERAL NOTES** 

LT-1

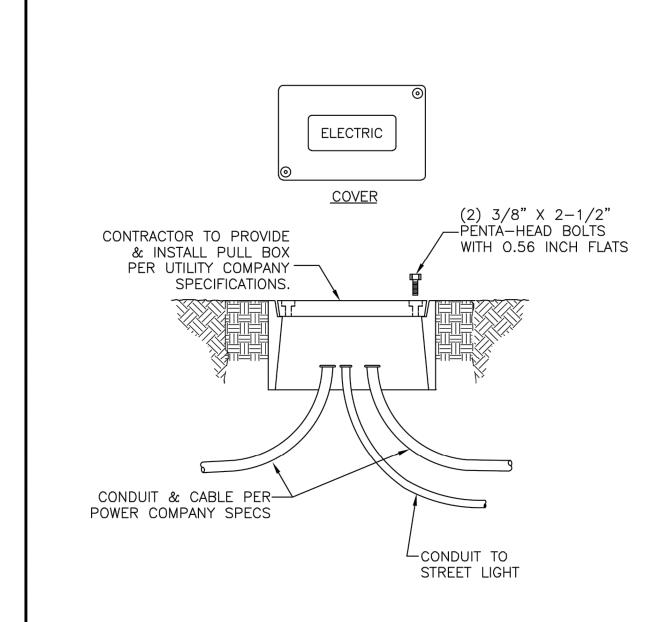

### NOTES:

- 1. PULL BOXES ARE TO BE INSTALLED FLUSH WITH SIDEWALK, IF NO SIDEWALK, SET 1" ABOVE TOP OF CURB.
- 2. AFTER PULL BOX IS SET, BACKFILL WITH EXCAVATED MATERIAL
- AND THOROUGHLY COMPACT. 3. WHERE PULL BOXES ARE INSTALLED IN CONCRETE AREAS, 1/2" PRE-MOLDED EXPANSION JOINT SHALL BE INSTALLED AROUND PULL BOX.
- 4. CONDUCTORS SHALL HAVE A MINIMUM OF 36" SLACK FROM
- CONDUIT AND BELL.
- 5. PULL BOXES SHALL BE INSTALLED OUTSIDE OF CONCRETED AREAS, PEDESTRIAN TRAILS, AND VEHICULAR TRAFFIC AREAS.



STREET LIGHT **PULL BOX** 

LT-2





TOWN OF QUEEN CREEK



POWER ROAD: RIGGS ROAD TO CHANDLER HEIGHTS ROAD ROADWAY AND DRAINAGE IMPROVEMENTS

Stantec

STREET LIGHT DETAILS

DESIGNED BY MH CIP PROJ NO. A1405 DRAWN BY

> SL006 DRAWING NO.

SHEET 93 OF 133


Chandler, Arizona 85226


Tel. 480.687.6100


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TOWN OF QUEEN CREEK

Chandler, Arizona 85226

Tel. 480.687.6100

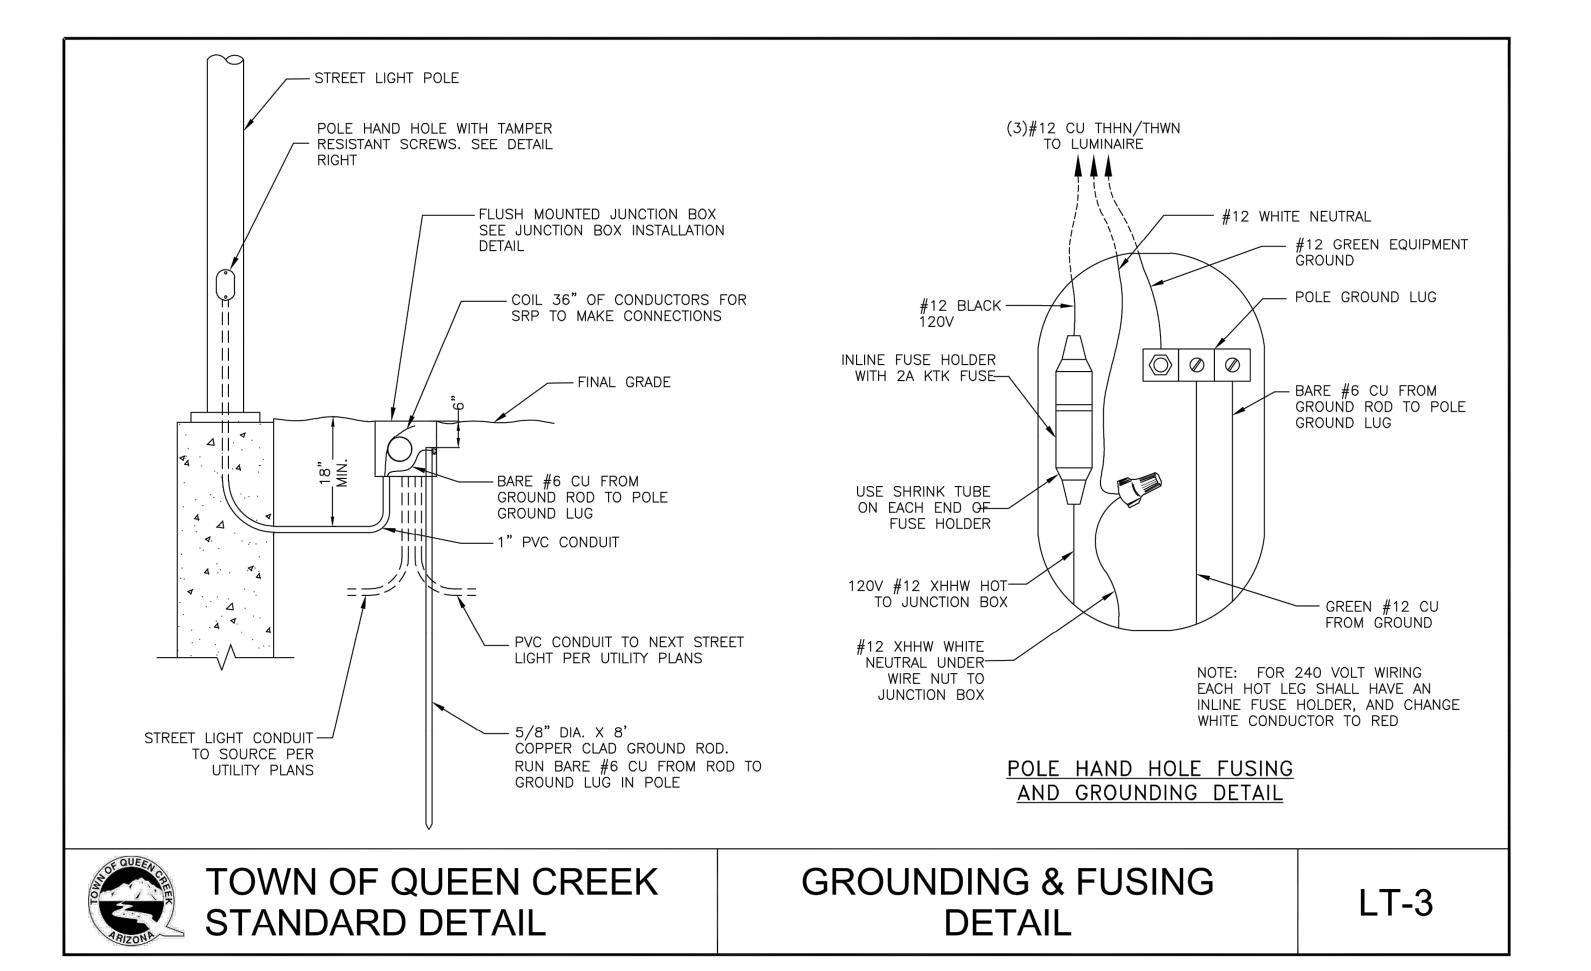

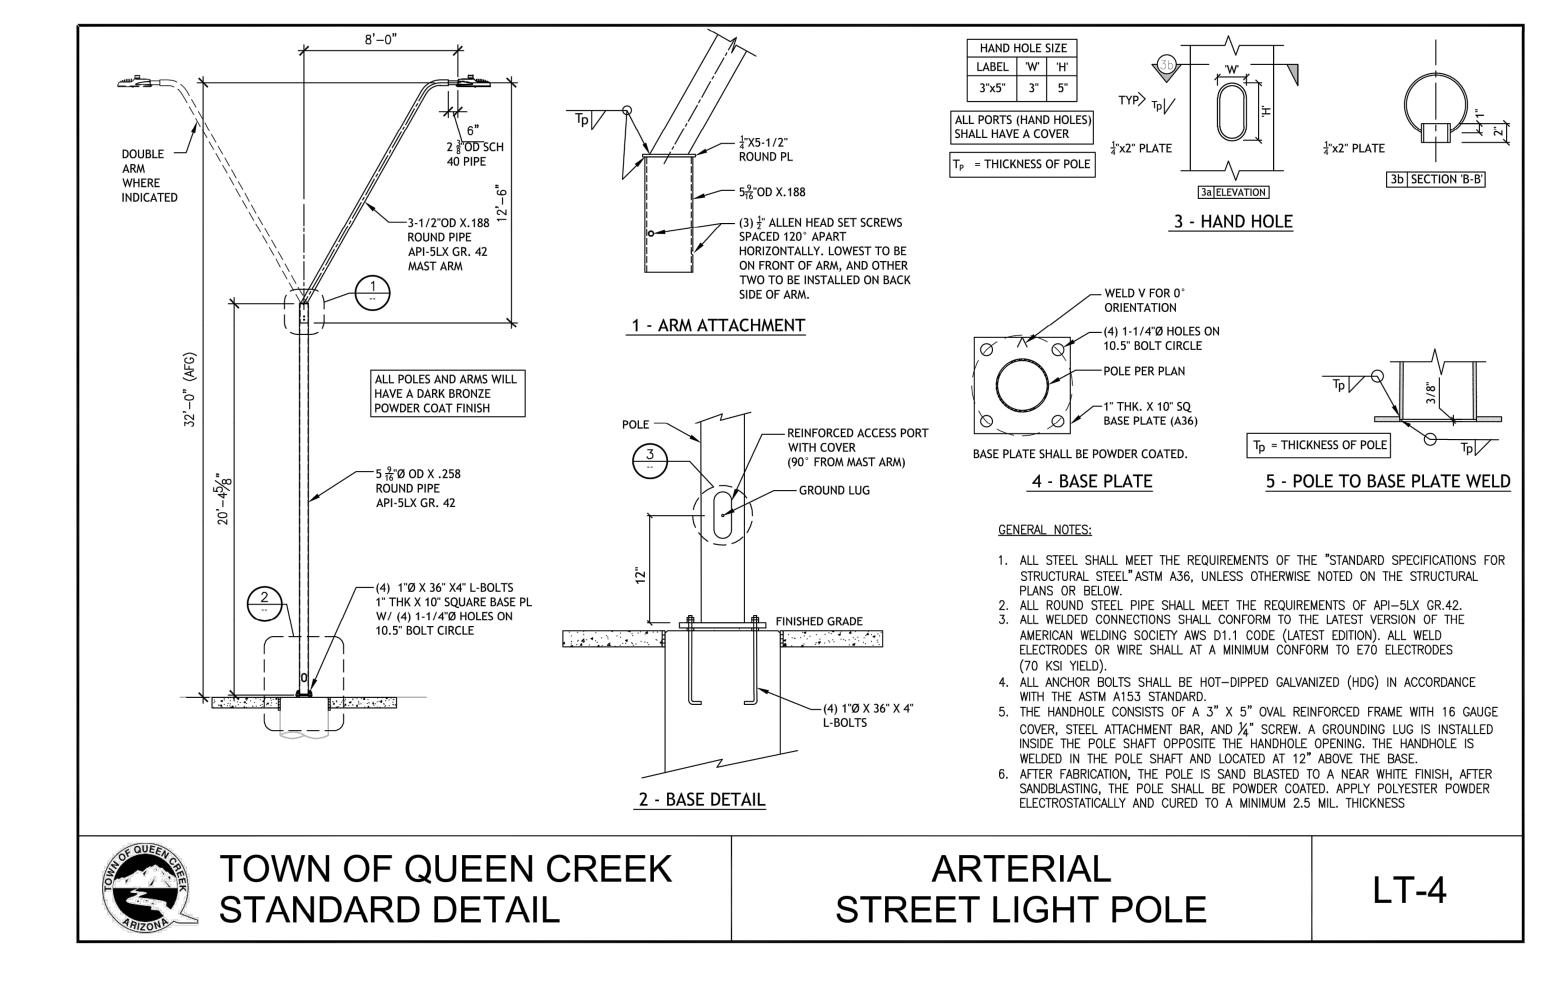POWER ROAD: RIGGS ROAD TO CHANDLER HEIGHTS ROAD ROADWAY AND DRAINAGE IMPROVEMENTS

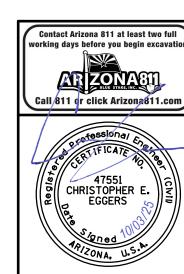Stantec


STREET LIGHT DETAILS


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SL007 DRAWING NO.

SHEET 94 OF 133

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TOWN OF QUEEN CREEK

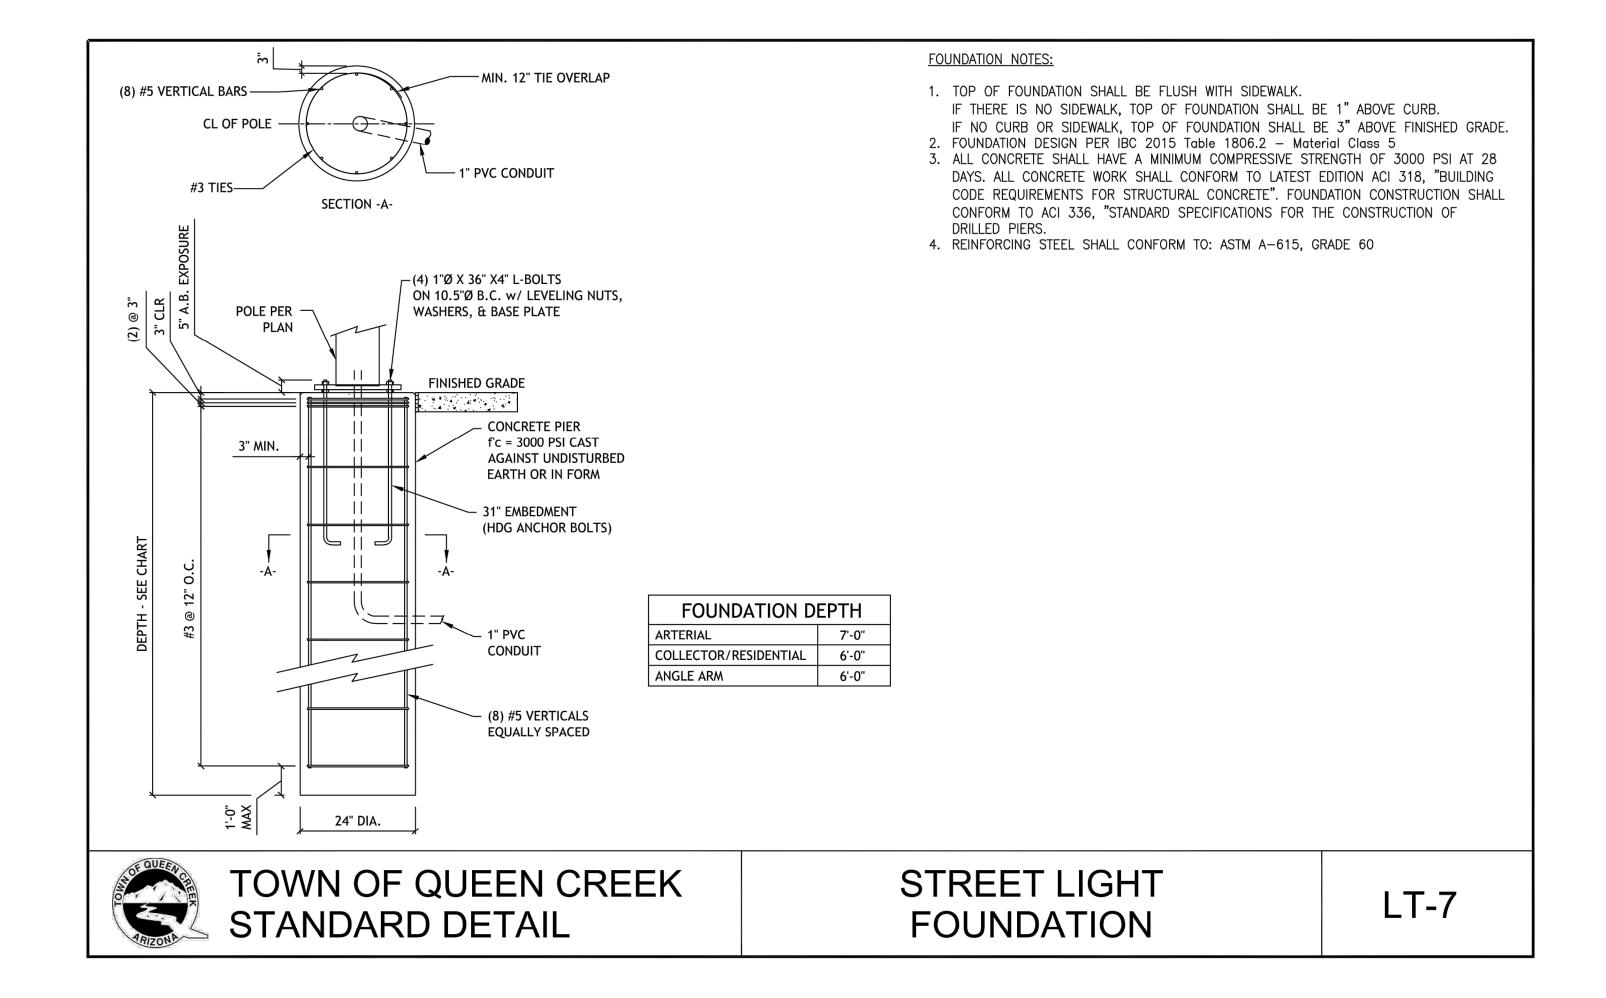

POWER ROAD: RIGGS ROAD TO CHANDLER HEIGHTS ROAD ROADWAY AND DRAINAGE IMPROVEMENTS

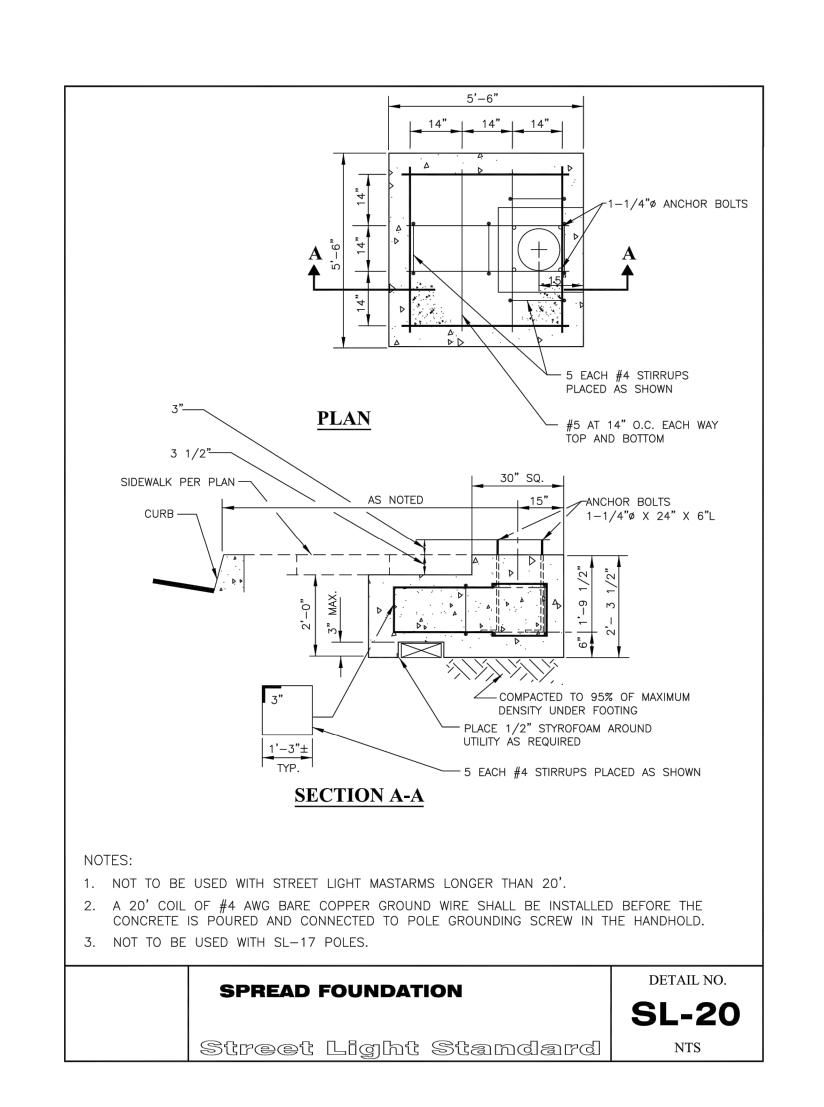
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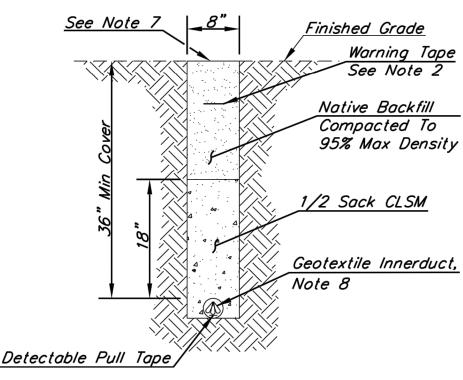
Chandler, Arizona 85226 Tel. 480.687.6100

STREET LIGHT DETAILS DESIGNED BY MH CIP PROJ NO. A1405

SHEET 95 OF 133 DRAWN BY DRAWING NO.

SL008



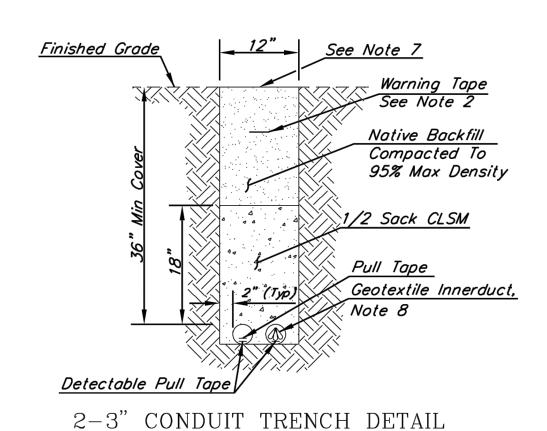

1-3" CONDUIT TRENCH DETAIL

### NOTES:

- 1. Pull tape and detectable pull tape shall be installed in continuous, unbroken runs from pull box to pull box. Detectable pull tape shall not be removed. Pull tape shall be used for cable or innerduct installation.
- 2. Warning tape shall be centered over conduit and installed at a depth of 6"-8" below finished grade. The warning tape shall be 4 mil inert plastic and shall be a minimum of 3" wide bearing the words "CAUTION-FIBER OPTIC CABLE BURIED BELOW" in BLACK letters on an orange background. Fiber optic warning tape shall extend into pull boxes.

  3. Conduit shall be blown out with compressed air and have a metal disk mandrel pulled through prior to acceptance. The
- size of the mandrel shall be 90% of the inside diameter of the conduit.
- 4. Conduit shall be Schedule 40 PVC.
- 5. All native backfill material shall be compacted to 95% of maximum density.
- 6. Conduit horizontal and vertical alignment offsets are to be accomplished by a uniform rate of conduit deflection over a distance equal to or greater than ten (10) times the offset distance.
- 7. When conduit is installed via open trench under existing pavement or sidewalk, the trench shall be backfilled with ½ sack CLSM from the bottom of trench to the bottom of asphalt or sidewalk. Asphalt mix and surface treatment shall be as directed by the Engineer, and conform to Town of Queen Creek standards.
- 8. Detectable 3-cell Geotextile Innerduct for 3-inch ID conduit shall be installed, per manufacturer's instructions.


REV. 08/2018



TOWN OF QUEEN CREEK STANDARD DETAIL

INTERCONNECT CONDUIT TRENCH DETAILS

**ITS-02** 

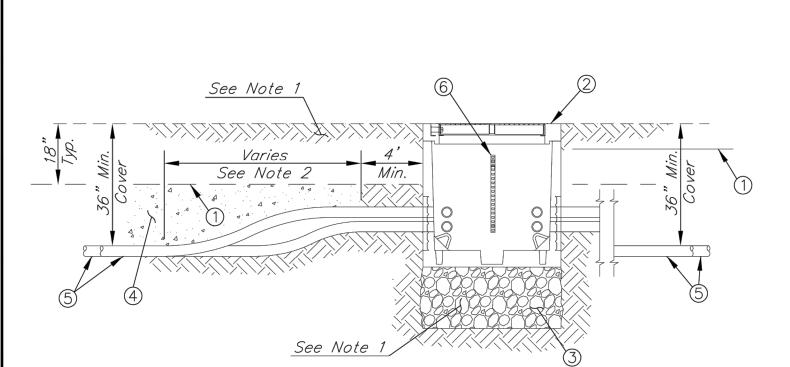

CONDUIT TRANSITION AND INSTALLATION

### NOTES:

- 1. BACKFILL WITH DESIGNATED SIZE NO. 57 AGGREGATE BELOW PULL BOX. BACKFILL AROUND SIDES OF PULL BOX WITH SELECT EXCAVATED MATERIAL, AND COMPACT TO 95% MAXIMUM DENSITY.
- CONDUIT ALIGNMENT OFFSETS ARE TO BE ACCOMPLISHED BY A GRADUAL RATE OF CONDUIT DEFLECTION OVER A DISTANCE EQUAL TO OR GREATER THAN TEN (10) TIMES THE OFFSET DISTANCE.
- PROVIDE 50 FEET OF FIBER CABLE SLACK FOR EACH CABLE ENTERING ANY NO. 9 PULL BOX WHERE CABLE WILL BE SPLICED. PROVIDE 100 FEET OF SLACK FOR EACH CABLE ENTERING ANY NO. 9 PULL BOX THAT IS NOT BEING SPLICED AS PART OF THIS PROJECT. SLACK REQUIREMENTS APPLY TO ALL FIBER TRUNK AND BRANCH CABLES.
- EACH CONDUIT END SHALL BE PLUGGED BY A TOWN-APPROVED WATERPROOF DUCT PLUG, WITH THE DETECTABLE ELEMENT EXTENDED OUTSIDE THE PLUG AND CONNECTED TO OTHER DETECTABLE ELEMENTS FROM OTHER CONDUITS, RESULTING IN A CONTINUOUS CIRCUIT.
- 5. ALL CABLES SHALL BE IDENTIFIED WITH CABLE TAGS, INDICATING FIBER COUNT AND ORIGIN/DESTINATION.
- 6. FINAL SET ELEVATION OF PULL BOX SHALL CONSIDER ADJACENT LANDSCAPING MATERIALS, TO PREVENT INTRUSION INTO OPEN BOX.

	GROUND
NO. 9 PULL BOX TRUNK CONDUIT(S)	
	2:1 MAX
	MAX
LATERAL(S) AS / REQUIRED	
93	
TRUNK CONDUIT(S)	
TRONK CONDUIT(S)	

EXISTING

	MATERIAL LIST								
ITEM	DESCRIPTION								
1	WARNING TAPE								
2	NO. 9 PULL BOX (CONCRETE)								
3	DESIGNATED SIZE NO. 57 AGGREGATE								
4	1/2 SACK CLSM								
5	SCHEDULE 40 PVC CONDUIT, PER PLANS								
6	RACK & HOOK (EACH WALL TYP)								

INSTALLATION IN SLOPED AREAS

REV. 06/2016

TOWN OF QUEEN CREEK STANDARD DETAIL

LATERAL CONDUIT INSTALLATION

No. 9 PULL BOX INSTALLATION

ITS-04

### RACKING PACKAGE 4 - 18 Hole Rack $8-\frac{1}{2}$ " SPRING NUTS AND BOLT $\sqrt{9} 8-7\frac{1}{2}$ " HOOKS

### NOTES:

- 1. CONCRETE: 28 DAY COMPRESSIVE
- STRENGTH f'c = 4,500 PSI, Min 2. REBAR ASTM A-615 GRADE 60
- MESH: ASTM A-185 GRADE 65
- 4. DESIGN: ACI-318-99 BUILDING CODE AND ASTM C-857 "MINIMUM STRUCTURAL DESIGN LOADING FOR UNDERGROUND PRECAST CONCRETE LOADING STRUCTURES"
- 5. LOADS: HS20-44 WHEEL LOADING IN OFF-STREET LOCATIONS WHERE NOT SUBJECTED TO HIGH DENSITY TRAFFIC.


80 PSF LATERAL LIVE LOAD SOIL: 40 PCF LATERAL SOIL PRESSURE ABOVE WATER TABLE 80 PCF LATERAL SOIL PRESSURE BELOW WATER TABLE 120 PCF SOIL DENSITY

- 6. SOIL COVER: O' TO 5' (MAX)
- WATER TABLE: 5'-0" BELOW GRADE
- 8. "QUEEN CREEK FIBER OPTICS" SHALL BE THE TITLE INSCRIBED ON LID.
- 9. GROUND LUG SHALL BE ATTACHED TO LID FRAME FOR COVER GROUNDING, PER NEC.
- 10. COVER SHALL OPEN TO 180-DEGREE POSITION.
- 11. MAX FORCE REQUIRED TO OPEN/CLOSE = 30 LBS
- 12. ALL NEW NO. 9 PULL BOXES SHALL BE FURNISHED WITH RACKS AND HOOKS INSTALLED.



No. 9 PULL BOX

**ITS-03** 

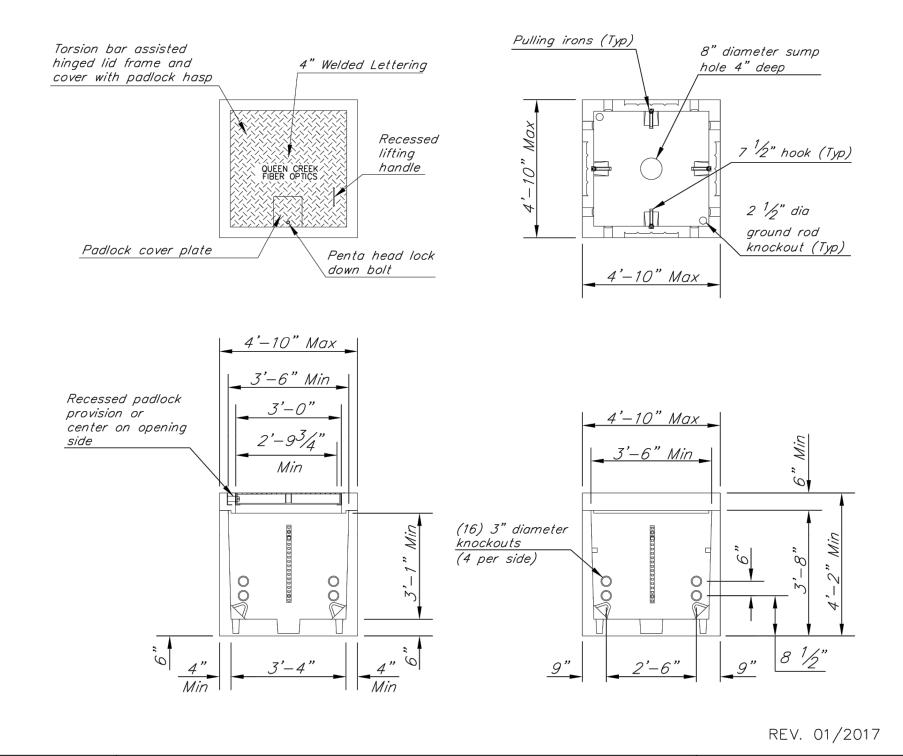



TOWN OF QUEEN CREEK

47551 CHRISTOPHER E. ||>

POWER ROAD: RIGGS ROAD TO CHANDLER HEIGHTS ROAD ROADWAY AND DRAINAGE IMPROVEMENTS


> Stantec Chandler, Arizona 85226 Tel. 480.687.6100


ITS DETAILS

DESIGNED BY MH CIP PROJ NO. A1405 DRAWN BY

> SL009 DRAWING NO.

SHEET 96 OF 133

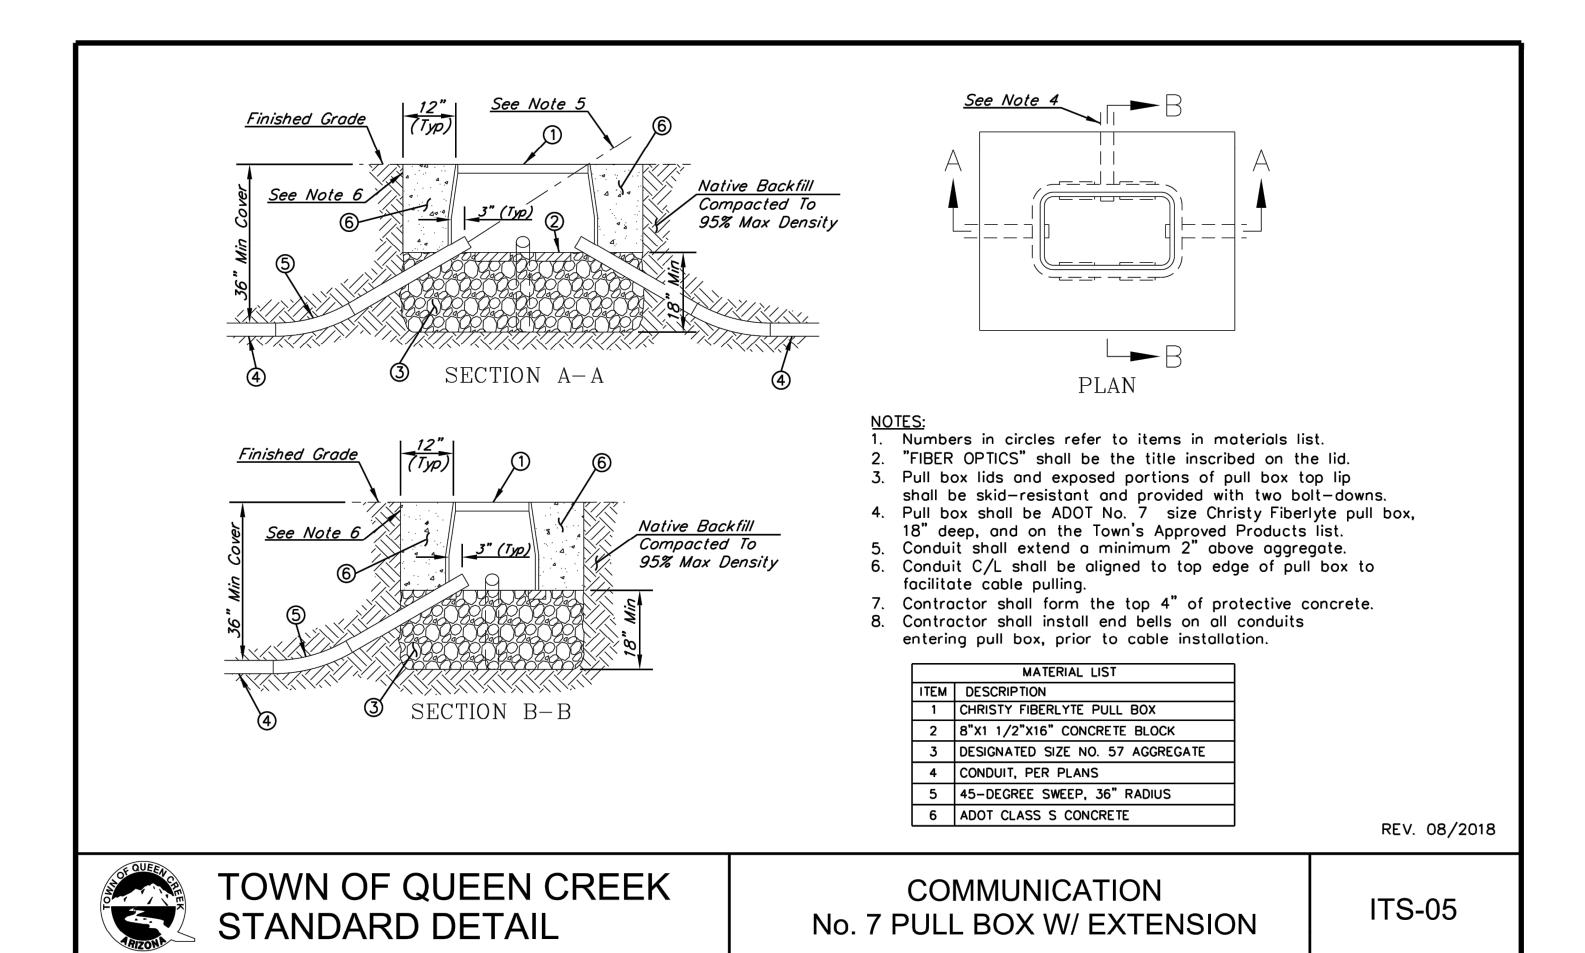

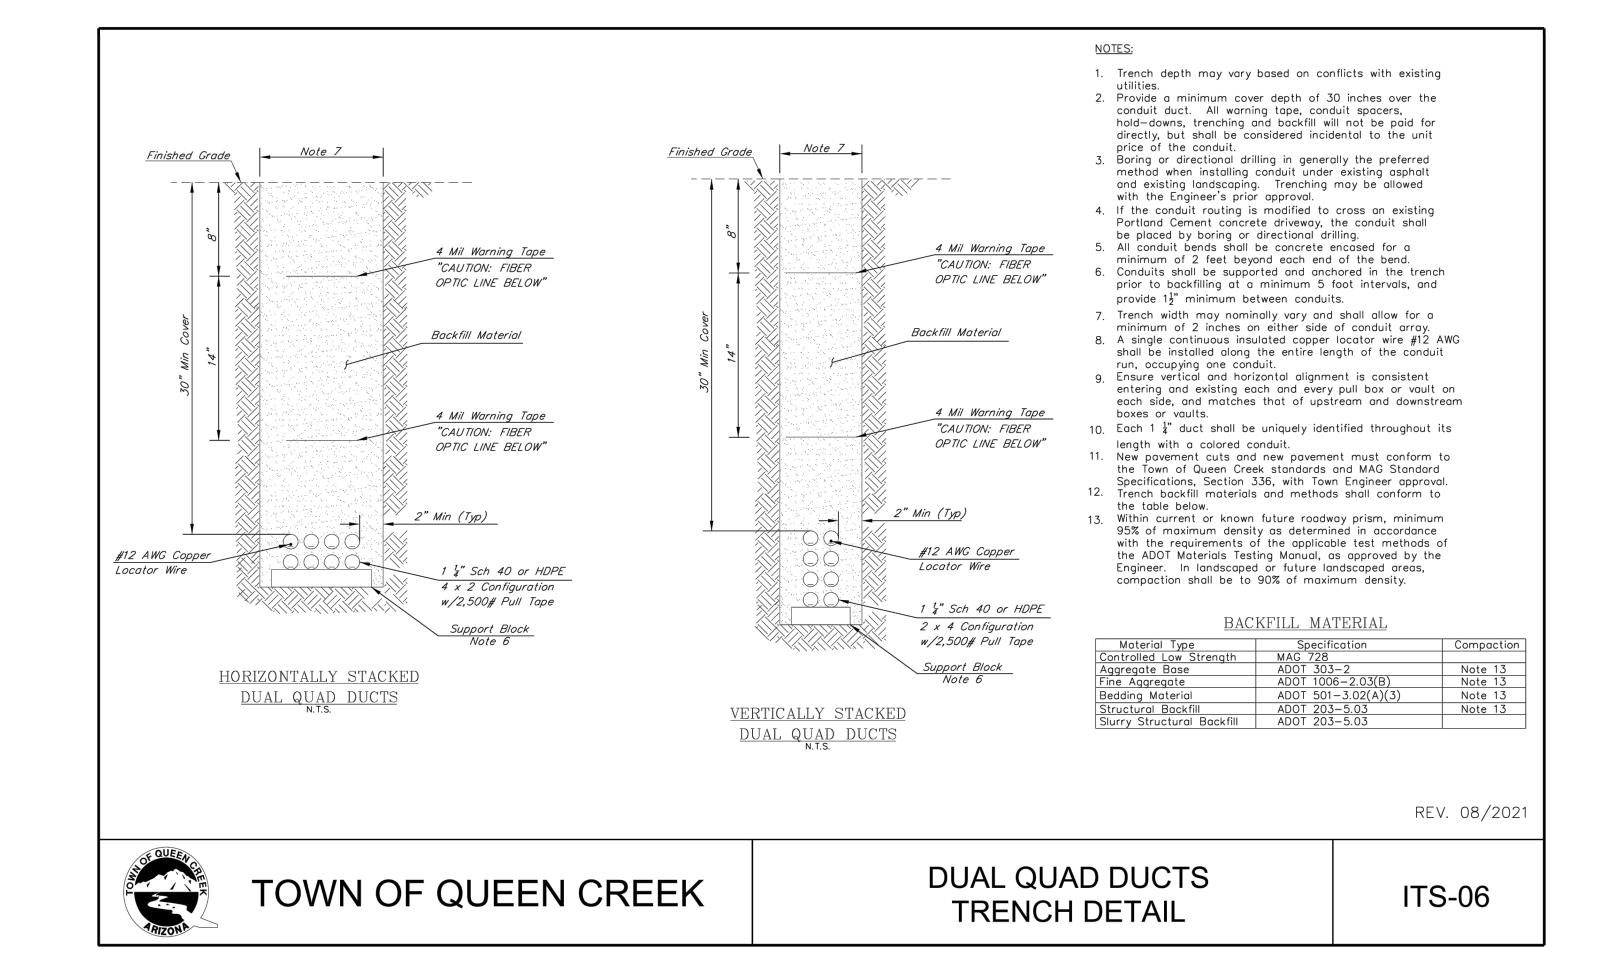



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TOWN OF QUEEN CREEK



POWER ROAD: RIGGS ROAD TO CHANDLER HEIGHTS ROAD ROADWAY AND DRAINAGE IMPROVEMENTS

Stantec

Chandler, Arizona 85226
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www.stantec.com

ITS DETAILS

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DRAWN BY BE

CIP PROJ NO. A1405

DRAWING NO. SLO10

SHEET 97 OF 133

- 2. THE CONTRACTOR IS RESPONSIBLE FOR PROVIDING WATER TO ALL NEWLY INSTALLED PLANT MATERIAL. REFER TO THE LANDSCAPE PLANS FOR LOCATIONS.
- 3. CONTRACTOR SHALL PROVIDE TOWN CIP INSPECTOR WITH "AS-BUILTS" FOR THE INSTALLED IRRIGATION SYSTEM PRIOR TO FINAL ACCEPTANCE OF WORK. AS-BUILTS SHALL BE HANDLED ON A DAILY BASIS DURING INSTALLATION OF SYSTEM TO THE SATISFACTION OF THE TOWN CIP INSPECTOR.
- THIS IRRIGATION DESIGN IS DIAGRAMMATIC. DRIP LATERAL LINES ARE NOT SHOWN GOING TO EVERY PLANT FOR DESIGN CLARITY. THE CONTRACTOR SHALL ENSURE ALL PLANTS RECEIVE DRIP IRRIGATION AS SCHEDULED. EQUIPMENT, PIPING, VALVES, ETC. AND IRRIGATION LINES SHOWN WITHIN PAVED AREAS, SIDEWALKS AND OUTSIDE OF THE PROPERTY BOUNDARIES ARE SHOWN FOR DESIGN CLARIFICATION ONLY AND SHALL BE INSTALLED WITHIN THE PLANTING AREAS. LOCATE VALVES AND BACKFLOW PREVENTION UNITS WITHIN PLANTER OR PROTECTED AREAS SO THAT THEY ARE VISUALLY UNOBTRUSIVE.
- 5. DO NOT INSTALL THE IRRIGATION SYSTEM AS SHOWN ON THE DRAWINGS WHEN IT IS OBVIOUS IN THE FIELD THAT UNKNOWN OBSTRUCTIONS, GRADE DIFFERENCES OR DIFFERENCES IN AREA DIMENSIONS EXIST THAT MIGHT NOT HAVE BEEN CONSIDERED IN THE DESIGN. SUCH OBSTRUCTIONS OR CONFLICTS SHALL IMMEDIATELY BE BROUGHT TO THE ATTENTION OF THE TOWN CIP INSPECTOR/ENGINEER. IN THE EVENT THIS NOTIFICATION IS NOT PERFORMED, THE CONTRACTOR SHALL ASSUME FULL RESPONSIBILITY FOR ANY NECESSARY REVISIONS.
- GRADE DIFFERENCES, LOCATION OF WALLS, RETAINING WALLS, STRUCTURES AND EXISTING UTILITIES, ETC. THE CONTRACTOR SHALL BE RESPONSIBLE FOR COORDINATION OF THE REPAIR OR REPLACEMENT OF ALL ITEMS DAMAGED BY HIS WORK. CONTRACTOR SHALL COORDINATE THE WORK WITH OTHER CONTRACTORS FOR THE LOCATION AND INSTALLATION OF PIPE SLEEVES AND LATERALS THROUGH WALLS, UNDER ROADWAYS AND PAVING, AND THROUGHOUT THE LIMITS OF WORK.
- 7. ALL INSTALLED IRRIGATION SHALL BE
  WARRANTED IN ACCORDANCE WITH IRRIGATION
  SPECIFICATIONS FOR THE MINIMUM DURATION
  SPECIFIED: (1—YEAR FROM SUBSTANTIAL
  COMPLETION). ALL PRODUCT WARRANTIES SHALL
  BE A MINIMUM 1—YEAR FROM SUBSTANTIAL
  COMPLETION.
- 8. IRRIGATION EQUIPMENT NOT OTHERWISE DETAILED OR SPECIFIED SHALL BE INSTALLED PER MANUFACTURER'S RECOMMENDATIONS AND SPECIFICATIONS.
- 9. ALL PIPE SHALL BE BEDDED ON ALL SIDES WITH FOUR INCHES OF ROCK FREE (3/8" MINUS) MATERIAL. IMPORT SAND IF NECESSARY. BACKFILL IN TWO OR MORE COMPACTED LIFTS. SETTLING OF TRENCHES BY MORE THAN ONE INCH SHALL BE BROUGHT BACK TO FINISH GRADE AT THE CONTRACTOR'S EXPENSE.

- 10. ALL PLANTS REQUIRING MORE THAN ONE DRIP EMITTER SHALL HAVE EMITTERS DISTRIBUTED EVENLY AROUND PERIMETER OF PLANTING ROOT BALL. EMISSION POINTS AT ROOT BALLS SHALL BE LOCATED ON THE UPHILL SIDE, IF APPLICABLE, MIDWAY BETWEEN THE CENTER OF THE PLANT AND THE EDGE OF THE ROOT BALL.
- 24 VOLT WIRE SHALL BE TYPE "UF" 600 VOLT. SOLID COPPER, SINGLE CONDUCTOR WIRE WITH PVC INSULATION AND BEAR UL APPROVAL FOR DIRECT UNDERGROUND BURIAL. COMMON WIRE SHALL BE 10 GAUGE WHITE; CONTROL WIRE SHALL BE 12 GAUGE RED (USE NO BLACK WIRE). TAPE AND BUNDLE WIRE AT 10' O.C. LAY BESIDE MAINLINE. SPLICE IN VALVE BOXES ONLY USING MANUFACTURED DRY-TYPE WATERPROOF CONNECTORS. PROVIDE 24" SLACK AT EACH ELBOW IN MAINLINE AND 30" SLACK AT EACH REMOTE CONTROL VALVE LOCATION. PULL ONE ADDITIONAL YELLOW 10 GAUGE SPARE WIRE TO THE MOST DISTANT VALVE LOCATION IN ALL DIRECTIONS OUT FROM THE CONTROLLER FOR POTENTIAL FUTURE USE WHEN TWO WIRE CONTROLLER IS USED REFER TO TWO WIRE NOTES FOR ADDITIONAL INFORMATION ON CONTROL WIRE. CONTRACTOR SHALL RUN (4) FOUR SPARE VALVE WIRES AND (1) ONE SPARE COMMON WIRE TO FURTHEST VALVE IN EACH DIRECTION.
- 2. LEVEL OF PEA GRAVEL IN IRRIGATION BOXES SHALL BE A MINIMUM OF 3" BELOW THE BOTTOM OF THE VALVE/FILTERS SO THAT THE COMPONENTS ARE COMPLETELY VISIBLE. ALL PEA GRAVEL AND/OR DEBRIS SHALL BE CLEARED FROM TOP OF VALVE/FILTERS AND THE LIP OF THE VALVE BOX.
  - THE CONTRACTOR SHALL GUARANTEE PROPER WATER SUPPLY TO ALL PLANT MATERIALS THROUGHOUT THE CONTRACT PERIOD. ALL PIPING SHALL BE THOROUGHLY FLUSHED PRIOR TO EMITTER INSTALLATION. CONTRACTOR IS RESPONSIBLE FOR ANY NECESSARY REPLACEMENT OF EMITTERS DUE TO CLOGGING FOR THE DURATION OF THE PROJECT. ANY PLANT MATERIAL THAT DIES DUE TO EMITTER OPERATING FAILURE SHALL BE REPLACED BY THE CONTRACTOR AT NO ADDITIONAL COST.
- 14. ALL VALVE BOXES SHALL HAVE OVERLAPPING LIDS WITH LOCKING BOLTS. ALL VALVE BOXES LOCATED WITHIN PLANTING AREAS SHALL BE DESERT TAN IN COLOR.
- THIS IRRIGATION DESIGN IS BASED UPON USING THE SPECIFIED EQUIPMENT IN THE INSTALLATION/FABRICATION OF THE SYSTEM. SUBSTITUTION OF IRRIGATION EQUIPMENT SPECIFIED IS NOT PERMITTED.

IRRIGATION	IRRIGATION SCHEDULE									
SYMBOL	MANUFACTURER/MODEL/DESCRIPTION	DETAIL	SHEET							
•	DRIP VALVE ASSEMBLY: 1" RAINBIRD PEB SERIES VALVE, BRONZE BALL VALVE AND UNIONS WITH:	1,8	IR501							
	* FLOWS <u>UNDER</u> 5.0 GPM: INSTALL 3/4" RAINBIRD PRF-075-RBY IN-LINE PRESSURE REGULATING FILTER.									
	* FLOWS <u>OVER</u> 5.0 GPM: INSTALL 1" PRB-QKCHK-100 COMBO QUICKCHECK/PRESSURE REGULATING BASKET FILTER.									
M	WATER METER-SEE CIVIL UTILITY PLANS	SEE CIVIL	SEE CIVIL							
$\otimes$ $\otimes$	FEBCO LF825YA OR EQ. REDUCED PRESSURE PRINCIPAL ASSEMBLY (RPPA): INSTALL IN GUARDSHACK GS-4 ENCLOSURE (VERIFY SIZE TO RPPA ORDERED)	4	IR502							
С	IRRIGATION CONTROLLER: WEATHERMATIC SMARTLINE #SL4800SLR -1YR-BDL-FLOW (INCLUDES: #SLPED-ENC SS PEDESTAL, #SLW1 WIRELESS WEATHER STATION AND #SL-AIRCARD)	1,2	IR502							
M	MASTER VALVE: GRISWOLD DWS-150 BRASS 1.5" STRAIGHT (NORMALLY CLOSED) FLOW RANGE: 0.1 TO 30 GPM	5	IR502							
F	FLOW SENSOR: WEATHERMATIC SLFSI-T10	5	IR502							
S	SOLAR PANEL ASSEMBLY W/WEATHER STATION AND POLE: WEATHERMATIC SLSOLAR-48	3	IR502							
×	MANUAL BRONZE GATE VALVE (NIBCO T-113-K NON-RISING STEM)-LINE SIZE	7	IR501							
	DRIP LATERAL FLUSH CAP ASSEMBLY; INCLUDES VALVE BOX	6	IR501							
	(SHRUB) LATERAL LINE: 1" PVC SCHEDULE 40 PIPE EXCEPT WHERE NOTED	2,3	IR501							
	(SHRUB) LATERAL LINE: 1" PVC SCHEDULE 40 PIPE EXCEPT WHERE NOTED  (TREE) LATERAL LINE: 1" PVC SCHEDULE 40 PIPE EXCEPT WHERE NOTED									
	IRRIGATION MAINLINE: 2" PVC SCHEDULE 40 PIPE	2,3	IR501							
SL	SLEEVE (SL): PVC SCHEDULE 40 PIPE: INSTALL (1) 4" SL FOR CONTROL WIRE BUNDLED WITH (1) 4" SL FOR MAINLINE UNDER PAVEMENTS. INSTALL (1) SEPARATE 4" SL FOR LATERAL PIPES—(1) PIPE PER SLEEVE	2	IR501							
EMITTERS	SEE EMITTER CHART, SCHEDULE, AND DETAILS	4,5,9	IR501							

EMITTER	SCHEDULE SHRUBS TREES	
MULTI OUTLET	EMITTERS	
GPH	MANUFACTURER	MODEL/DESCRIPTION
1	BOWSMITH PRODUCTS, 800-269-7648 www.bowsmith.com.	PRESSURE COMP. M210 THREADED 1 GPH EACH-PSI RANGE (10-30), COLOR: "BLUE CAP"
2	BOWSMITH PRODUCTS, 800-269-7648 www.bowsmith.com.	PRESSURE COMP. M220 THREADED 2 GPH EACH-PSI RANGE (10-30), COLOR: "RED CAP"

VALVE CALLOUT

TREES

Plant Zone Type

Valve Station #

Valve GPM

Valve Size

EMITTE	EMITTER QUANTITY SCHEDULE									
SHRUBS, GROUNDCOVERS, ACCENTS (SHRUB ZONE)										
SYMBOL	MULTI EMITTERS	GPH	TOTAL GPH	BOTANICAL NAME/COMMON NAME						
(+)	4 EMITTERS 16 OUTLETS	2	32	PISTACIA X HYBRID 'RED PUSH' RED PUSH PISTACHE						
	4 EMITTERS 16 OUTLETS	2	32	ULMUS PARVIFLORA 'TRUE GREEN' TRUE GREEN ELM						
B	2 OUTLETS EACH	1	2	EREMOPHILA HYGROPHANA 'BLUE BELLS BLUE BELLS EREMOPHILA						
0	2 OUTLETS EACH	1	2	ERICAMERIA LARICIFOLIA 'DESERT MOUNTAIN' TURPENTINE BUSH 'DESERT MOUNTAIN'						
$\bigcirc$	2 OUTLETS EACH	1	2	LEUCOPHYLLUM LANGMANIAE 'LYNN'S LEGACY TEXAS RANGER LYNN'S LEGACY						
<b>Ø</b>	2 OUTLETS EACH	1	2	TEUCRIUM CHAMAERDYS GERMANDER						
$\varnothing$	2 OUTLETS EACH	1	2	EREMOPHILA GLABRA 'MINGNEW GOLD' OUTBACK SUNRISE EMU						
$\oplus$	3 OUTLETS EACH	1	3	LANTANA X 'NEW GOLD' NEW GOLD LANTANA						
•	2 OUTLETS EACH	1	2	HESPERALOE PARVIFLORA 'DESERT FLAMENCO' 'DESERT FLAMENCO' FALSE YUCCA						

ASSEMBLY PER DETAIL 6, SHT. IR501 28 440.73100 INSTALL FLOW SENSOR ASSEMBLY 1" PER DETAIL 5, SHEET IR502 EΑ SUBI 440.74200 INSTALL MASTER VALVE ASSEMBLY 1<sup>1</sup>/<sub>2</sub>" PER DETAIL 5, SHEET IR502 EΑ 10. 440.76100 INSTALL REMOTE CONTROL VALVE, DRIP-1" PER DETAIL 1,SHEET IR501 EΑ S 11. 440.91000 INSTALL SOLAR POWER ASSEMBLY COMPLETE PER DETAIL 3, SHEET IMPROVEMENT EΑ 12. 632.01000 INSTALL REDUCED PRESSURE BACKFLOW UNIT. CONCRETE PAD. AND ENCLOSURE PER DETAIL 5/IR502 EA INSTALL SPARE WIRES FROM CONTROLLER TO STATION #1 (±2,450') AND TO #11 (±1,800') DRAINAGE AS FOLLOWS: (1)#10 COMMON, (2) #12 RED, TOTAL (±12,750') | ∞ ROADWAY ROAD HEIGHTS CHANDLER 잍 ROAD

IRRIGATION CONSTRUCTION NOTES (TYP)

DESCRIPTION

440.41000 INSTALL IRRIGATION CONTROLLER

440.60030 INSTALL PIPE-SCHEDULE 40-1"

440.60060 INSTALL PIPE-SCHEDULE 40-2"

440.62040 INSTALL SLEEVE-PIPE-SCHEDULE

440.71060 INSTALL GATE VALVE ASSEMBLY-2"

440.72200 INSTALL DRIP EMITTER ASSEMBLY-

440.72320 INSTALL DRIP LATERAL FLUSH CAP

4,5,9, SHEET IR501

ASSEMBLY SYSTEM PER

DETAILS 1,2, SHEET IR502

PER DETAIL 3, SHEET IR501

PER DETAIL 3. SHEET IR501

PER DETAIL 7, SHEET IR501

MULTI OUTLET PER DETAILS

40-4" PER DETAIL 2,SHEET IR501

UNIT QTY

LF 11,740

LF 4,110

LF 2,340

772 **\(\)(0/0\)** 

EΑ

EΑ

EΑ

ITEM BID ITEM

SHEET KEYMAP

IR001 | IR002 | IR003 | IR004 | IR005 | IR006 | IR007 | IR009 | IR010 | IR011 | IR012 | IR014 |



ontact Arizona 811 at least two full king days before you begin excavation



TOWN OF QUEEN CREEK

Chandler, Arizona 85226 Tel. 480.687.6100



Call 811 or click Arizona811.com


POWER ROAD: RIGGS ROAD TO CHANDLER HEIGHTS ROAD ROADWAY AND DRAINAGE IMPROVEMENTS

Stantec

IRRIGATION NOTES AND SCHEDULES

DESIGNED BY CB
DRAWN BY CB
CIP PROJ NO. A1405


DRAWING NO. IR101 SHEET 98 OF 133

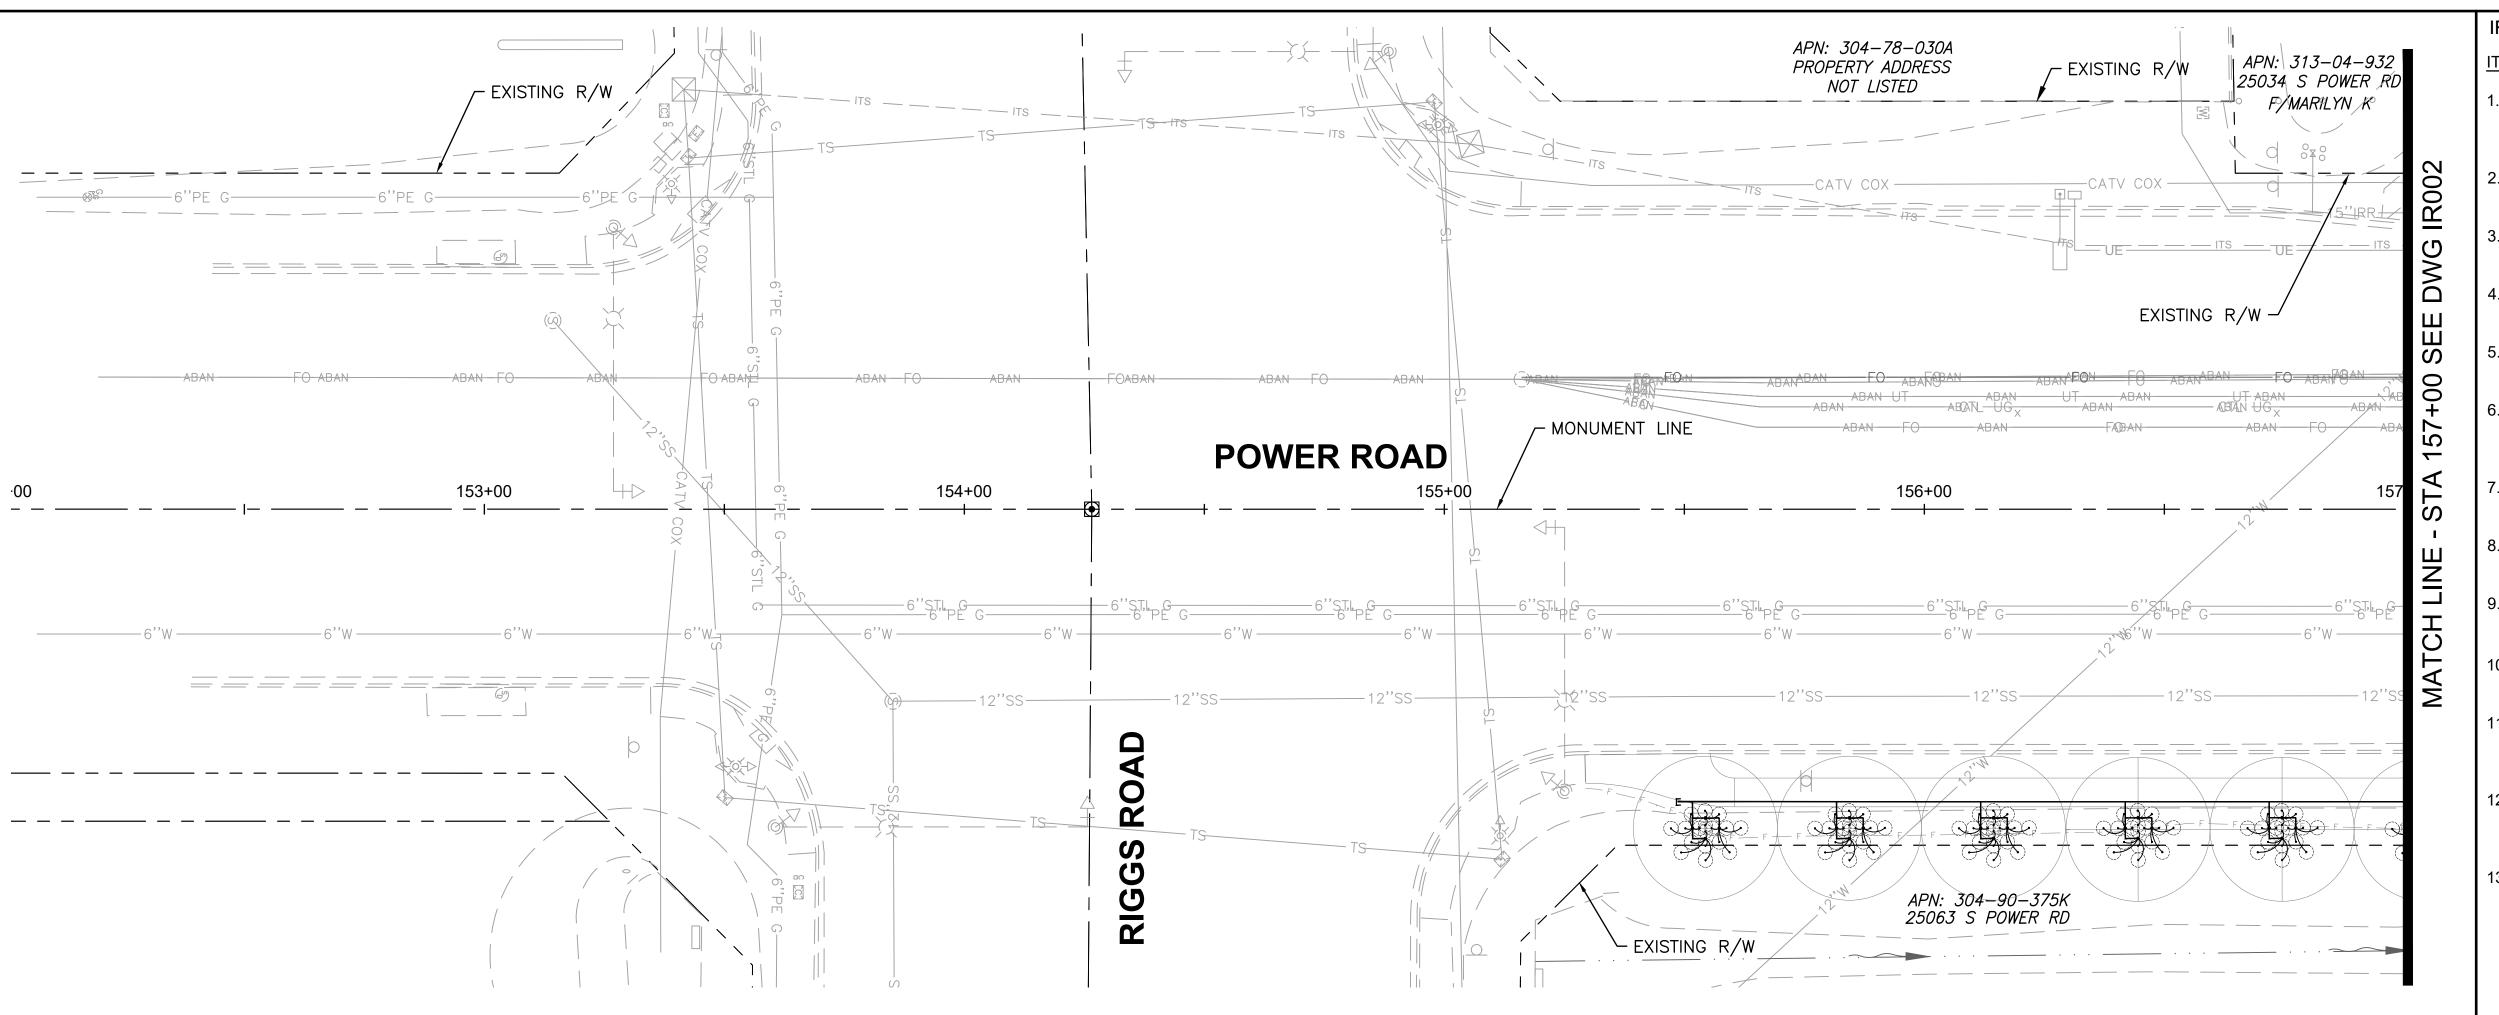


IRRIGATIO	ON SCHEDULE						
SYMBOL	MANUFACTURER/MODEL/DESCRIPTION	DETAIL	SHEET	SYMBOL	MANUFACTURER/MODEL/DESCRIPTION	DETAIL	SHEET
	DRIP VALVE ASSEMBLY: 1" RAINBIRD PEB SERIES VALVE, BRONZE BALL VALVE	1,8	IR501	F	FLOW SENSOR: WEATHERMATIC SLFSI-T10	5	IR502
	AND UNIONS WITH:	,,,,		S	SOLAR PANEL ASSEMBLY W/WEATHER STATION AND POLE: WEATHERMATIC SLSOLAR-48	3	IR502
	* FLOWS <u>UNDER</u> 5.0 GPM: INSTALL 3/4" RAINBIRD PRF-075-RBY IN-LINE PRESSURE REGULATING FILTER.			×	MANUAL BRONZE GATE VALVE (NIBCO T-113-K NON-RISING STEM)-LINE SIZE	7	IR501
	* FLOWS <u>OVER</u> 5.0 GPM: INSTALL 1" PRB-QKCHK-100 COMBO			-]	DRIP LATERAL FLUSH CAP ASSEMBLY; INCLUDES VALVE BOX	6	IR501
	QUICKCHECK/PRESSURE REGULATING BASKET FILTER.				(SHRUB) LATERAL LINE: 1" PVC SCHEDULE 40 PIPE EXCEPT WHERE NOTED	2,3	IR501
M	WATER METER-SEE CIVIL UTILITY PLANS	_	_		(TREE) LATERAL LINE: 1" PVC SCHEDULE 40 PIPE EXCEPT WHERE NOTED	2,3	IR501
$\otimes \otimes$	FEBCO LF825YA OR EQ. REDUCED PRESSURE PRINCIPAL ASSEMBLY (RPPA): INSTALL IN GUARDSHACK GS-4 ENCLOSURE (VERIFY SIZE TO RPPA ORDERED)	4	IR502		IRRIGATION MAINLINE: 2" PVC SCHEDULE 40 PIPE	2,3	IR501
С	IRRIGATION CONTROLLER: WEATHERMATIC SMARTLINE #SL4800SLR -1YR-BDL-FLOW (INCLUDES: #SLPED-ENC SS PEDESTAL, #SLW1 WIRELESS WEATHER STATION AND #SL-AIRCARD)	1,2	IR502	SL	SLEEVE (SL): PVC SCHEDULE 40 PIPE: INSTALL (1) 4" SL FOR CONTROL WIRE BUNDLED WITH (1) 4" SL FOR MAINLINE UNDER PAVEMENTS. INSTALL (1) SEPARATE 4" SL FOR LATERAL PIPES—(1) PIPE PER SLEEVE	2	IR501
M	MASTER VALVE: GRISWOLD DWS-150 BRASS 1.5" STRAIGHT (NORMALLY CLOSED) FLOW RANGE: 0.1 TO 30 GPM	5	IR502	EMITTERS	SEE EMITTER CHART, SCHEDULE, AND DETAILS	4,5,9	IR501

-	<u>VALVE</u>	CAL	LOUT		
	TRE	<u> S</u> •_		-Plant	Zone Type
	1	•—		-Valve	Station #
	1 "♥	1 •		- Valve	GPM
	——			- \/alvo	Sizo

SHEET	T KEYMAP											
	2	3	4	5 6	7	8	9	0	111   12	13	14	
IR0	01 IR002	IR003/	IR004 IR0	005   IR006/	IR007	IR008	IR009	IR010 IF	R011   IR012	JR013	IR014/	
27												

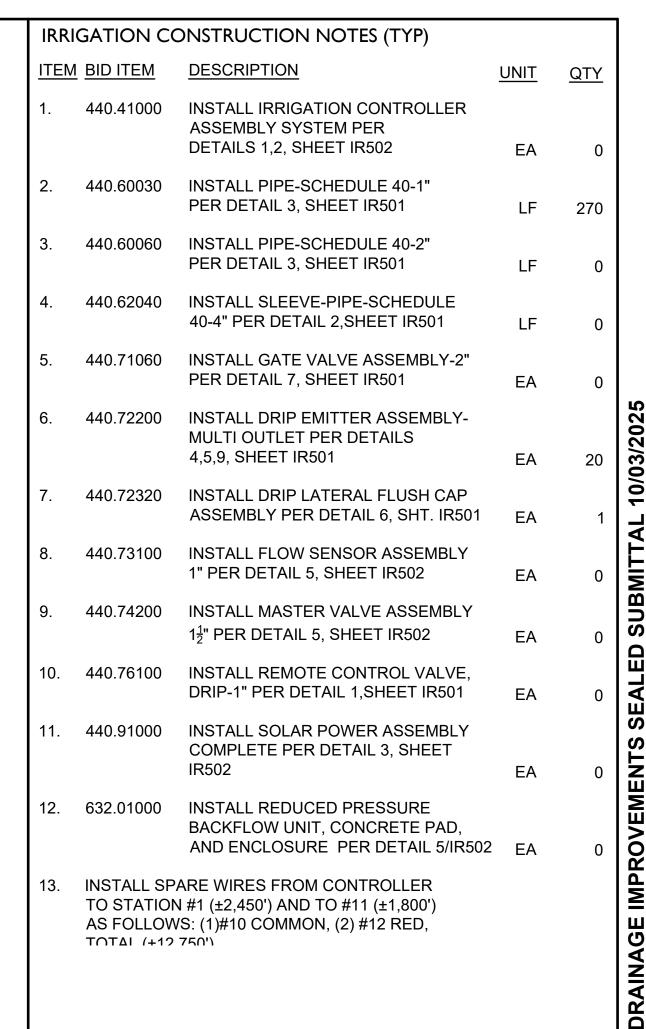


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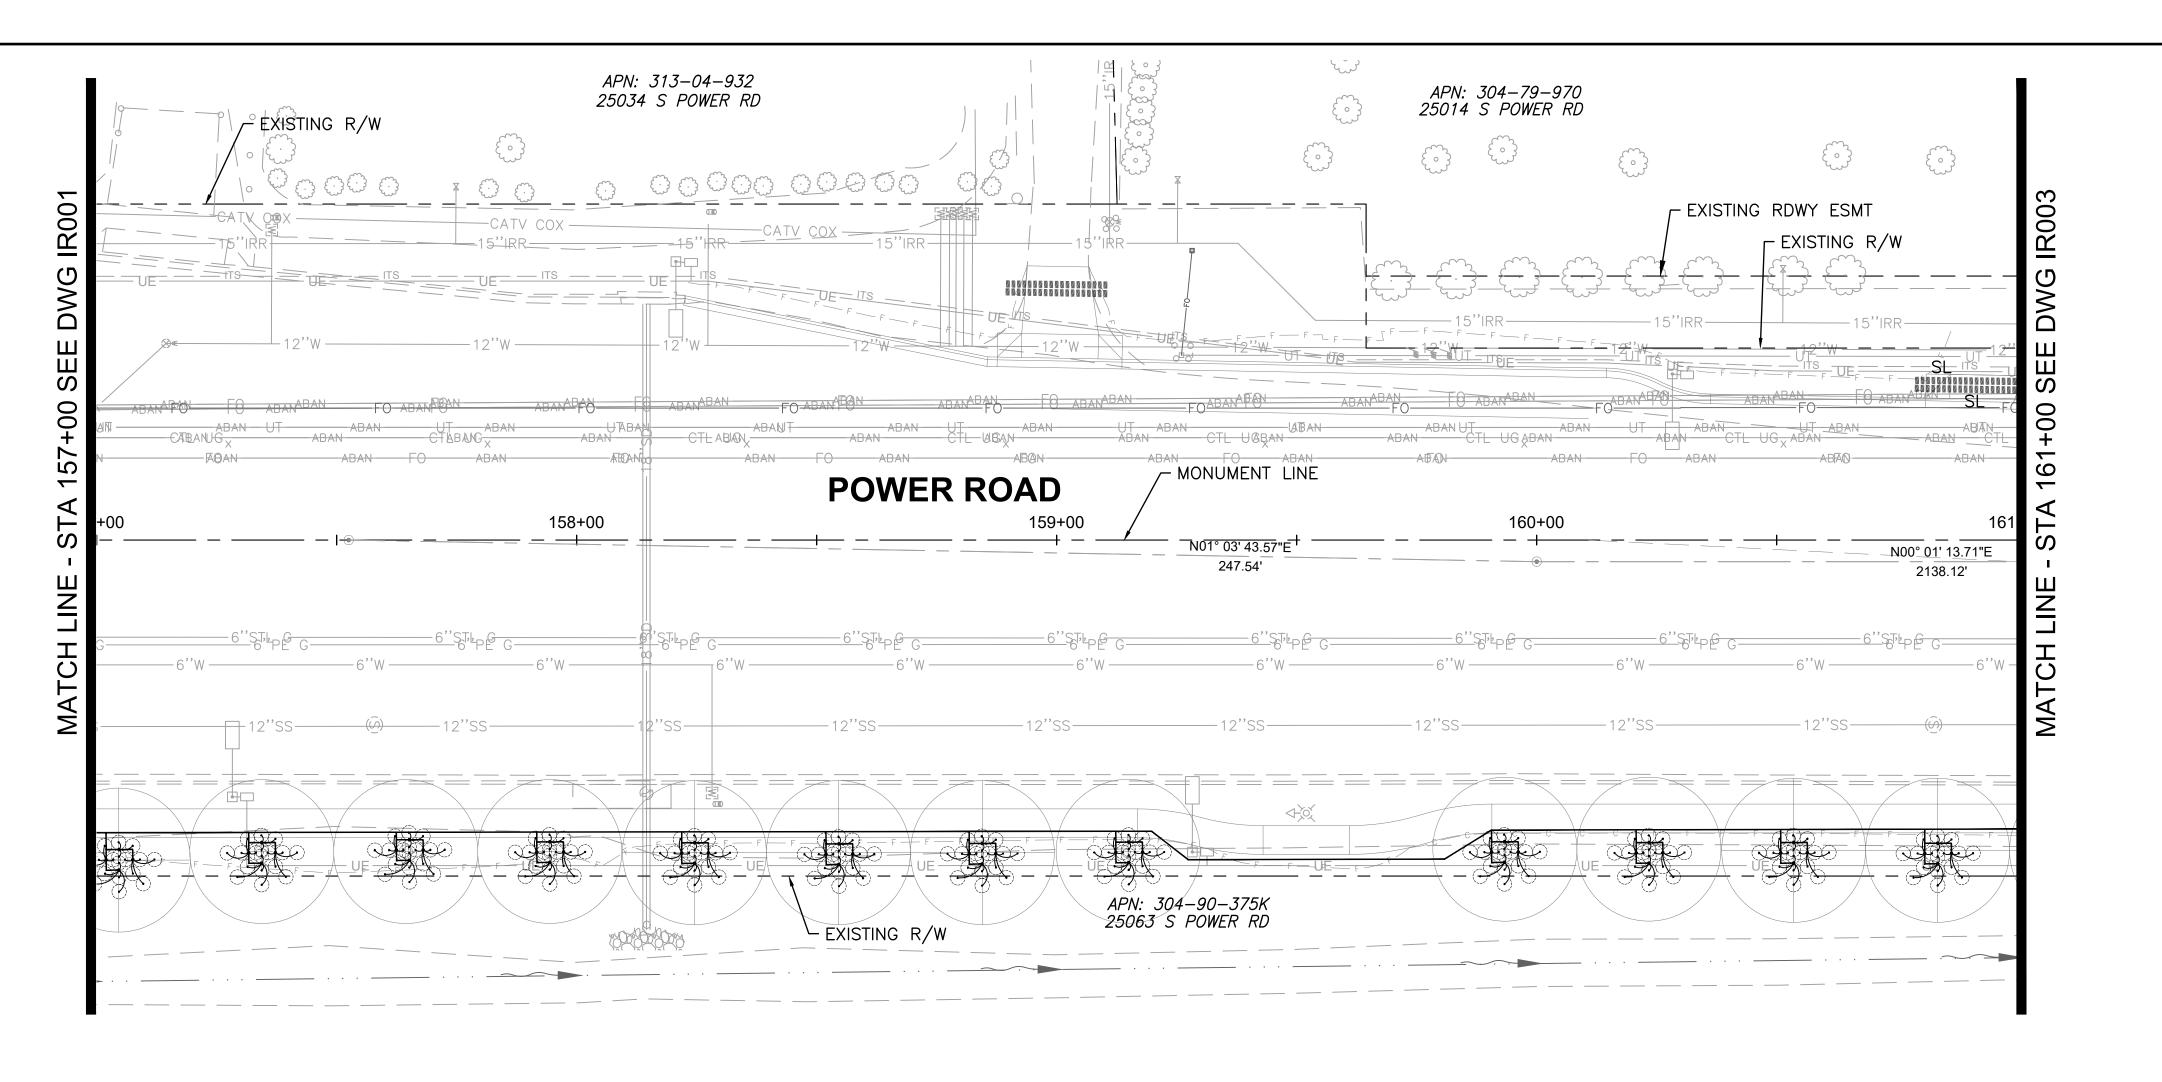
Chandler, Arizona 85226 Tel. 480.687.6100 www.stantec.com

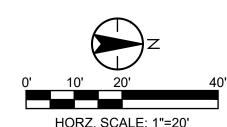

POWER ROAD: RIGGS ROAD TO CHANDLER HEIGHTS ROAD ROADWAY AND DRAINAGE IMPROVEMENTS

DESIGNED BY CB CIP PROJ NO. A1405 DRAWING NO.

IRRIGATION PLAN

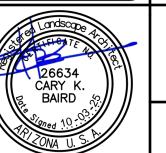

IRRIGATIO	ON SCHEDULE						
SYMBOL	MANUFACTURER/MODEL/DESCRIPTION	DETAIL	SHEET	SYMBOL	MANUFACTURER/MODEL/DESCRIPTION	DETAIL	SHEET
	DRIP VALVE ASSEMBLY: 1" RAINBIRD PEB SERIES VALVE, BRONZE BALL VALVE	1,8	IR501	F	FLOW SENSOR: WEATHERMATIC SLFSI-T10	5	IR502
	AND UNIONS WITH:			S	SOLAR PANEL ASSEMBLY W/WEATHER STATION AND POLE: WEATHERMATIC SLSOLAR-48	3	IR502
	* FLOWS <u>UNDER</u> 5.0 GPM: INSTALL 3/4" RAINBIRD PRF-075-RBY IN-LINE PRESSURE REGULATING FILTER.			×	MANUAL BRONZE GATE VALVE (NIBCO T-113-K NON-RISING STEM)-LINE SIZE	7	IR501
	* FLOWS <u>OVER</u> 5.0 GPM: INSTALL 1" PRB-QKCHK-100 COMBO			-3	DRIP LATERAL FLUSH CAP ASSEMBLY; INCLUDES VALVE BOX	6	IR501
	QUICKCHECK/PRESSURE REGULATING BASKET FILTER.				(SHRUB) LATERAL LINE: 1" PVC SCHEDULE 40 PIPE EXCEPT WHERE NOTED	2,3	IR501
M	WATER METER-SEE CIVIL UTILITY PLANS	_	_		(TREE) LATERAL LINE: 1" PVC SCHEDULE 40 PIPE EXCEPT WHERE NOTED	2,3	IR501
$\otimes \! \! \! \! \! \! \! \! \! \! \! \! \! \! \! \! \! \! \!$	FEBCO LF825YA OR EQ. REDUCED PRESSURE PRINCIPAL ASSEMBLY (RPPA): INSTALL IN GUARDSHACK GS-4 ENCLOSURE (VERIFY SIZE TO RPPA ORDERED)	4	IR502		IRRIGATION MAINLINE: 2" PVC SCHEDULE 40 PIPE	2,3	IR501
С	IRRIGATION CONTROLLER: WEATHERMATIC SMARTLINE #SL4800SLR -1YR-BDL-FLOW (INCLUDES: #SLPED-ENC SS PEDESTAL, #SLW1 WIRELESS WEATHER STATION AND #SL-AIRCARD)	1,2	IR502	SL	SLEEVE (SL): PVC SCHEDULE 40 PIPE: INSTALL (1) 4" SL FOR CONTROL WIRE BUNDLED WITH (1) 4" SL FOR MAINLINE UNDER PAVEMENTS. INSTALL (1) SEPARATE 4" SL FOR LATERAL PIPES—(1) PIPE PER SLEEVE	2	IR501
M	MASTER VALVE: GRISWOLD DWS-150 BRASS 1.5" STRAIGHT (NORMALLY CLOSED) FLOW RANGE: 0.1 TO 30 GPM	5	IR502	EMITTERS	SEE EMITTER CHART, SCHEDULE, AND DETAILS	4,5,9	IR501

VALVE CALLOUT

—Plant Zone Type ──Valve Station # — Valve GPM -Valve Size

TOWN OF QUEEN CREEK

IRRIGATION CONSTRUCTION NOTES (TYP)

440.41000 INSTALL IRRIGATION CONTROLLER

440.60030 INSTALL PIPE-SCHEDULE 40-1"

440.60060 INSTALL PIPE-SCHEDULE 40-2"

440.62040 INSTALL SLEEVE-PIPE-SCHEDULE

440.71060 INSTALL GATE VALVE ASSEMBLY-2"

440.72200 INSTALL DRIP EMITTER ASSEMBLY-

440.72320 INSTALL DRIP LATERAL FLUSH CAP

440.73100 INSTALL FLOW SENSOR ASSEMBLY

440.74200 INSTALL MASTER VALVE ASSEMBLY

10. 440.76100 INSTALL REMOTE CONTROL VALVE,

11. 440.91000 INSTALL SOLAR POWER ASSEMBLY

12. 632.01000 INSTALL REDUCED PRESSURE

13. INSTALL SPARE WIRES FROM CONTROLLER

TO STATION #1 (±2,450') AND TO #11 (±1,800') AS FOLLOWS: (1)#10 COMMON, (2) #12 RED,

IR502

TOTAL (+12 750')

4,5,9, SHEET IR501

ASSEMBLY SYSTEM PER DETAILS 1,2, SHEET IR502

PER DETAIL 3, SHEET IR501

PER DETAIL 3, SHEET IR501

PER DETAIL 7, SHEET IR501

MULTI OUTLET PER DETAILS

1" PER DETAIL 5, SHEET IR502

1½" PER DETAIL 5, SHEET IR502

DRIP-1" PER DETAIL 1,SHEET IR501

COMPLETE PER DETAIL 3, SHEET

BACKFLOW UNIT, CONCRETE PAD,

AND ENCLOSURE PER DETAIL 5/IR502 EA

ASSEMBLY PER DETAIL 6. SHT. IR501

40-4" PER DETAIL 2,SHEET IR501

ITEM BID ITEM DESCRIPTION

QTY

<u>UNIT</u>

EΑ

LF

LF

LF

EA

EΑ

EΑ

DRAINAGE IMPROVEMENTS

	h 1	2	<b>3</b>	4	5	6	7	8	9	10		12	13	14	
_	IR001	IR002	IR003/	IR004	JR005	IR006	IR007	IR008	IR009	IR010	IR011	IR012	IR013	IR014	
				1											_
															H


POWER ROAD: RIGGS ROAD TO CHANDLER HEIGHTS ROAD ROADWAY AND DRAINAGE IMPROVEMENTS

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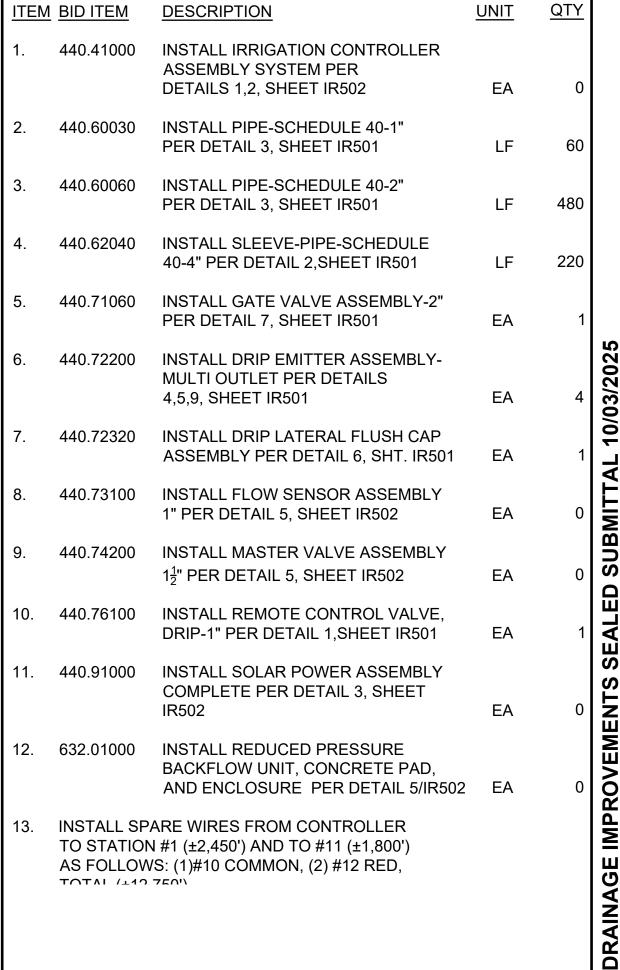
IRRIGATION PLAN 2 DESIGNED BY CB CIP PROJ NO. A1405


SHEET 100 OF 133 IR002 DRAWING NO.



IRRIGATIO	ON SCHEDULE					_				
SYMBOL	MANUFACTURER/MODEL/DESCRIPTION	DETAIL	SHEET	SYMBOL	MANUFACTURER/MODEL/DESCRIPTION	DETAIL	SHEET			
	DRIP VALVE ASSEMBLY: 1" RAINBIRD PEB SERIES VALVE, BRONZE BALL VALVE	1,8	IR501	F	FLOW SENSOR: WEATHERMATIC SLFSI-T10	5	IR502			
	AND UNIONS WITH:	,,,,,	11.001	S	SOLAR PANEL ASSEMBLY W/WEATHER STATION AND POLE: WEATHERMATIC SLSOLAR-48	3	IR502			
	* FLOWS <u>UNDER</u> 5.0 GPM: INSTALL 3/4" RAINBIRD PRF-075-RBY IN-LINE PRESSURE REGULATING FILTER.			×	MANUAL BRONZE GATE VALVE (NIBCO T-113-K NON-RISING STEM)-LINE SIZE	7	IR501			
	* FLOWS <u>OVER</u> 5.0 GPM: INSTALL 1" PRB-QKCHK-100 COMBO			-3	DRIP LATERAL FLUSH CAP ASSEMBLY; INCLUDES VALVE BOX	6	IR501			
	QUICKCHECK/PRESSURE REGULATING BASKET FILTER.				(SHRUB) LATERAL LINE: 1" PVC SCHEDULE 40 PIPE EXCEPT WHERE NOTED	2,3				
M	WATER METER-SEE CIVIL UTILITY PLANS	_	_		(TREE) LATERAL LINE: 1" PVC SCHEDULE 40 PIPE EXCEPT WHERE NOTED	2,3	IR501			
$\otimes\!$	FEBCO LF825YA OR EQ. REDUCED PRESSURE PRINCIPAL ASSEMBLY (RPPA): INSTALL IN GUARDSHACK GS-4 ENCLOSURE (VERIFY SIZE TO RPPA ORDERED)	4	IR502		IRRIGATION MAINLINE: 2" PVC SCHEDULE 40 PIPE	2,3	IR501			
С	IRRIGATION CONTROLLER: WEATHERMATIC SMARTLINE #SL4800SLR -1YR-BDL-FLOW (INCLUDES: #SLPED-ENC SS PEDESTAL, #SLW1 WIRELESS WEATHER STATION AND #SL-AIRCARD)	1,2	IR502	SL	SLEEVE (SL): PVC SCHEDULE 40 PIPE: INSTALL (1) 4" SL FOR CONTROL WIRE BUNDLED WITH (1) 4" SL FOR MAINLINE UNDER PAVEMENTS. INSTALL (1) SEPARATE 4" SL FOR LATERAL PIPES—(1) PIPE PER SLEEVE	2	IR501			
M	MASTER VALVE: GRISWOLD DWS-150 BRASS 1.5" STRAIGHT (NORMALLY CLOSED) FLOW RANGE: 0.1 TO 30 GPM	5	IR502	EMITTERS	SEE EMITTER CHART, SCHEDULE, AND DETAILS	4,5,9	IR501			

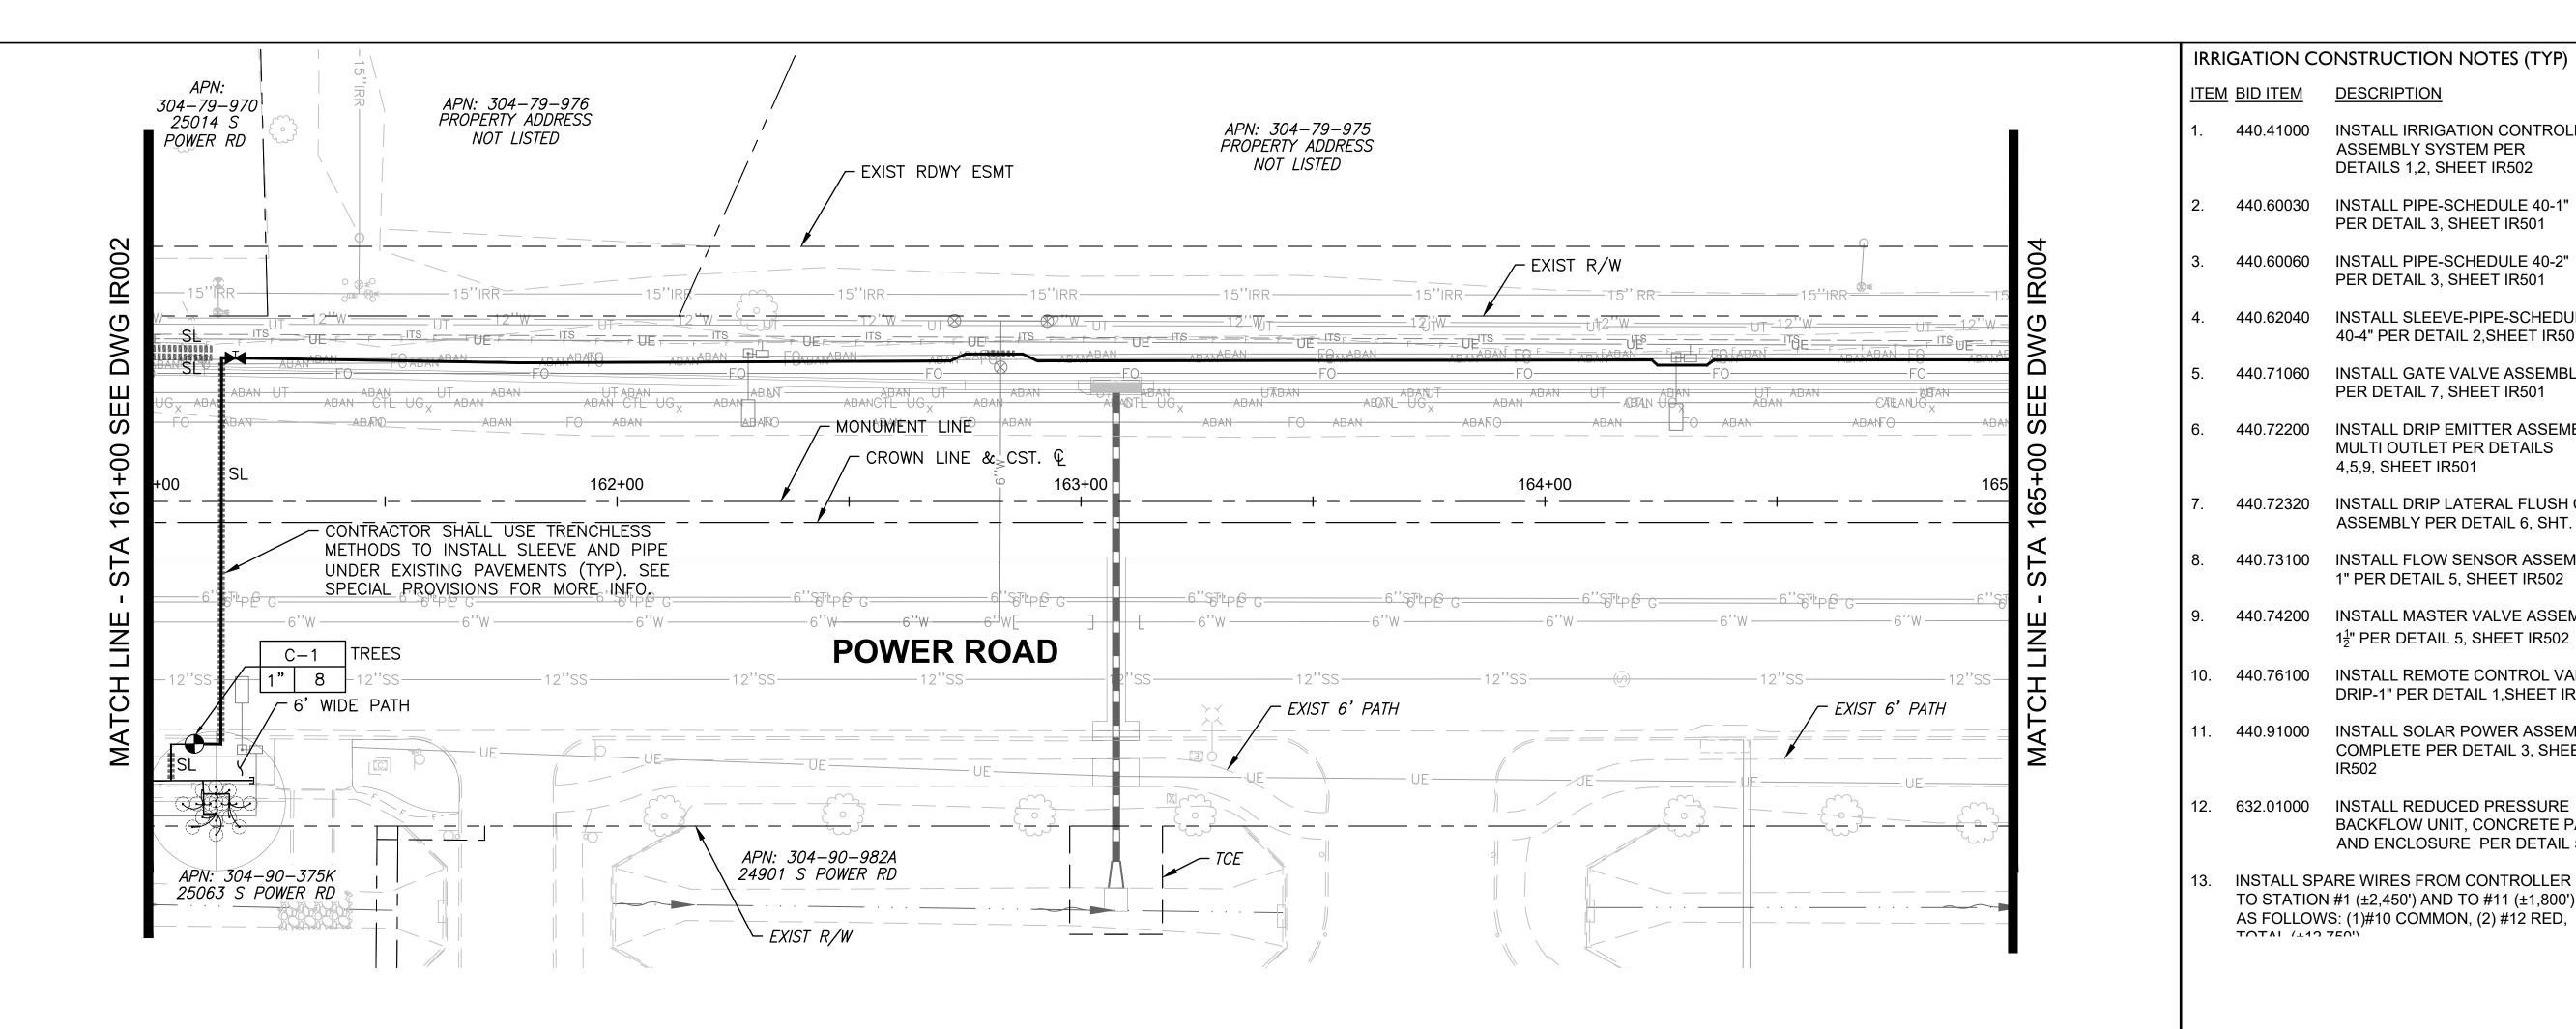
VALVE CALLOUT ——Plant Zone Type ─Valve Station # —Valve GPM -Valve Size



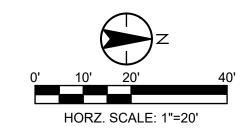



TOWN OF QUEEN CREEK

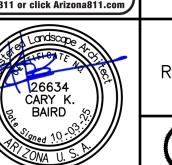

POWER ROAD: RIGGS ROAD TO CHANDLER HEIGHTS ROAD ROADWAY AND DRAINAGE IMPROVEMENTS

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IRRIGATION PLAN 3

DESIGNED BY CB CIP PROJ NO. A1405 SHEET 101 OF 133 IR003 DRAWING NO.

SHEET KEYMAP

IR003 | IR004 | IR005 | IR006 | IR007 | IR008 | IR009 | IR010 | IR011 | IR012 | IR013 | IR014/

IRRIGATION SCHEDULE										
SYMBOL	MANUFACTURER/MODEL/DESCRIPTION	DETAIL	SHEET	SYMBOL	MANUFACTURER/MODEL/DESCRIPTION	DETAIL	SHEET			
	DRIP VALVE ASSEMBLY: 1" RAINBIRD PEB SERIES VALVE, BRONZE BALL VALVE	1,8	IR501	F	FLOW SENSOR: WEATHERMATIC SLFSI-T10	5	IR502			
	AND UNIONS WITH:		11.001	S	SOLAR PANEL ASSEMBLY W/WEATHER STATION AND POLE: WEATHERMATIC SLSOLAR-48	3	IR502			
	* FLOWS <u>UNDER</u> 5.0 GPM: INSTALL 3/4" RAINBIRD PRF-075-RBY IN-LINE PRESSURE REGULATING FILTER.			×	MANUAL BRONZE GATE VALVE (NIBCO T-113-K NON-RISING STEM)-LINE SIZE	7	IR501			
	* FLOWS <u>OVER</u> 5.0 GPM: INSTALL 1" PRB-QKCHK-100 COMBO				DRIP LATERAL FLUSH CAP ASSEMBLY; INCLUDES VALVE BOX	6	IR501			
	QUICKCHECK/PRESSURE REGULATING BASKET FILTER.				(SHRUB) LATERAL LINE: 1" PVC SCHEDULE 40 PIPE EXCEPT WHERE NOTED	2,3	IR501			
M	WATER METER-SEE CIVIL UTILITY PLANS	_	_		(TREE) LATERAL LINE: 1" PVC SCHEDULE 40 PIPE EXCEPT WHERE NOTED	2,3	IR501			
$\otimes\!$	FEBCO LF825YA OR EQ. REDUCED PRESSURE PRINCIPAL ASSEMBLY (RPPA): INSTALL IN GUARDSHACK GS-4 ENCLOSURE (VERIFY SIZE TO RPPA ORDERED)	4	IR502		IRRIGATION MAINLINE: 2" PVC SCHEDULE 40 PIPE	2,3	IR501			
С	IRRIGATION CONTROLLER: WEATHERMATIC SMARTLINE #SL4800SLR -1YR-BDL-FLOW (INCLUDES: #SLPED-ENC SS PEDESTAL, #SLW1 WIRELESS WEATHER STATION AND #SL-AIRCARD)	1,2	IR502	SL		2	IR501			
M	MASTER VALVE: GRISWOLD DWS-150 BRASS 1.5" STRAIGHT (NORMALLY CLOSED) FLOW RANGE: 0.1 TO 30 GPM	5	IR502	EMITTERS	SEE EMITTER CHART, SCHEDULE, AND DETAILS	4,5,9	IR501			

VALVE CALLOUT	
1 • V	lant Zone Type alve Station # alve GPM alve Size

Landscape 44 CARY K. BAIRD S.	
20ned 10.53	

# TOWN OF

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POWER ROAD: RIGGS ROAD TO CHANDLER HEIGHTS ROAD ROADWAY AND DRAINAGE IMPROVEMENTS

Stantec

IRRIGATION PLAN 4

DESIGNED BY CB CIP PROJ NO. A1405 IR004 DRAWING NO.

SHEET KEYMAP

	2	3	4	5	6	7	8	9	10		12	13	14
IR001	IR002	. IR003	IR004	IR005	IR006	IR007	IRO08	IR009	IR010	IR044	IR042	IR013	IR014
					. =								

<u>UNIT</u>


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IRRIGATION CONSTRUCTION NOTES (TYP)


1. 440.41000 INSTALL IRRIGATION CONTROLLER

ASSEMBLY SYSTEM PER


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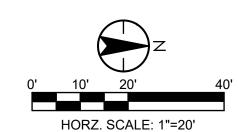


IRRIGATION SCHEDULE										
SYMBOL	MANUFACTURER/MODEL/DESCRIPTION	DETAIL	SHEET	SYMBOL	MANUFACTURER/MODEL/DESCRIPTION	DETAIL	SHEET			
	DRIP VALVE ASSEMBLY: 1" RAINBIRD PEB SERIES VALVE, BRONZE BALL VALVE		IR501	F	FLOW SENSOR: WEATHERMATIC SLFSI-T10	5	IR502			
	AND UNIONS WITH:	1,8		S	SOLAR PANEL ASSEMBLY W/WEATHER STATION AND POLE: WEATHERMATIC SLSOLAR-48	3	IR502			
	* FLOWS <u>UNDER</u> 5.0 GPM: INSTALL 3/4" RAINBIRD PRF-075-RBY IN-LINE PRESSURE REGULATING FILTER.			<b>M</b>	MANUAL BRONZE GATE VALVE (NIBCO T-113-K NON-RISING STEM)-LINE SIZE	7	IR501			
	* FLOWS <u>OVER</u> 5.0 GPM: INSTALL 1" PRB-QKCHK-100 COMBO			-]	DRIP LATERAL FLUSH CAP ASSEMBLY; INCLUDES VALVE BOX	6	IR501			
	QUICKCHECK/PRESSURE REGULATING BASKET FILTER.				(SHRUB) LATERAL LINE: 1" PVC SCHEDULE 40 PIPE EXCEPT WHERE NOTED	2,3	IR501			
M	WATER METER-SEE CIVIL UTILITY PLANS	_	_		(TREE) LATERAL LINE: 1" PVC SCHEDULE 40 PIPE EXCEPT WHERE NOTED	2,3	IR501			
$\otimes\!$	FEBCO LF825YA OR EQ. REDUCED PRESSURE PRINCIPAL ASSEMBLY (RPPA): INSTALL IN GUARDSHACK GS-4 ENCLOSURE (VERIFY SIZE TO RPPA ORDERED)	4	IR502		IRRIGATION MAINLINE: 2" PVC SCHEDULE 40 PIPE	2,3	IR501			
С	IRRIGATION CONTROLLER: WEATHERMATIC SMARTLINE #SL4800SLR -1YR-BDL-FLOW (INCLUDES: #SLPED-ENC SS PEDESTAL, #SLW1 WIRELESS WEATHER STATION AND #SL-AIRCARD)	1,2	IR502	SL	SLEEVE (SL): PVC SCHEDULE 40 PIPE: INSTALL (1) 4" SL FOR CONTROL WIRE BUNDLED WITH (1) 4" SL FOR MAINLINE UNDER PAVEMENTS. INSTALL (1) SEPARATE 4" SL FOR LATERAL PIPES—(1) PIPE PER SLEEVE	2	IR501			
M	MASTER VALVE: GRISWOLD DWS-150 BRASS 1.5" STRAIGHT (NORMALLY CLOSED) FLOW RANGE: 0.1 TO 30 GPM	5	IR502	EMITTERS	SEE EMITTER CHART, SCHEDULE, AND DETAILS	4,5,9	IR501			

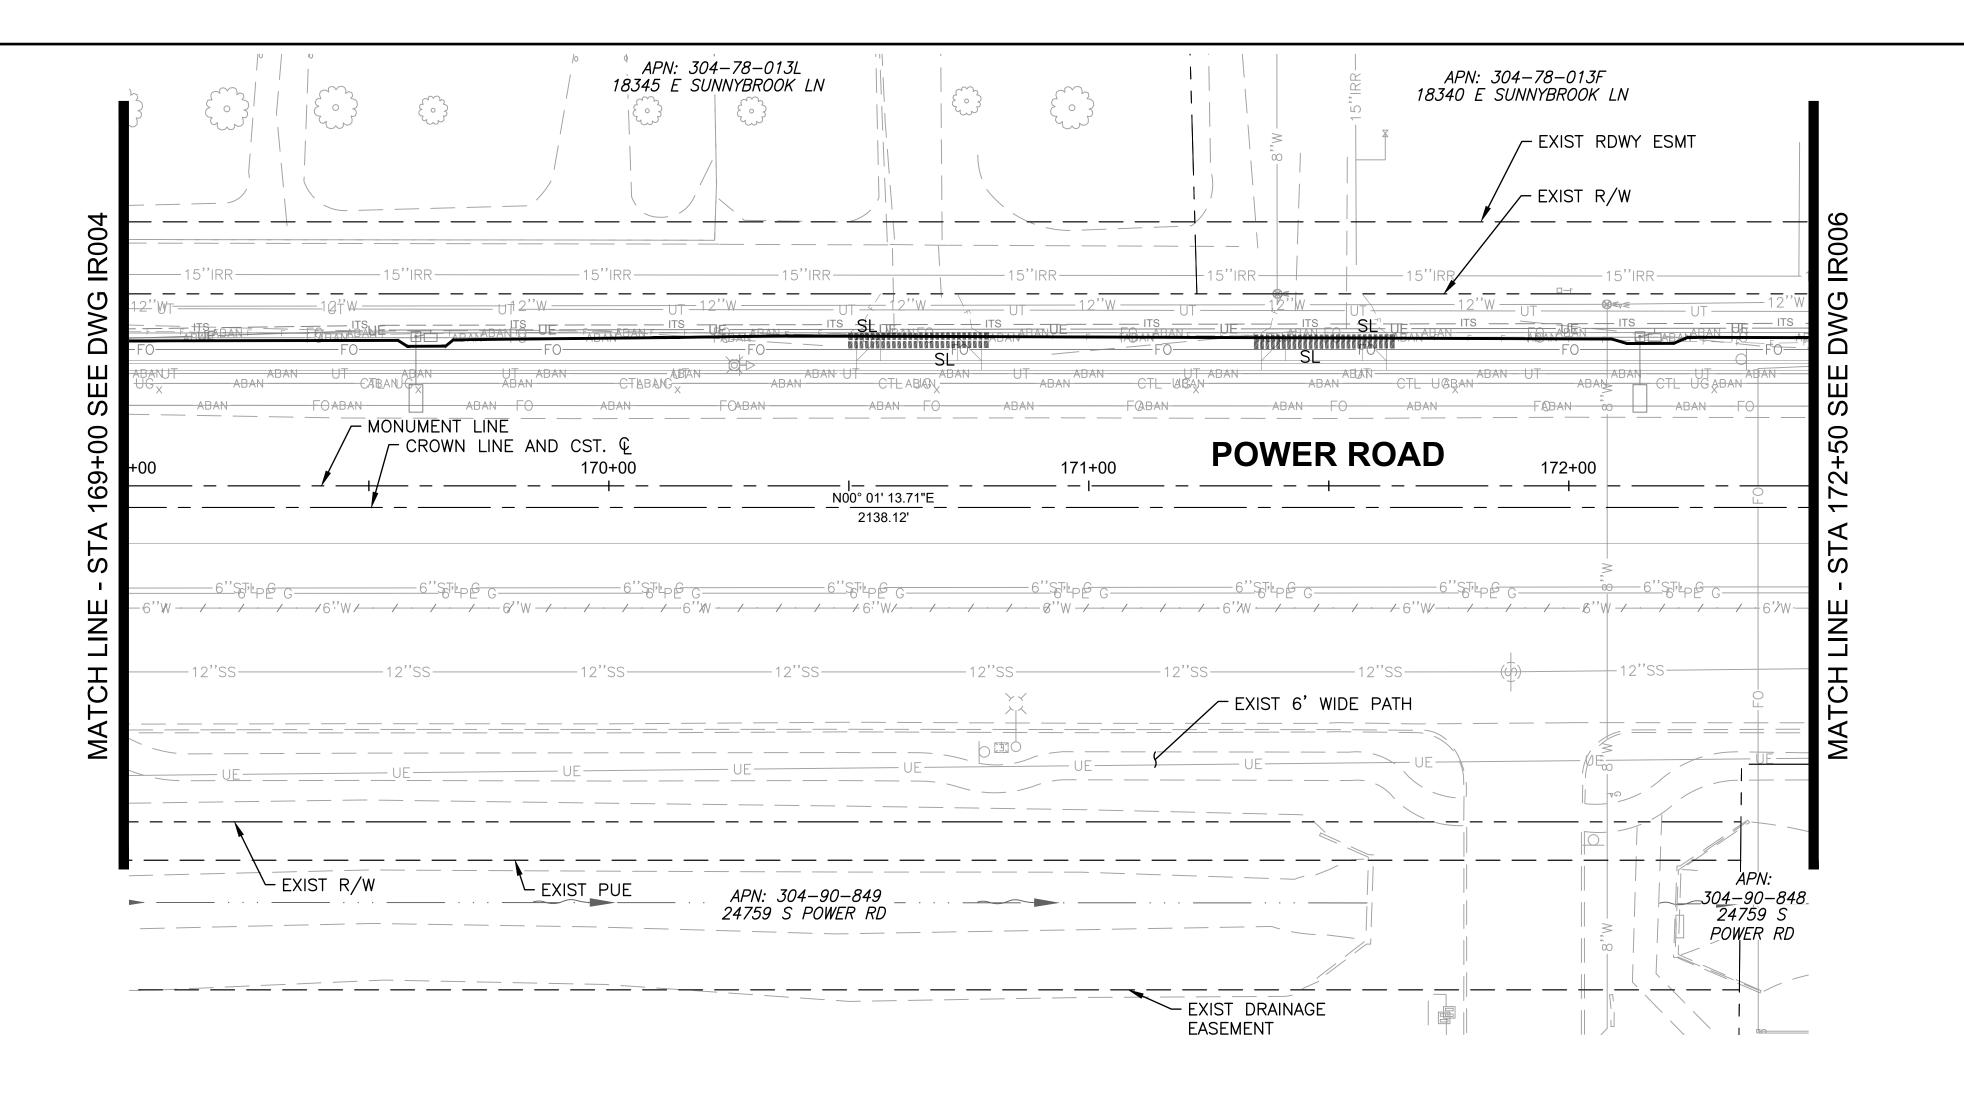

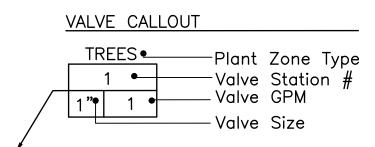SHEET KEYMAP													
1 2	3	4	5	6	7	8	9	10		12	13	_14_	
IR001 IR002	IR003/	TR004	9IR005	IR006   II	<del>2</del> 007	IROO8	IR009	IR010	IR011	IR012	IR013	IR014	
				. JE	-								




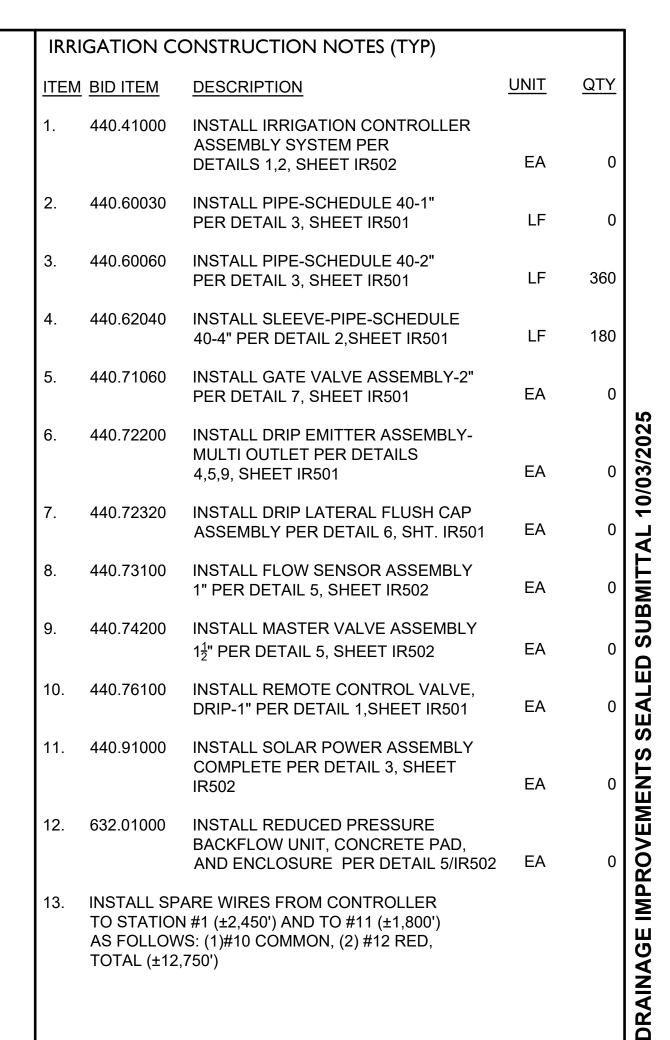





TOWN OF QUEEN CREEK

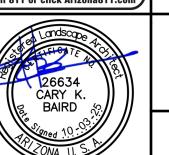

POWER ROAD: RIGGS ROAD TO CHANDLER HEIGHTS ROAD ROADWAY AND DRAINAGE IMPROVEMENTS

Stantec

Chandler, Arizona 85226 Tel. 480.687.6100 IRRIGATION PLAN 5


	111	MIGATION FLAN J
NED BY	CB	CIP PROJ NO. A1405
1 BY	CB	CIP PROJ NO. A1405
		10005


IR005 DRAWING NO.


IRRIGATIO	ON SCHEDULE						
SYMBOL	MANUFACTURER/MODEL/DESCRIPTION	DETAIL	SHEET	SYMBOL	MANUFACTURER/MODEL/DESCRIPTION	DETAIL	SHEET
	DRIP VALVE ASSEMBLY: 1" RAINBIRD PEB SERIES VALVE, BRONZE BALL VALVE	1,8	IR501	F	FLOW SENSOR: WEATHERMATIC SLFSI-T10	5	IR502
	AND UNIONS WITH:			S	SOLAR PANEL ASSEMBLY W/WEATHER STATION AND POLE: WEATHERMATIC SLSOLAR-48	3	IR502
	* FLOWS <u>UNDER</u> 5.0 GPM: INSTALL 3/4" RAINBIRD PRF-075-RBY IN-LINE PRESSURE REGULATING FILTER.			×	MANUAL BRONZE GATE VALVE (NIBCO T-113-K NON-RISING STEM)-LINE SIZE	7	IR501
	* FLOWS <u>OVER</u> 5.0 GPM: INSTALL 1" PRB-QKCHK-100 COMBO			口	DRIP LATERAL FLUSH CAP ASSEMBLY; INCLUDES VALVE BOX	6	IR501
	QUICKCHECK/PRESSURE REGULATING BASKET FILTER.				(SHRUB) LATERAL LINE: 1" PVC SCHEDULE 40 PIPE EXCEPT WHERE NOTED	2,3	IR501
M	WATER METER-SEE CIVIL UTILITY PLANS	_	_		(TREE) LATERAL LINE: 1" PVC SCHEDULE 40 PIPE EXCEPT WHERE NOTED	2,3	IR501
$\otimes\!$	FEBCO LF825YA OR EQ. REDUCED PRESSURE PRINCIPAL ASSEMBLY (RPPA): INSTALL IN GUARDSHACK GS-4 ENCLOSURE (VERIFY SIZE TO RPPA ORDERED)	4	IR502		IRRIGATION MAINLINE: 2" PVC SCHEDULE 40 PIPE	2,3	IR501
С	IRRIGATION CONTROLLER: WEATHERMATIC SMARTLINE #SL4800SLR -1YR-BDL-FLOW (INCLUDES: #SLPED-ENC SS PEDESTAL, #SLW1 WIRELESS WEATHER STATION AND #SL-AIRCARD)	1,2	IR502	SL	SLEEVE (SL): PVC SCHEDULE 40 PIPE: INSTALL (1) 4" SL FOR CONTROL WIRE BUNDLED WITH (1) 4" SL FOR MAINLINE UNDER PAVEMENTS. INSTALL (1) SEPARATE 4" SL FOR LATERAL PIPES—(1) PIPE PER SLEEVE	2	IR501
M	MASTER VALVE: GRISWOLD DWS-150 BRASS 1.5" STRAIGHT (NORMALLY CLOSED) FLOW RANGE: 0.1 TO 30 GPM	5	IR502	EMITTERS	SEE EMITTER CHART, SCHEDULE, AND DETAILS	4,5,9	IR501

VALVE CALLOUT	
1 • Valve	Zone Type Station # GPM Size

SHEET KEYMAP					
IR001 IR002	IR003 IR004 IR005	IR006 IR007 IR008	IR009 IR010	IR011   IR012   IR0	10 11017

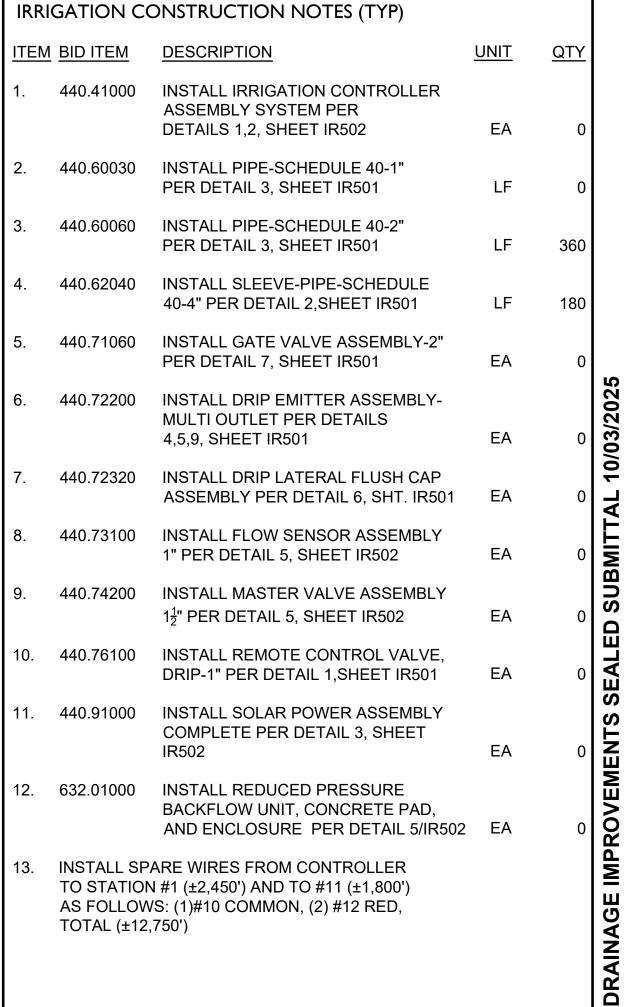

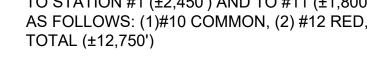

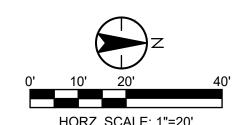





TOWN OF QUEEN CREEK

Chandler, Arizona 85226 Tel. 480.687.6100 www.stantec.com




POWER ROAD: RIGGS ROAD TO CHANDLER HEIGHTS ROAD ROADWAY AND DRAINAGE IMPROVEMENTS

**Stantec** 


IRRIGATION PLAN 6

DESIGNED BY CB CIP PROJ NO. A1405 IR006 DRAWING NO.

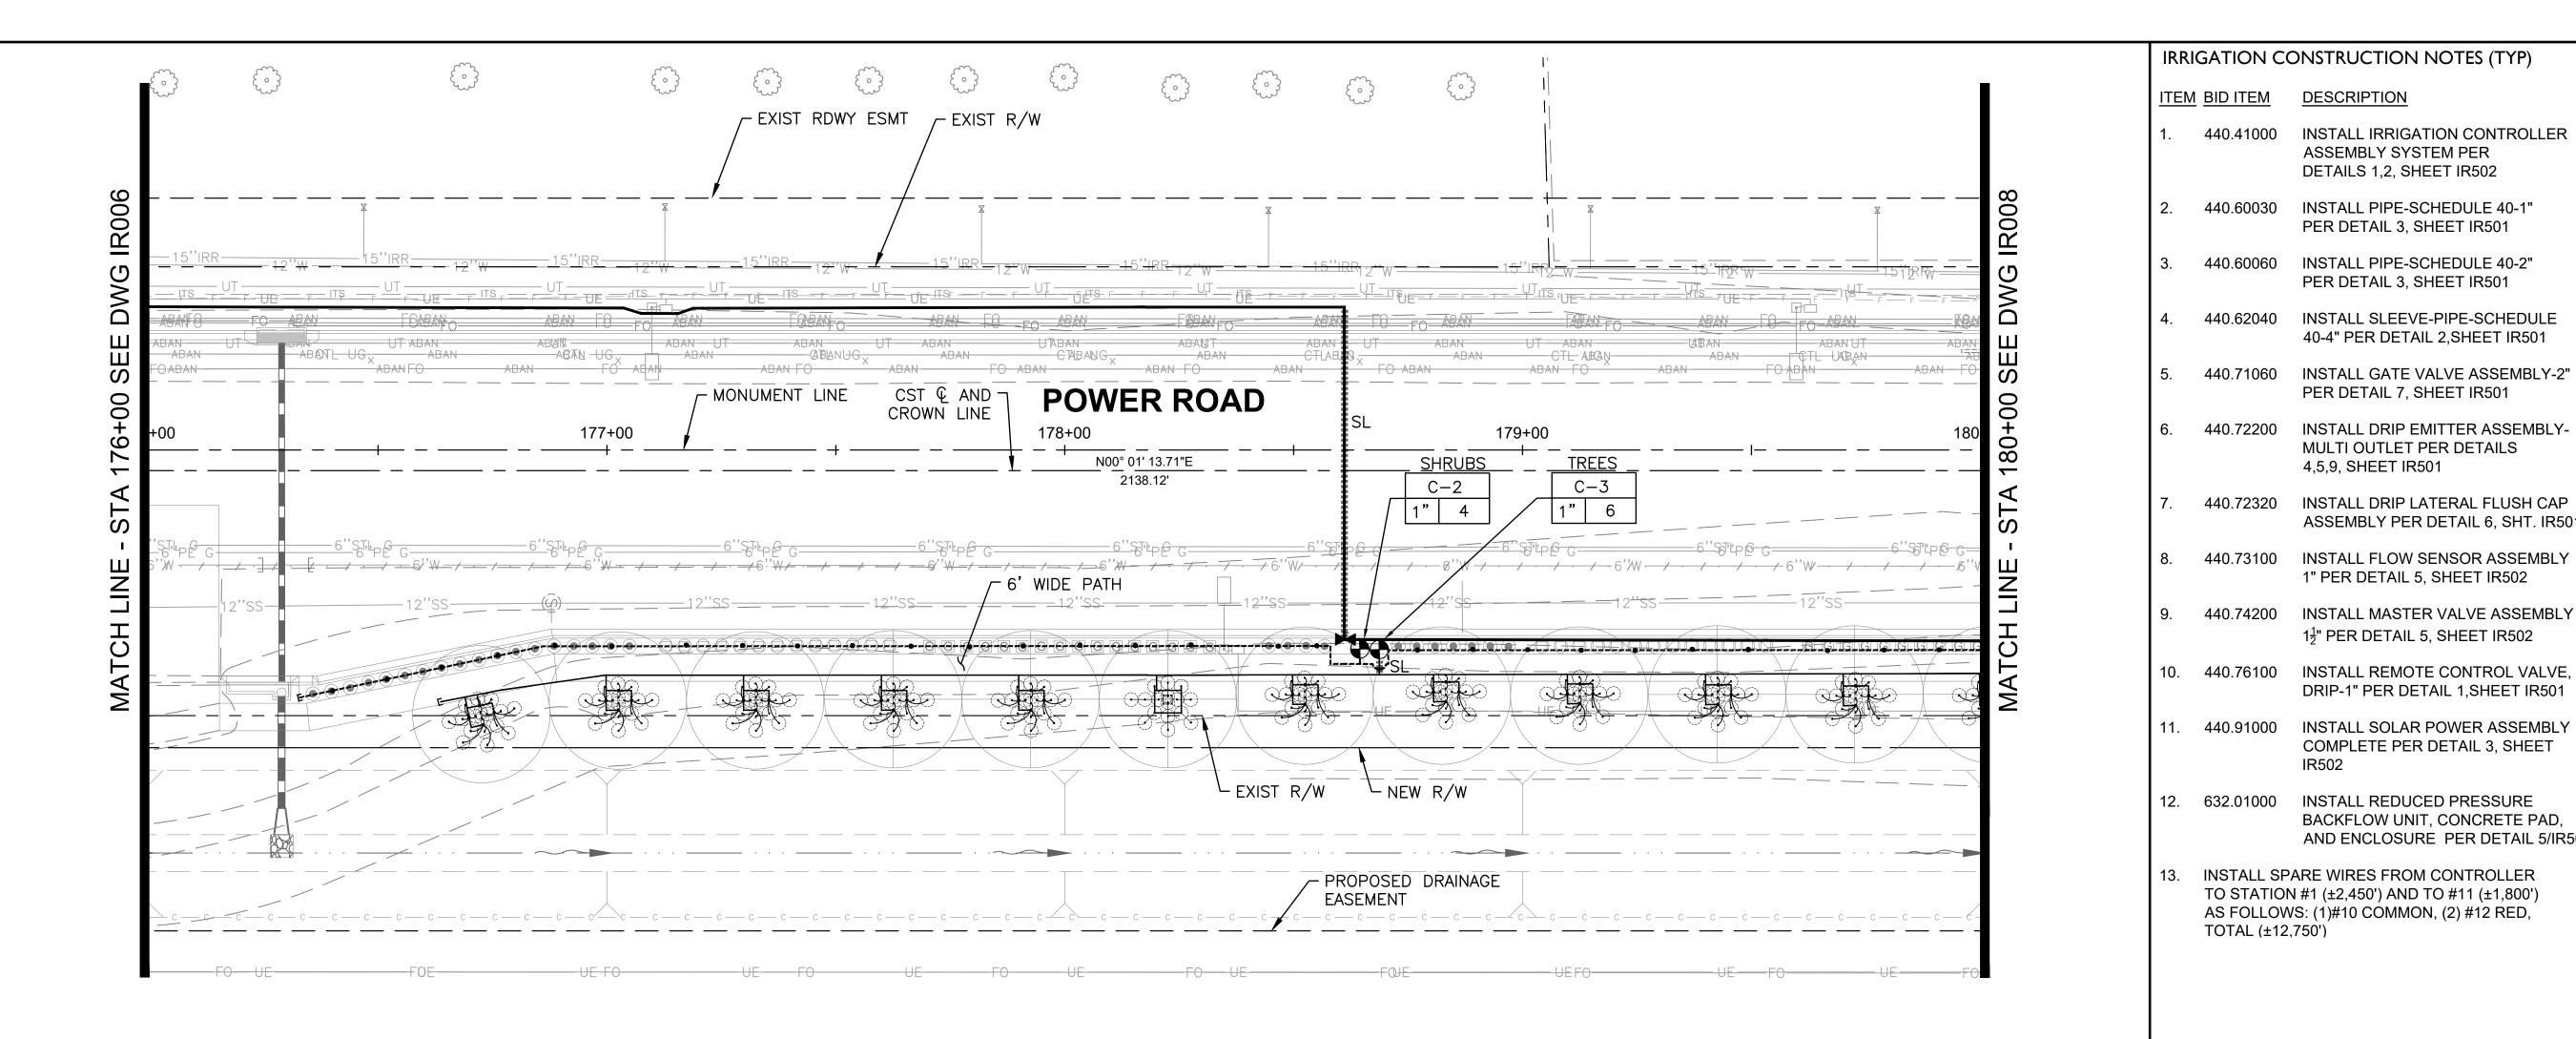

IRRIGATION SCHEDULE										
SYMBOL	MANUFACTURER/MODEL/DESCRIPTION	DETAIL	SHEET	SYMBOL	MANUFACTURER/MODEL/DESCRIPTION	DETAIL	SHEET			
	DRIP VALVE ASSEMBLY: 1" RAINBIRD PEB SERIES VALVE, BRONZE BALL VALVE	1.8	IR501	F	FLOW SENSOR: WEATHERMATIC SLFSI-T10	5	IR502			
	AND UNIONS WITH:	,,,,,	11.001	S	SOLAR PANEL ASSEMBLY W/WEATHER STATION AND POLE: WEATHERMATIC SLSOLAR-48	3	IR502			
	* FLOWS <u>UNDER</u> 5.0 GPM: INSTALL 3/4" RAINBIRD PRF-075-RBY IN-LINE PRESSURE REGULATING FILTER.			×	MANUAL BRONZE GATE VALVE (NIBCO T-113-K NON-RISING STEM)-LINE SIZE	7	IR501			
	* FLOWS <u>OVER</u> 5.0 GPM: INSTALL 1" PRB-QKCHK-100 COMBO			-]	DRIP LATERAL FLUSH CAP ASSEMBLY; INCLUDES VALVE BOX	6	IR501			
	QUICKCHECK/PRESSURE REGULATING BASKET FILTER.				(SHRUB) LATERAL LINE: 1" PVC SCHEDULE 40 PIPE EXCEPT WHERE NOTED	2,3	IR501			
M	WATER METER-SEE CIVIL UTILITY PLANS	_	_		(TREE) LATERAL LINE: 1" PVC SCHEDULE 40 PIPE EXCEPT WHERE NOTED	2,3	IR501			
$\otimes \! \! \! \! \! \! \! \! \! \! \! \! \! \! \! \! \! \! \!$	FEBCO LF825YA OR EQ. REDUCED PRESSURE PRINCIPAL ASSEMBLY (RPPA): INSTALL IN GUARDSHACK GS-4 ENCLOSURE (VERIFY SIZE TO RPPA ORDERED)	4	IR502		IRRIGATION MAINLINE: 2" PVC SCHEDULE 40 PIPE	2,3	IR501			
С	IRRIGATION CONTROLLER: WEATHERMATIC SMARTLINE #SL4800SLR -1YR-BDL-FLOW (INCLUDES: #SLPED-ENC SS PEDESTAL, #SLW1 WIRELESS WEATHER STATION AND #SL-AIRCARD)	1,2	IR502	SL	SLEEVE (SL): PVC SCHEDULE 40 PIPE: INSTALL (1) 4" SL FOR CONTROL WIRE BUNDLED WITH (1) 4" SL FOR MAINLINE UNDER PAVEMENTS. INSTALL (1) SEPARATE 4" SL FOR LATERAL PIPES—(1) PIPE PER SLEEVE	2	IR501			
M	MASTER VALVE: GRISWOLD DWS-150 BRASS 1.5" STRAIGHT (NORMALLY CLOSED) FLOW RANGE: 0.1 TO 30 GPM	5	IR502	EMITTERS	SEE EMITTER CHART, SCHEDULE, AND DETAILS	4,5,9	IR501			

VALVE CALLOUT —Plant Zone Type —Valve Station # —Valve GPM -Valve Size

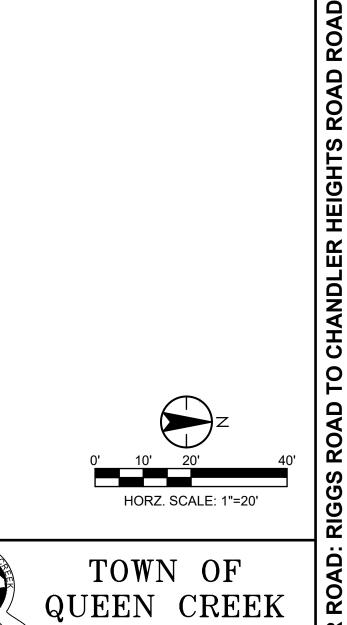

POWER ROAD: RIGGS ROAD TO CHANDLER HEIGHTS ROAD ROADWAY AND DRAINAGE IMPROVEMENTS

Stantec

CIP PROJ NO. A1405

IRRIGATION PLAN 7

IR007

Chandler, Arizona 85226 Tel. 480.687.6100 www.stantec.com

SHEET 105 OF 133

<u>UNIT</u> <u>QTY</u>

LF 980

LF 480

LF 170

DRAINAGE IMPROVEMENTS

EΑ

EΑ

ASSEMBLY SYSTEM PER DETAILS 1,2, SHEET IR502

PER DETAIL 3, SHEET IR501

PER DETAIL 3, SHEET IR501

PER DETAIL 7, SHEET IR501

MULTI OUTLET PER DETAILS

1" PER DETAIL 5, SHEET IR502

1½" PER DETAIL 5, SHEET IR502

DRIP-1" PER DETAIL 1,SHEET IR501

COMPLETE PER DETAIL 3, SHEET

BACKFLOW UNIT, CONCRETE PAD,

TO STATION #1 (±2,450') AND TO #11 (±1,800')

AS FOLLOWS: (1)#10 COMMON, (2) #12 RED,

TOTAL (±12,750')

Call 811 or click Arizona811.com

DESIGNED BY CB

DRAWING NO.

AND ENCLOSURE PER DETAIL 5/IR502 EA


ASSEMBLY PER DETAIL 6, SHT. IR501

4,5,9, SHEET IR501

40-4" PER DETAIL 2,SHEET IR501

SHEET KEYMAP

IR002 | IR003 | IR004 | IR005 | IR006 | IR007 | IR008 | IR009 | IR010 | IR011 | IR012 IR013 IR014

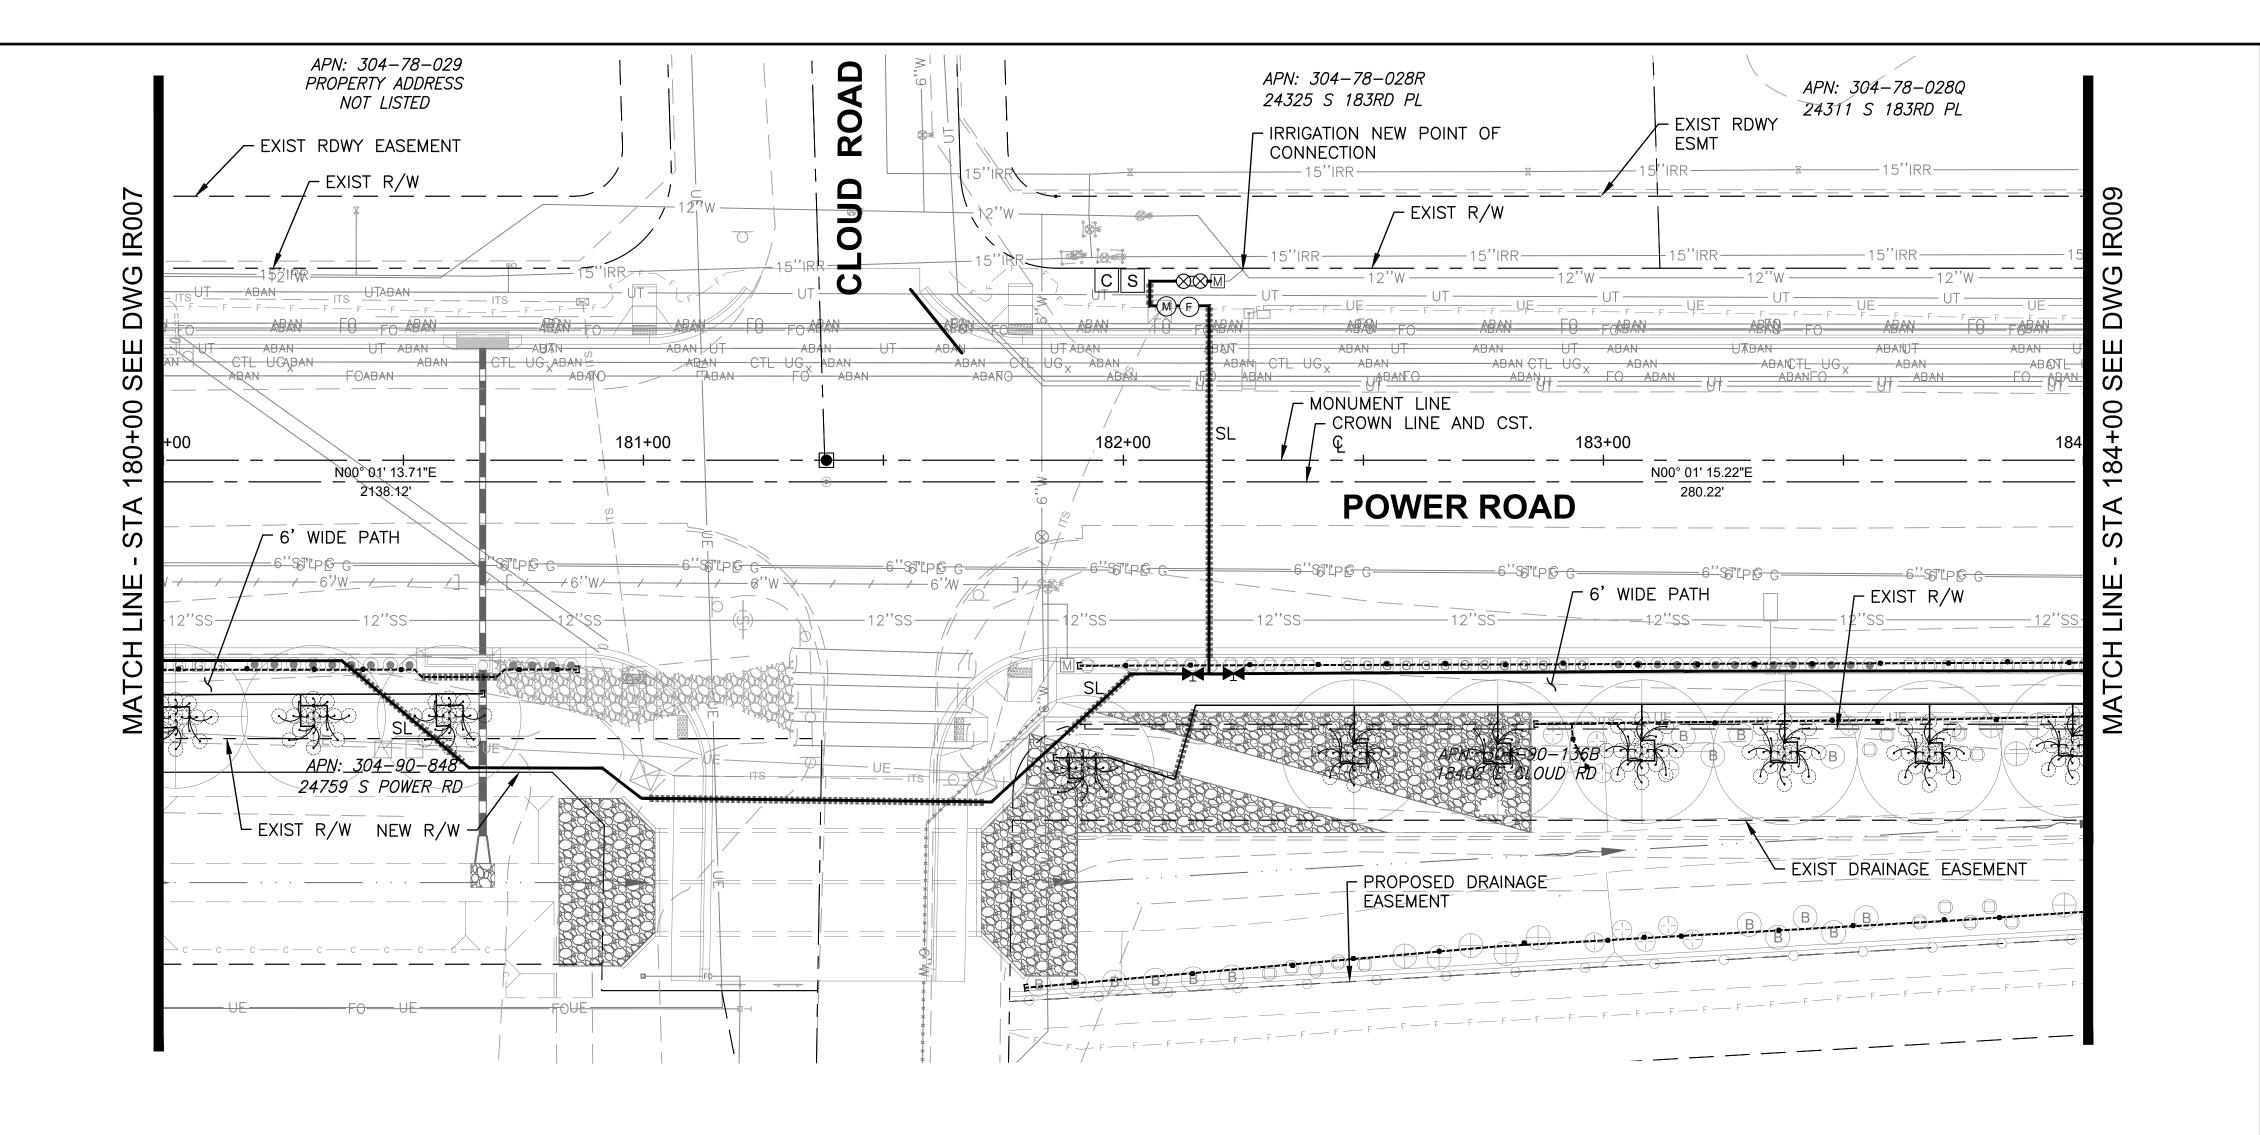

IRRIGATIO	ON SCHEDULE						
SYMBOL	MANUFACTURER/MODEL/DESCRIPTION	DETAIL	SHEET	SYMBOL	MANUFACTURER/MODEL/DESCRIPTION	DETAIL	SHEET
	DRIP VALVE ASSEMBLY: 1" RAINBIRD PEB SERIES VALVE, BRONZE BALL VALVE	1,8	IR501	F	FLOW SENSOR: WEATHERMATIC SLFSI-T10	5	IR502
	AND UNIONS WITH:	.,0		S	SOLAR PANEL ASSEMBLY W/WEATHER STATION AND POLE: WEATHERMATIC SLSOLAR-48	3	IR502
	* FLOWS <u>UNDER</u> 5.0 GPM: INSTALL 3/4" RAINBIRD PRF-075-RBY IN-LINE PRESSURE REGULATING FILTER.			×	MANUAL BRONZE GATE VALVE (NIBCO T-113-K NON-RISING STEM)-LINE SIZE	7	IR501
	* FLOWS <u>OVER</u> 5.0 GPM: INSTALL 1" PRB-QKCHK-100 COMBO			-3	DRIP LATERAL FLUSH CAP ASSEMBLY; INCLUDES VALVE BOX	6	IR501
	QUICKCHECK/PRESSURE REGULATING BASKET FILTER.				(SHRUB) LATERAL LINE: 1" PVC SCHEDULE 40 PIPE EXCEPT WHERE NOTED	2,3	IR501
M	WATER METER-SEE CIVIL UTILITY PLANS	_	_		(TREE) LATERAL LINE: 1" PVC SCHEDULE 40 PIPE EXCEPT WHERE NOTED	2,3	IR501
$\otimes\!$	FEBCO LF825YA OR EQ. REDUCED PRESSURE PRINCIPAL ASSEMBLY (RPPA): INSTALL IN GUARDSHACK GS-4 ENCLOSURE (VERIFY SIZE TO RPPA ORDERED)	4	IR502		IRRIGATION MAINLINE: 2" PVC SCHEDULE 40 PIPE	2,3	IR501
С	IRRIGATION CONTROLLER: WEATHERMATIC SMARTLINE #SL4800SLR -1YR-BDL-FLOW (INCLUDES: #SLPED-ENC SS PEDESTAL, #SLW1 WIRELESS WEATHER STATION AND #SL-AIRCARD)	1,2	IR502	SL	SLEEVE (SL): PVC SCHEDULE 40 PIPE: INSTALL (1) 4" SL FOR CONTROL WIRE BUNDLED WITH (1) 4" SL FOR MAINLINE UNDER PAVEMENTS. INSTALL (1) SEPARATE 4" SL FOR LATERAL PIPES—(1) PIPE PER SLEEVE	2	IR501
M	MASTER VALVE: GRISWOLD DWS-150 BRASS 1.5" STRAIGHT (NORMALLY CLOSED) FLOW RANGE: 0.1 TO 30 GPM	5	IR502	EMITTERS	SEE EMITTER CHART, SCHEDULE, AND DETAILS	4,5,9	IR501

<u>\</u>	VALVE_	CALLOU	IT	
-  -	TREE 1 1"	1 •	—Plant —Valve —Valve —Valve	

	BAIRD SINGLE STATE OF THE STATE	Stantec Cr	33 West Frye Ro andler, Arizono . 480.687.610 vw.stantec.con	n 85226 10	A1405,
	L26634 CART K.	POWER ROAD: RIGGS ROAD TO CHANDLER HE ROADWAY AND DRAINAGE IMP			
working da	Arizona 811 at least two full tys before you begin excavate to the property of	TOWN OUEEN (	OF CREE	EK	POWER ROAD: RIGGS
		0' 10' 2 HORZ. SC	0' ALE: 1"=20	40' '	RIGGS ROAD TO CHANDLER
					SHANDLER
					HEIGHTS R
					ROAD ROADWAY & DRAINAGE
	TOTAL (±12,7				& DRAINAG
13.	TO STATION	BACKFLOW UNIT, CONCRETE PAD, AND ENCLOSURE PER DETAIL 5/IR502 RE WIRES FROM CONTROLLER #1 (±2,450') AND TO #11 (±1,800') S: (1)#10 COMMON, (2) #12 RED,	EA	1	SE IMPROV
12.		COMPLETE PER DETAIL 3, SHEET IR502 INSTALL REDUCED PRESSURE	EA	1	IMPROVEMENTS
10. 11.	440.76100 440.91000	INSTALL REMOTE CONTROL VALVE, DRIP-1" PER DETAIL 1,SHEET IR501 INSTALL SOLAR POWER ASSEMBLY	EA	0	SEAL
9.	440.74200	INSTALL MASTER VALVE ASSEMBLY 1½" PER DETAIL 5, SHEET IR502	EA	1	ED SUBMITI
8.	440.73100	INSTALL FLOW SENSOR ASSEMBLY 1" PER DETAIL 5, SHEET IR502	EA	1	
7.	440.72320	4,5,9, SHEET IR501  INSTALL DRIP LATERAL FLUSH CAP ASSEMBLY PER DETAIL 6, SHT. IR501	EA EA	82 6	AL 10/03/202
6.	440.72200	PER DETAIL 7, SHEET IR501  INSTALL DRIP EMITTER ASSEMBLY- MULTI OUTLET PER DETAILS	EA	2	2025
<b>4</b> . <b>5</b> .		40-4" PER DETAIL 2,SHEET IR501  INSTALL GATE VALVE ASSEMBLY-2"	LF	745	
<ol> <li>3.</li> <li>4.</li> </ol>		INSTALL PIPE-SCHEDULE 40-2" PER DETAIL 3, SHEET IR501 INSTALL SLEEVE-PIPE-SCHEDULE	LF	520	
2.		INSTALL PIPE-SCHEDULE 40-1" PER DETAIL 3, SHEET IR501	LF	1,240	
1.	440.41000	ASSEMBLY SYSTEM PER DETAILS 1,2, SHEET IR502	EA	1	

IRRIGATION CONSTRUCTION NOTES (TYP)

440.41000 INSTALL IRRIGATION CONTROLLER

<u>UNIT</u> <u>QTY</u>


ITEM BID ITEM DESCRIPTION

۱F	RRIGATION	PLAN	8	

SHEET 106 OF 133 DESIGNED BY CB CIP PROJ NO. A1405 DRAWN BY CB IR008 DRAWING NO.

SHEET KEYMAP

IR002 | IR003 | IR004 | IR005 | IR006 | IR007 | IR008 | IR009 | IR010 | IR011 | IR012 | IR013 | IR014

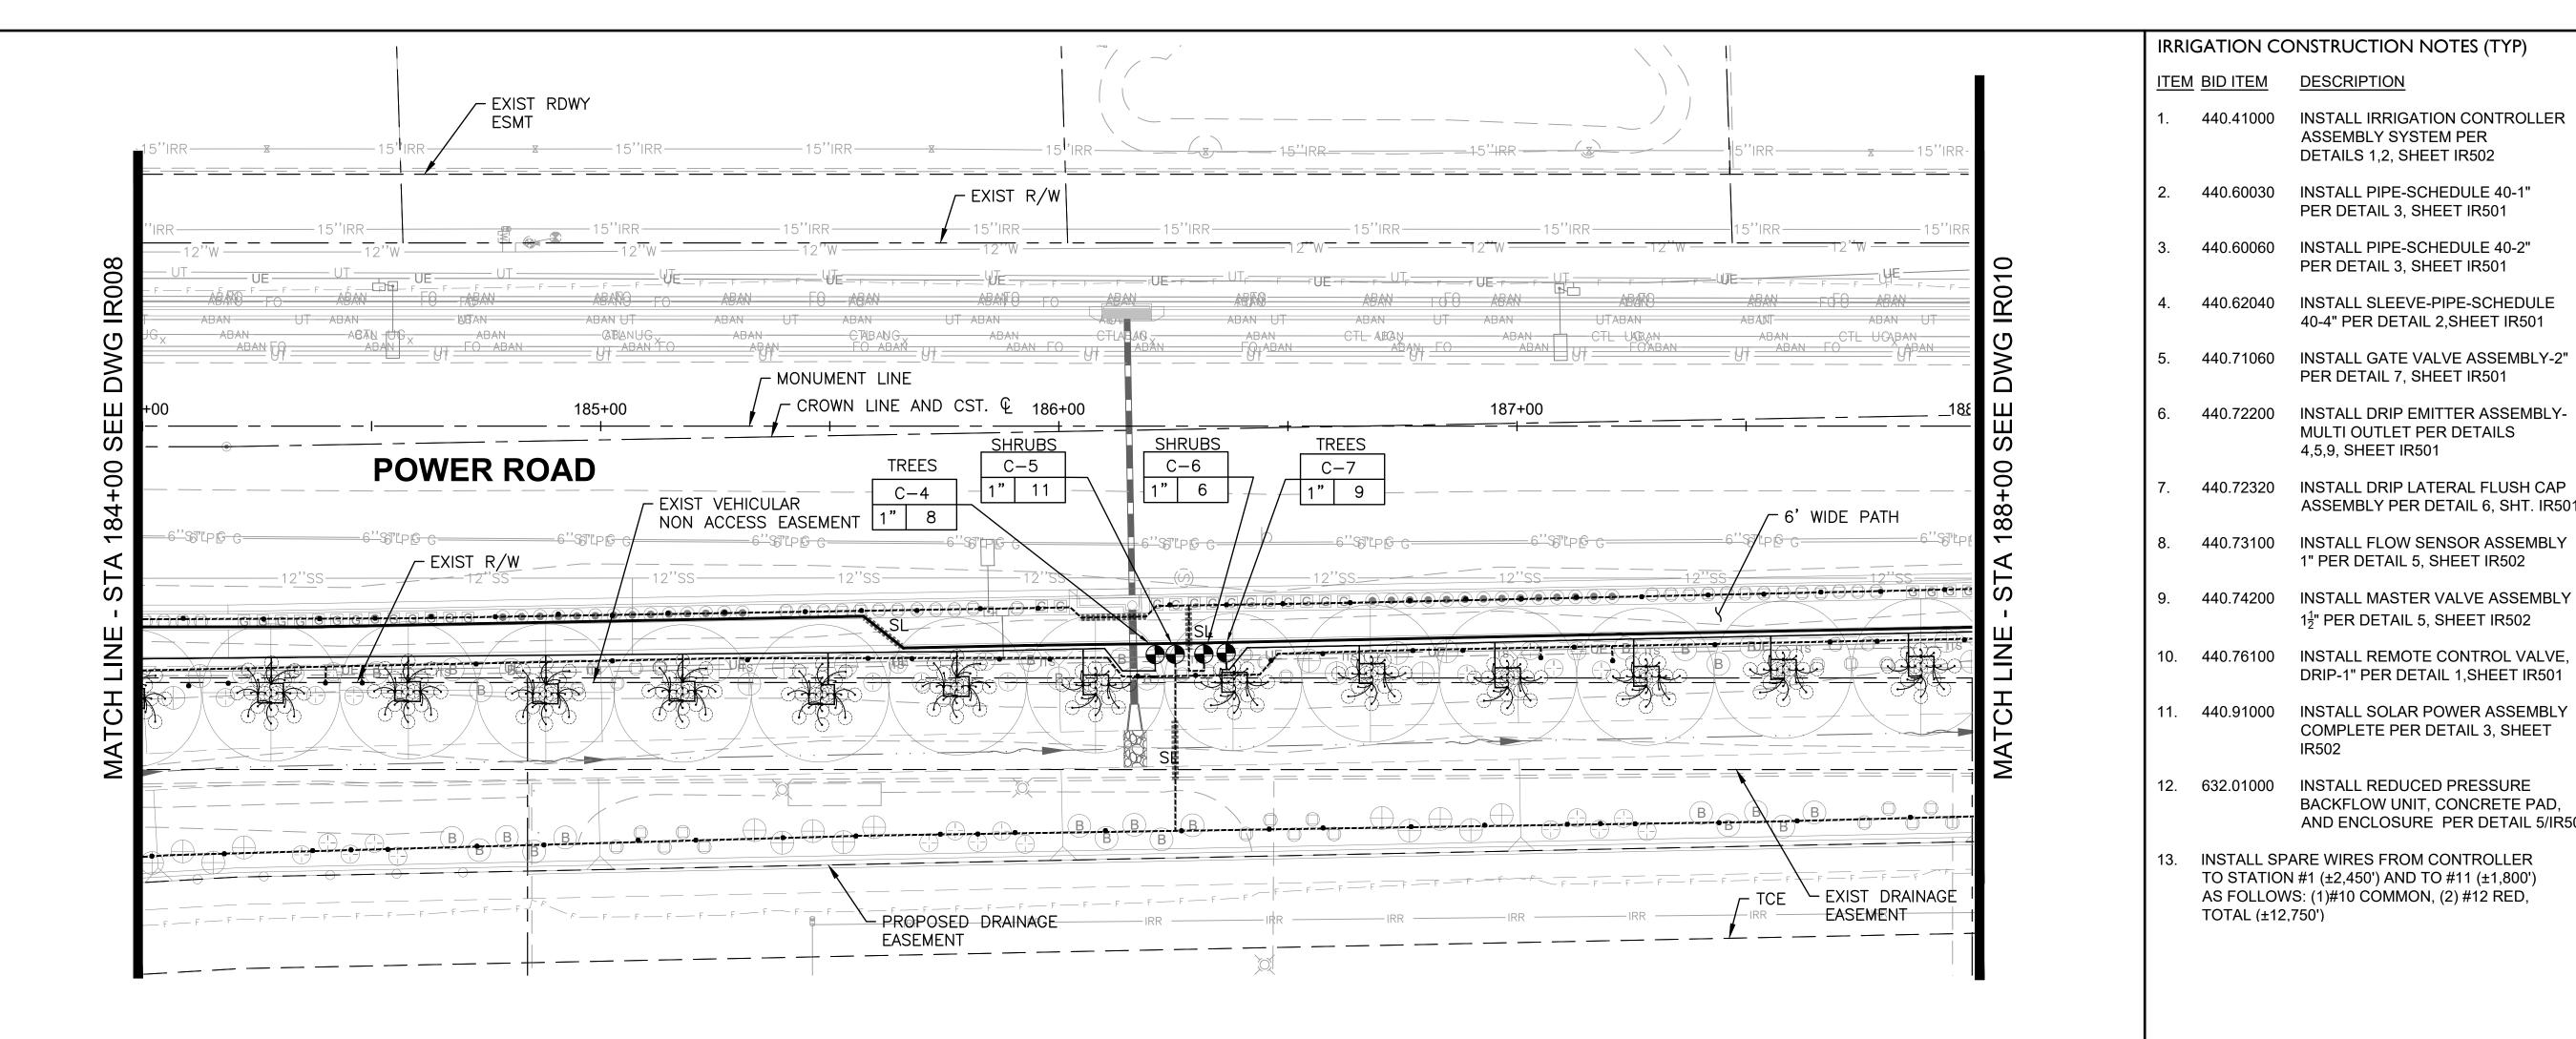

IRRIGATIO	ON SCHEDULE						
SYMBOL	MANUFACTURER/MODEL/DESCRIPTION	DETAIL	SHEET	SYMBOL	MANUFACTURER/MODEL/DESCRIPTION	DETAIL	SHEET
	DRIP VALVE ASSEMBLY: 1" RAINBIRD PEB SERIES VALVE, BRONZE BALL VALVE	1,8	IR501	F	FLOW SENSOR: WEATHERMATIC SLFSI-T10	5	IR502
	AND UNIONS WITH:  * FLOWS <u>UNDER</u> 5.0 GPM: INSTALL 3/4" RAINBIRD PRF-075-RBY IN-LINE PRESSURE REGULATING FILTER.			S	SOLAR PANEL ASSEMBLY W/WEATHER STATION AND POLE: WEATHERMATIC SLSOLAR-48	3	IR502
				×	MANUAL BRONZE GATE VALVE (NIBCO T-113-K NON-RISING STEM)-LINE SIZE	7	IR501
	* FLOWS <u>OVER</u> 5.0 GPM: INSTALL 1" PRB-QKCHK-100 COMBO				DRIP LATERAL FLUSH CAP ASSEMBLY; INCLUDES VALVE BOX	6	IR501
	QUICKCHECK/PRESSURE REGULATING BASKET FILTER.				(SHRUB) LATERAL LINE: 1" PVC SCHEDULE 40 PIPE EXCEPT WHERE NOTED	2,3	IR501
M	WATER METER-SEE CIVIL UTILITY PLANS	_	_		(TREE) LATERAL LINE: 1" PVC SCHEDULE 40 PIPE EXCEPT WHERE NOTED	2,3	IR501
$\otimes\!$	FEBCO LF825YA OR EQ. REDUCED PRESSURE PRINCIPAL ASSEMBLY (RPPA): INSTALL IN GUARDSHACK GS-4 ENCLOSURE (VERIFY SIZE TO RPPA ORDERED)	4	IR502		IRRIGATION MAINLINE: 2" PVC SCHEDULE 40 PIPE	2,3	IR501
С	IRRIGATION CONTROLLER: WEATHERMATIC SMARTLINE #SL4800SLR -1YR-BDL-FLOW (INCLUDES: #SLPED-ENC SS PEDESTAL, #SLW1 WIRELESS WEATHER STATION AND #SL-AIRCARD)	1,2	IR502	SL	SLEEVE (SL): PVC SCHEDULE 40 PIPE: INSTALL (1) 4" SL FOR CONTROL WIRE BUNDLED WITH (1) 4" SL FOR MAINLINE UNDER PAVEMENTS. INSTALL (1) SEPARATE 4" SL FOR LATERAL PIPES—(1) PIPE PER SLEEVE	2	IR501
M	MASTER VALVE: GRISWOLD DWS-150 BRASS 1.5" STRAIGHT (NORMALLY CLOSED) FLOW RANGE: 0.1 TO 30 GPM	5	IR502	EMITTERS	SEE EMITTER CHART, SCHEDULE, AND DETAILS	4,5,9	IR501

•	VALVE CALLOUT		
_	TREES • 1 • 1 • 1 • 1	-Plant -Valve -Valve -Valve	•

0' 10' 20' 40' HORZ. SCALE: 1"=20'	ER ROAD: RIGGS ROAD TO CHANDLER HEIGHTS ROAD F
TOWN OF QUEEN CREEK	ROAD:
POWER ROAD: RIGGS ROAD TO CHANDLER HEIGHTS ROAD	POW
Stantec  3133 West Frye Road Chandler, Arizona 85226 Tel. 480.687.6100	۸1405, ا

SHEET 107 OF 133

IRRIGATION PLAN 9

IR009

CIP PROJ NO. A1405

UNIT QTY

LF 1,240

LF 745

EΑ

EΑ

ASSEMBLY SYSTEM PER DETAILS 1,2, SHEET IR502

PER DETAIL 3, SHEET IR501

PER DETAIL 3, SHEET IR501

PER DETAIL 7, SHEET IR501

MULTI OUTLET PER DETAILS

1" PER DETAIL 5, SHEET IR502

 $1\frac{1}{2}$ " PER DETAIL 5, SHEET IR502

DRIP-1" PER DETAIL 1,SHEET IR501

COMPLETE PER DETAIL 3, SHEET

BACKFLOW UNIT, CONCRETE PAD,

TO STATION #1 (±2,450') AND TO #11 (±1,800')

AS FOLLOWS: (1)#10 COMMON, (2) #12 RED,

TOTAL (±12,750')

Call 811 or click Arizona811.com

DESIGNED BY CB

DRAWING NO.

AND ENCLOSURE PER DETAIL 5/IR502 EA


ASSEMBLY PER DETAIL 6, SHT. IR501

4,5,9, SHEET IR501

40-4" PER DETAIL 2,SHEET IR501

SHEET KEYMAP

IR003 | IR004 | IR005 | IR006 | IR007 | IR008 | IR009

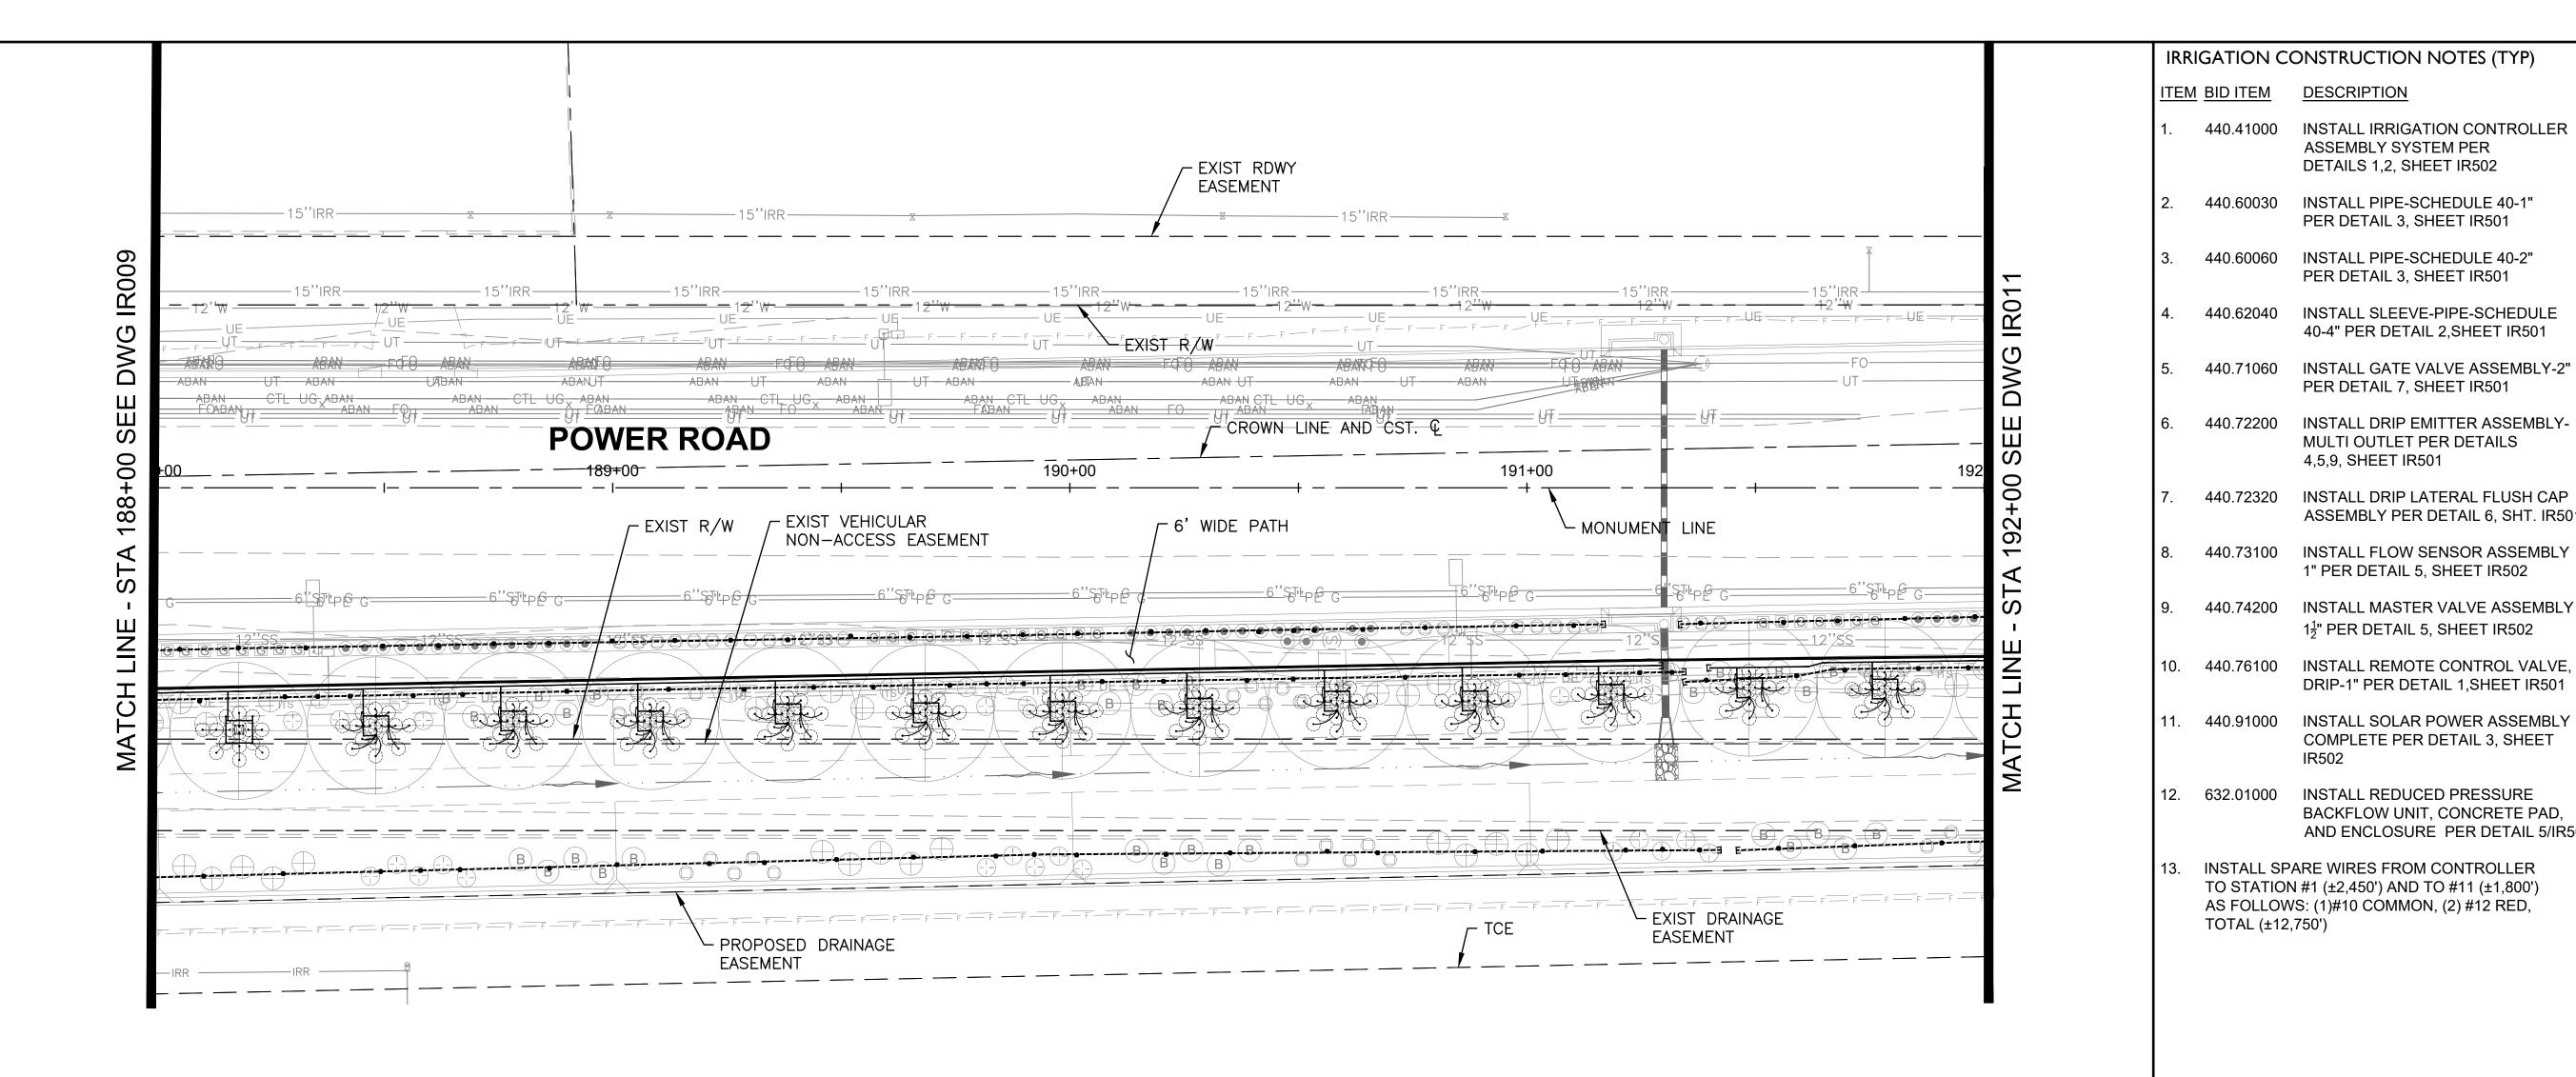

IRRIGATIO	ON SCHEDULE					_	
SYMBOL	MANUFACTURER/MODEL/DESCRIPTION	DETAIL	SHEET	SYMBOL	MANUFACTURER/MODEL/DESCRIPTION	DETAIL	SHEET
	DRIP VALVE ASSEMBLY: 1" RAINBIRD PEB SERIES VALVE, BRONZE BALL VALVE		IR501	F	FLOW SENSOR: WEATHERMATIC SLFSI-T10	5	IR502
	AND UNIONS WITH:	1,8		S	SOLAR PANEL ASSEMBLY W/WEATHER STATION AND POLE: WEATHERMATIC SLSOLAR-48	3	IR502
	* FLOWS <u>UNDER</u> 5.0 GPM: INSTALL 3/4" RAINBIRD PRF-075-RBY IN-LINE PRESSURE REGULATING FILTER.			<b>—</b>	MANUAL BRONZE GATE VALVE (NIBCO T-113-K NON-RISING STEM)-LINE SIZE	7	IR501
	* FLOWS <u>OVER</u> 5.0 GPM: INSTALL 1" PRB-QKCHK-100 COMBO			-3	DRIP LATERAL FLUSH CAP ASSEMBLY; INCLUDES VALVE BOX	6	IR501
	QUICKCHECK/PRESSURE REGULATING BASKET FILTER.				(SHRUB) LATERAL LINE: 1" PVC SCHEDULE 40 PIPE EXCEPT WHERE NOTED	2,3	IR501
M	WATER METER-SEE CIVIL UTILITY PLANS	_	_		(TREE) LATERAL LINE: 1" PVC SCHEDULE 40 PIPE EXCEPT WHERE NOTED	2,3	IR501
$\otimes$	FEBCO LF825YA OR EQ. REDUCED PRESSURE PRINCIPAL ASSEMBLY (RPPA): INSTALL IN GUARDSHACK GS-4 ENCLOSURE (VERIFY SIZE TO RPPA ORDERED)	4	IR502		IRRIGATION MAINLINE: 2" PVC SCHEDULE 40 PIPE	2,3	IR501
С	IRRIGATION CONTROLLER: WEATHERMATIC SMARTLINE #SL4800SLR -1YR-BDL-FLOW (INCLUDES: #SLPED-ENC SS PEDESTAL, #SLW1 WIRELESS WEATHER STATION AND #SL-AIRCARD)	1,2	IR502	SL	SLEEVE (SL): PVC SCHEDULE 40 PIPE: INSTALL (1) 4" SL FOR CONTROL WIRE BUNDLED WITH (1) 4" SL FOR MAINLINE UNDER PAVEMENTS. INSTALL (1) SEPARATE 4" SL FOR LATERAL PIPES—(1) PIPE PER SLEEVE	2	IR501
M	MASTER VALVE: GRISWOLD DWS-150 BRASS 1.5" STRAIGHT (NORMALLY CLOSED) FLOW RANGE: 0.1 TO 30 GPM	5	IR502	EMITTERS	SEE EMITTER CHART, SCHEDULE, AND DETAILS	4,5,9	IR501

<u>VALVE</u>	CALLOUT	
TRE 1 1 "•	1 •	

HORZ. SCALE: 1"=20'

<u>QTY</u>

<u>UNIT</u>

EΑ

LF

LF

EA

DRAINAGE IMPROVEMENTS

LF 1,960

ASSEMBLY SYSTEM PER DETAILS 1,2, SHEET IR502

PER DETAIL 3, SHEET IR501

PER DETAIL 3, SHEET IR501

PER DETAIL 7, SHEET IR501

MULTI OUTLET PER DETAILS

1" PER DETAIL 5, SHEET IR502

 $1\frac{1}{2}$ " PER DETAIL 5, SHEET IR502

DRIP-1" PER DETAIL 1,SHEET IR501

COMPLETE PER DETAIL 3, SHEET

BACKFLOW UNIT, CONCRETE PAD,

TO STATION #1 (±2,450') AND TO #11 (±1,800') AS FOLLOWS: (1)#10 COMMON, (2) #12 RED,

TOTAL (±12,750')

AND ENCLOSURE PER DETAIL 5/IR502 EA

ASSEMBLY PER DETAIL 6, SHT. IR501

40-4" PER DETAIL 2,SHEET IR501

440.60030 INSTALL PIPE-SCHEDULE 40-1"

440.60060 INSTALL PIPE-SCHEDULE 40-2"

440.71060 INSTALL GATE VALVE ASSEMBLY-2"

440.72200 INSTALL DRIP EMITTER ASSEMBLY-

440.72320 INSTALL DRIP LATERAL FLUSH CAP

440.73100 INSTALL FLOW SENSOR ASSEMBLY

4,5,9, SHEET IR501

TOWN OF QUEEN CREEK

POWER ROAD: RIGGS ROAD TO CHANDLER HEIGHTS ROAD ROADWAY AND DRAINAGE IMPROVEMENTS

**Stantec** 


Chandler, Arizona 85226 Tel. 480.687.6100 www.stantec.com

IRRIGATION PLAN 10

DESIGNED BY CB CIP PROJ NO. A1405 SHEET 108 OF 133 IR010 DRAWING NO.

SHEET KEYMAP

IR002 | IR003 | IR004 | IR005 | IR006 | IR007 | IR008 | IR009 | IR010 | IR011 | IR012 | IR013 | IR014/

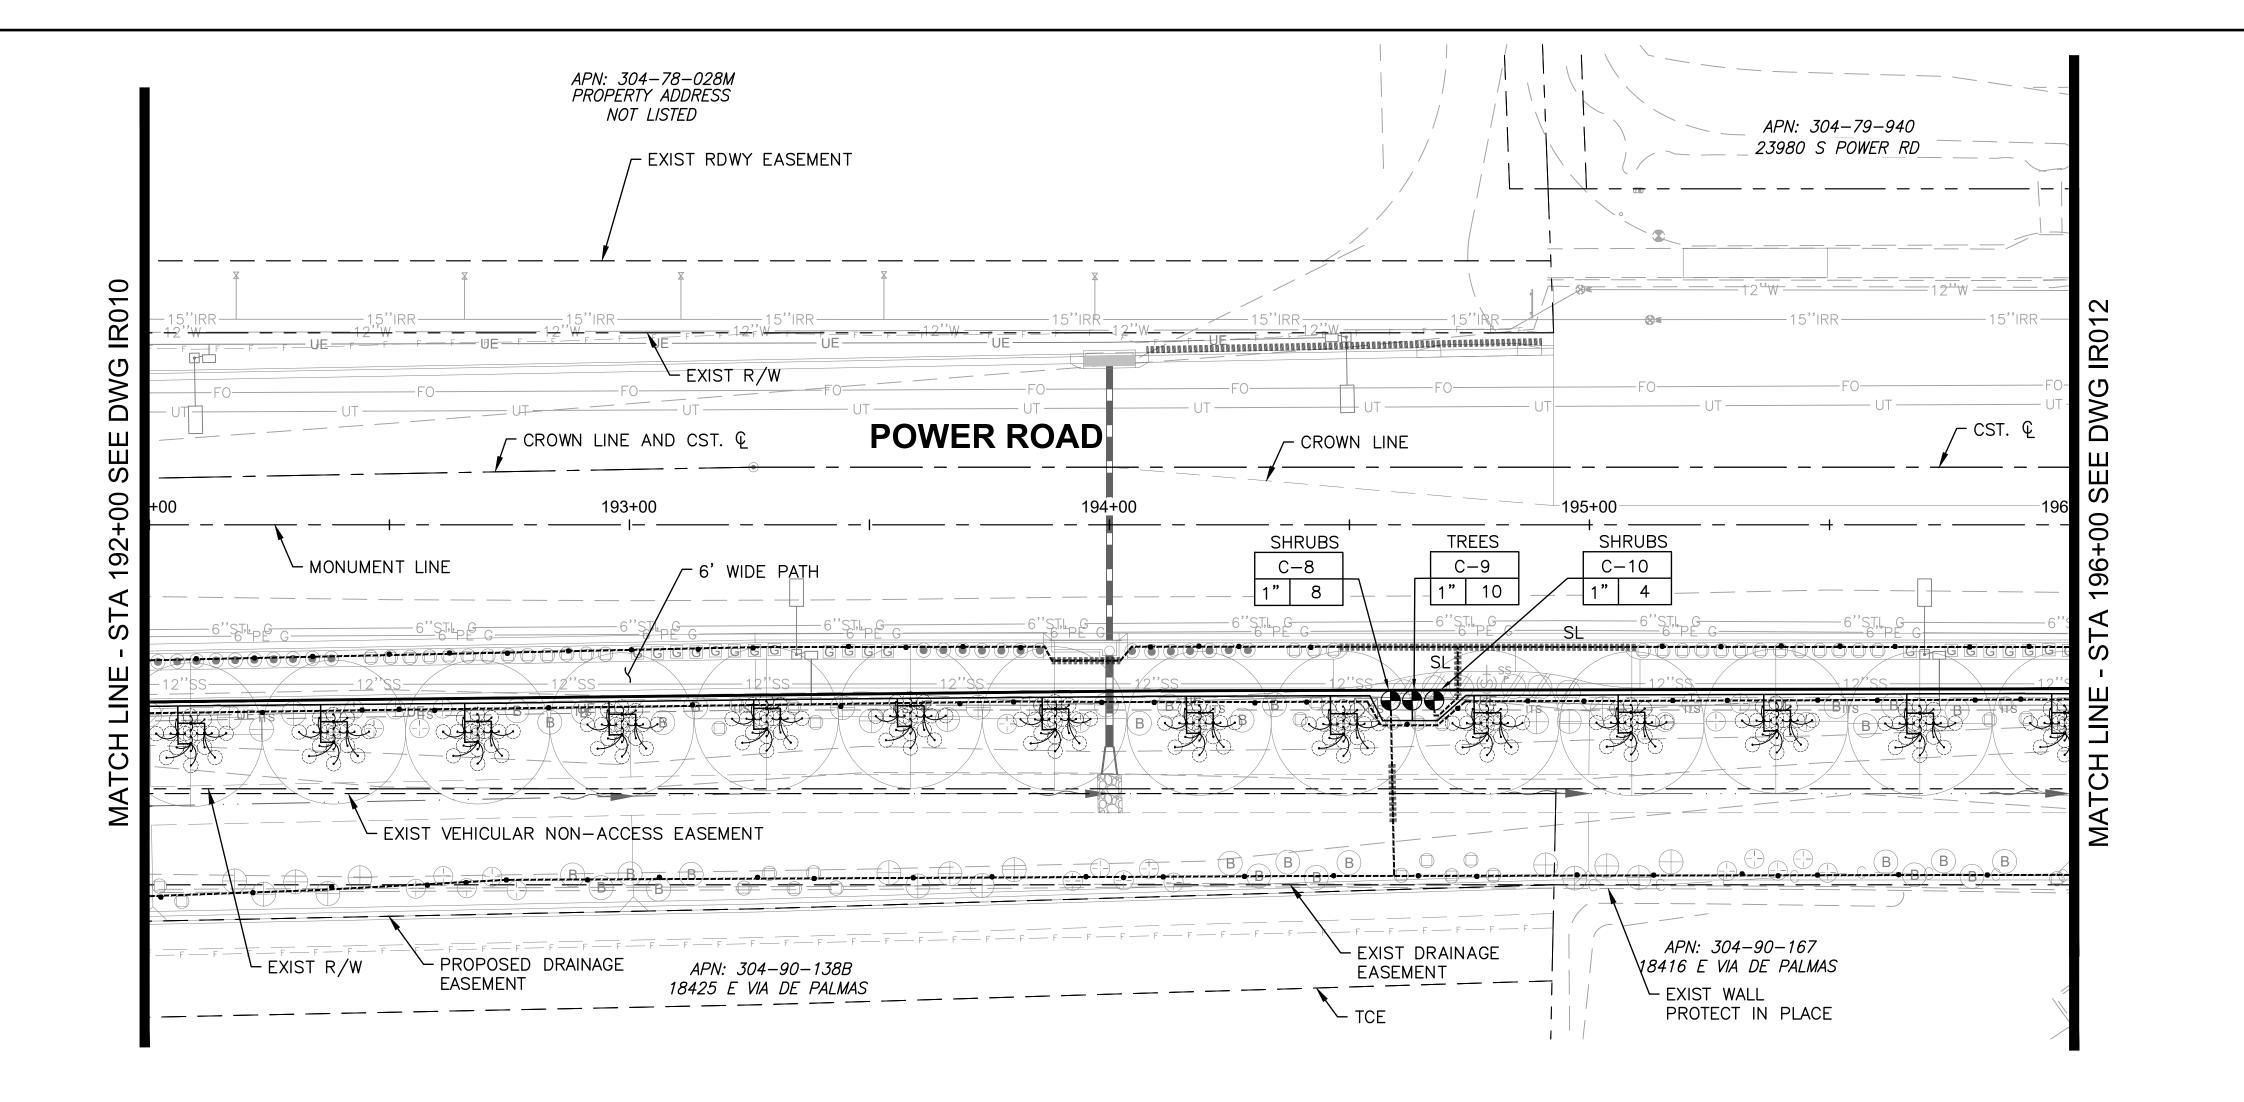

IRRIGATIO	N SCHEDULE						
SYMBOL	MANUFACTURER/MODEL/DESCRIPTION	DETAIL	SHEET	SYMBOL	MANUFACTURER/MODEL/DESCRIPTION	DETAIL	SHEET
	DRIP VALVE ASSEMBLY: 1" RAINBIRD PEB SERIES VALVE, BRONZE BALL VALVE	1,8	IR501	F	FLOW SENSOR: WEATHERMATIC SLFSI-T10	5	IR502
	AND UNIONS WITH:  * FLOWS <u>UNDER</u> 5.0 GPM: INSTALL 3/4" RAINBIRD PRF-075-RBY IN-LINE PRESSURE REGULATING FILTER.			S	SOLAR PANEL ASSEMBLY W/WEATHER STATION AND POLE: WEATHERMATIC SLSOLAR-48	3	IR502
				×	MANUAL BRONZE GATE VALVE (NIBCO T-113-K NON-RISING STEM)-LINE SIZE	7	IR501
	* FLOWS <u>OVER</u> 5.0 GPM: INSTALL 1" PRB-QKCHK-100 COMBO				DRIP LATERAL FLUSH CAP ASSEMBLY; INCLUDES VALVE BOX	6	IR501
	QUICKCHECK/PRESSURE REGULATING BASKET FILTER.				(SHRUB) LATERAL LINE: 1" PVC SCHEDULE 40 PIPE EXCEPT WHERE NOTED	2,3	IR501
M	WATER METER-SEE CIVIL UTILITY PLANS	_	_		(TREE) LATERAL LINE: 1" PVC SCHEDULE 40 PIPE EXCEPT WHERE NOTED	2,3	IR501
$\otimes\!\!\!\otimes\!\!\!\otimes$	FEBCO LF825YA OR EQ. REDUCED PRESSURE PRINCIPAL ASSEMBLY (RPPA): INSTALL IN GUARDSHACK GS-4 ENCLOSURE (VERIFY SIZE TO RPPA ORDERED)	4	IR502		IRRIGATION MAINLINE: 2" PVC SCHEDULE 40 PIPE	2,3	IR501
С	IRRIGATION CONTROLLER: WEATHERMATIC SMARTLINE #SL4800SLR -1YR-BDL-FLOW (INCLUDES: #SLPED-ENC SS PEDESTAL, #SLW1 WIRELESS WEATHER STATION AND #SL-AIRCARD)	1,2	IR502	SL	SLEEVE (SL): PVC SCHEDULE 40 PIPE: INSTALL (1) 4" SL FOR CONTROL WIRE BUNDLED WITH (1) 4" SL FOR MAINLINE UNDER PAVEMENTS. INSTALL (1) SEPARATE 4" SL FOR LATERAL PIPES—(1) PIPE PER SLEEVE	2	IR501
M	MASTER VALVE: GRISWOLD DWS-150 BRASS 1.5" STRAIGHT (NORMALLY CLOSED) FLOW RANGE: 0.1 TO 30 GPM	5	IR502	EMITTERS	SEE EMITTER CHART, SCHEDULE, AND DETAILS	4,5,9	IR501

VALVE CALLOUT		
TREES ● 1 * 1 * 1 * 1 * 1 * 1 * 1 * 1 * 1 * 1	-Plant -Valve -Valve -Valve	

	Signed 10.53	Stantec Chan	West Frye Roc dler, Arizona 480.687.6100 stantec.com	85226 )	). A1405,
	L26634 CARY K.	POWER ROAD: RIGGS ROAD TO CHANDLER HEIG ROADWAY AND DRAINAGE IMPRO			
working d	t Arizona 811 at least two flays before you begin excav	TOWN OUEEN C		K	R ROAD:
		0' 10' 20' HORZ. SCAL	<b>)</b> ∠ .E: 1"=20'	40'	POWER ROAD: RIGGS ROAD TO CHANDLER HEI
	TOTAL (±12,				GHTS ROAD ROADWAY & DRAINAGE IMPROVEMENTS
13.	TO STATION	BACKFLOW UNIT, CONCRETE PAD, AND ENCLOSURE PER DETAIL 5/IR502  ARE WIRES FROM CONTROLLER 1 #1 (±2,450') AND TO #11 (±1,800') S: (1)#10 COMMON, (2) #12 RED,	EA	0	E IMPROVI
<ul><li>11.</li><li>12.</li></ul>	440.91000 632.01000	INSTALL SOLAR POWER ASSEMBLY COMPLETE PER DETAIL 3, SHEET IR502 INSTALL REDUCED PRESSURE	EA	0	
10.	440.76100	INSTALL REMOTE CONTROL VALVE, DRIP-1" PER DETAIL 1,SHEET IR501	EA	3	SEALED
9.	440.74200	INSTALL MASTER VALVE ASSEMBLY 1½" PER DETAIL 5, SHEET IR502	EA	0	D SUBMIT
8.	440.73100	INSTALL FLOW SENSOR ASSEMBLY 1" PER DETAIL 5, SHEET IR502	EA	0	
7.	440.72320	4,5,9, SHEET IR501  INSTALL DRIP LATERAL FLUSH CAP ASSEMBLY PER DETAIL 6, SHT. IR501	EA EA	130	TAL 10/03/2025
6.	440.72200	PER DETAIL 7, SHEET IR501  INSTALL DRIP EMITTER ASSEMBLY- MULTI OUTLET PER DETAILS	EA	0	2025
5.	440.71060	40-4" PER DETAIL 2,SHEET IR501 INSTALL GATE VALVE ASSEMBLY-2"	LF	210	
<ol> <li>4.</li> </ol>	440.60060 440.62040	INSTALL PIPE-SCHEDULE 40-2" PER DETAIL 3, SHEET IR501 INSTALL SLEEVE-PIPE-SCHEDULE	LF	410	
2.	440.60030	INSTALL PIPE-SCHEDULE 40-1" PER DETAIL 3, SHEET IR501	LF	2,060	
1.	440.41000	INSTALL IRRIGATION CONTROLLER ASSEMBLY SYSTEM PER DETAILS 1,2, SHEET IR502	EA	0	

IRRIGATION PLAN 11

IR011

CIP PROJ NO. A1405

DESIGNED BY CB

DRAWING NO.

SHEET 109 OF 133


IRRIGATION CONSTRUCTION NOTES (TYP)

ITEM BID ITEM DESCRIPTION


<u>UNIT</u>

SHEET KEYMAP

1 2 3 4 5 6 7 8 9 10 11 12 13 14 IR001 IR002 IR003 IR004 IR005 IR006 IR007 IR008 IR009 IR010 IR011 IR012 IR013 IR014

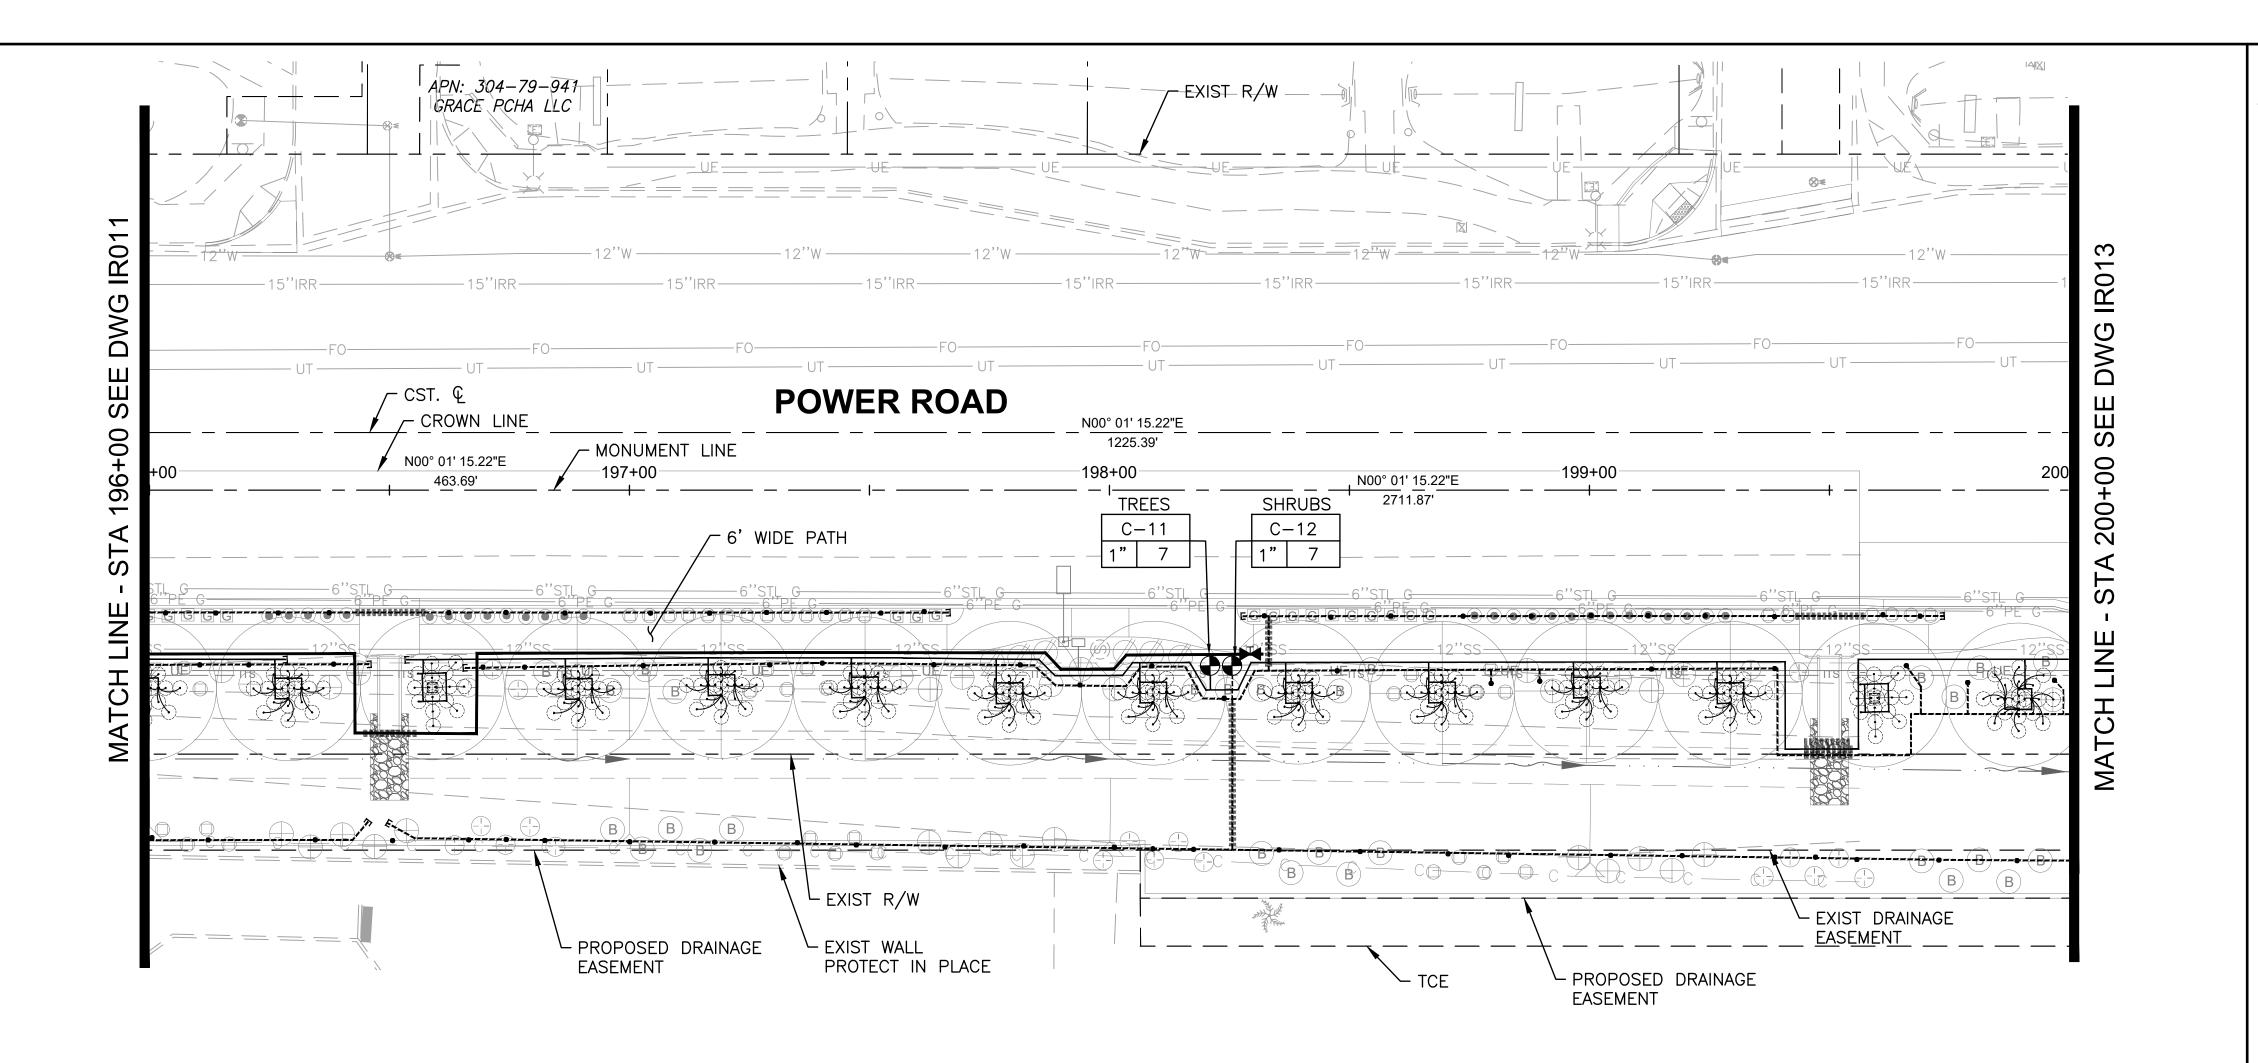


IRRIGATIO	N SCHEDULE					_	
SYMBOL	MANUFACTURER/MODEL/DESCRIPTION	DETAIL	SHEET	SYMBOL	MANUFACTURER/MODEL/DESCRIPTION	DETAIL	SHEET
	DRIP VALVE ASSEMBLY: 1" RAINBIRD PEB SERIES VALVE, BRONZE BALL VALVE		IR501	F	FLOW SENSOR: WEATHERMATIC SLFSI-T10	5	IR502
	AND UNIONS WITH:	1,8		S	SOLAR PANEL ASSEMBLY W/WEATHER STATION AND POLE: WEATHERMATIC SLSOLAR-48	3	IR502
	* FLOWS <u>UNDER</u> 5.0 GPM: INSTALL 3/4" RAINBIRD PRF-075-RBY IN-LINE PRESSURE REGULATING FILTER.			×	MANUAL BRONZE GATE VALVE (NIBCO T-113-K NON-RISING STEM)-LINE SIZE	7	IR501
	* FLOWS <u>OVER</u> 5.0 GPM: INSTALL 1" PRB-QKCHK-100 COMBO				DRIP LATERAL FLUSH CAP ASSEMBLY; INCLUDES VALVE BOX	6	IR501
	QUICKCHECK/PRESSURE REGULATING BASKET FILTER.				(SHRUB) LATERAL LINE: 1" PVC SCHEDULE 40 PIPE EXCEPT WHERE NOTED	2,3	IR501
M	WATER METER-SEE CIVIL UTILITY PLANS	_	_		(TREE) LATERAL LINE: 1" PVC SCHEDULE 40 PIPE EXCEPT WHERE NOTED	2,3	IR501
$\otimes\!\!\!\otimes\!\!\!\otimes$	FEBCO LF825YA OR EQ. REDUCED PRESSURE PRINCIPAL ASSEMBLY (RPPA): INSTALL IN GUARDSHACK GS-4 ENCLOSURE (VERIFY SIZE TO RPPA ORDERED)	4	IR502		IRRIGATION MAINLINE: 2" PVC SCHEDULE 40 PIPE	2,3	IR501
С	IRRIGATION CONTROLLER: WEATHERMATIC SMARTLINE #SL4800SLR -1YR-BDL-FLOW (INCLUDES: #SLPED-ENC SS PEDESTAL, #SLW1 WIRELESS WEATHER STATION AND #SL-AIRCARD)	1,2	IR502	SL	SLEEVE (SL): PVC SCHEDULE 40 PIPE: INSTALL (1) 4" SL FOR CONTROL WIRE BUNDLED WITH (1) 4" SL FOR MAINLINE UNDER PAVEMENTS. INSTALL (1) SEPARATE 4" SL FOR LATERAL PIPES—(1) PIPE PER SLEEVE	2	IR501
M	MASTER VALVE: GRISWOLD DWS-150 BRASS 1.5" STRAIGHT (NORMALLY CLOSED) FLOW RANGE: 0.1 TO 30 GPM	5	IR502	EMITTERS	SEE EMITTER CHART, SCHEDULE, AND DETAILS	4,5,9	IR501

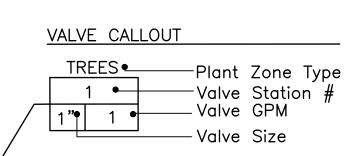

SHEET KEYMAP

	1 1 1 1 2 1 2 1 1 1 1 1 1 1 1 1 1 1 1 1 1 1 1 1 1 1 1	
IR001 IR002 IR003 IR004 IR00	IR006 IR007 IR008 IR009 I	R010   IR011   IR012   IR013   IR014

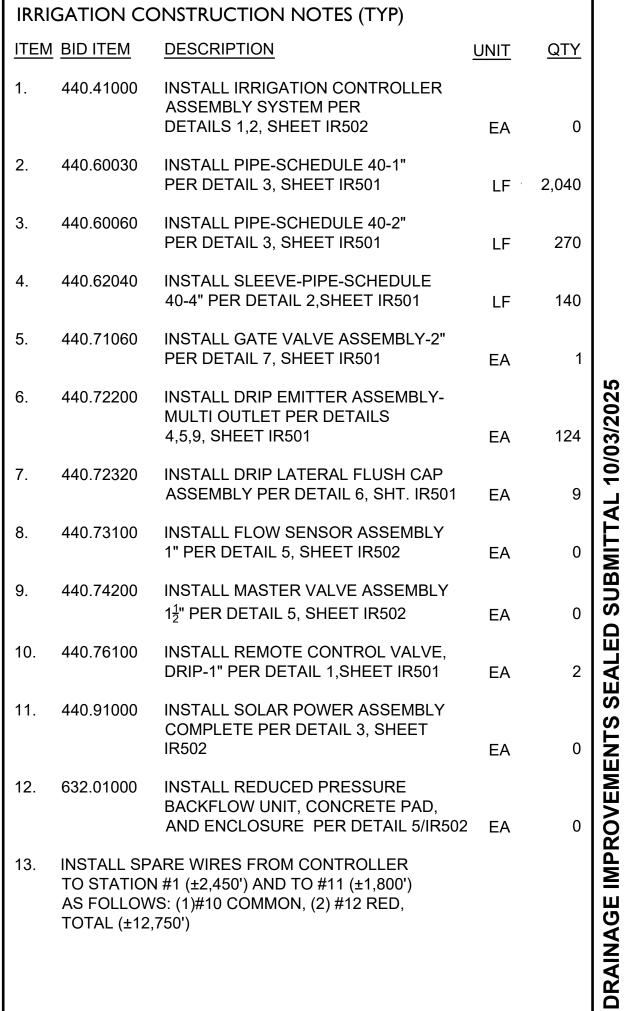

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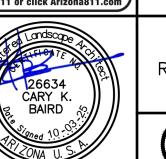
HORZ. SCALE: 1"=20'

Chandler, Arizona 85226 Tel. 480.687.6100 www.stantec.com





TOWN OF QUEEN CREEK



POWER ROAD: RIGGS ROAD TO CHANDLER HEIGHTS ROAD ROADWAY AND DRAINAGE IMPROVEMENTS

Stantec

DESIGNED BY CB
DRAWN BY CB
DRAWING NO. IRO12

IRRIGATION PLAN 12

CIP PROJ NO. A1405

SHEET 110 OF 133

IRRIGATIO	ON SCHEDULE						
SYMBOL	MANUFACTURER/MODEL/DESCRIPTION	DETAIL	SHEET	SYMBOL	MANUFACTURER/MODEL/DESCRIPTION	DETAIL	SHEET
	DRIP VALVE ASSEMBLY: 1" RAINBIRD PEB SERIES VALVE, BRONZE BALL VALVE	1,8	IR501	F	FLOW SENSOR: WEATHERMATIC SLFSI-T10	5	IR502
	AND UNIONS WITH:	,,,,		S	SOLAR PANEL ASSEMBLY W/WEATHER STATION AND POLE: WEATHERMATIC SLSOLAR-48	3	IR502
	* FLOWS <u>UNDER</u> 5.0 GPM: INSTALL 3/4" RAINBIRD PRF-075-RBY IN-LINE PRESSURE REGULATING FILTER.			×	MANUAL BRONZE GATE VALVE (NIBCO T-113-K NON-RISING STEM)-LINE SIZE	7	IR501
	* FLOWS <u>OVER</u> 5.0 GPM: INSTALL 1" PRB-QKCHK-100 COMBO				DRIP LATERAL FLUSH CAP ASSEMBLY; INCLUDES VALVE BOX	6	IR501
	QUICKCHECK/PRESSURE REGULATING BASKET FILTER.				(SHRUB) LATERAL LINE: 1" PVC SCHEDULE 40 PIPE EXCEPT WHERE NOTED	2,3	IR501
M	WATER METER-SEE CIVIL UTILITY PLANS	_	_		(TREE) LATERAL LINE: 1" PVC SCHEDULE 40 PIPE EXCEPT WHERE NOTED	2,3	IR501
$\otimes\!$	FEBCO LF825YA OR EQ. REDUCED PRESSURE PRINCIPAL ASSEMBLY (RPPA): INSTALL IN GUARDSHACK GS-4 ENCLOSURE (VERIFY SIZE TO RPPA ORDERED)	4	IR502		IRRIGATION MAINLINE: 2" PVC SCHEDULE 40 PIPE	2,3	IR501
С	IRRIGATION CONTROLLER: WEATHERMATIC SMARTLINE #SL4800SLR -1YR-BDL-FLOW (INCLUDES: #SLPED-ENC SS PEDESTAL, #SLW1 WIRELESS WEATHER STATION AND #SL-AIRCARD)	1,2	IR502	SL	SLEEVE (SL): PVC SCHEDULE 40 PIPE: INSTALL (1) 4" SL FOR CONTROL WIRE BUNDLED WITH (1) 4" SL FOR MAINLINE UNDER PAVEMENTS. INSTALL (1) SEPARATE 4" SL FOR LATERAL PIPES—(1) PIPE PER SLEEVE	2	IR501
M	MASTER VALVE: GRISWOLD DWS-150 BRASS 1.5" STRAIGHT (NORMALLY CLOSED) FLOW RANGE: 0.1 TO 30 GPM	5	IR502	EMITTERS	SEE EMITTER CHART, SCHEDULE, AND DETAILS	4,5,9	IR501

VALVE CALLOUT

TREES

Plant Zone Type


Valve Station #


Valve GPM

Valve Size

SHEET KEYMAP

1 2	3	4	5	6	7	8	9	10	111	12	13	_14	
IR001 IR002	IR003	IR004	IR005	IR006	IR007	IR008	IR009	IR010	IR011	IR012	IR013	IR014	

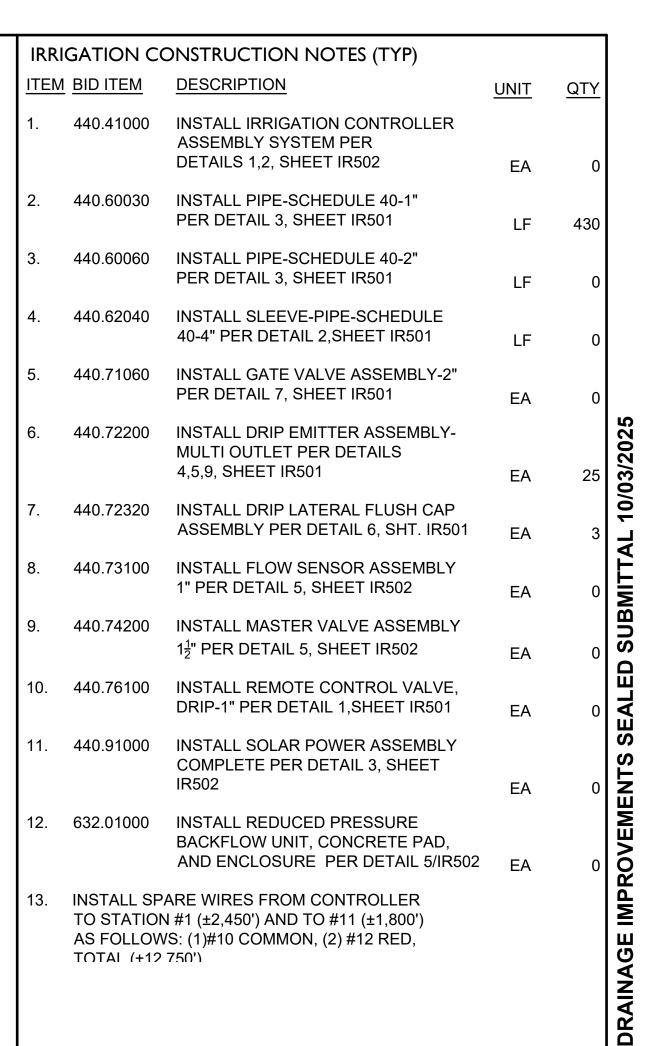

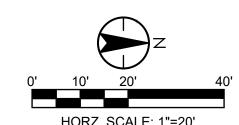






TOWN OF QUEEN CREEK

Chandler, Arizona 85226 Tel. 480.687.6100

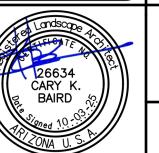


POWER ROAD:
RIGGS ROAD TO CHANDLER HEIGHTS ROAD
ROADWAY AND DRAINAGE IMPROVEMENTS

**Stantec** 

IRRIGATION PLAN 13

DESIGNED BY CB
DRAWN BY CB
CIP PROJ NO. A1405

DRAWING NO. IR013 SHEET 111 OF 133

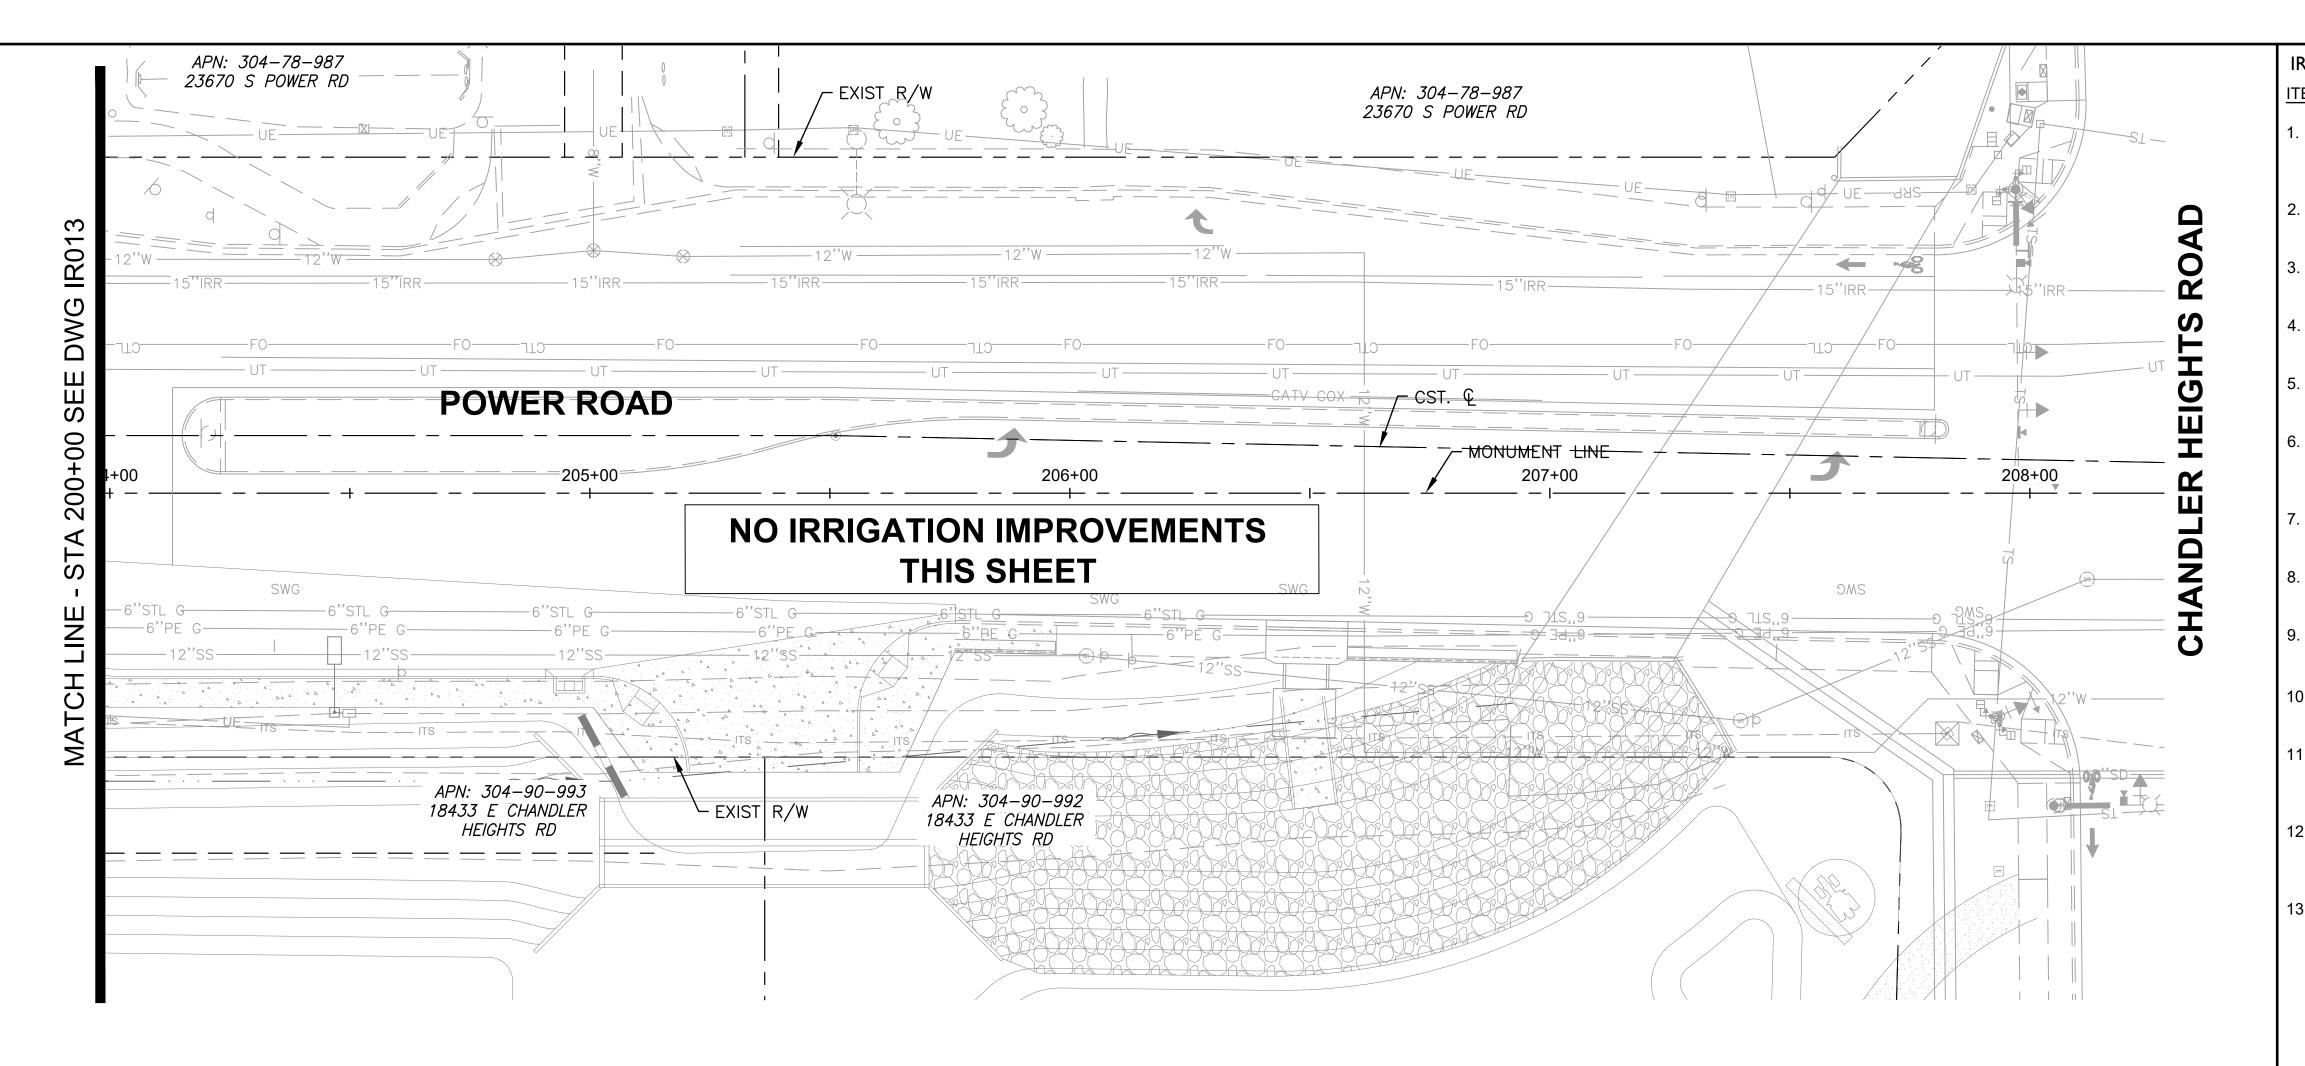



IRRIGATIO	ON SCHEDULE						
SYMBOL	MANUFACTURER/MODEL/DESCRIPTION	DETAIL	SHEET	SYMBOL	MANUFACTURER/MODEL/DESCRIPTION	DETAIL	SHEET
	DRIP VALVE ASSEMBLY: 1" RAINBIRD PEB SERIES VALVE, BRONZE BALL VALVE		1,8 IR501		FLOW SENSOR: WEATHERMATIC SLFSI-T10	5	IR502
	AND UNIONS WITH:	,,,		S	SOLAR PANEL ASSEMBLY W/WEATHER STATION AND POLE: WEATHERMATIC SLSOLAR-48	3	IR502
	* FLOWS <u>UNDER</u> 5.0 GPM: INSTALL 3/4" RAINBIRD PRF-075-RBY IN-LINE PRESSURE REGULATING FILTER.			×	MANUAL BRONZE GATE VALVE (NIBCO T-113-K NON-RISING STEM)-LINE SIZE	7	IR501
	* FLOWS <u>OVER</u> 5.0 GPM: INSTALL 1" PRB-QKCHK-100 COMBO			-]	DRIP LATERAL FLUSH CAP ASSEMBLY; INCLUDES VALVE BOX	6	IR501
	QUICKCHECK/PRESSURE REGULATING BASKET FILTER.				(SHRUB) LATERAL LINE: 1" PVC SCHEDULE 40 PIPE EXCEPT WHERE NOTED	2,3	IR501
M	WATER METER-SEE CIVIL UTILITY PLANS	_	_		(TREE) LATERAL LINE: 1" PVC SCHEDULE 40 PIPE EXCEPT WHERE NOTED	2,3	IR501
$\otimes \! \! \! \! \! \! \! \! \! \! \! \! \! \! \! \! \! \! \!$	FEBCO LF825YA OR EQ. REDUCED PRESSURE PRINCIPAL ASSEMBLY (RPPA): INSTALL IN GUARDSHACK GS-4 ENCLOSURE (VERIFY SIZE TO RPPA ORDERED)	4	IR502		IRRIGATION MAINLINE: 2" PVC SCHEDULE 40 PIPE	2,3	IR501
С	IRRIGATION CONTROLLER: WEATHERMATIC SMARTLINE #SL4800SLR -1YR-BDL-FLOW (INCLUDES: #SLPED-ENC SS PEDESTAL, #SLW1 WIRELESS WEATHER STATION AND #SL-AIRCARD)	1,2	IR502	SL	SLEEVE (SL): PVC SCHEDULE 40 PIPE: INSTALL (1) 4" SL FOR CONTROL WIRE BUNDLED WITH (1) 4" SL FOR MAINLINE UNDER PAVEMENTS. INSTALL (1) SEPARATE 4" SL FOR LATERAL PIPES—(1) PIPE PER SLEEVE	2	IR501
M	MASTER VALVE: GRISWOLD DWS-150 BRASS 1.5" STRAIGHT (NORMALLY CLOSED) FLOW RANGE: 0.1 TO 30 GPM	5	IR502	EMITTERS	SEE EMITTER CHART, SCHEDULE, AND DETAILS	4,5,9	IR501

VALVE CALLOUT			
TREES • 1 • 1 • 1 • 1	-Plant -Valve -Valve -Valve	Static GPM	

SHEET KEYMAP

1 2	3	4	5	6	7	8	9	a A		12	13	_14	
IR001 IR002	IR003	IR004,	IR005	IR006	IR007	IRÒ08	IR009	IR010	IR011	IR012	IR013	IR014	

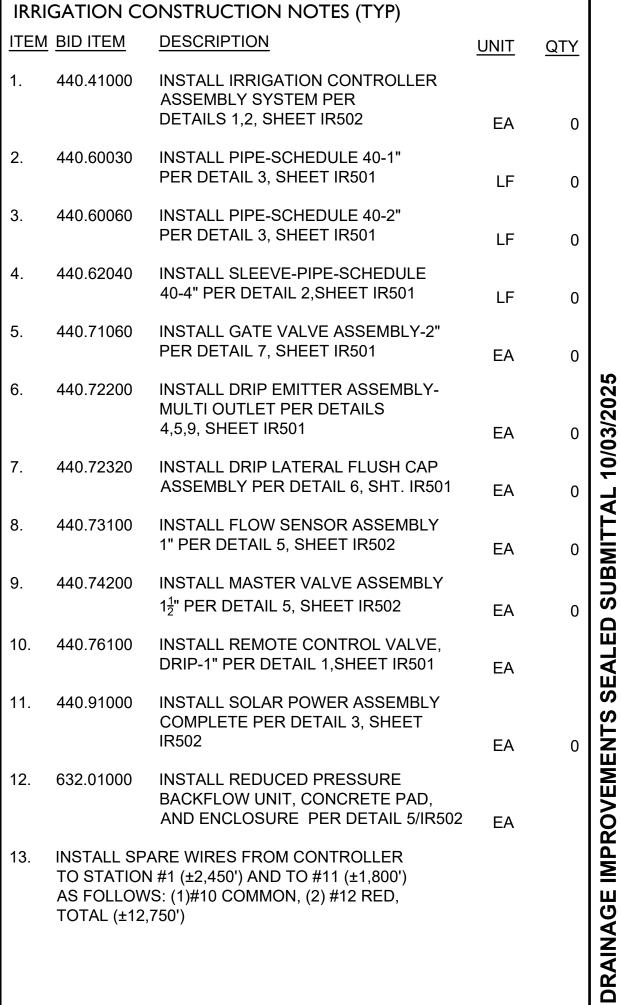


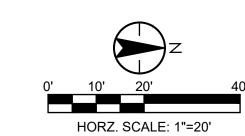





TOWN OF QUEEN CREEK

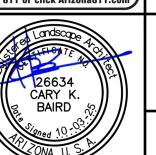

POWER ROAD: RIGGS ROAD TO CHANDLER HEIGHTS ROAD ROADWAY AND DRAINAGE IMPROVEMENTS

Stantec

IRRIGATION PLAN 14

DESIGNED BY CB CIP PROJ NO. A1405 IR014 DRAWING NO.

1. LENGTH OF DISTRIBUTION TUBING SHALL NOT EXCEED 10-FEET. REFER TO LOCAL JURISDICTIONAL REQUIREMENTS. MAXIMUM ALLOWBLE LENGTH

2. LAYOUT DISTRIBUTION TUBING AS SHOWN AND LOCATE DISCHARGE POINT

3. \*\*\* IN LOCATIONS WHERE TREE AND SHRUBS OVERLAP, DELETE

CENTER OF SHRUB

OR GROUNDCOVER

BID ITEM NOTE: ITEM 440.72200 MULTI-PORT EMITTER WORK INCLUDES

DISTRIBUTION TUBING TO TREE AT OR NEAR SHRUB LOCATION.

### LEGEND:

- 1. PVC SCHEDULE 80 ELL. (SXT) 2. PVC SCHEDULE 80 NIPPLE (TYPICAL, LENGTH AS REQUIRED (SXT)
- 3. LINE SIZE BRONZE BALL VALVE 4. 30" LINEAR LENGTH OF WIRE, COILED
- 5. WATERPROOF CONNECTION—(2 REQ'D. SPEARS/GPH DS—400) 6. CONCRETE VALVE BOX WITH LOCKING STEEL COVER (OLD CASTLE/CHRISTY B1324 (OR EQUAL) - GRIND OR WELD "RCV" AND
- STATION NO. ON LID 7. ID TAG
- 8. TOP OF ROCK MULCH
- 9. SUBGRADE 10. REMOTE CONTROL VALVE - SEE PLAN SCHEDULE
- 11. PVC LATERAL REFER TO PLAN FOR SIZE 12. PVC SCHEDULE 80 MALE ADAPTER
- 13. PVC SCHEDULE 80 NIPPLE LENGTH AS REQUIRED
- 14. THREADED PVC UNION FOR SERVICING ASSEMBLY (1 OF 2) 15. PVC MAINLINE - SEE PLAN LEGEND
- 16. 3" MINIMUM DEPTH OF  $\frac{3}{4}$ " WASHED GRAVEL
- 17. BRICK (1 OF 4)

SET /4"

1.  $\frac{1}{4}$ -IN DISTRIBUTION TUBING TO PLANT (10-FT

2. ROUND ACCESS BOX WITH LID-COLOR: TAN

3. 6-OUTLET MULTI-PORT THREADED EMITTER

4. ROUTE DISTRIBUTION TUBING THROUGH SLOT

HOLE IN BOX. PROVIDE LOOP INSIDE BOX


MULTI-PORT EMITTER - SECTION

TREE DRIP EMITTERS - LAYOUT

RAINBIRD SEB 7XB OR EQUAL

MAX LENGTH)

- 18. PVC SCHEDULE 80 NIPPLE (2" LENGTH, HIDDEN) AND PVC
- SCHEDULE 80 ELL 19. PVC SCHEDULE 80 TEE OR ELL
- 20. PRESSURE REGULATOR FILTER SEE PLAN SCHEDULE

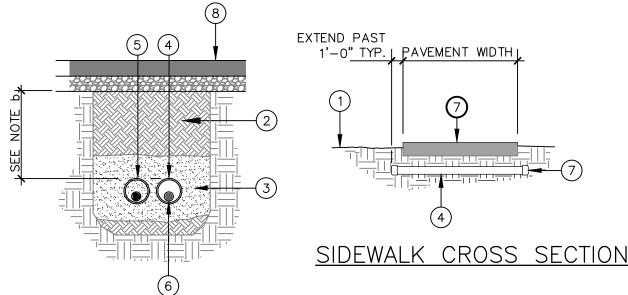

### SLEEVE CROSS SECTION

### **LEGEND:**

### 1. FINISHED GRADE.


- 2. CLEAN BACKFILL, NO PARTICLE OVER ½" DIAMETER, 95% COMPACTED.
- FREE SOIL AROUND ALL PIPE. PIPE SLEEVE: SEE IRRIGATION PLAN LEGEND

3. BED AND SHADE WITH 2" OF SAND OR ROCK

- <u>WIRES SLEEVE</u>: SEE IRRIGATION PLAN LEGEND IRRIGATION LINE.
- PVC STANDARD CAP FOR NON USED SLEEVES
- 8. CONCRETE OR ASPHALT PAVING-SEE CIVIL

SLEEVE INSTALLATION

- A. SLEEVE ALL PIPE AND WIRES UNDER WALKS, STRUCTURES, WALLS, ETC.
- B. SLEEVE DEPTHS: 1. ROADWAYS: 30" MIN.
- 2. RESIDENTIAL DRIVEWAYS: 24" MIN.
- 3. SIDEWALKS: 18" MIN.

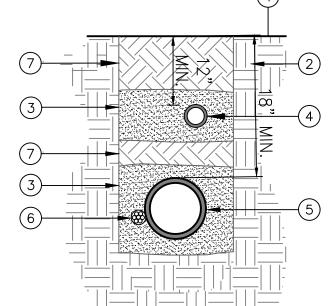

### UNDER WALKS, DRIVEWAYS,

STRUCTURES, WALLS, ETC. B. SLEEVE SIZE TO BE TWICE THE

A. SLEEVE ALL PIPE AND WIRES

**LEGEND:** 

NOTES:

FINISH GRADE

UNDISTURBED SUBGRADE

AROUND ALL PIPE.

20' INTERVALS.

OVER 3" DIAMETER.

BED AND SHADE WITH A MINIMUM 2" OF SAND ABOVE, BELOW AND

4. LATERAL LINE (12-IN MIN. DEPTH).

PROVIDE THRUST BLOCKS AT ALL

CHANGES IN DIRECTION ON ALL

MAINLINE, TAPE AND BUNDLE AT


5. MAINLINE (18-IN MIN. DEPTH)

MAINLINES 3" AND LARGER.

6. UF DIRECT BURIAL SOLID COPPER CONTROL WIRE, ROUTE WITH

7. COMPACTED FILL, NO PARTICLES


- DIAMETER OF THE PIPE IF NOT SPECIFIED ON PLANS.
- C. SEE SPECIFICATION SECTION 213 FOR PIPE DEPTHS UNDER PART 3 "TRENCHING" SUBSECTION

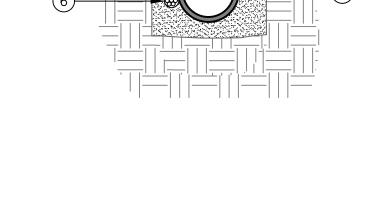


### 3 TRENCH SECTION DETAIL

SCALE: N.T.S


# IR501

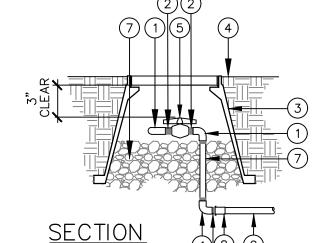

- 1. SLIP x THREADED PVC SCH 40 90 ELL.
- <sup>1</sup>/<sub>2</sub>" THREADED PVC SCH 40 NIPPLE 10" ROUND TAN VALVE BOX, BRAND "FV" INTO VALVE BOX W/ LOCKING LID. SEE SPECS. FOR FONT AND HEIGHT. TAN COLOR
- 4. FINISH GRADE. 5. ½" PVC SCH. 40 BALL VALVE (SLIP X SLIP)
- TO REST ON GRAVEL SUMP
- 6. SCHEDULE 40 PVC NIPPLE  $-\frac{1}{2}$ " x 6".
- 7. 3" CRUSHED GRAVEL SUMP (1 CU. FT,). 8. THREADED X SLIP 1/2"X1" PVC SCH 40 REDUCER.
- 9. 1" PVC SCH 40 PIPE
- 10. 36" x ½" I.D. IPS FLEX PVC HOSE-SLIP FIT INTO  $\frac{1}{2}$ " PVC ELL.

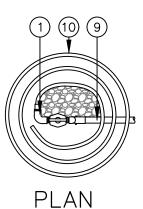

- PROVIDE A MINIMUM OF 3" CLEAR FROM BOTTOM OF VALVE BOX LID TO TOP OF BALL VALVE.
- B. FLUSH ALL LATERALS DURING CONSTRUCTION AND PROJECT COMPLETION

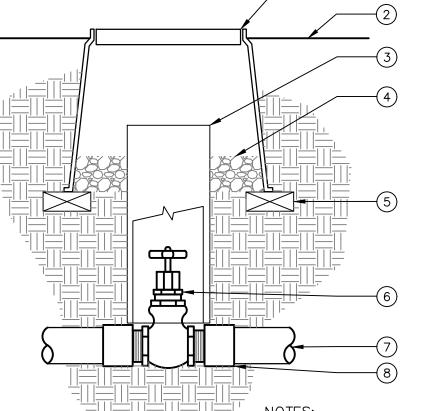


1. INSTALL GATE VALVES A MIN. OF 24" FROM STRUCTURES OR

HARDSCAPING.

- 1. 10-INCH DIA. PLASTIC VALVE BOX WITH LOCKING LID. PROVIDE EXTENSIONS AS NEEDED. REFER TO SPECS. HEAT BRAND "GV" ON LID. COLOR OF BOX: TAN 2. FINISH GRADE-TOP OF
- LANDSCAPE ROCK 1" BELOW TOP OF BOX 3. 6-INCH PVC CL 200 PIPE
- (LENGTH AS REQUIRED) 4. 3-INCH MINIMUM DEPTH OF
- 3/4-INCH WASHED GRAVEL 5. BRICK (1 OF 2) 6. THREADED BRONZE GATE VALVE
- WITH RESILIENT WEDGE, NON-RISING STEM, SQUARE OPERATING NUT 7. MAINLINE
- 8. PVC SCH. 40 MALE ADAPTOR (1 OF 2)
  - 2. REFER TO SPECS. AND PLAN SHEETS FOR MORE INFORMATION.
- 3. NOMINAL SIZE OF GATE VALVE TO MATH NOMINAL MAINLINE SIZE.

### SCALE: N.T.S



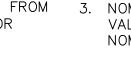

### DRIP LATERAL FLUSH CAP ASSEMBLY SCALE: N.T.S



### TREE AND SHRUB DRIP EMITTER - SECTION SCALE: N.T.S

5. FINISHED GRADE

6. TOP OF EARTH SUBGRADE

8. PVC SCH. 40 TEE OR ELL

10. GRAVEL SUMP: ⅓ CUFT 3/4-IN DIA.

7. PVC SCH. 40 ADAPTOR

9. PVC LATERAL PIPE

WASHED GRAVEL

### STEP 1: STRIP WIRES 1/2" FROM ENDS.

SHRUB DRIP EMITTERS - LAYOUT

STEP 2: APPLY SCOTCHLOK Y SPRING CONNECTOR IN A CLOCKWISE DIRECTION.

1 DRIP VALVE ASSEMBLY


2-INCHES ABOVE FINISHED GRADE.

SCALE: N.T.S

ROOTBALL


SCALE: N.T.S

MAY BE LESS.

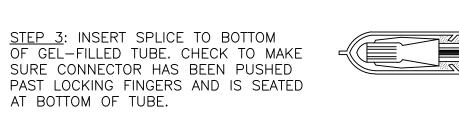

3M DIRECT BURY SPLICE KIT DBR/Y-60R, RAINBIRD WC20 CONNECTOR, OR APPROVED EQUAL,

STEP 4: POSITION WIRES IN WIRE CHANNELS AND CLOSE INSULATOR TUBE COVER.

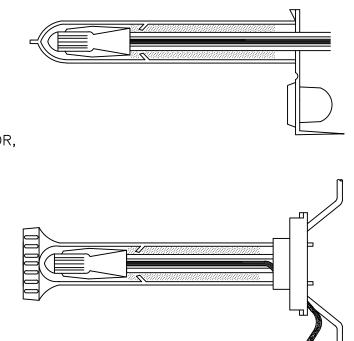

PIPE LATERAL AND FITTINGS

OBSTRIBUTION TUBE

PER IRRIGATION SCHEDULE

MULTI-OUTLET EMITTER IN

ACCESS BOX TYP. 2-3

OUTLETS PER SHRUB OR

SCHEDULE


MULTI-PORT EMITTER, DISTRIBUTION TUBING, EMITTER ACCESS BOX,

FITTINGS, CONNECTION TO LATERAL PIPE, EXCAVATION AND

BACKFILL-COMPLETE. (EXCLUDES LATERAL PIPE)

GROUNDCOVER-SEE EMITTER




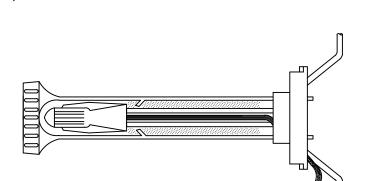

### 8 WIRE WATERPROOF CONNECTORS

SCALE: N.T.S

IR501

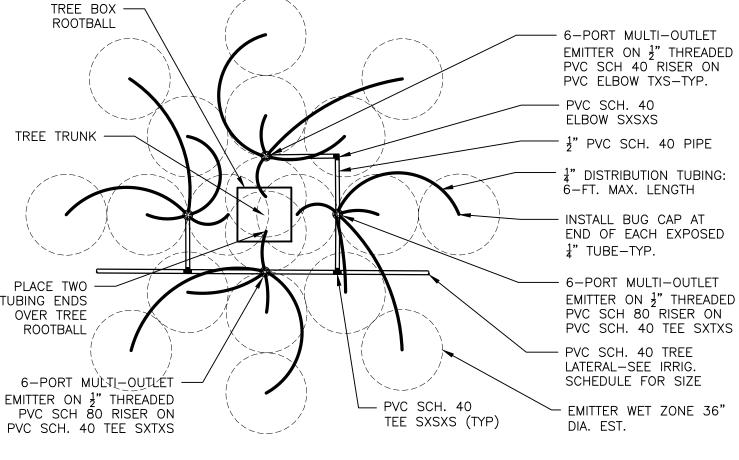

- 1. EMITTER TUBING SHALL BE EQUALLY SPACED AND LOCATED TO DIRECT WATER FLOW AT EMITTER WET ZONES SHOWN. SPACE WET ZONES EQUALLY AROUND TREE PER DETAIL. SOME LOCATIONS ON PLAN WILL NOT ALLOW PLACEMENT DUE TO CONFLICTS.
- 2. MULTIPORT EMITTERS SHALL SHALL HAVE 4 PORTS OPEN. CAP UNUSED OUTLETS NOT USED. 3. INSTALL (4) MULTI-PORT EMITTERS FOR THIS TREE CONDITION (EAST SIDE OF STREET)
- 4. \*\*\* IN LOCATIONS WHERE TREE AND SHRUBS OVERLAP, DELETE DISTRIBUTION TUBING TO TREE AT OR NEAR SHRUB LOCATION.

BID ITEM NOTE: ITEM 440.72200 MULTI-PORT EMITTER WORK INCLUDES MULTI-PORT EMITTER, DISTRIBUTION TUBING, EMITTER ACCESS BOX, FITTINGS, CONNECTION TO LATERAL PIPE, EXCAVATION AND BACKFILL-COMPLETE. (EXCLUDES LATERAL PIPE)





TOWN OF



POWER ROAD: RIGGS ROAD TO CHANDLER HEIGHTS ROAD ROADWAY AND DRAINAGE IMPROVEMENTS



IRRIGATION DETAILS

DESIGNED BY CB CIP PROJ NO. A1405 DRAWN BY

IR501 DRAWING NO.

SHEET 113 OF 133

Chandler, Arizona 85226

Tel. 480.687.6100

### <u>LEGEND</u>:


- 1. SL SERIES SOLAR CONTROLLER SEE IRRIGATION SCHEDULE
- 2. SL-PED-ENC PEDESTAL CABINET
- SL-AIRCARD (VERIFY SIGNAL STRENGTH-CONNECT TO CONTROLLER)
- 4. POWER SUPPLY
- 5. GROUNDING LUG-CONNECT GROUND WIRE TO GROUND GRID
- 6. CONDUIT-115V AC
- 7. POWER SUPPLY WIRES
- 8. #8 SOLID INSULATED COPPER GROUND WIRE TO GROUND GRID
- 9. CONDUIT 24V AC
- 10. PE CABLE-DIRECT BURY, (SHIELDED
- AND TWISTED) TO FLOW SENSOR
- 11. VALVE CONTROL WIRES-ONE PER VALVE 12. TO MASTER VALVE
- 13. 6" DEPTH CONCRETE SLAB-SLOPE SIDES TO DRAIN. CONCRETE SHALL BE

CLASS "B" PER MAG STD. SPEC. 725

- 14. COMPACT SUBGRADE 95% MIN.
- 15. FINISHED GRADE-1" BELOW SLAB


### 2 CONTROLLER GROUNDING

12-IN

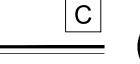



WEATHERMATIC IRRIGATION CONTROLLER

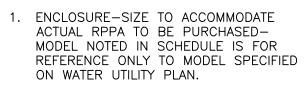

- 2. BACKFLOW PREVENTION DEVICE-SEE WATER UTILITY PLAN
- 3. CxM COPPER ADAPTOR (1 OF 2)
- 4. TYPE K COPPER PIPE (TYP.): LENGTH AS REQUIRED
- 5. CL200 PVC PIPE SLEEVE (1 OF 2) 6. 4" DEPTH CONCRETE PAD-CONSTRUCT 6" LARGER ON ALL SIDES. USE CLASS B CONCRETE PER MAG STD. SPEC.
- 7. FINISHED GRADE
- 8. COPPER FEMALE ADAPTOR
- (8) (9) (10) 9. SCH. 40 PVC MALE ADAPTOR 10. PVC MAINLINE-SEE IRRIGATION
  - SCHEDULE
  - 11. TYPE K COPPER PIPE

SCALE: N.T.S

- 1. FURNISH FITTINGS AND PIPING SIZED 3. INSTALL RPPA UNIT, ENCLOSURE, IDENTICALLY WITH NOMINAL BACKFLOW PREVENTION DEVICE.
- PROVIDE SUBMITTAL AND SHOP DRAWING SPECIFYING ENCLOSURE SIZE AND SHOWING RELATIVE LAYOUT OF EQUIPMENT.

CONCRETE PAD AND ALL


APPURTENANCES-COMPLETE UNDER BID ITEM 632.01000. WORK SHALL ALSO COMPLY WITH SPECIFICATION SECTION

### 4 RPPA CONCRETE PAD AND ENCLOSURE





NO VALVES, REDUCERS, OR ELBOWS IN THIS AREA

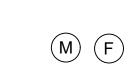

5xPIPE DIA.

### LEGEND:

- 1. UL LISTED #6 AWG BARE COPPER WIRE.
- 2. UL LISTED 4-IN X 96-IN X .0625-IN COPPER GROUNDING PLATE: PAIGE ELECTRIC-INSTALL HORIZONTALLY-WELD WIRE TO PLATE.
- 3. IRRIGATION CONTROLLER/ENCLOSURE.
- 4. UL LISTED § DIA. X 10FT COPPER-CLAD GROUNDING ROD.
- 5. WIRE WELDED TO ROD (PREWELDED OR EXOTHERMIC WELD PROCESS IN FIELD).
- 6. TAN 10-IN VALVE BOX W/ LOCKABLE LID.
- 8. BRICK (1 OF 4)
- 9. FINISH GRADE

1. 14"x19" RECTANGULAR VALVE BOX (COLOR TAN) WITH 6"

1. FLOW SENSOR: DIRECT BURY ONE PAIR, TWISTED SHIELDED

5. DO NOT CUT ENDS OF VALVE BOXES UNNECESSARILY.

BOTTOM OF THE VALVE AND SENSOR ASSEMBLY.

CABLE-MINIMUM CONDUCTOR SIZE 20 AWG. DO NOT EXCEED 2,000 FEET

IN LAYING DISTANCE FROM FLOW SENSOR TO IRRIGATION CONTROLLER.

2. MINIMUM DISTANCES BETWEEN ANY FITTING OR VALVE AND FLOW SENSOR

3. USE VALVE BOX EXTENSIONS AS NECESSARY TO ACHIEVE MINIMUM

4. NOMINAL SIZE OF ALL COMPONENTS ARE TO BE THE SAME NOMINAL

6. POSITION VALVE BOXES OVER VALVE AND SENSOR TO ALLOW EASY

7. INSTALL WASHED GRAVEL SO IT ONLY COMES IN CONTACT WITH THE

SIZE AS THE SOLENOID VALVE (SIZED PER IRRIGATION SCHEDULE).

EXTENSIONS AS REQUIRED. STAMP LID WITH "FS" AND "MV"

PLAN VIEW

LEGEND:

2. FINISHED GRADE

8. FLOW SENSOR

10. REDUCER AS REQUIRED

ARE NOTED ABOVE.

ACCESS TO SOLENOID.

DIMENSIONS ABOVE ASSEMBLY.

11. PVC SCHEDULE 40 ADAPTOR

3. WATERPROOF WIRE CONNECTORS

4. 30" LENGTH OF COILED WIRES

5. PVC MAINLINE FROM RPPA BACKFLOW DEVICE

7.  $\frac{3}{4}$ " WASHED GRAVEL-MINIMUM 3' DEPTH-TYP.

6. REMOTE CONTROL VALVE—SEE LEGEND

9. DIRECT BURIAL CABLE—SEE NOTE 1)

# 7. 3-IN MIN. DEPTH OF 3" WASHED GRAVEL. EQ. SPACED

### LEGEND:

- 1. WIRELESS WEATHER STATION-SYNCHRONIZE TO WEATHER STATION HUB IN CONTROLLER
- 2. SOLAR PANEL ARRAY-2 PANELS. ORIENT PANELS AT 30 DEGREES ABD FACE DUE SOUTH
- 3. ADJUSTABLE MODULE SUPPORT STRUCTURE, 15"-65" (TILT ANGLE VARIES BASED ON LOCATION)
- 4. 3" SCH. 40 GALVANIZED STEEL POST
- 5. CABLES FROM SOLAR ARRAY J-BOX TO J-BOX ON BOTTOM OF POLE
- 6. 4"x4"x8" GALVANIZED STEEL J-BOX RATED NEMA 3R
- 7. J-BOX MOUNTING BRACKETS (2)
- 8. (1) DB 120 CONDUIT FROM J-BOX TO CONTROLLER. ÈLÉCTRICAL CONDUIT FROM ENCLOSURE TO SWEEP PAST THE FOOTING FOR GROUNDING WIRE TO CONNECT TO CONTROLLER GROUNDING ROD, SIZE AS REQUIRED.
- 9. CONCRETE FOOTING-PER IBC 2015 TABLE 1806.2; MATERIAL CLASS 5. CONCRETE WORK SHALL CONFORM TO LATEST EDITION OF ACI 318, "BUILDING CODE REQUIREMENTS FOR STRUCTUAL CONCRETE". FOOTING SHALL CONFORM TO ACI 336, "STANDARD SPEC. FOR CONSTRUCTION OF DRILLED PIERS. REINFORCING STEEL PER ASTM A-615, GRADE 60.
- 10. WELD STEEL ROD TO POST EACH SIDE FOR POST SUPPORT
- 11. COMPACT SUBGRADE 95% MIN ALL SIDES OF FOOTING 12. CONTROLLER











POWER ROAD: RIGGS ROAD TO CHANDLER HEIGHTS ROAD ROADWAY AND DRAINAGE IMPROVEMENTS



Chandler, Arizona 85226 Tel. 480.687.6100

IRRIGATION DETAILS 2

DESIGNED BY CB CIP PROJ NO. A1405 DRAWN BY

> IR502 DRAWING NO.

SHEET 114 OF 133

- 2. IT IS THE RESPONSIBILITY OF THE CONTRACTOR TO COORDINATE ALL PLANT MATERIAL LOCATIONS WITH OTHER TRADES PRIOR TO INSTALLATION. THE CONTRACTOR SHALL FAMILIARIZE THEMSELVES WITH THE LOCATIONS OF EXISTING AND FUTURE UNDERGROUND SERVICES AND IMPROVEMENTS WHICH MAY CONFLICT WITH THE WORK TO BE DONE. PRIOR TO THE START OF WORK, ALL UNDERGROUND UTILITIES SHALL BE LOCATED AND PROTECTED. EXISTING UNDERGROUND SERVICES SHALL NOT BE DISTURBED OR REMOVED UNLESS SPECIFICALLY NOTED OTHERWISE ON DRAWINGS.
- 3. PLANTING DESIGN MAY BE MODIFIED TO ADAPT TO EXISTING CONDITIONS THAT DIFFER FROM THESE PLANS, AND DUE TO GRADE LIMITATIONS ON SITE.
- 4. ALL PLANTS SHALL BE OF VARIETIES AND TYPES SPECIFIED AND PURCHASED FROM GROWERS OR COMPANIES THAT ARE APPROVED BY THE AMERICAN NURSERY ASSOCIATION AND THE ARIZONA NURSERY ASSOCIATION. PLANTS SPECIFIED WERE VERIFIED AS "AVAILABLE" DURING DESIGN. IT IS THE CONTRACTOR'S RESPONSIBILITY TO LOCATE PLANTS FROM NURSERIES OUTSIDE ARIZONA IF NOT AVAILABLE LOCALLY. ALL DELIVERY COSTS SHALL BE INCLUDED IN THE BID. ADDITIONAL COSTS INCURRED AFTER AWARD SHALL BE CONTRACTOR'S RESPONSIBILITY. NO CHANGE ORDER WILL BE ACCEPTED BY THE TOWN OF QUEEN CREEK. ALL PLANTS SHALL BE SECURED FOR THIS PROJECT NO LATER THAN 60 DAYS AFTER PROJECT NOTICE TO PROCEED. CONTRACTOR SHALL PAY FOR ALL TRAVEL COSTS FOR LANDSCAPE ARCHITECT AND TOWN OF QUEEN CREEK CIP INSPECTOR OR REPRESENTATIVE TO VISIT NURSERIES IF LOCATED OUTSIDE ARIZONA.
- 5. \*\*TREES: ALL TREES ON NORTH SIDE OF STREET SHALL BE NURSERY SELECTED TO PROVIDE A SIX FOOT "NO BRANCH/NO LEAF CLEAR ZONE" FOR TRAFFIC SIGHT LINE VISIBILITY MEASURED FROM "PLANTED" FINISH GRADE. SELECT TREES WITH HIGH BRANCHING TO ACHIEVE THIS.
  - 5A. IF SOME TREES REQUIRE "MINOR" PRUNING TO ACHIEVE THIS CLEARANCE, PROPOSED PRUNING SHALL BE REVIEWED IN ADVANCE WITH AN ARBORIST AND LANDSCAPE ARCHITECT. UNDER NO CIRCUMSTANCE SHALL PRUNING COMPROMISE TREE FORM AND TREE INTEGRITY.
  - 5B. ALL TREES SHALL BE TAGGED AND APPROVED BY LANDSCAPE ARCHITECT AND TOWN INSPECTOR AT THE NURSERY. PROVIDE PHOTOS OF TREES IN ADVANCE FOR PRE-APPROVAL BY LANDSCAPE ARCHITECT PRIOR TO SCHEDULING NURSERY VISIT. TREE SELECTION INTENT:
  - 5C. ALL TREES SHALL BE SELECTED TO HAVE A SOUND TREE BRANCH STRUCTURE BECAUSE UPON PROJECT COMPLETION, THE TOWN WILL START SHAPING THESE TREES AS THEY GROW TO ACHIEVE A 8-FT NO-LEAF CLEARANCE FROM 6-FT.
- 6. PLANT APPROVALS: CONTRACTOR SHALL SUBMIT (PDF FILE TYPE ONLY) COLOR DIGITAL PHOTOGRAPHS (MINIMUM 300 DPI RESOLUTION) OF ALL PLANT MATERIALS SPECIFIED PRIOR TO ORDERING FOR REVIEW AND APPROVAL BY TOWN CIP INSPECTOR'S AUTHORIZED REPRESENTATIVE. FOR TREES AND SHRUBS, EACH PHOTO SHALL INCLUDE A MEASURING STICK (FEET—INCHES) FOR PLANT SIZE VERIFICATION. MEASURING STICKS SHALL BE READABLE IN EACH PHOTO. LABEL PLANT NAME AND NURSERY SOURCE ON EACH PDF PHOTO.

- 7. VERIFY PLANT AND LANDSCAPE ROCK QUANTITIES DURING BIDDING AND PRIOR TO INSTALLATION. QUANTITIES ARE LISTED FOR CONVENIENCE ONLY, THE ACTUAL NUMBER OF SYMBOLS SHOWN ON THE PLANTING PLANS SHALL HAVE PRIORITY OVER QUANTITIES LISTED WITHIN THE LANDSCAPE MATERIAL SCHEDULES. THE CONTRACTOR SHALL FURNISH ALL PLANT MATERIAL NECESSARY TO COMPLETE THE PLANTINGS AS SHOWN ON THE PLANS.
- 8. CLARIFICATION OF DISCREPANCIES BETWEEN THE CONSTRUCTION DOCUMENTS AND THE SITE SHALL IMMEDIATELY BE BROUGHT TO THE ATTENTION OF THE PROJECT LANDSCAPE ARCHITECT.
- 9. ONLY THE LANDSCAPE ARCHITECT OR TOWN CIP INSPECTOR MAY APPROVE SUBSTITUTIONS REQUESTED OTHERWISE, PLANT SUBSTITUTIONS ARE PROHIBITED.
- 10. ALL PLANT MATERIAL MUST BE MAINTAINED IN HEALTH AND VIGOR, AND BE ALLOWED TO ATTAIN NATURAL SIZE AND SHAPE IN ACCORDANCE WITH NATIONAL AND ARIZONA NURSERY ASSOCIATION SPECIFICATIONS AND PROJECT SPECIFICATIONS.
- 11. UPON DELIVERY, ALL PLANT MATERIAL IS SUBJECT TO INSPECTION PRIOR TO ACCEPTANCE. TOWN CIP INSPECTOR RESERVES THE RIGHT TO REFUSE ANY PLANT MATERIAL DEEMED UNACCEPTABLE, EVEN AFTER DELIVERY TO THE SITE.
- 12. SHRUBS/GROUNDCOVER PLACEMENTS:
  - 12A. FLAG ALL PLANT LOCATIONS FOR APPROVAL BY TOWN CIP INSPECTOR'S AUTHORIZED REPRESENTATIVE PRIOR TO INSTALLATION.
  - 12B. LOCATE PLANTS BY MEASURING THEIR PLANT CENTERS NO CLOSER THAN NOTED ON THE PLANT SCHEDULE ON EACH PLAN SHEET. SPACE PLANTS FURTHER APART WHERE GRAPHICALLY SHOWN ON THE PLANS. FIELD ADJUST IF NECESSARY TO AVOID ANY UNFORESEEN CONFLICTS NOT SHOWN ON THESE PLANS.
  - 12C. PLANT CENTERS SHALL BE NO CLOSER THAN THE DISTANCE SPECIFIED ON THE PLANT SCHEDULE LOCATED ON EACH PLAN SHEET. DISTANCES ARE MEASURED FROM PLANT CENTER TO EDGE OF PAVEMENTS, PUBLIC ACCESS—WAYS, OR BACK OF CURBS UNLESS OTHERWISE STATED OR DETAILED DIFFERENTLY ON THE PLANS OR AS DIRECTED BY THE CITY PROJECT MANAGER'S AUTHORIZED REPRESENTATIVE.
- 13. PLANTING METHODS, SOIL AMENDMENT QUANTITIES, AND PLANT PIT PREPARATION METHODS SHALL BE ACCORDING TO THE PLANTING SPECIFICATIONS AND DETAILS.
- 14. ALL PLANTING AREAS SHALL RECEIVE
  PRE-APPROVED WEED CONTROL/ PRE-EMERGENT
  HERBICIDES PER THE GUIDELINES SET FORTH IN
  THE SPECIFICATIONS AND DETAILS. RE-APPLY
  HERBICIDES AS NECESSARY TO COMPLETELY KILL
  NOXIOUS MATERIAL, INCLUDING WEEDS, BERMUDA
  GRASS. REMOVE ANY DEBRIS AND PROPERLY
  DISPOSE OF OFF-SITE. REMOVE LARGE
  WEEDS/ROOTS BY HAND UP TO PROJECT FINAL
  ACCEPTANCE.
- 15. DECOMPOSED GRANITE (GRAVEL MULCH) SHALL COVER ALL LANDSCAPE PLANTER AREAS. ROCK SHALL BE INSTALLED UNIFORMLY. INSTALL PER PLAN DETAILS AND PROJECT SPECIFICATIONS.
- 16. UNLESS OTHERWISE DIRECTED BY TOWN CIP INSPECTOR'S AUTHORIZED REPRESENTATIVE, REMOVE ALL NURSERY STAKES FROM TREES. ADD ADDITIONAL GUYS TO TREE STAKING AS NECESSARY. DO NOT OVER TIGHTEN ALLOW TRUNKS TO MOVE WITHIN GUYS WITHOUT RUBBING AGAINST THE TRUNK OR BRANCHES.
- 17. PLANT WARRANTY SHALL BE UNCONDITIONAL FOR ONE (1) YEAR FROM DATED OF SUBSTANTIAL COMPLETION—SEE ALSO SPECIFICATIONS.

MASTE	R PLAN	IT SCHEDULE						
TREES					GIVEN FOR T MINIMUM		RENCE ONLY. TREE PER SIZE	
SYMBOL	QUANTITY			MIN CALIPER *MIN BOX SIZE		MINIMUM SIZE (HT.xWD.)		
*	48	PISTACIA X HYBRID 'RED PUSH' RED PUSH PISTACHE			ALIPER BOX		10"x 4"	
	45	ULMUS PARVIFLORA 'TRUE GREEN' TRUE GREEN ELM			ALIPER BOX		11"× 7"	
SHRUE	BS						MATURE SIZE (HT.xWD.) NO PRUNING!!	
SYMBOL	QUANTITY	BOTANICAL NAME/COMMON NAME	CONTAINEF		ER MINIMUM SIZE (HT.xWD.)		MINIMUM SPACING FROM OTHER PLANTS	
B	133	EREMOPHILA HYGROPHANA 'BLUE BELLS (1) BLUE BELLS EREMOPHILA	5	GAL.	GAL. 9"x9"		2'x4' PLANT MIN. 5' APART	
	290	ERICAMERIA LARICIFOLIA 'DESERT MOUNTAIN' (1) TURPENTINE BUSH 'DESERT MOUNTAIN'	5	GAL. 9">			2'x3' PLANT MIN. 4' APART	
$\bigoplus$	133	LEUCOPHYLLUM LANGMANIAE 'LYNN'S LEGACY' TEXAS RANGER LYNN'S LEGACY (1)	5	GAL.	12"x10'	,	5'x5' PLANT MIN 6' APART	
G	137	TEUCRIUM CHAMAERDYS GERMANDER	5	GAL.	6"x12"		1'x2' PLANT MIN. 3' APART	
GROUN	IDCOVE	RS						
Ø	12 EREMOPHILA GLABRA 'MINGNEW GOLD' OUTBACK SUNRISE EMU (1)		5	GAL.	4"x12"		1'x6' PLANT MIN 6' APART	
$\oplus$	128	LANTANA X 'NEW GOLD' NEW GOLD LANTANA	5	GAL.	10"x10'	,	2'x4' PLANT MIN 5' APART	
SUCCU	LENTS							
•	184	HESPERALOE PARVIFLORA 'DESERT FLAMENCO' DESERT FLAMENCO YUCCA (1)	5	GAL.	12"x12'	,	3'x3' PLANT MIN 3' APART	

(1) KNOWN SOURCE: MOUNTAIN STATES WHOLESALE NURSERY

### LANDSCAPE ROCK

<u>KEY:</u>

**DESCRIPTION** 

GRAVEL MULCH GROUNDCOVER: SEE CIVIL PLANS FOR QUANTITIES 1/2" SCREENED COLOR: 'SUPERIOR GOLD', DEPTH 2" SEE DETAIL 2,3 SHEET L501 SOURCE: KALAMAZOO MATERIALS INC.

ITEM BID ITEM **DESCRIPTION** QTY. <u>UNIT</u> 93 430.50136 INSTALL 36-INCH BOX TREE PER DETAIL 1, SHEET PL501. 2. 430.50205 INSTALL 5-GALLON SHRUB 1,110 EA PER DETAIL 2, SHEET PL501. SY 3. 430.53110 INSTALL 2" DEPTH GRAVEL \_ MULCH IN ALL LANDSCAPE PLANTER AREAS PER DETAIL 3,4 SHEET PL501-SEE CIVIL PLAN FOR QUANTITIES.

QUANTITY

10/03/202

SUBMITTAL

SEALED

IMPROVEMENTS

DRAINAGE

| ∞

ROADWAY

ROAD

HEIGHTS

CHANDLER

잍

ROAD

LANDSCAPE CONSTRUCTION NOTES (TYP)

Contact Arizona 811 at least two full working days before you begin excavation

ARE LONG BACKETS

Call 811 or click Arizona811.com



TOWN OF QUEEN CREEK

Chandler, Arizona 85226 Tel. 480.687.6100



POWER ROAD: RIGGS ROAD TO CHANDLER HEIGHTS ROAD ROADWAY AND DRAINAGE IMPROVEMENTS

Stantec

LANDSCAPING NOTES AND SCHEDULES

DESIGNED BY CB
DRAWN BY CB


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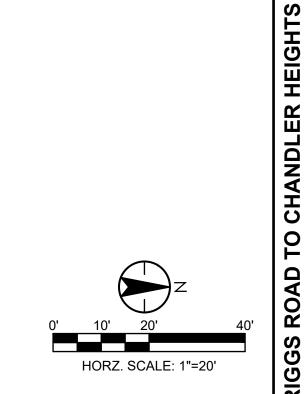
SHEET 115 OF 133

SHEET KEYMAP

PL001 PL002 PL003 PL004 PL005 PL006 PL007 PE008 PL009 PL010 PL011 PL012 PL013 PL014





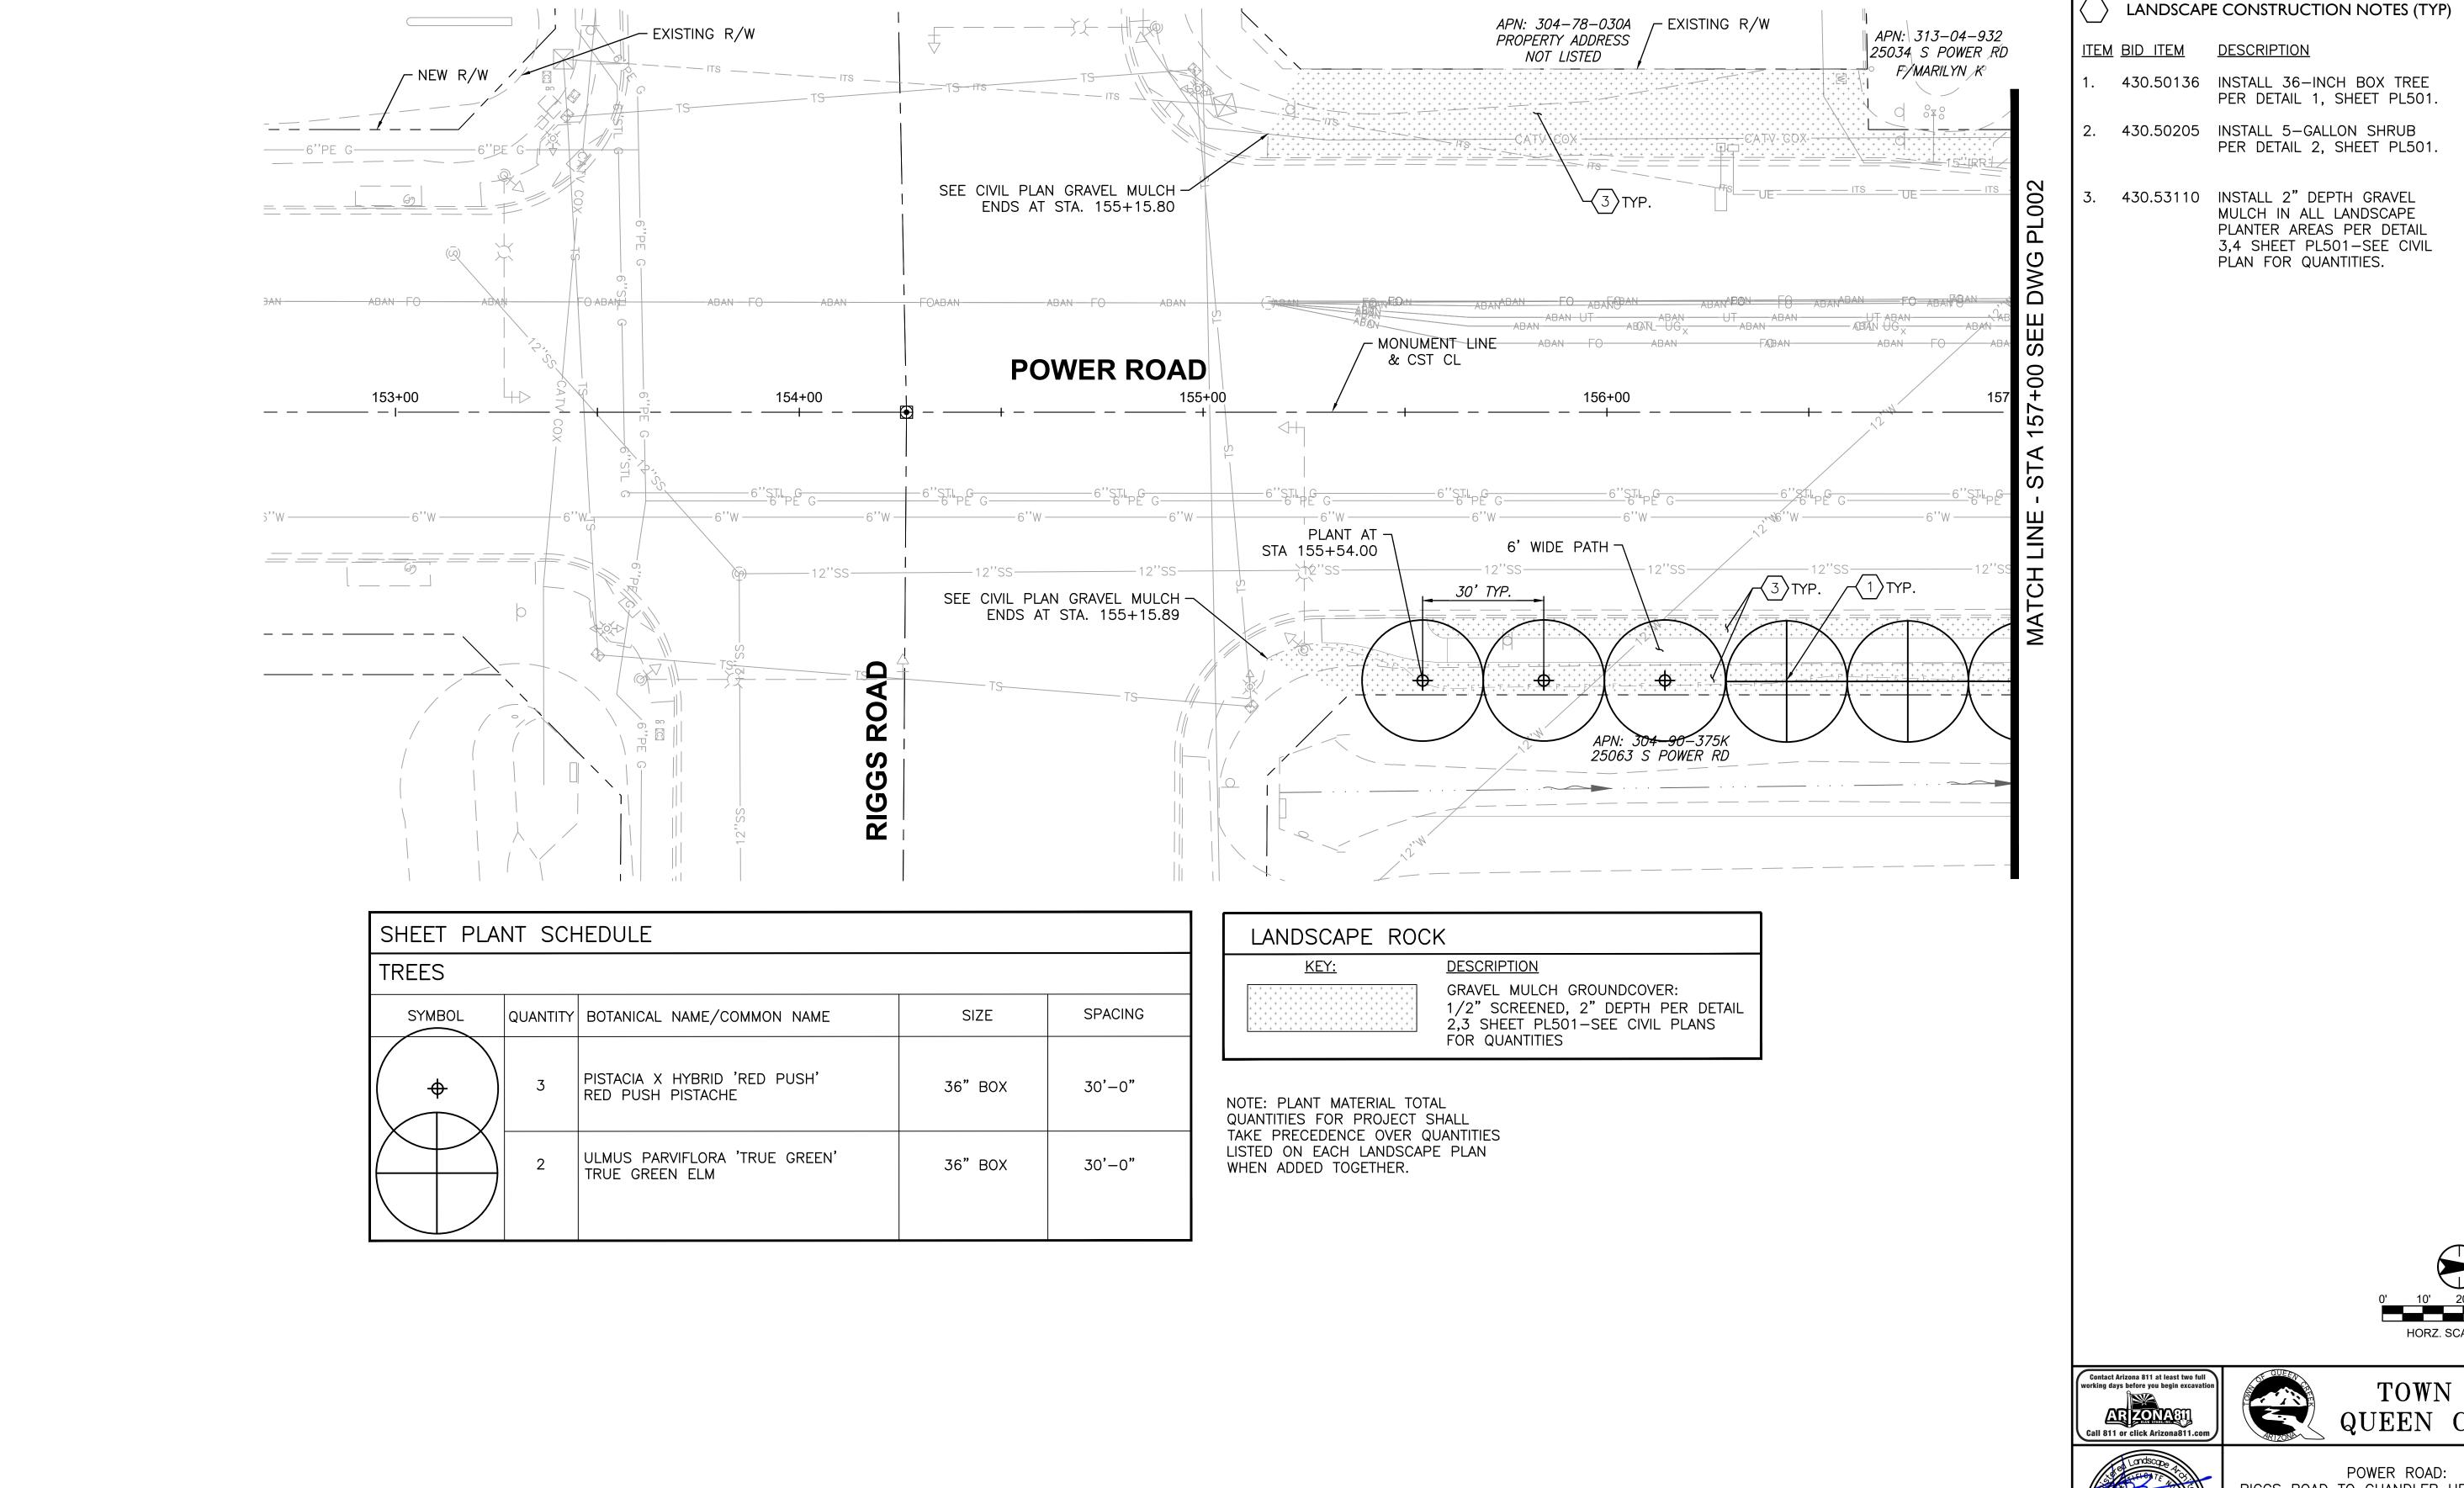

ROAD

QUANTITY

<u>QTY</u> <u>UNIT</u>

O EA

- SY

**DESCRIPTION** 

PER DETAIL 1, SHEET PL501.


PER DETAIL 2, SHEET PL501.

MULCH IN ALL LANDSCAPE PLANTER AREAS PER DETAIL 3,4 SHEET PL501-SEE CIVIL

PLAN FOR QUANTITIES.



TOWN OF QUEEN CREEK

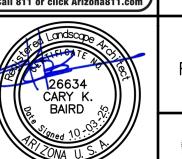

POWER ROAD: RIGGS ROAD TO CHANDLER HEIGHTS ROAD ROADWAY AND DRAINAGE IMPROVEMENTS


( ) Stantec

Chandler, Arizona 85226 Tel. 480.687.6100

LANDSCAPING PLAN 1 DESIGNED BY CB CIP PROJ NO. A1405 DRAWN BY SHEET 116 OF 133 PL001 DRAWING NO.

PL002 PL003 PL004 PL005 PL006 PL007 PL008 PL009 PL010 PL011 PL012 PL013 PL014/

SHEET KEYMAP

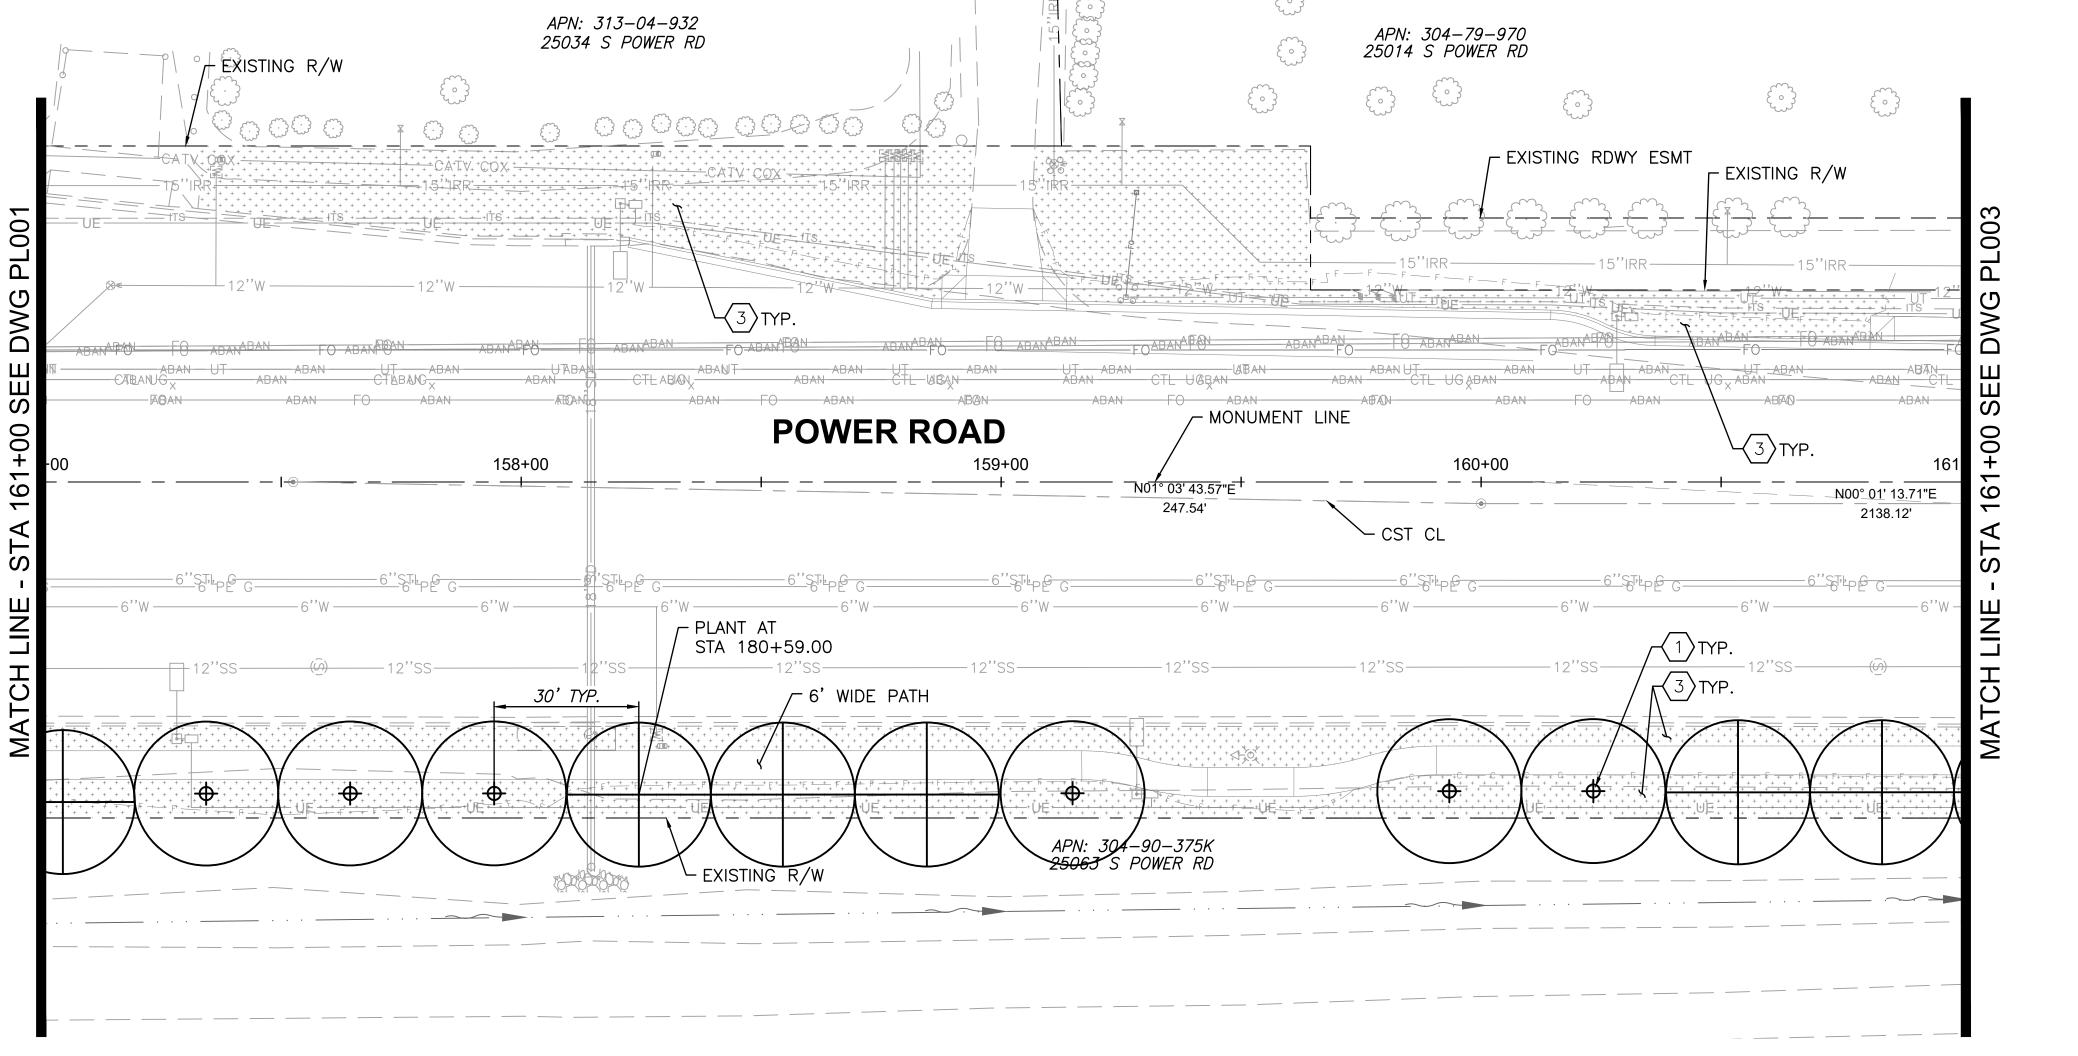


			T						
SHEET PLANT SCHEDULE									
SHRUE	S		NO PRUNING!!	PLANT SETBACK:					
SYMBOL	QUANTITY	BOTANICAL NAME/COMMON NAME	MINIMUM SPACING FROM OTHER PLANTS	MINIMUM PLANT CENTER FROM INSIDE EDGE OF CURB OR PAVEMENT					
B	B 0 EREMOPHILA HYGROPHANA 'BLUE BELLS BLUE BELLS EREMOPHILA		PLANT MIN. 5' APART	2'-6"					
0	0	ERICAMERIA LARICIFOLIA 'DESERT MOUNTAIN' TURPENTINE BUSH 'DESERT MOUNTAIN'	PLANT MIN. 4' APART	2'-0"					
$\oplus$	0	LEUCOPHYLLUM LANGMANIAE 'LYNN'S LEGACY TEXAS RANGER LYNN'S LEGACY	PLANT MIN 6' APART	3'-0"					
G	G TEUCRIUM CHAMAERDYS GERMANDER		PLANT MIN. 3' APART	1'-6"					
GROUN	DCOVE	RS							
$\varnothing$	0	EREMOPHILA GLABRA 'MINGNEW GOLD' OUTBACK SUNRISE EMU	PLANT MIN 6' APART	3'-0"					
$\oplus$	0	LANTANA X 'NEW GOLD' NEW GOLD LANTANA	PLANT MIN 5' APART	2'-0"					
SUCCU	SUCCULENTS								
•	0	HESPERALOE PARVIFLORA 'DESERT FLAMENCO' HYBRID YUCCA 'DESERT FLAMINCO'	PLANT MIN 4' APART	2'-0"					


SHEET PLANT SCHEDULE							
TREES							
SYMBOL	QUANTITY	BOTANICAL NAME/COMMON NAME	SIZE	SPACING			
<b>•</b>	6	PISTACIA X HYBRID 'RED PUSH' RED PUSH PISTACHE	36" BOX	30'-0"			
	6	ULMUS PARVIFLORA 'TRUE GREEN' TRUE GREEN ELM	36" BOX	30'-0"			

LANDSCAPE ROC	K
<u>KEY:</u>	<u>DESCRIPTION</u>
+         +	GRAVEL MULCH GROUNDCOVER: 1/2" SCREENED, 2" DEPTH PER DETAIL 2,3 SHEET PL501—SEE CIVIL PLANS FOR QUANTITIES

WHEN ADDED TOGETHER.

NOTE: PLANT MATERIAL TOTAL QUANTITIES FOR PROJECT SHALL TAKE PRECEDENCE OVER QUANTITIES LISTED ON EACH LANDSCAPE PLAN

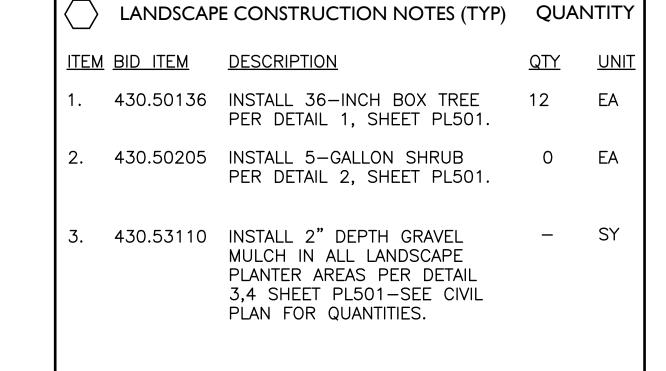


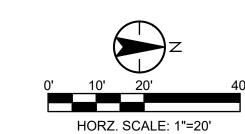





TOWN OF QUEEN CREEK

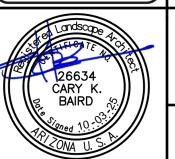

POWER ROAD: RIGGS ROAD TO CHANDLER HEIGHTS ROAD ROADWAY AND DRAINAGE IMPROVEMENTS




Chandler, Arizona 85226 Tel. 480.687.6100 www.stantec.com

LANDSCAPING PLAN 2

		1200/11110 12/11	
DESIGNED BY	CB	CIP PROJ NO. A1	405
DRAWN BY	CB	CIP PROJ NO. AT	403
DRAWING NO		PL002	SHEET 117 OF 13

SHEET KEYMAP

PL001 PL002 PL003 PL004 PL005 PL006 PL007 PL008 PL009 PL010 PL011 PL012 PL013 PL014

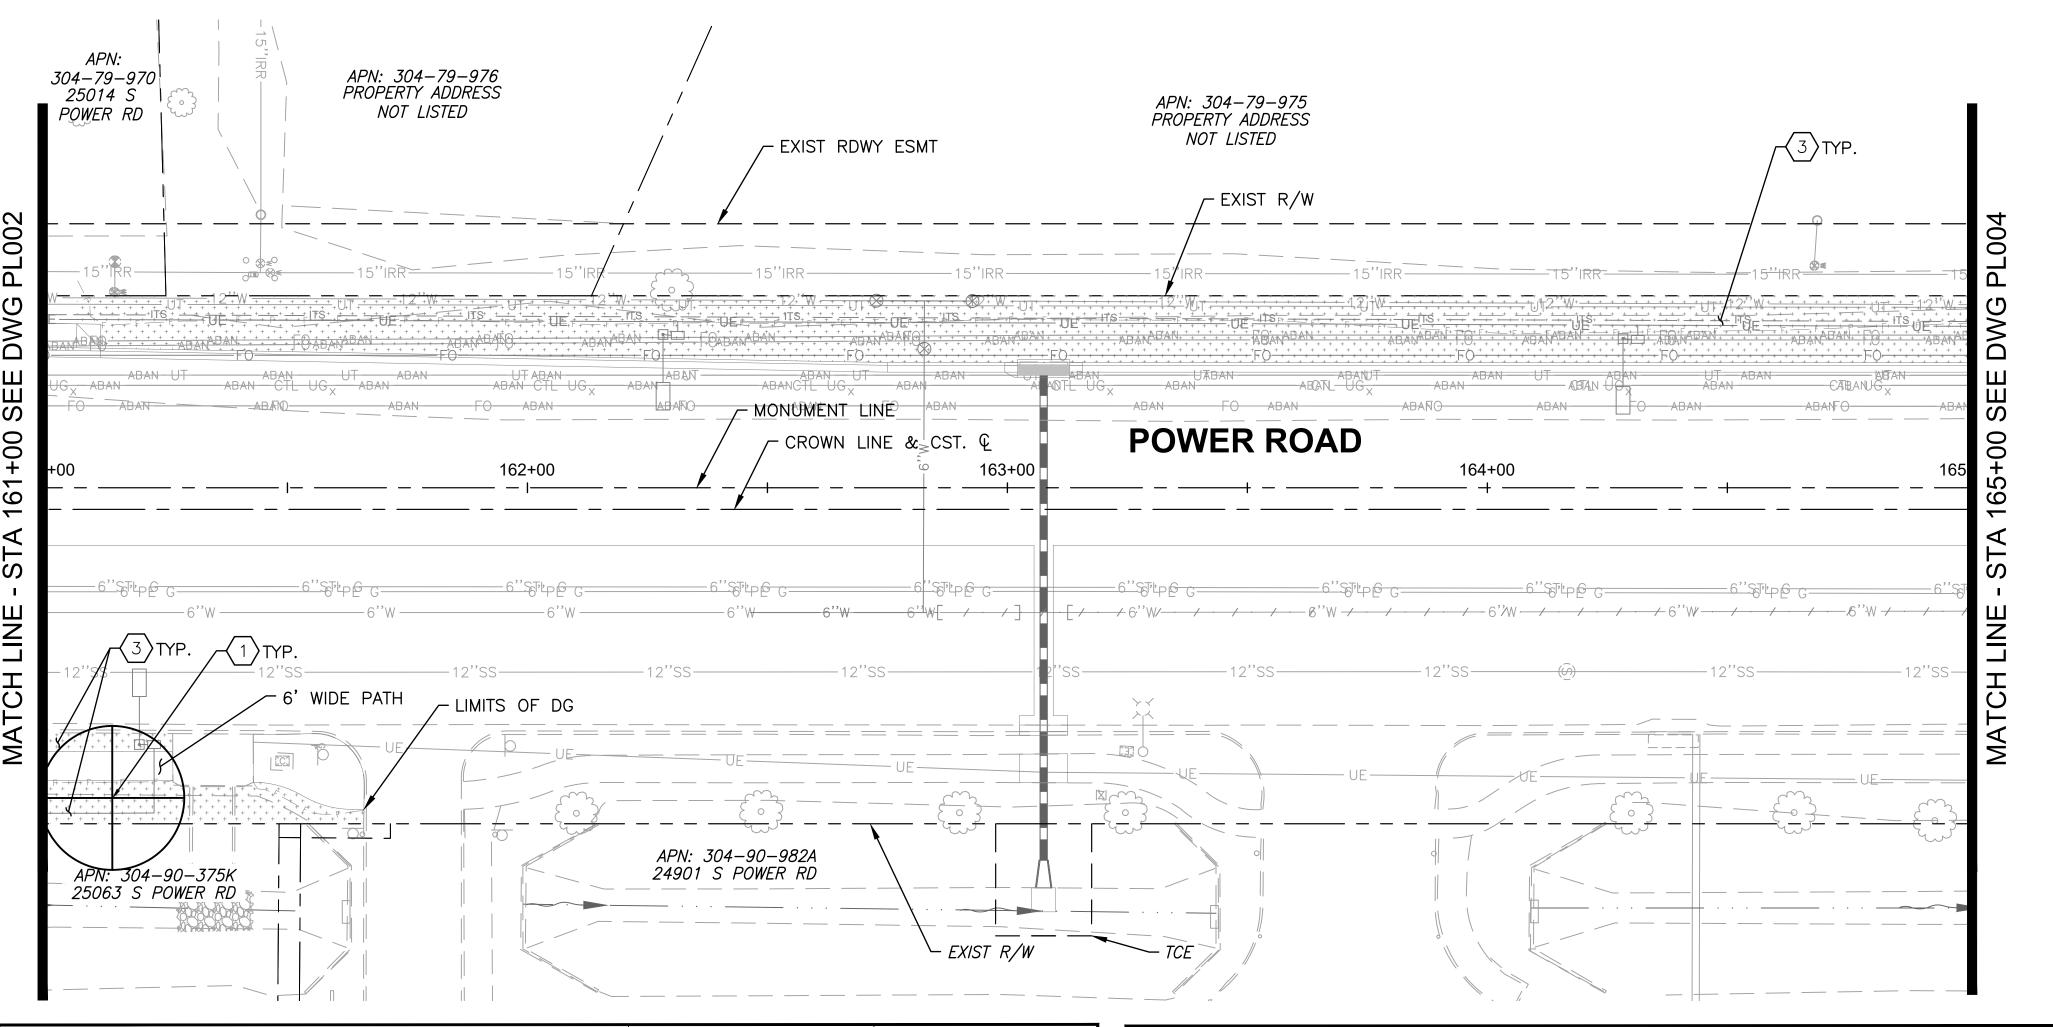



SHEET	PLANT	SCHEDULE			
SHRUE	3S		NO PRUNING!!	PLANT SETBACK:	
SYMBOL	QUANTITY	BOTANICAL NAME/COMMON NAME	MINIMUM SPACING FROM MINIMUM PLANT CE OTHER PLANTS FROM INSIDE EDGE CURB OR PAVEMI		
B	0	EREMOPHILA HYGROPHANA 'BLUE BELLS BLUE BELLS EREMOPHILA	PLANT MIN. 5' APART	2'-6"	
	0	ERICAMERIA LARICIFOLIA 'DESERT MOUNTAIN' TURPENTINE BUSH 'DESERT MOUNTAIN'	PLANT MIN. 4' APART	2'-0"	
$\oplus$	0	LEUCOPHYLLUM LANGMANIAE 'LYNN'S LEGACY TEXAS RANGER LYNN'S LEGACY	PLANT MIN 6' APART	3'-0"	
G	0	TEUCRIUM CHAMAERDYS GERMANDER	PLANT MIN. 3' APART	1'-6"	
GROUNDCOVERS					
Ø	0	EREMOPHILA GLABRA 'MINGNEW GOLD' OUTBACK SUNRISE EMU	PLANT MIN 6' APART	3'-0"	
<u></u>	0	LANTANA X 'NEW GOLD' NEW GOLD LANTANA	PLANT MIN 5' APART	2'-0"	
SUCCU	LENTS				
•	0	HESPERALOE PARVIFLORA 'DESERT FLAMENCO' HYBRID YUCCA 'DESERT FLAMINCO'	PLANT MIN 4' APART	2'-0"	

SHEET PLANT SCHEDULE				
TREES				
SYMBOL	QUANTITY	BOTANICAL NAME/COMMON NAME	SIZE	SPACING
<b>+</b>	0	PISTACIA X HYBRID 'RED PUSH' RED PUSH PISTACHE	36" BOX	30'-0"
	1	ULMUS PARVIFLORA 'TRUE GREEN' TRUE GREEN ELM	36" BOX	30'-0"

LANDSCAPE ROCK				
<u>KEY:</u>	<u>DESCRIPTION</u>			
+ + + + + + + + + + + + + + + + + + +	GRAVEL MULCH GROUNDCOVER: 1/2" SCREENED, 2" DEPTH PER DETAIL 2,3 SHEET PL501—SEE CIVIL PLANS FOR QUANTITIES			

SHEET KEYMAP

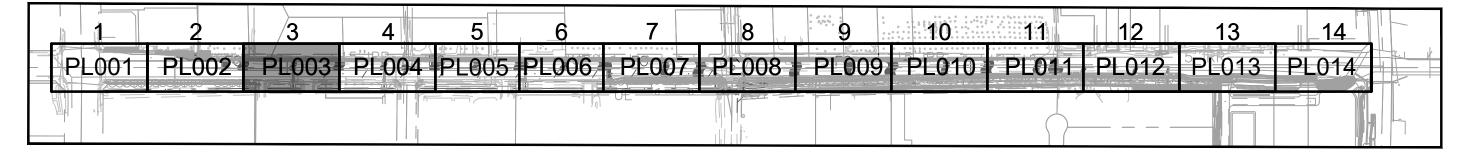

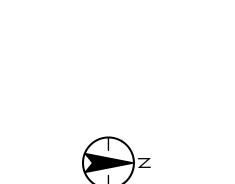

HORZ. SCALE: 1"=20'



TOWN OF QUEEN CREEK



DRAWN

POWER ROAD: RIGGS ROAD TO CHANDLER HEIGHTS ROAD ROADWAY AND DRAINAGE IMPROVEMENTS

Stantec

LANDSCAPE CONSTRUCTION NOTES (TYP) QUANTITY

PER DETAIL 1, SHEET PL501.

PER DETAIL 2, SHEET PL501.

MULCH IN ALL LANDSCAPE

PLANTER AREAS PER DETAIL 3,4 SHEET PL501-SEE CIVIL

PLAN FOR QUANTITIES.

<u>QTY</u> <u>UNIT</u>

O EA

<u>ITEM</u> <u>BID</u> <u>ITEM</u> <u>DESCRIPTION</u>


1. 430.50136 INSTALL 36-INCH BOX TREE

2. 430.50205 INSTALL 5-GALLON SHRUB

3. 430.53110 INSTALL 2" DEPTH GRAVEL

Chandler, Arizona 85226 Tel. 480.687.6100 www.stantec.com LANDSCAPING PLAN 3

NED BY	CB	CID DDO L NO. A:	CIP PROJ NO. A1405			
N BY	CB	CIP PROJ NO. A	405			
DRAWING NO.		PL003	SHEET 118 OF 1			

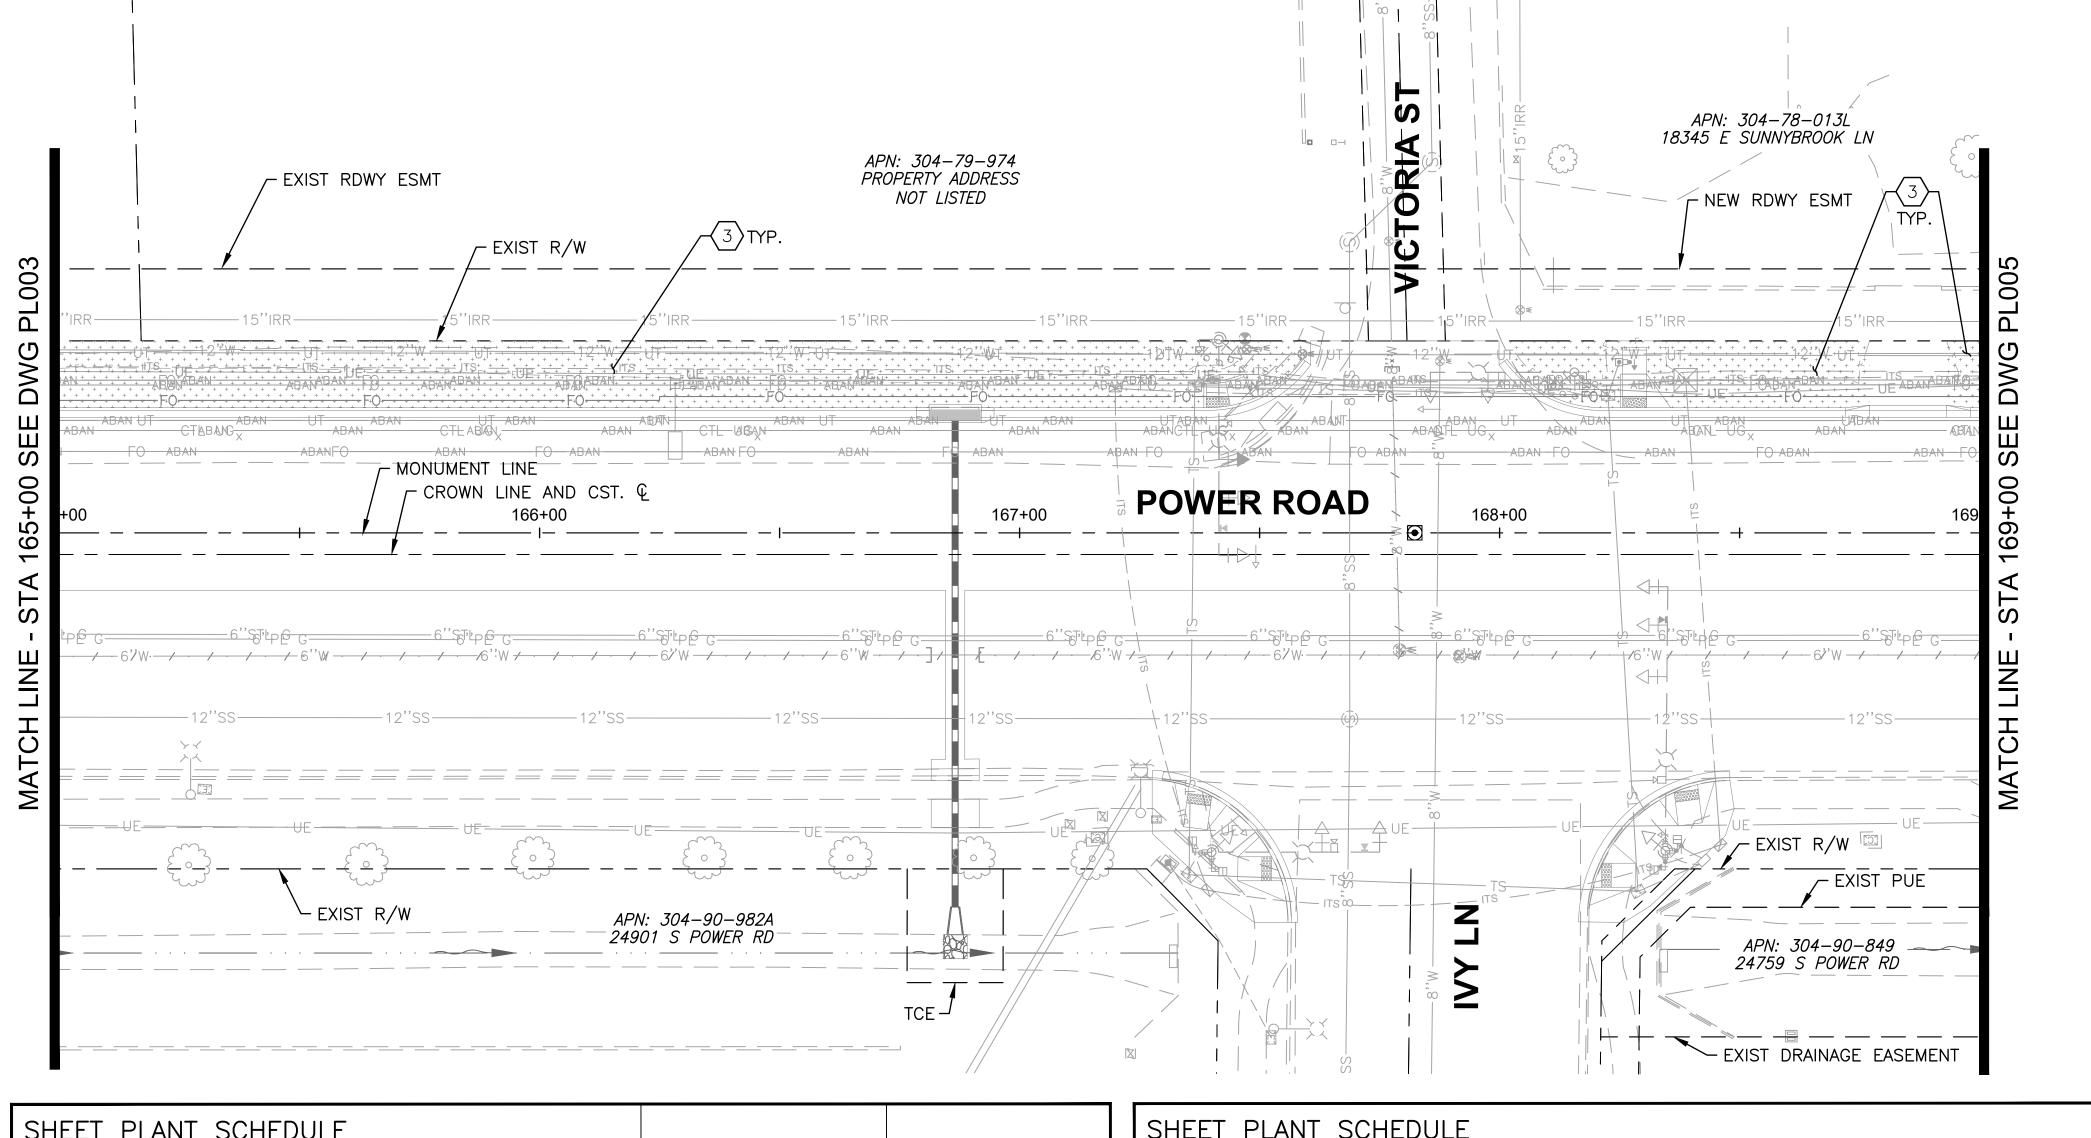

SHEET	SHEET PLANT SCHEDULE						
SHRUB	S		NO PRUNING!!	PLANT SETBACK:			
SYMBOL	QUANTITY	BOTANICAL NAME/COMMON NAME	MINIMUM SPACING FROM MINIMUM PLANT CEN  OTHER PLANTS FROM INSIDE EDGE  CURB OR PAVEMEN				
B	0	EREMOPHILA HYGROPHANA 'BLUE BELLS BLUE BELLS EREMOPHILA	PLANT MIN. 5' APART	2'-6"			
0	0	ERICAMERIA LARICIFOLIA 'DESERT MOUNTAIN' TURPENTINE BUSH 'DESERT MOUNTAIN'	PLANT MIN. 4' APART	2'-0"			
$\oplus$	0	LEUCOPHYLLUM LANGMANIAE 'LYNN'S LEGACY TEXAS RANGER LYNN'S LEGACY	PLANT MIN 6' APART	3'-0"			
G	0	TEUCRIUM CHAMAERDYS GERMANDER	PLANT MIN. 3' APART	1'-6"			
GROUN	DCOVE	RS					
$\varnothing$	0	EREMOPHILA GLABRA 'MINGNEW GOLD' OUTBACK SUNRISE EMU	PLANT MIN 6' APART	3'-0"			
<del></del>	0	LANTANA X 'NEW GOLD' NEW GOLD LANTANA	PLANT MIN 5' APART	2'-0"			
SUCCU	LENTS						
•	0	HESPERALOE PARVIFLORA 'DESERT FLAMENCO' HYBRID YUCCA 'DESERT FLAMINCO'	PLANT MIN 4' APART	2'-0"			

SHEET PLA	NT SCH	HEDULE		
TREES				
SYMBOL	QUANTITY	BOTANICAL NAME/COMMON NAME	SIZE	SPACING
<b>+</b>	0	PISTACIA X HYBRID 'RED PUSH' RED PUSH PISTACHE	36" BOX	30'-0"
	0	ULMUS PARVIFLORA 'TRUE GREEN' TRUE GREEN ELM	36" BOX	30'-0"

LANDSCAPE ROCK				
<u>KEY:</u>	<u>DESCRIPTION</u>			
	GRAVEL MULCH GROUNDCOVER: 1/2" SCREENED, 2" DEPTH PER DETAIL 2,3 SHEET PL501—SEE CIVIL PLANS FOR QUANTITIES			

0' 10' 20' 40

HORZ. SCALE: 1"=20'





TOWN OF QUEEN CREEK



POWER ROAD:
RIGGS ROAD TO CHANDLER HEIGHTS ROAD
ROADWAY AND DRAINAGE IMPROVEMENTS



LANDSCAPE CONSTRUCTION NOTES (TYP) QUANTITY

PER DETAIL 1, SHEET PL501.

PER DETAIL 2, SHEET PL501.

MULCH IN ALL LANDSCAPE PLANTER AREAS PER DETAIL 3,4 SHEET PL501—SEE CIVIL

PLAN FOR QUANTITIES.

<u>QTY</u> <u>UNIT</u>

O EA

<u>ITEM</u> <u>BID</u> <u>ITEM</u> <u>DESCRIPTION</u>

1. 430.50136 INSTALL 36-INCH BOX TREE

2. 430.50205 INSTALL 5-GALLON SHRUB

3. 430.53110 INSTALL 2" DEPTH GRAVEL


Stantec Chandler, Arizona 85226
Tel. 480.687.6100
www.stantec.com

LANDSCAPING	PLAN	4	
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DESIGNED BY CB		CIP PROJ NO. A1405		
DRAWN BY	CB	CIP PROJ NO. A	J. A1405	
DRAWING NO		). PL004	SHEET 119 OF 133	

SHEET KEYMAP

1 2 3 4 5 6 7 8 9 10 11 12 13 14 PL001 PL002 PL003 PL004 PL005 PL006 PL007 PL008 PL009 PL010 PL011 PL012 PL013 PL014

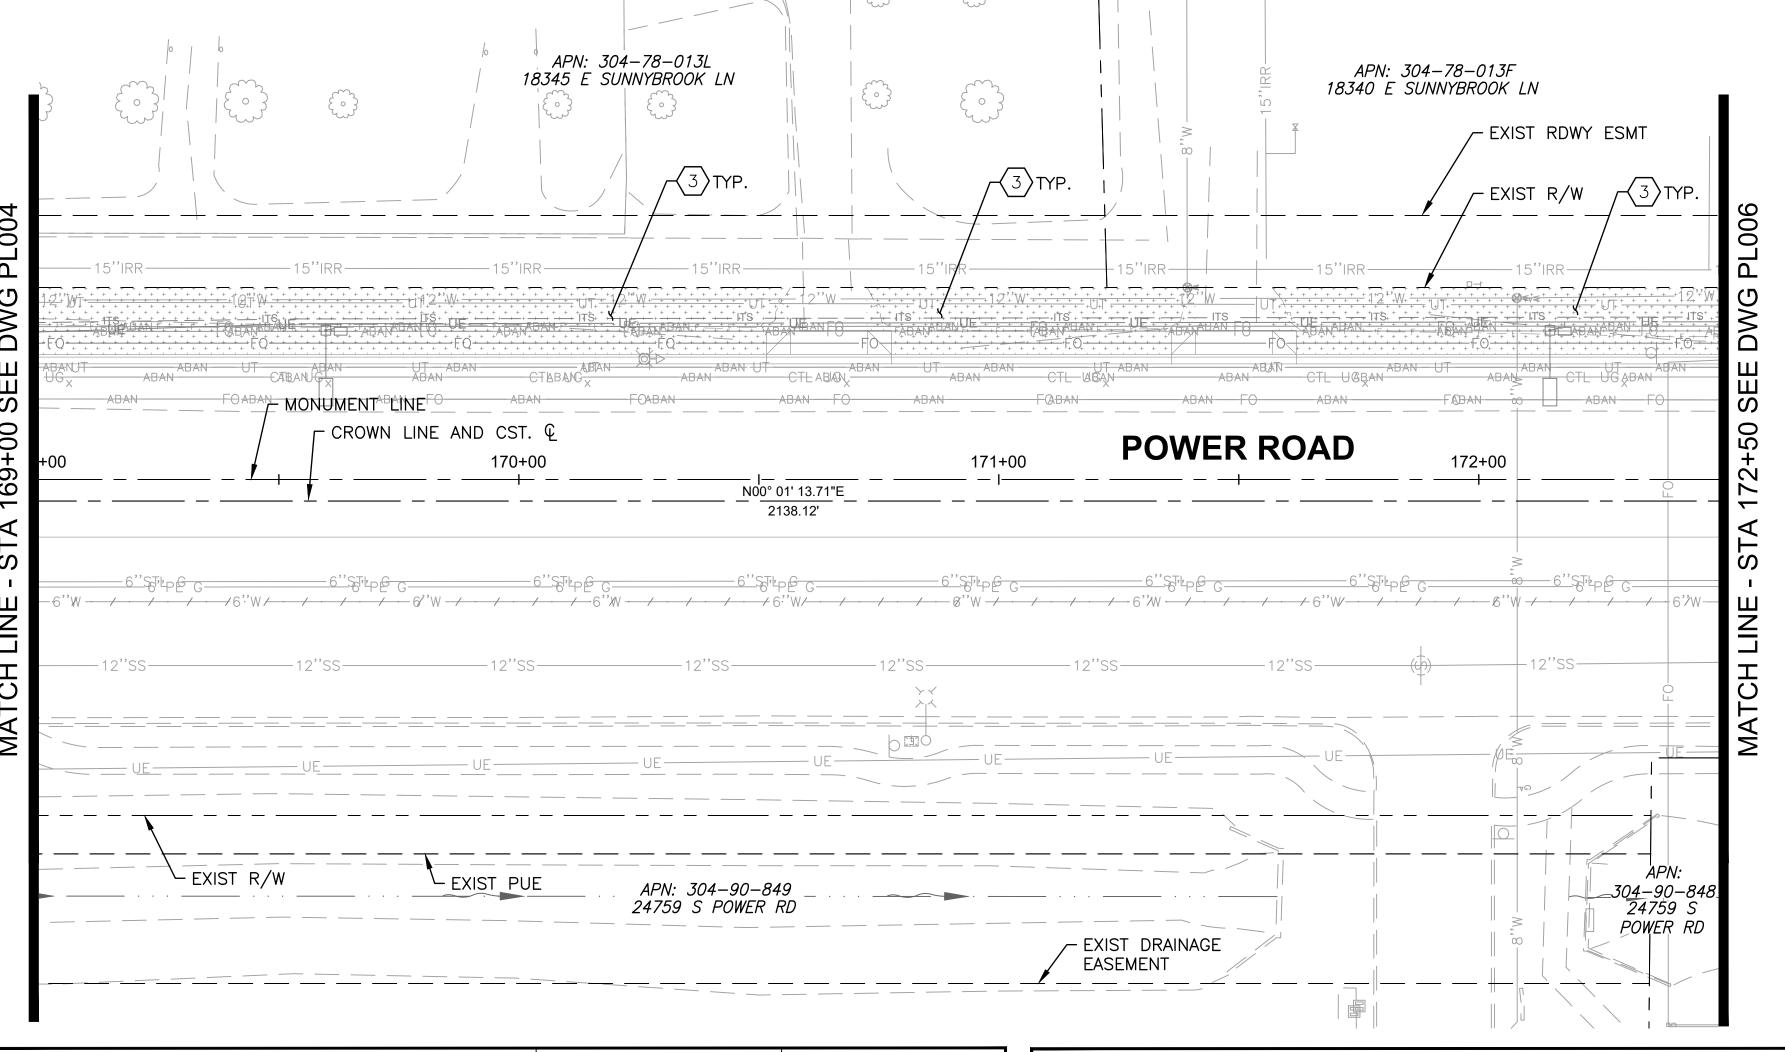

SHEET	SHEET PLANT SCHEDULE							
SHRUB	IS		NO PRUNING!!	PLANT SETBACK:				
SYMBOL QUANTITY BOTANICAL NAME/COMMON NAME OTHER PLANTS FROM INSIDE		MINIMUM PLANT CENTER FROM INSIDE EDGE OF CURB OR PAVEMENT						
В	0	EREMOPHILA HYGROPHANA 'BLUE BELLS BLUE BELLS EREMOPHILA	PLANT MIN. 5' APART	2'-6"				
0	0	ERICAMERIA LARICIFOLIA 'DESERT MOUNTAIN' TURPENTINE BUSH 'DESERT MOUNTAIN'	PLANT MIN. 4' APART	2'-0"				
$\oplus$	0	LEUCOPHYLLUM LANGMANIAE 'LYNN'S LEGACY TEXAS RANGER LYNN'S LEGACY	PLANT MIN 6' APART	3'-0"				
G	0	TEUCRIUM CHAMAERDYS GERMANDER	PLANT MIN. 3' APART	1'-6"				
GROUN	GROUNDCOVERS							
$\varnothing$	0	EREMOPHILA GLABRA 'MINGNEW GOLD' OUTBACK SUNRISE EMU	PLANT MIN 6' APART	3'-0"				
<b>(</b>	0	LANTANA X 'NEW GOLD' NEW GOLD LANTANA	PLANT MIN 5' APART	2'-0"				
SUCCU	LENTS							
•	0	HESPERALOE PARVIFLORA 'DESERT FLAMENCO' HYBRID YUCCA 'DESERT FLAMINCO'	PLANT MIN 4' APART	2'-0"				

			<u> </u>	
SHEET PLA	NT SCH	HEDULE		
TREES				
SYMBOL	QUANTITY	BOTANICAL NAME/COMMON NAME	SIZE	SPACING
<b>+</b>	0	PISTACIA X HYBRID 'RED PUSH' RED PUSH PISTACHE	36" BOX	30'-0"
	0	ULMUS PARVIFLORA 'TRUE GREEN' TRUE GREEN ELM	36" BOX	30'-0"

LANDSCAPE ROCK					
KEY:	<u>DESCRIPTION</u>				
+ + + + + + + + + + + + + + + + + + +	GRAVEL MULCH GROUNDCOVER: 1/2" SCREENED, 2" DEPTH PER DETAIL 2,3 SHEET PL501—SEE CIVIL PLANS FOR QUANTITIES				

HORZ. SCALE: 1"=20'

LANDSCAPE CONSTRUCTION NOTES (TYP) QUANTITY

PER DETAIL 1, SHEET PL501.

PER DETAIL 2, SHEET PL501.

MULCH IN ALL LANDSCAPE PLANTER AREAS PER DETAIL 3,4 SHEET PL501-SEE CIVIL

PLAN FOR QUANTITIES.

<u>ITEM</u> <u>BID</u> <u>ITEM</u> <u>DESCRIPTION</u>

1. 430.50136 INSTALL 36-INCH BOX TREE

2. 430.50205 INSTALL 5-GALLON SHRUB

3. 430.53110 INSTALL 2" DEPTH GRAVEL


QTY UNIT

O EA





TOWN OF QUEEN CREEK

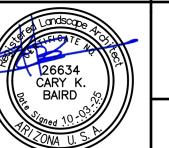

POWER ROAD: RIGGS ROAD TO CHANDLER HEIGHTS ROAD ROADWAY AND DRAINAGE IMPROVEMENTS

Stantec


Chandler, Arizona 85226 Tel. 480.687.6100 www.stantec.com

LANDSCAPING PLAN 5

DESIGNED BY	CB	CIP PROJ NO. A1	1405
DRAWN BY	CB	CIP PROJ NO. A	1405
DRAWII	NG NC	PL005	SHEET 120 OF 1

SHEET KEYMAP

RL002 PL003 PL004 PL005 PL006 PL007 PL008 PL009 PL010 PL011 PL012 PL013 PL014

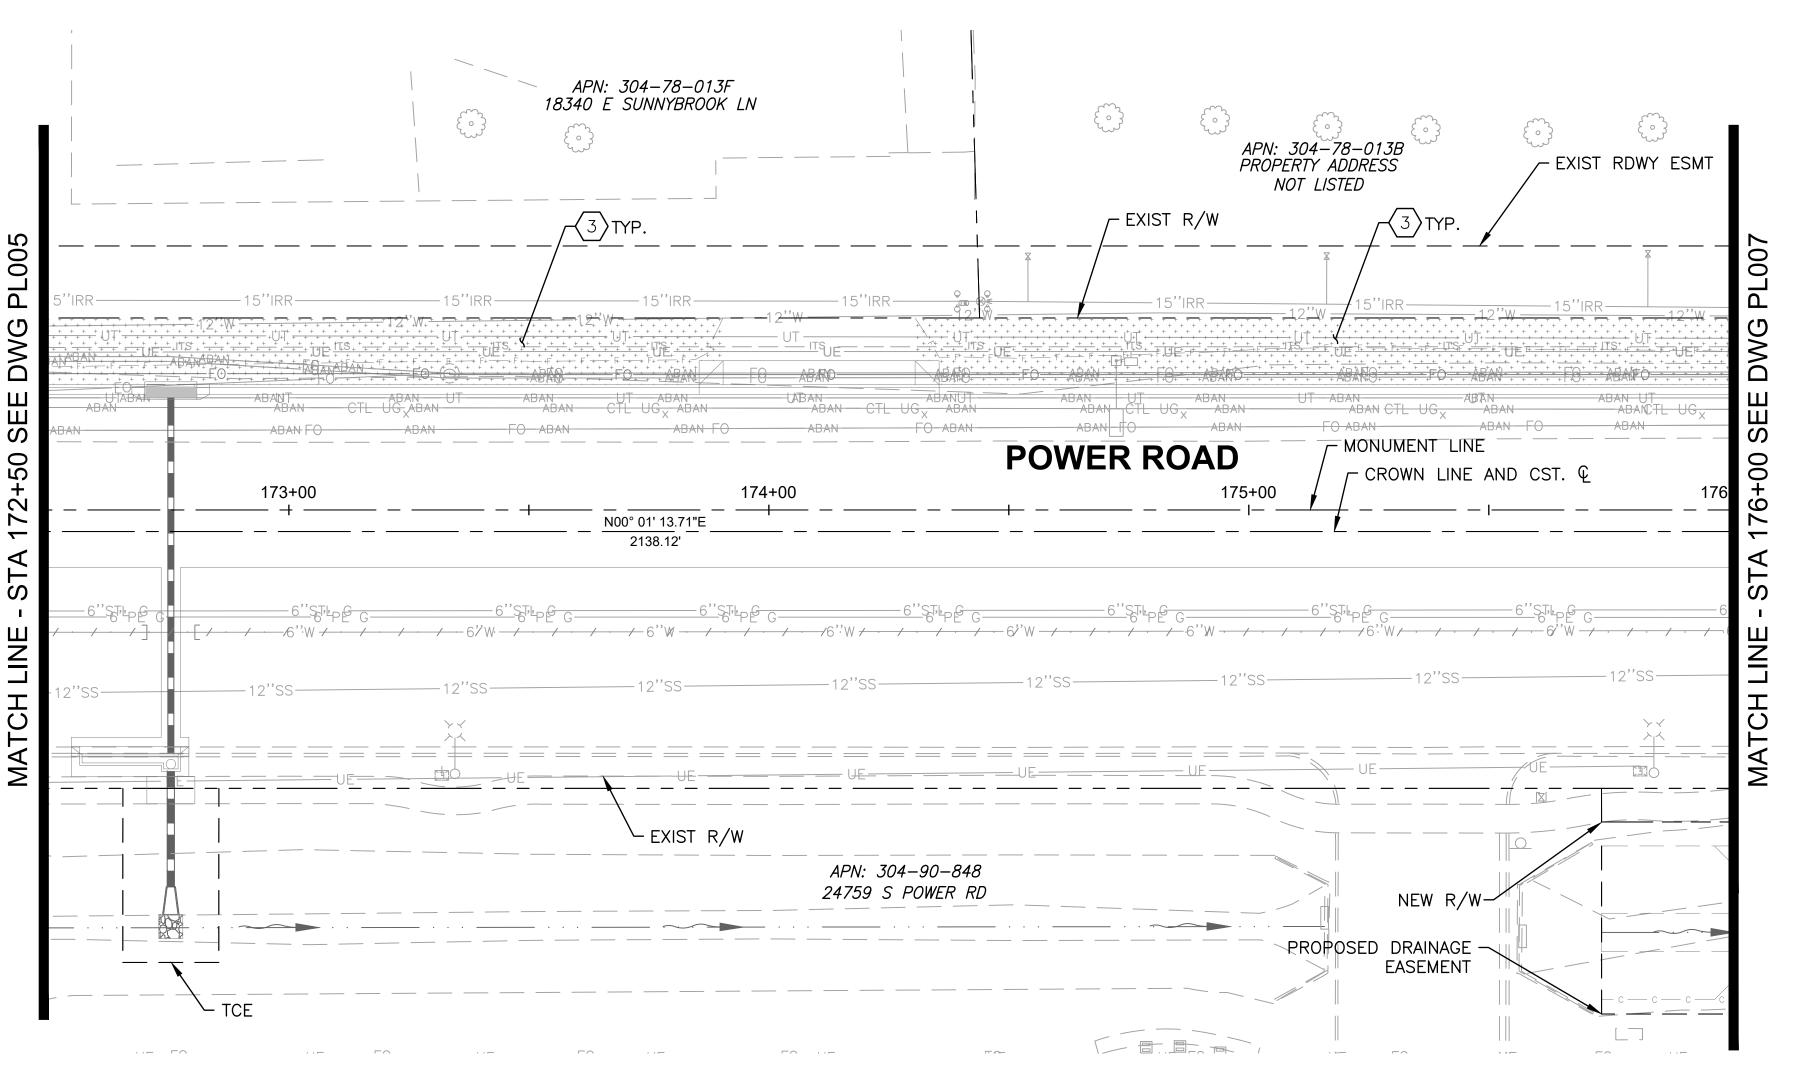

SHEET	SHEET PLANT SCHEDULE							
SHRUB	S		NO PRUNING!!	PLANT SETBACK:				
SYMBOL	QUANTITY	BOTANICAL NAME/COMMON NAME	MINIMUM SPACING FROM OTHER PLANTS	MINIMUM PLANT CENTER FROM INSIDE EDGE OF CURB OR PAVEMENT				
B	0	EREMOPHILA HYGROPHANA 'BLUE BELLS BLUE BELLS EREMOPHILA	PLANT MIN. 5' APART	2'-6"				
0	0	ERICAMERIA LARICIFOLIA 'DESERT MOUNTAIN' TURPENTINE BUSH 'DESERT MOUNTAIN'	PLANT MIN. 4' APART	2'-0"				
$\oplus$	0	LEUCOPHYLLUM LANGMANIAE 'LYNN'S LEGACY TEXAS RANGER LYNN'S LEGACY	PLANT MIN 6' APART	3'-0"				
G	0	TEUCRIUM CHAMAERDYS GERMANDER	PLANT MIN. 3' APART	1'-6"				
GROUN	DCOVE	RS						
$\varnothing$	0	EREMOPHILA GLABRA 'MINGNEW GOLD' OUTBACK SUNRISE EMU	PLANT MIN 6' APART	3'-0"				
<del>( )</del>	0	LANTANA X 'NEW GOLD' NEW GOLD LANTANA	PLANT MIN 5' APART	2'-0"				
SUCCU	LENTS							
•	0	HESPERALOE PARVIFLORA 'DESERT FLAMENCO' HYBRID YUCCA 'DESERT FLAMINCO'	PLANT MIN 4' APART	2'-0"				

SHEET PLA	NT SCH	HEDULE		
TREES				
SYMBOL	QUANTITY	BOTANICAL NAME/COMMON NAME	SIZE	SPACING
<b>\$</b>	0	PISTACIA X HYBRID 'RED PUSH' RED PUSH PISTACHE	36" BOX	30'-0"
	0	ULMUS PARVIFLORA 'TRUE GREEN' TRUE GREEN ELM	36" BOX	30'-0"

LANDSCAPE ROCK				
<u>KEY:</u>	<u>DESCRIPTION</u>			
+ + + + + + + + + + + + + + + + + + +	GRAVEL MULCH GROUNDCOVER: 1/2" SCREENED, 2" DEPTH PER DETAIL 2,3 SHEET PL501—SEE CIVIL PLANS FOR QUANTITIES			


LANDSCAPE CONSTRUCTION NOTES (TYP) QUANTITY

ITEM BID ITEM DESCRIPTION QTY UNIT

1. 430.50136 INSTALL 36—INCH BOX TREE PER DETAIL 1, SHEET PL501.

2. 430.50205 INSTALL 5—GALLON SHRUB PER DETAIL 2, SHEET PL501.

3. 430.53110 INSTALL 2" DEPTH GRAVEL MULCH IN ALL LANDSCAPE PLANTER AREAS PER DETAIL 3,4 SHEET PL501—SEE CIVIL PLAN FOR QUANTITIES.

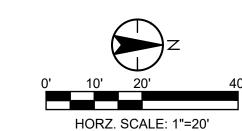

ROAD

ROAD TO CHANDLER HEIGHTS





TOWN OF QUEEN CREEK



POWER ROAD:
RIGGS ROAD TO CHANDLER HEIGHTS ROAD
ROADWAY AND DRAINAGE IMPROVEMENTS

**Stantec** 

tec

3133 West Frye Road
Chandler, Arizona 85226
Tel. 480.687.6100
www.stantec.com

LANDSCAPING PLAN 6

DESIGNED BY CB
DRAWN BY CB


CIP PROJ NO. A1405

DRAWING NO. PLOO6

SHEET 121 OF 133

SHEET KEYMAP


1 2 3 4 5 6 7 8 9 10 11 12 13 14 PL001 PL002 PL003 PL004 PL005 PL006 PL007 PL008 PL009 PL010 PL011 PL012 PL013 PL014

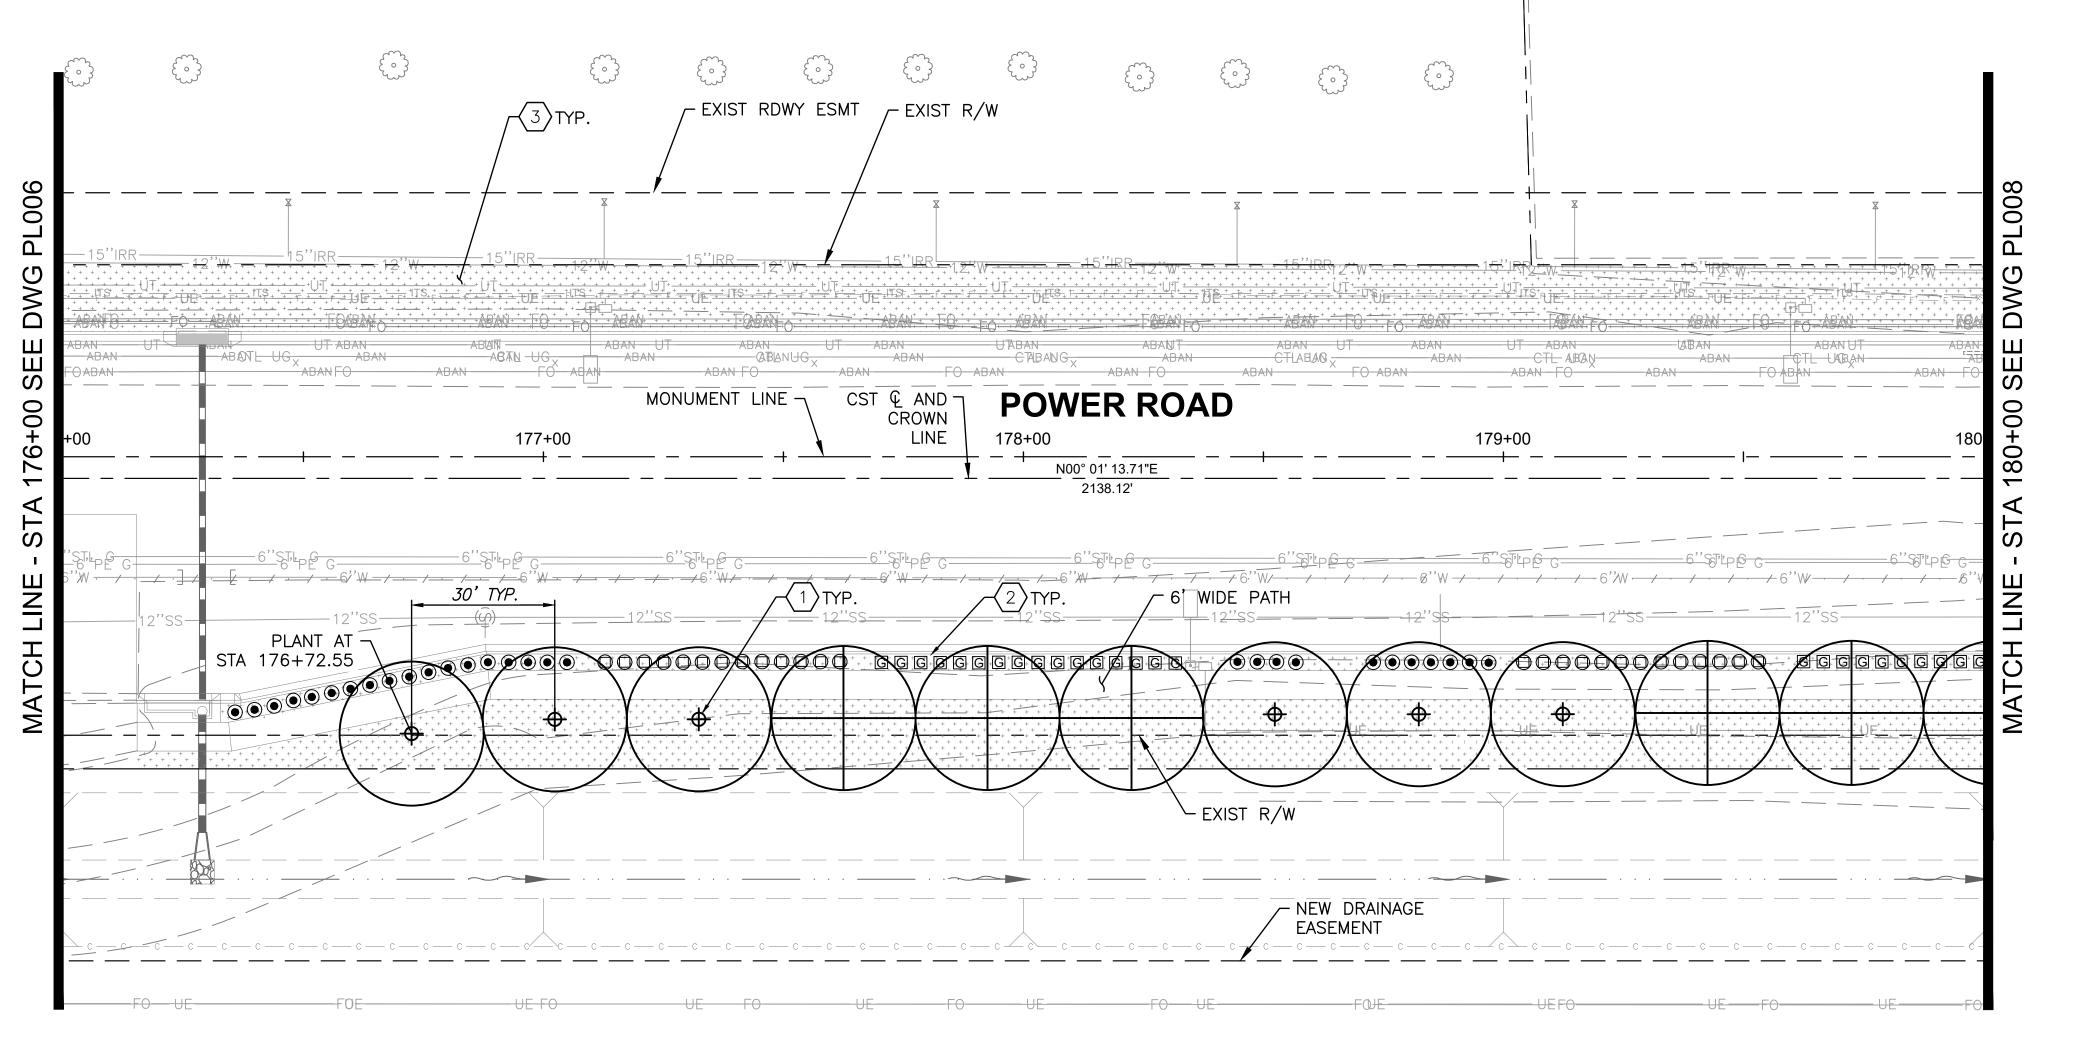

SHEET	PLANT	SCHEDULE		
SHRUE	BS		NO PRUNING!!	PLANT SETBACK: MINIMUM PLANT CENTER
SYMBOL	QUANTITY	BOTANICAL NAME/COMMON NAME	- MINIMUM SPACING FROM OTHER PLANTS	FROM INSIDE EDGE OF CURB OR PAVEMENT
В	0	EREMOPHILA HYGROPHANA 'BLUE BELLS BLUE BELLS EREMOPHILA	PLANT MIN. 5' APART	2'-6"
0	26	ERICAMERIA LARICIFOLIA 'DESERT MOUNTAIN' TURPENTINE BUSH 'DESERT MOUNTAIN'	PLANT MIN. 4' APART	2'-0"
$\oplus$	0	LEUCOPHYLLUM LANGMANIAE 'LYNN'S LEGACY TEXAS RANGER LYNN'S LEGACY	PLANT MIN 6' APART	3'-0"
G	TEUCRIUM CHAMAERDYS 26 GERMANDER		PLANT MIN. 3' APART	1'-6"
GROUN	IDCOVE	RS		
Ø	0	EREMOPHILA GLABRA 'MINGNEW GOLD' OUTBACK SUNRISE EMU	PLANT MIN 6' APART	3'-0"
$\oplus$	0	LANTANA X 'NEW GOLD' NEW GOLD LANTANA	PLANT MIN 5' APART	2'-0"
SUCCU	LENTS			
•	33	HESPERALOE PARVIFLORA 'DESERT FLAMENCO' HYBRID YUCCA 'DESERT FLAMINCO'	PLANT MIN 4' APART	2'-0"

SHEET PLANT SCHEDULE				
TREES				
SYMBOL	QUANTITY	BOTANICAL NAME/COMMON NAME	SIZE	SPACING
<b>+</b>	6	PISTACIA X HYBRID 'RED PUSH' RED PUSH PISTACHE	36" BOX	30'-0"
	5	ULMUS PARVIFLORA 'TRUE GREEN' TRUE GREEN ELM	36" BOX	30'-0"

LANDSCAPE ROCK				
<u>KEY:</u>	<u>DESCRIPTION</u>			
	GRAVEL MULCH GROUNDCOVER: 1/2" SCREENED, 2" DEPTH PER DETAIL 2,3 SHEET PL501—SEE CIVIL PLANS FOR QUANTITIES			

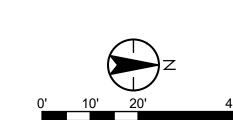

HORZ. SCALE: 1"=20'





TOWN OF QUEEN CREEK



POWER ROAD:
RIGGS ROAD TO CHANDLER HEIGHTS ROAD
ROADWAY AND DRAINAGE IMPROVEMENTS

**Stantec** 

LANDSCAPE CONSTRUCTION NOTES (TYP) QUANTITY

PER DETAIL 1, SHEET PL501.

PER DETAIL 2, SHEET PL501.

MULCH IN ALL LANDSCAPE PLANTER AREAS PER DETAIL 3,4 SHEET PL501—SEE CIVIL

PLAN FOR QUANTITIES.

ITEM BID ITEM DESCRIPTION

1. 430.50136 INSTALL 36-INCH BOX TREE

2. 430.50205 INSTALL 5-GALLON SHRUB

3. 430.53110 INSTALL 2" DEPTH GRAVEL

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LANDSCAPE PLAN 7

DESIGNED BY CB
DRAWN BY CB

CIP PROJ NO. A1405


DRAWING NO. PLOO7

SHEET 122 OF 133

SHEET KEYMAP

1 2 3 4 5 6 7 8 9 10 11 12 13 14 PL001 PL002 PL003 PL004 PL005 PL006 PL007 PL008 PL009 PL010 PL011 PL012 PL013 PL014


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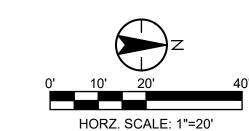


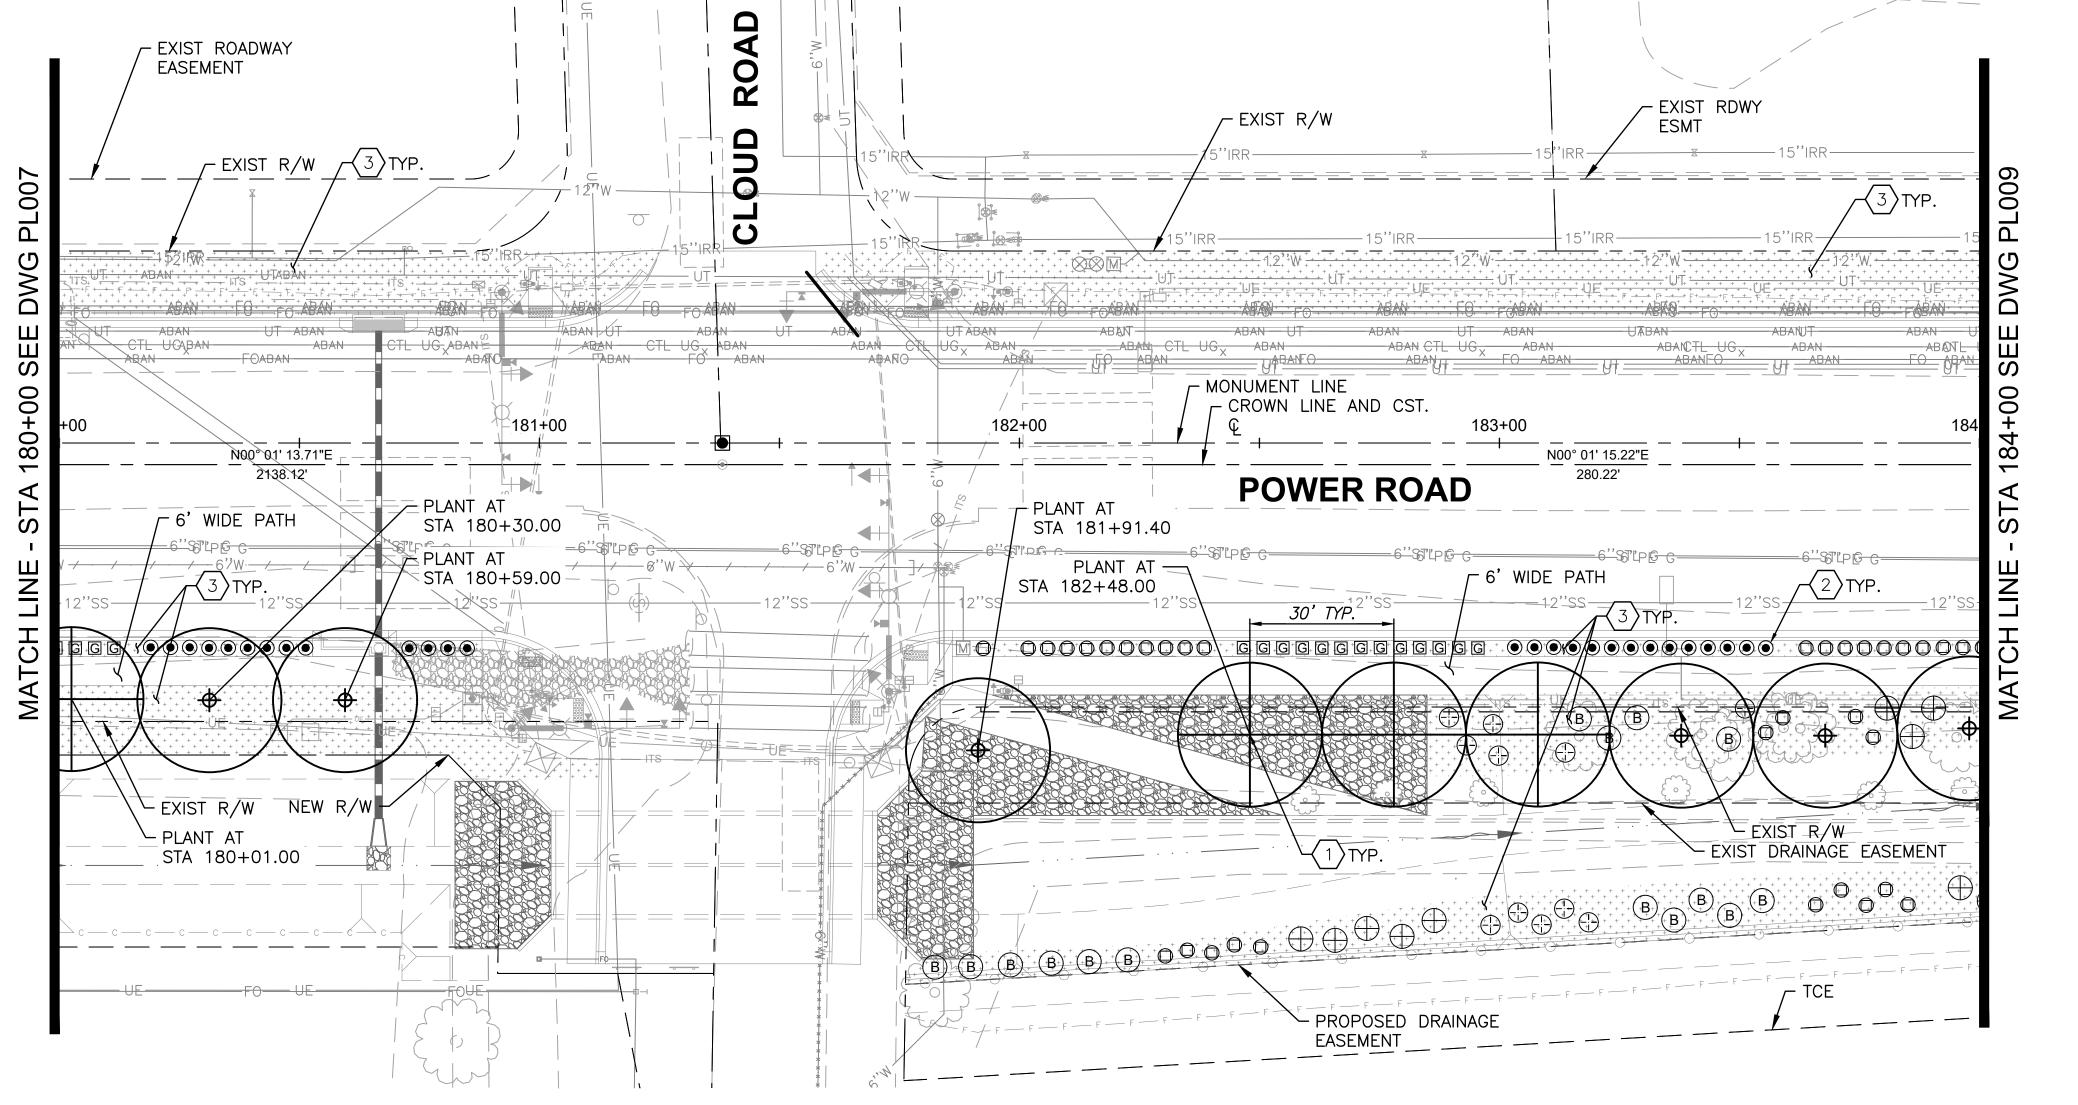SHEET	PLANT	SCHEDULE		
SHRUB	S		NO PRUNING!!	PLANT SETBACK:
SYMBOL QUANTITY BOTANICAL NAME/COMMON NAME			MINIMUM SPACING FROM OTHER PLANTS	MINIMUM PLANT CENTER FROM INSIDE EDGE OF CURB OR PAVEMENT
B	15	EREMOPHILA HYGROPHANA 'BLUE BELLS BLUE BELLS EREMOPHILA	PLANT MIN. 5' APART	2'-6"
0	34	ERICAMERIA LARICIFOLIA 'DESERT MOUNTAIN' TURPENTINE BUSH 'DESERT MOUNTAIN'	PLANT MIN. 4' APART	2'-0"
$\oplus$	9	LEUCOPHYLLUM LANGMANIAE 'LYNN'S LEGACY TEXAS RANGER LYNN'S LEGACY	PLANT MIN 6' APART	3'-0"
G TEUCRIUM CHAMAERDYS GERMANDER		PLANT MIN. 3' APART	1'-6"	
GROUN	DCOVE	RS		
Ø	0	EREMOPHILA GLABRA 'MINGNEW GOLD' OUTBACK SUNRISE EMU	PLANT MIN 6' APART	3'-0"
<b>(+)</b>	11	LANTANA X 'NEW GOLD' NEW GOLD LANTANA	PLANT MIN 5' APART	2'-0"
SUCCU	LENTS			
•	23	HESPERALOE PARVIFLORA 'DESERT FLAMENCO' HYBRID YUCCA 'DESERT FLAMINCO'	PLANT MIN 4' APART	2'-0"

SHEET PLA	NT SCH	HEDULE		
TREES				
SYMBOL	QUANTITY	BOTANICAL NAME/COMMON NAME	SIZE	SPACING
<b>+</b>	6	PISTACIA X HYBRID 'RED PUSH' RED PUSH PISTACHE	36" BOX	30'-0"
	4	ULMUS PARVIFLORA 'TRUE GREEN' TRUE GREEN ELM	36" BOX	30'-0"

LANDSCAPE ROCK	
<u>KEY:</u>	DESCRIPTION
+ + + + + + + + + + + + + + + + + + +	GRAVEL MULCH GROUNDCOVER: 1/2" SCREENED, 2" DEPTH PER DETAIL 2,3 SHEET PL501—SEE CIVIL PLANS FOR QUANTITIES



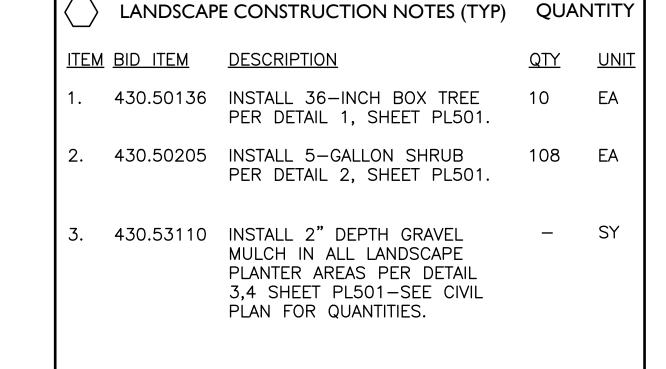

ROAD





TOWN OF QUEEN CREEK



POWER ROAD: RIGGS ROAD TO CHANDLER HEIGHTS ROAD ROADWAY AND DRAINAGE IMPROVEMENTS

Stantec


Chandler, Arizona 85226 Tel. 480.687.6100

LANDSCAPE PLAN 8

DESIGNED BY CB CIP PROJ NO. A1405 DRAWN BY SHEET 123 OF 133 PL008 DRAWING NO.

SHEET KEYMAP

PL001 PL002 PL003 PL004 PL005 PL006 PL007 PL008 PL009 PL010 PL011 PL012 PL013 PL014

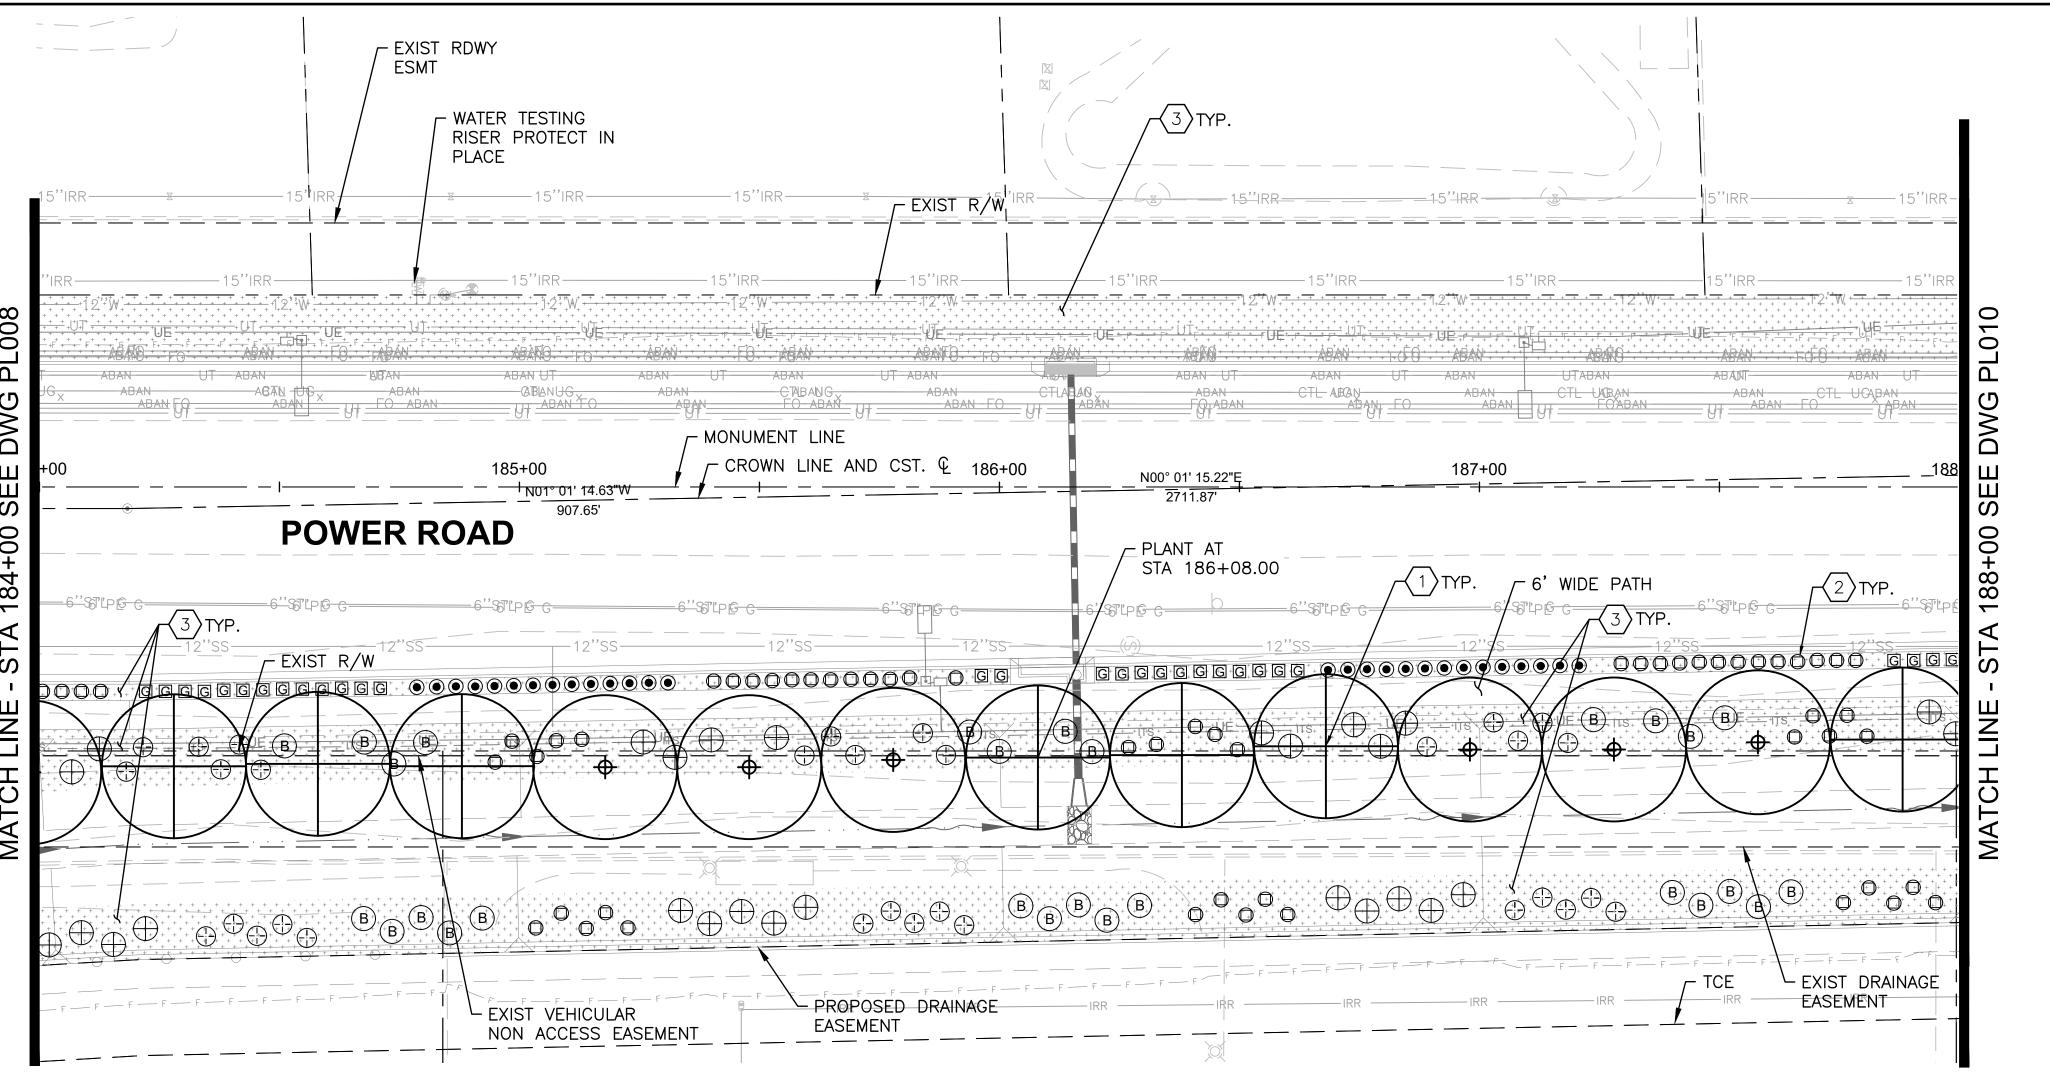

SHEET	PLANT	SCHEDULE		
SHRUB	S		NO PRUNING!!	PLANT SETBACK:
SYMBOL QUANTITY BOTANICAL NAME/COMMON NAME			MINIMUM SPACING FROM OTHER PLANTS	MINIMUM PLANT CENTER FROM INSIDE EDGE OF CURB OR PAVEMENT
В	27	EREMOPHILA HYGROPHANA 'BLUE BELLS BLUE BELLS EREMOPHILA	PLANT MIN. 5' APART	2'-6"
0	59	ERICAMERIA LARICIFOLIA 'DESERT MOUNTAIN' TURPENTINE BUSH 'DESERT MOUNTAIN'	PLANT MIN. 4' APART	2'-0"
$\oplus$	27	LEUCOPHYLLUM LANGMANIAE 'LYNN'S LEGACY TEXAS RANGER LYNN'S LEGACY	PLANT MIN 6' APART	3'-0"
G	30	TEUCRIUM CHAMAERDYS GERMANDER	PLANT MIN. 3' APART	1'-6"
GROUN	DCOVE	RS		
Ø	0	EREMOPHILA GLABRA 'MINGNEW GOLD' OUTBACK SUNRISE EMU	PLANT MIN 6' APART	3'-0"
$\oplus$	31	LANTANA X 'NEW GOLD' NEW GOLD LANTANA	PLANT MIN 5' APART	2'-0"
SUCCU	LENTS			
•	28	HESPERALOE PARVIFLORA 'DESERT FLAMENCO' HYBRID YUCCA 'DESERT FLAMINCO'	PLANT MIN 4' APART	2'-0"

SHEET PLA	NT SCH	HEDULE		
TREES				
SYMBOL	QUANTITY	BOTANICAL NAME/COMMON NAME	SIZE	SPACING
<b>+</b>	6	PISTACIA X HYBRID 'RED PUSH' RED PUSH PISTACHE	36" BOX	30'-0"
	7	ULMUS PARVIFLORA 'TRUE GREEN' TRUE GREEN ELM	36" BOX	30'-0"

LANDSCAPE ROCK				
<u>KEY:</u>	<u>DESCRIPTION</u>			
+ + + + + + + + + + + + + + + + + + +	GRAVEL MULCH GROUNDCOVER: 1/2" SCREENED, 2" DEPTH PER DETAIL 2,3 SHEET PL501—SEE CIVIL PLANS FOR QUANTITIES			

0' 10' 20' 4 HORZ. SCALE: 1"=20'





TOWN OF QUEEN CREEK

Chandler, Arizona 85226 Tel. 480.687.6100



POWER ROAD: RIGGS ROAD TO CHANDLER HEIGHTS ROAD ROADWAY AND DRAINAGE IMPROVEMENTS

**Stantec** 

LANDSCAPE PLAN 9

DESIGNED BY CB
DRAWN BY CB

DRAWING NO. PLOO9

SHEET 124 OF 133

SHEET KEYMAP

1 2	3	4 5	6	7	8	9	12	13	14
PL001 PL002	PL003 1	PL004 PL00	5 PL006	PL007	PL008	PL009	PL010 PL011 PL012	PL013	PL014

LANDSCAPE CONSTRUCTION NOTES (TYP) QUANTITY

PER DETAIL 1, SHEET PL501.

PER DETAIL 2, SHEET PL501.

MULCH IN ALL LANDSCAPE PLANTER AREAS PER DETAIL 3,4 SHEET PL501—SEE CIVIL

PLAN FOR QUANTITIES.

**DESCRIPTION** 

1. 430.50136 INSTALL 36-INCH BOX TREE


2. 430.50205 INSTALL 5-GALLON SHRUB

3. 430.53110 INSTALL 2" DEPTH GRAVEL

QTY UNIT

202 EA


<u>ITEM</u> <u>BID</u> ITEM

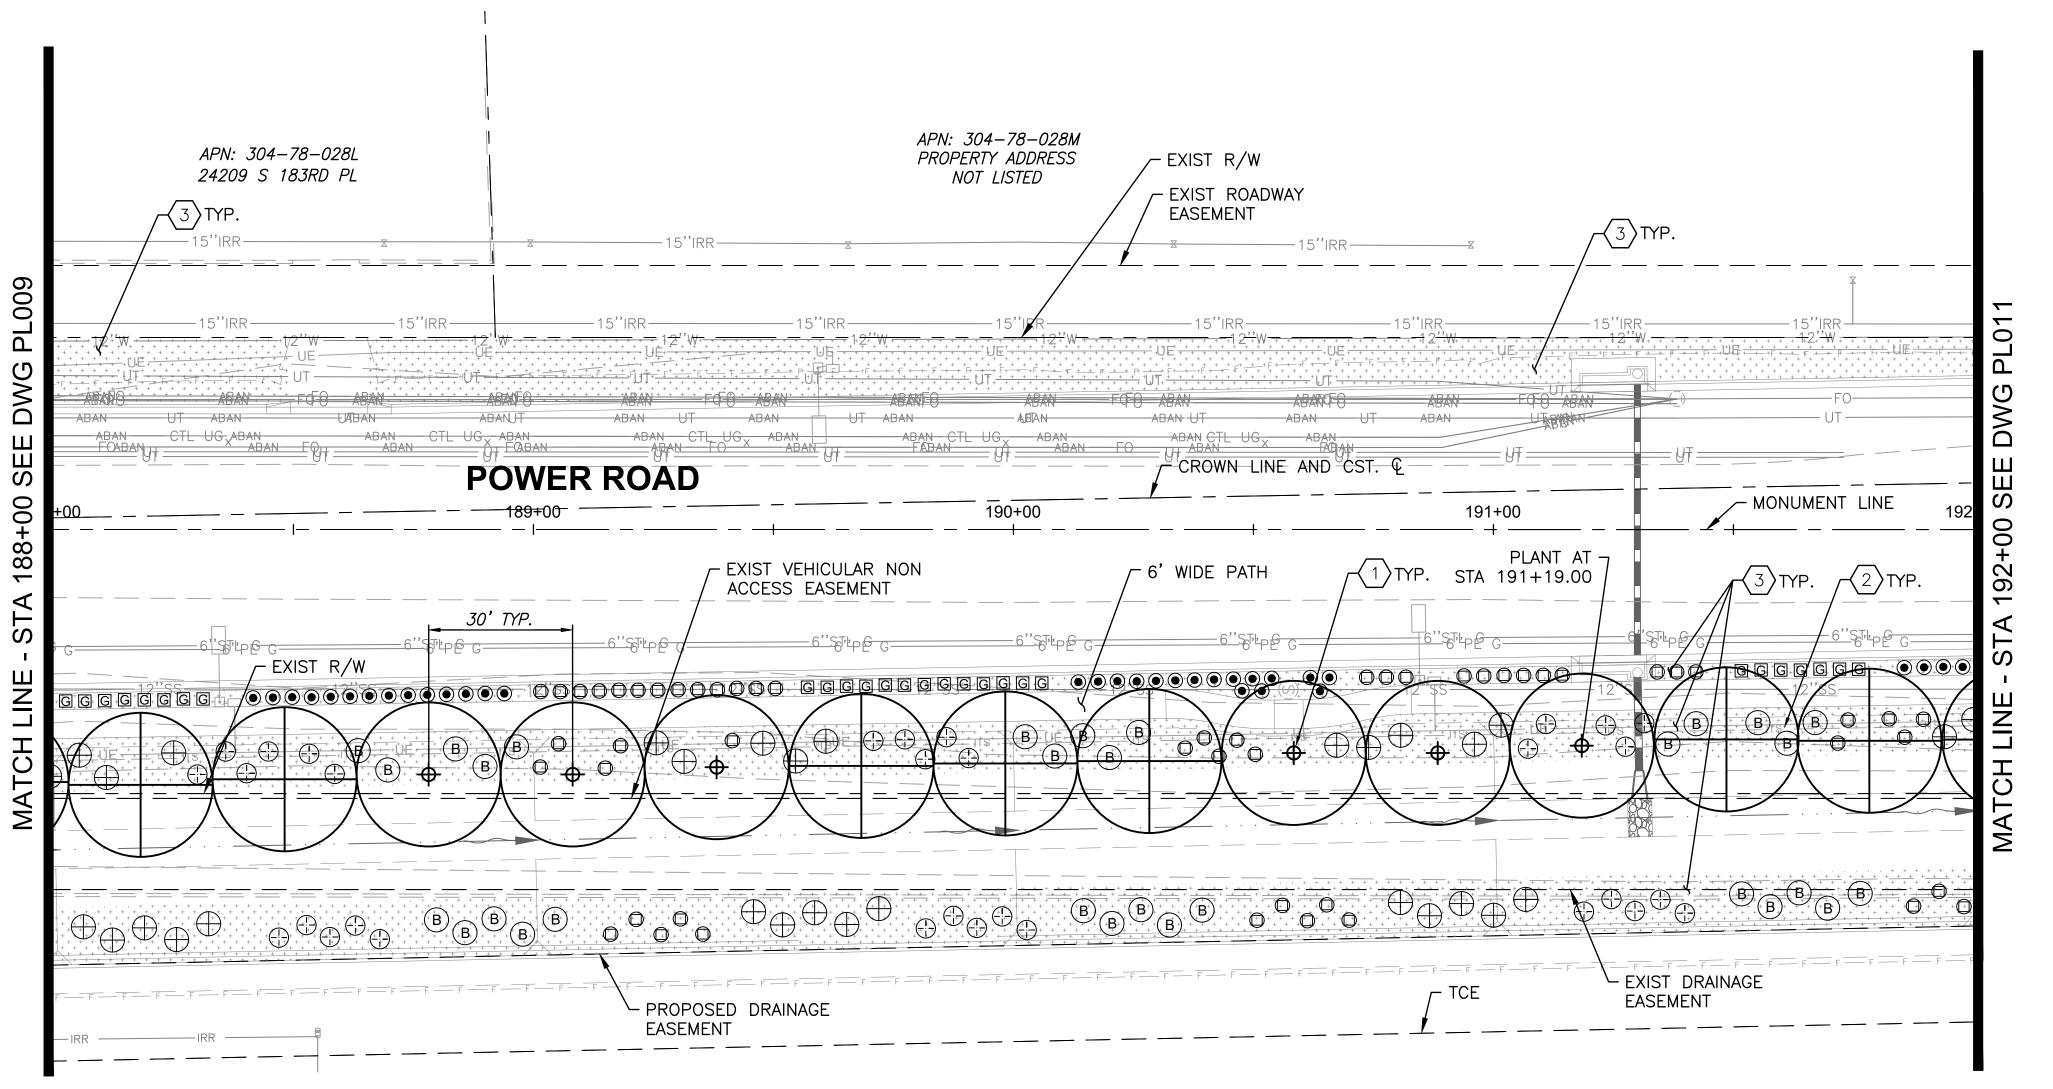

SHEET PLANT SCHEDULE					
SHRUB	S		NO PRUNING!!	PLANT SETBACK:	
SYMBOL	QUANTITY	BOTANICAL NAME/COMMON NAME	MINIMUM SPACING FROM OTHER PLANTS	MINIMUM PLANT CENTER FROM INSIDE EDGE OF CURB OR PAVEMENT	
В	30	EREMOPHILA HYGROPHANA 'BLUE BELLS BLUE BELLS EREMOPHILA	PLANT MIN. 5' APART	2'-6"	
	53	ERICAMERIA LARICIFOLIA 'DESERT MOUNTAIN' TURPENTINE BUSH 'DESERT MOUNTAIN'	PLANT MIN. 4' APART	2'-0"	
$\oplus$	29	LEUCOPHYLLUM LANGMANIAE 'LYNN'S LEGACY TEXAS RANGER LYNN'S LEGACY	PLANT MIN 6' APART	3'-0"	
G	TEUCRIUM CHAMAERDYS GERMANDER		PLANT MIN. 3' APART	1'-6"	
GROUN	DCOVE	RS			
$\varnothing$	0	EREMOPHILA GLABRA 'MINGNEW GOLD' OUTBACK SUNRISE EMU	PLANT MIN 6' APART	3'-0"	
	31	LANTANA X 'NEW GOLD' NEW GOLD LANTANA	PLANT MIN 5' APART	2'-0"	
SUCCU	SUCCULENTS				
•	34	HESPERALOE PARVIFLORA 'DESERT FLAMENCO' HYBRID YUCCA 'DESERT FLAMINCO'	PLANT MIN 4' APART	2'-0"	

SHEET PLANT SCHEDULE					
TREES					
SYMBOL	QUANTITY	BOTANICAL NAME/COMMON NAME	SIZE	SPACING	
<b>+</b>	6	PISTACIA X HYBRID 'RED PUSH' RED PUSH PISTACHE	36" BOX	30'-0"	
	7	ULMUS PARVIFLORA 'TRUE GREEN' TRUE GREEN ELM	36" BOX	30'-0"	

LANDSCAPE ROCK				
KEY:	<u>DESCRIPTION</u>			
+ + + + + + + + + + + + + + + + + + +	GRAVEL MULCH GROUNDCOVER: 1/2" SCREENED, 2" DEPTH PER DETAIL 2,3 SHEET PL501—SEE CIVIL PLANS FOR QUANTITIES			

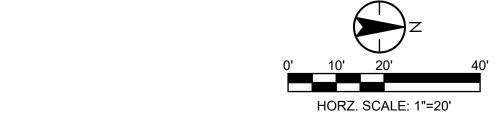

LANDSCAPE CONSTRUCTION NOTES (TYP) QUANTITY

PER DETAIL 1, SHEET PL501.

PER DETAIL 2, SHEET PL501.

MULCH IN ALL LANDSCAPE PLANTER AREAS PER DETAIL 3,4 SHEET PL501-SEE CIVIL

PLAN FOR QUANTITIES.

**DESCRIPTION** 

1. 430.50136 INSTALL 36-INCH BOX TREE

2. 430.50205 INSTALL 5-GALLON SHRUB

3. 430.53110 INSTALL 2" DEPTH GRAVEL

<u>QTY</u> <u>UNIT</u>

205 EA

13

<u>ITEM</u> <u>BID ITEM</u>





TOWN OF QUEEN CREEK



POWER ROAD: RIGGS ROAD TO CHANDLER HEIGHTS ROAD ROADWAY AND DRAINAGE IMPROVEMENTS

Stantec


LANDSCAPE PLAN 10

DESIGNED BY CB CIP PROJ NO. A1405 DRAWN BY SHEET 125 OF 133 PL010 DRAWING NO.

SHEET KEYMAP

11 PL001 PL002 PL003 PL004 PL005 PL006 PL007 PL008 PL009 PL010 PL011 PL012 PL013 PL014 ROAD

Chandler, Arizona 85226 Tel. 480.687.6100

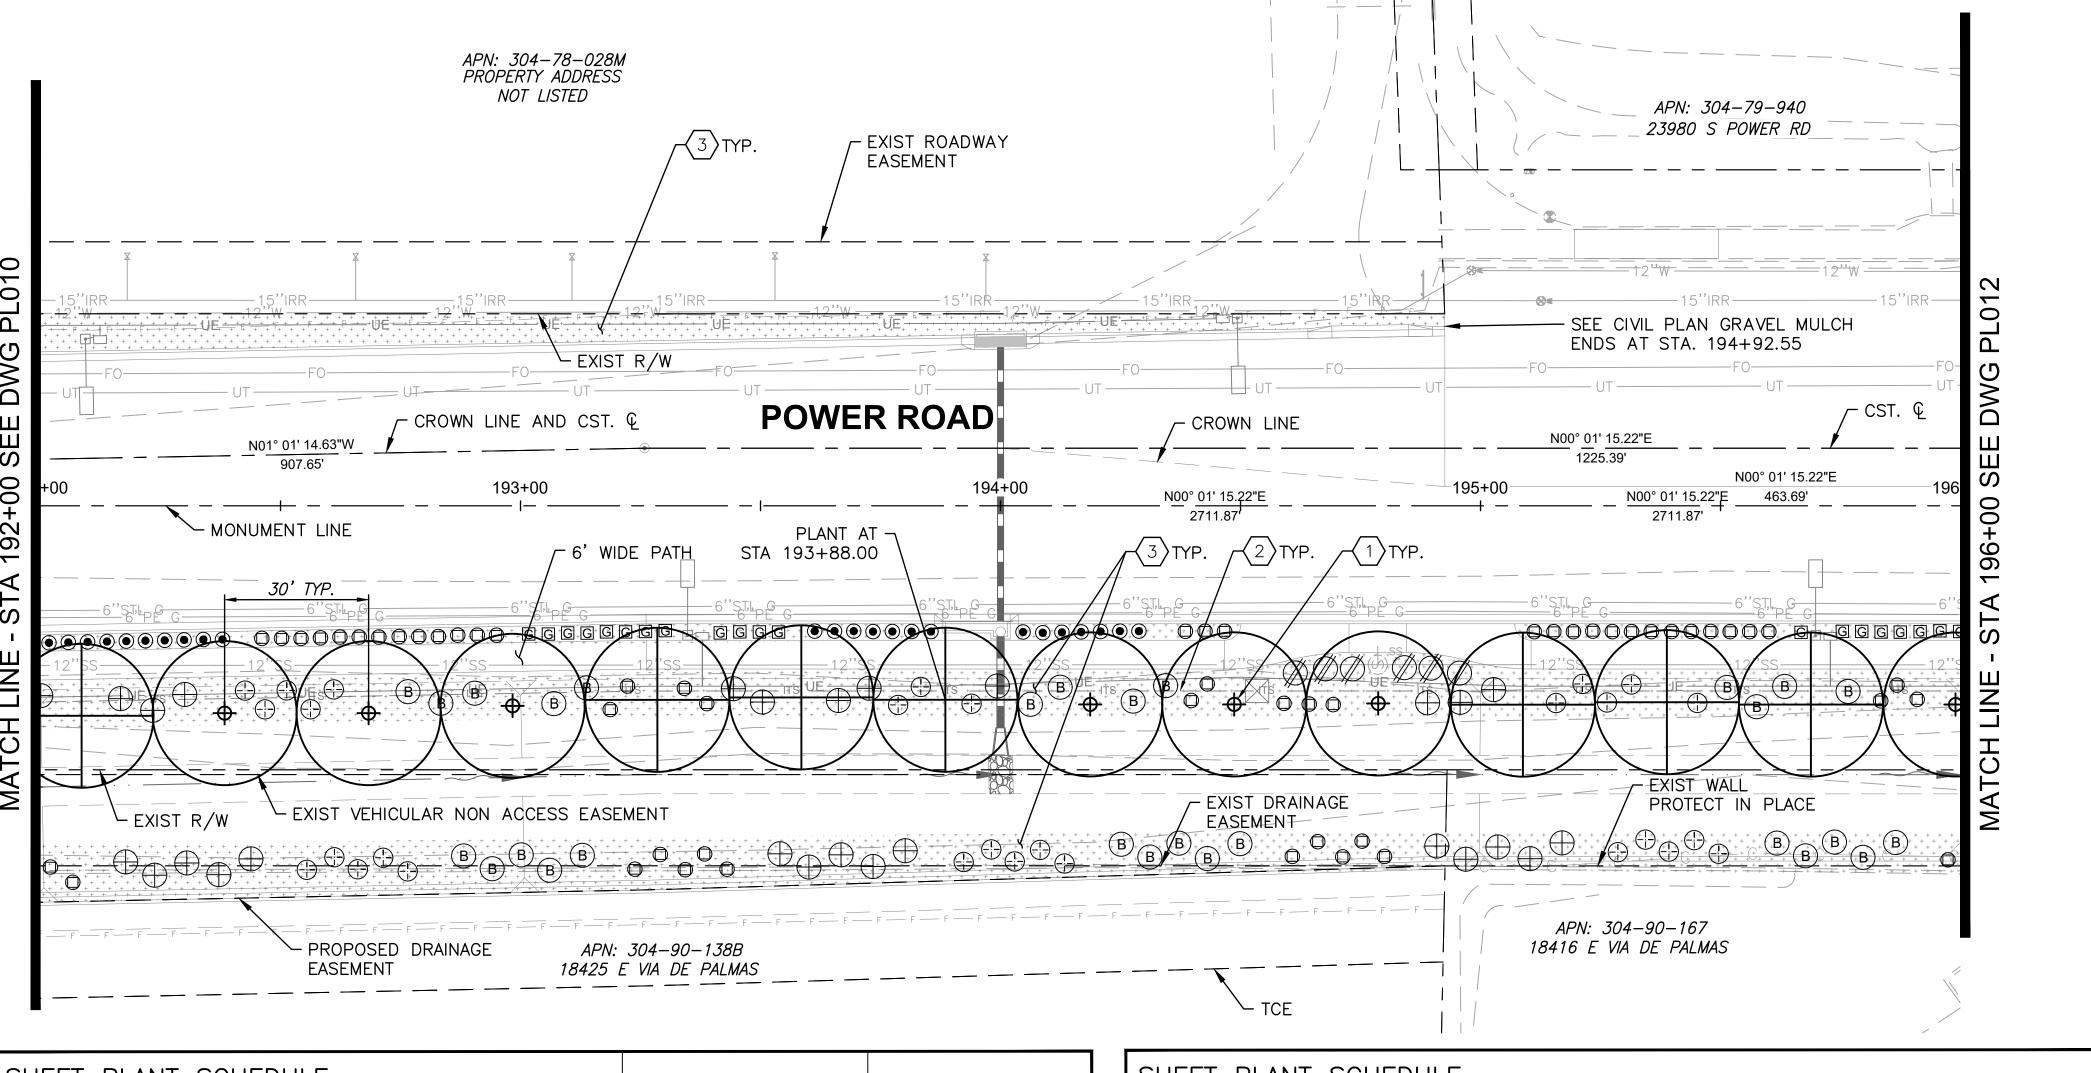

SHEET	PLANT	SCHEDULE		
SHRUB	S		NO PRUNING!!	PLANT SETBACK:
SYMBOL	QUANTITY	BOTANICAL NAME/COMMON NAME	MINIMUM SPACING FROM OTHER PLANTS	MINIMUM PLANT CENTER FROM INSIDE EDGE OF CURB OR PAVEMENT
B	28	EREMOPHILA HYGROPHANA 'BLUE BELLS BLUE BELLS EREMOPHILA	PLANT MIN. 5' APART	2'-6"
0	54	ERICAMERIA LARICIFOLIA 'DESERT MOUNTAIN' TURPENTINE BUSH 'DESERT MOUNTAIN'	PLANT MIN. 4' APART	2'-0"
$\oplus$	27	LEUCOPHYLLUM LANGMANIAE 'LYNN'S LEGACY TEXAS RANGER LYNN'S LEGACY	PLANT MIN 6' APART	3'-0"
G	20	TEUCRIUM CHAMAERDYS GERMANDER	PLANT MIN. 3' APART	1'-6"
GROUN	DCOVE	RS		
Ø	6	EREMOPHILA GLABRA 'MINGNEW GOLD' OUTBACK SUNRISE EMU	PLANT MIN 6' APART	3'-0"
<b>(-)</b>	28	LANTANA X 'NEW GOLD' NEW GOLD LANTANA	PLANT MIN 5' APART	2'-0"
SUCCULENTS				
•	24	HESPERALOE PARVIFLORA 'DESERT FLAMENCO' HYBRID YUCCA 'DESERT FLAMINCO'	PLANT MIN 4' APART	2'-0"


PL001 PL002 PL003 PL004 PL005 PL006 PL007 PL008 PL009 PL010 PL011 PL012 PL013 PL014

		I I		
SHEET PLA	NT SCH	HEDULE		
TREES				
SYMBOL	QUANTITY	BOTANICAL NAME/COMMON NAME	SIZE	SPACING
<b>\$</b>	7	PISTACIA X HYBRID 'RED PUSH' RED PUSH PISTACHE	36" BOX	30'-0"
	7	ULMUS PARVIFLORA 'TRUE GREEN' TRUE GREEN ELM	36" BOX	30'-0"

LANDSCAPE ROCK				
<u>KEY:</u>	<u>DESCRIPTION</u>			
	GRAVEL MULCH GROUNDCOVER:  1/2" SCREENED, 2" DEPTH PER DETAIL  2,3 SHEET PL501—SEE CIVIL PLANS  FOR QUANTITIES			

LISTED ON EACH LANDSCAPE PLAN WHEN ADDED TOGETHER.

NOTE: PLANT MATERIAL TOTAL QUANTITIES FOR PROJECT SHALL TAKE PRECEDENCE OVER QUANTITIES

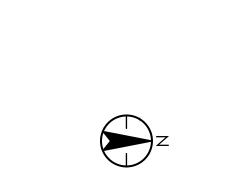

HORZ. SCALE: 1"=20'

ROAD

ROAD TO CHANDLER HEIGHTS





TOWN OF QUEEN CREEK



POWER ROAD: RIGGS ROAD TO CHANDLER HEIGHTS ROAD ROADWAY AND DRAINAGE IMPROVEMENTS

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LANDSCAPE CONSTRUCTION NOTES (TYP) QUANTITY

PER DETAIL 1, SHEET PL501.

PER DETAIL 2, SHEET PL501.

MULCH IN ALL LANDSCAPE PLANTER AREAS PER DETAIL 3,4 SHEET PL501-SEE CIVIL

PLAN FOR QUANTITIES.

**DESCRIPTION** 

1. 430.50136 INSTALL 36-INCH BOX TREE

2. 430.50205 INSTALL 5-GALLON SHRUB

3. 430.53110 INSTALL 2" DEPTH GRAVEL

<u>QTY</u> <u>UNIT</u>

14 EA


187 EA

<u>ITEM</u> <u>BID ITEM</u>

Chandler, Arizona 85226 Tel. 480.687.6100 www.stantec.com LANDSCAPE PLAN 11

DESIGNED BY	CB	CID DDO I NO A1	1405		
DRAWN BY	CB	CIP PROJ NO. A1405			
DRAWII	NG NO	PL011	SHEET 126 OF 1		

SHEET KEYMAP

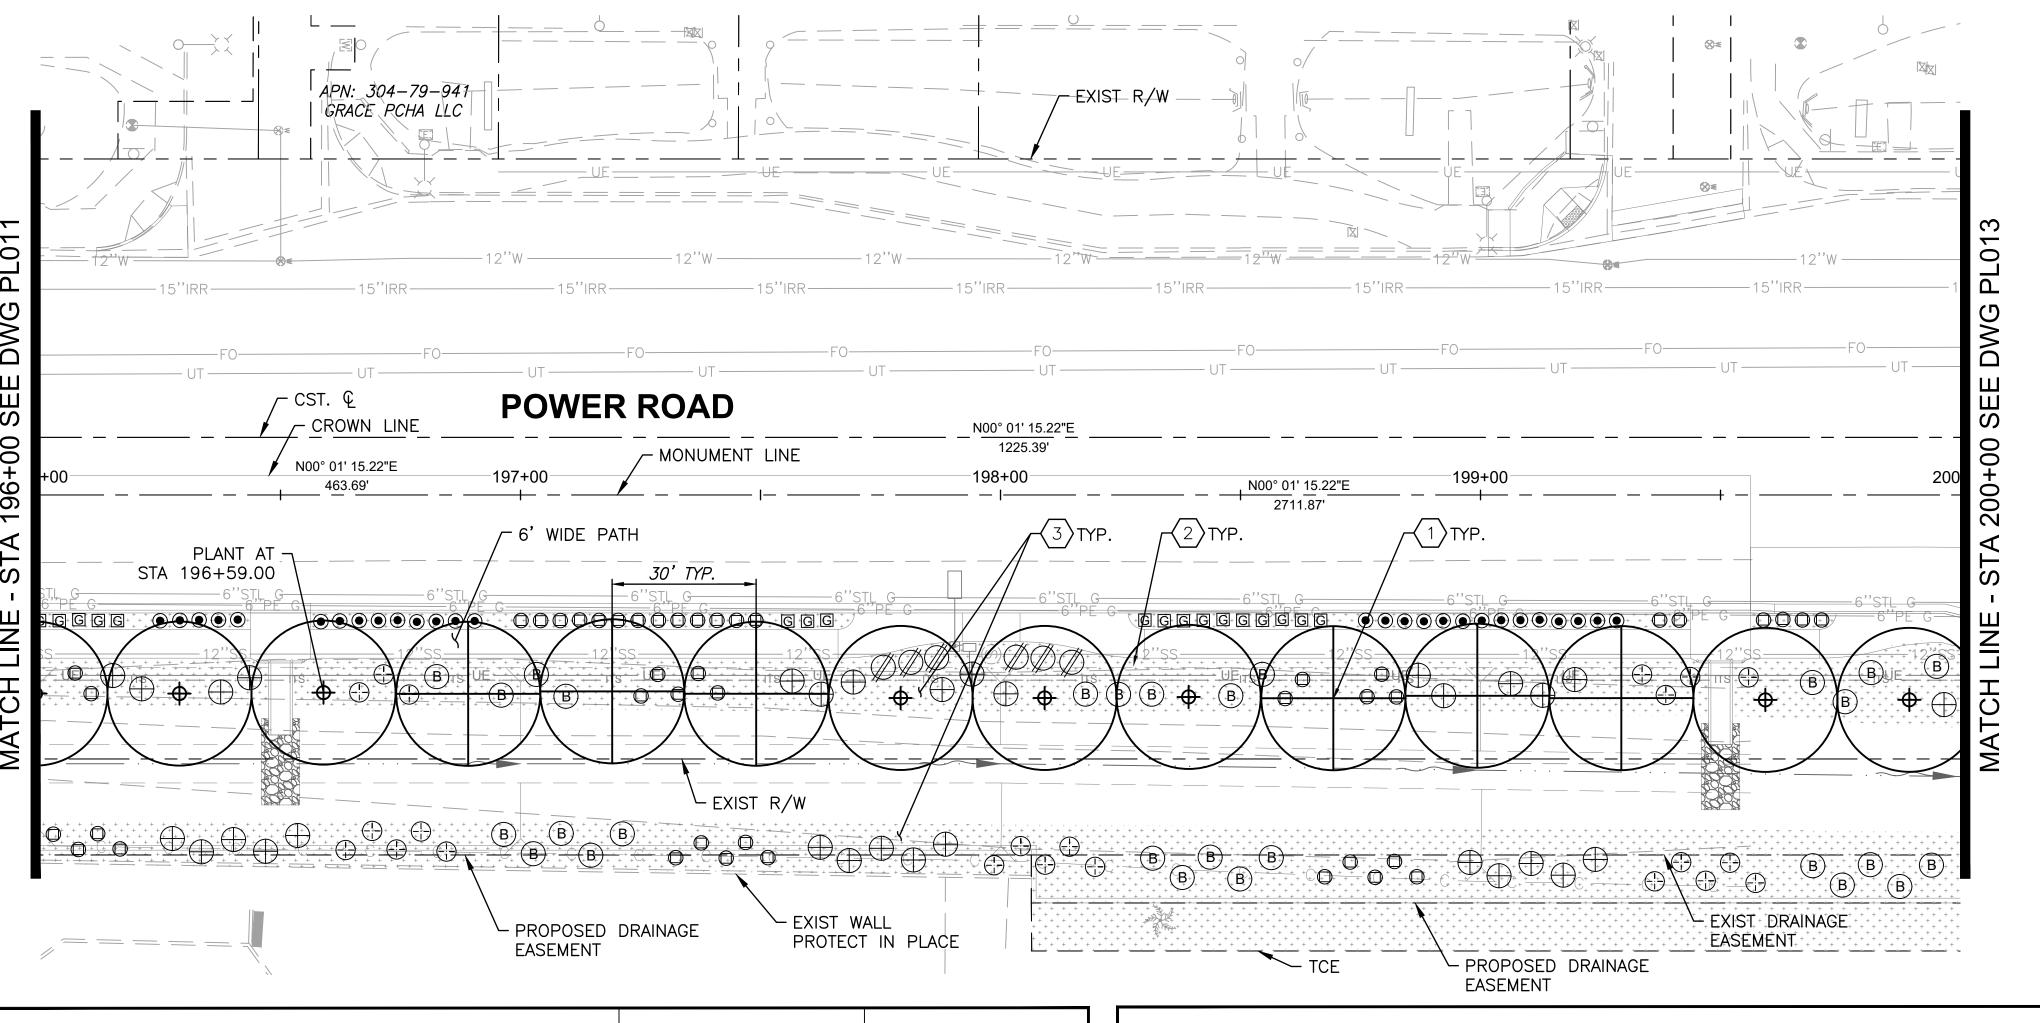

SHEET	PLANT	SCHEDULE		
SHRUB	S		NO PRUNING!!	PLANT SETBACK:
SYMBOL	QUANTITY	BOTANICAL NAME/COMMON NAME	MINIMUM SPACING FROM OTHER PLANTS	MINIMUM PLANT CENTER FROM INSIDE EDGE OF CURB OR PAVEMENT
B	28	EREMOPHILA HYGROPHANA 'BLUE BELLS BLUE BELLS EREMOPHILA	PLANT MIN. 5' APART	2'-6"
0	45	ERICAMERIA LARICIFOLIA 'DESERT MOUNTAIN' TURPENTINE BUSH 'DESERT MOUNTAIN'	PLANT MIN. 4' APART	2'-0"
$\bigoplus$	31	LEUCOPHYLLUM LANGMANIAE 'LYNN'S LEGACY TEXAS RANGER LYNN'S LEGACY	PLANT MIN 6' APART	3'-0"
G	17	TEUCRIUM CHAMAERDYS GERMANDER	PLANT MIN. 3' APART	1'-6"
GROUN	DCOVE	RS		
Ø	6	EREMOPHILA GLABRA 'MINGNEW GOLD' OUTBACK SUNRISE EMU	PLANT MIN 6' APART	3'-0"
	22	LANTANA X 'NEW GOLD' NEW GOLD LANTANA	PLANT MIN 5' APART	2'-0"
SUCCULENTS				
•	28	HESPERALOE PARVIFLORA 'DESERT FLAMENCO' HYBRID YUCCA 'DESERT FLAMINCO'	PLANT MIN 4' APART	2'-0"

SHEET PLANT SCHEDULE					
TREES					
SYMBOL	QUANTITY	BOTANICAL NAME/COMMON NAME	SIZE	SPACING	
<b>\$</b>	7	PISTACIA X HYBRID 'RED PUSH' RED PUSH PISTACHE	36" BOX	30'-0"	
	6	ULMUS PARVIFLORA 'TRUE GREEN' TRUE GREEN ELM	36" BOX	30'-0"	

LANDSCAPE ROCK				
<u>KEY:</u>	<u>DESCRIPTION</u>			
+ + + + + + + + + + + + + + + + + + +	GRAVEL MULCH GROUNDCOVER: 1/2" SCREENED, 2" DEPTH PER DETAIL 2,3 SHEET PL501—SEE CIVIL PLANS FOR QUANTITIES			

TOWN OF QUEEN CREEK

HORZ. SCALE: 1"=20'

Chandler, Arizona 85226 Tel. 480.687.6100



POWER ROAD: RIGGS ROAD TO CHANDLER HEIGHTS ROAD ROADWAY AND DRAINAGE IMPROVEMENTS

**Stantec** 

LANDSCAPE PLAN 12

DESIGNED BY CB CIP PROJ NO. A1405 DRAWN BY SHEET 127 OF 133 PL012 DRAWING NO.


SHEET KEYMAP

	· <u> </u>											
	2	3	4	5	6	7	8	9		12	13	14
PL001	PL002	PL003	PL004 F	2L005 P	'L006/	PL007	PL008	PL009	PL010 PL011	PL012	PL013	PL014
	<u> </u>											

**DESCRIPTION** <u>QTY</u> <u>UNIT</u> 1. 430.50136 INSTALL 36-INCH BOX TREE 13 EA PER DETAIL 1, SHEET PL501. 2. 430.50205 INSTALL 5-GALLON SHRUB 177 EA PER DETAIL 2, SHEET PL501. 3. 430.53110 INSTALL 2" DEPTH GRAVEL MULCH IN ALL LANDSCAPE PLANTER AREAS PER DETAIL 3,4 SHEET PL501-SEE CIVIL PLAN FOR QUANTITIES.

LANDSCAPE CONSTRUCTION NOTES (TYP) QUANTITY

ITEM BID ITEM

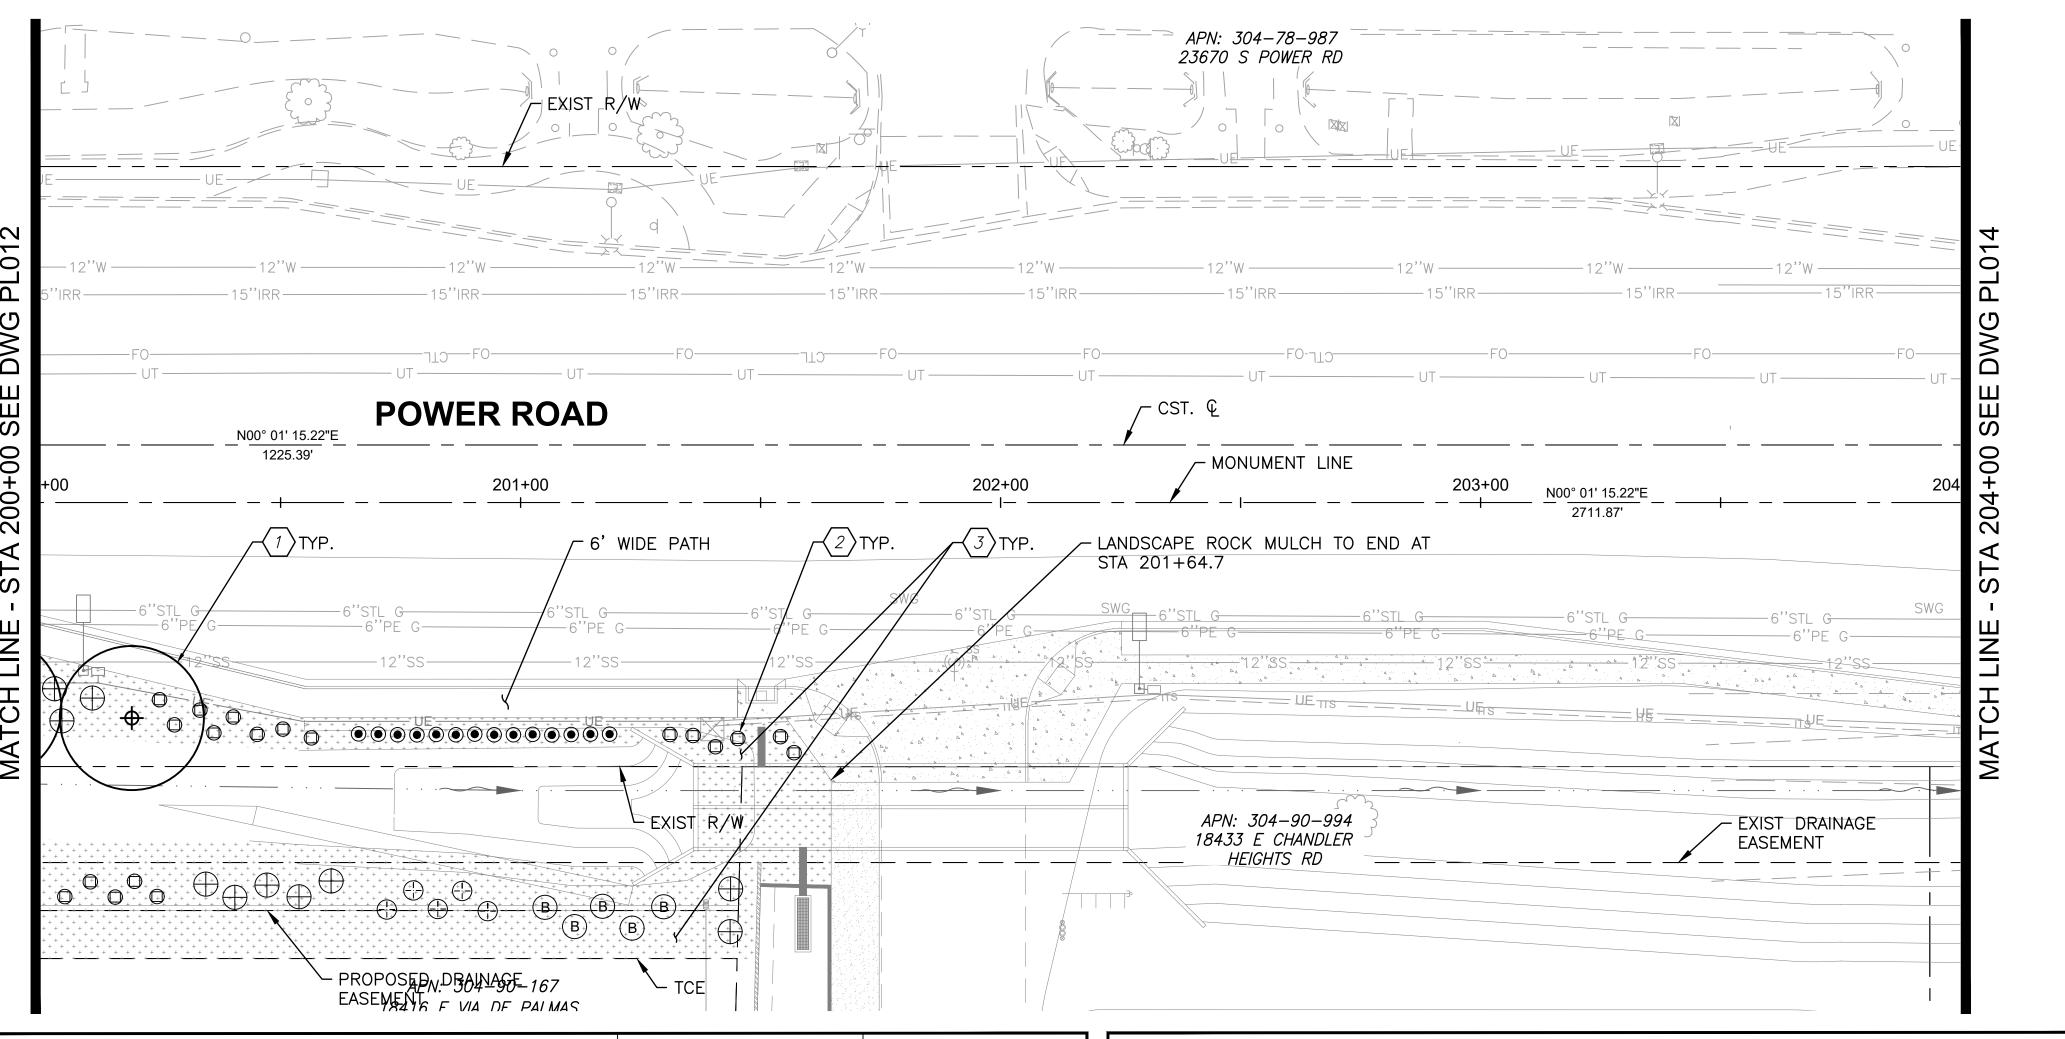

SHEET	PLANT	SCHEDULE		
SHRUB	S		NO PRUNING!!	PLANT SETBACK:
SYMBOL	QUANTITY	BOTANICAL NAME/COMMON NAME	MINIMUM SPACING FROM OTHER PLANTS	MINIMUM PLANT CENTER FROM INSIDE EDGE OF CURB OR PAVEMENT
B	5	EREMOPHILA HYGROPHANA 'BLUE BELLS BLUE BELLS EREMOPHILA	PLANT MIN. 5' APART	2'-6"
0	18	ERICAMERIA LARICIFOLIA 'DESERT MOUNTAIN' TURPENTINE BUSH 'DESERT MOUNTAIN'	PLANT MIN. 4' APART	2'-0"
$\oplus$	10	LEUCOPHYLLUM LANGMANIAE 'LYNN'S LEGACY TEXAS RANGER LYNN'S LEGACY	PLANT MIN 6' APART	3'-0"
G	0	TEUCRIUM CHAMAERDYS GERMANDER	PLANT MIN. 3' APART	1'-6"
GROUN	DCOVE	RS		
Ø	0	EREMOPHILA GLABRA 'MINGNEW GOLD' OUTBACK SUNRISE EMU	PLANT MIN 6' APART	3'-0"
<b>(-)</b>	5	LANTANA X 'NEW GOLD' NEW GOLD LANTANA	PLANT MIN 5' APART	2'-0"
SUCCU	LENTS			
•	14	HESPERALOE PARVIFLORA 'DESERT FLAMENCO' HYBRID YUCCA 'DESERT FLAMINCO'	PLANT MIN 4' APART	2'-0"

NT SCH	HEDULE		
QUANTITY	BOTANICAL NAME/COMMON NAME	SIZE	SPACING
1	PISTACIA X HYBRID 'RED PUSH' RED PUSH PISTACHE	36" BOX	30'-0"
0	ULMUS PARVIFLORA 'TRUE GREEN' TRUE GREEN ELM	36" BOX	30'-0"
	QUANTITY 1	RED PUSH PISTACHE  O ULMUS PARVIFLORA 'TRUE GREEN'	QUANTITY BOTANICAL NAME/COMMON NAME  SIZE  1 PISTACIA X HYBRID 'RED PUSH' RED PUSH PISTACHE  36" BOX  ULMUS PARVIFLORA 'TRUE GREEN' 36" BOX

LANDSCAPE ROC	K
<u>KEY:</u>	<u>DESCRIPTION</u>
+ + + + + + + + + + + + + + + + + + +	GRAVEL MULCH GROUNDCOVER: 1/2" SCREENED, 2" DEPTH PER DETAIL 2,3 SHEET PL501—SEE CIVIL PLANS FOR QUANTITIES

SHEET KEYMAP

	2 3	4	5 6	7	o h	12	13 14
PL001	PL002 PL0	03 PL004 F	PL005 PL006	PL007 PL008	PL009 PL0	10 PL011 PL012	PL013 PL014



<u>QTY</u> <u>UNIT</u>

52 EA

LANDSCAPE CONSTRUCTION NOTES (TYP) QUANTITY

PER DETAIL 1, SHEET PL501.

PER DETAIL 2, SHEET PL501.

MULCH IN ALL LANDSCAPE PLANTER AREAS PER DETAIL 3,4 SHEET PL501-SEE CIVIL

PLAN FOR QUANTITIES.


**DESCRIPTION** 

1. 430.50136 INSTALL 36-INCH BOX TREE

2. 430.50205 INSTALL 5-GALLON SHRUB

3. 430.53110 INSTALL 2" DEPTH GRAVEL


<u>ITEM</u> BID ITEM

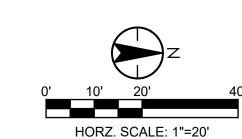





TOWN OF QUEEN CREEK

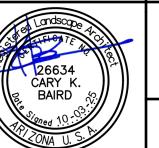


POWER ROAD: RIGGS ROAD TO CHANDLER HEIGHTS ROAD ROADWAY AND DRAINAGE IMPROVEMENTS

( ) Stantec

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LANDSCAPE PLAN 13


DESIGNED BY CB CIP PROJ NO. A1405 DRAWN BY SHEET 128 OF 133 PL013 DRAWING NO.

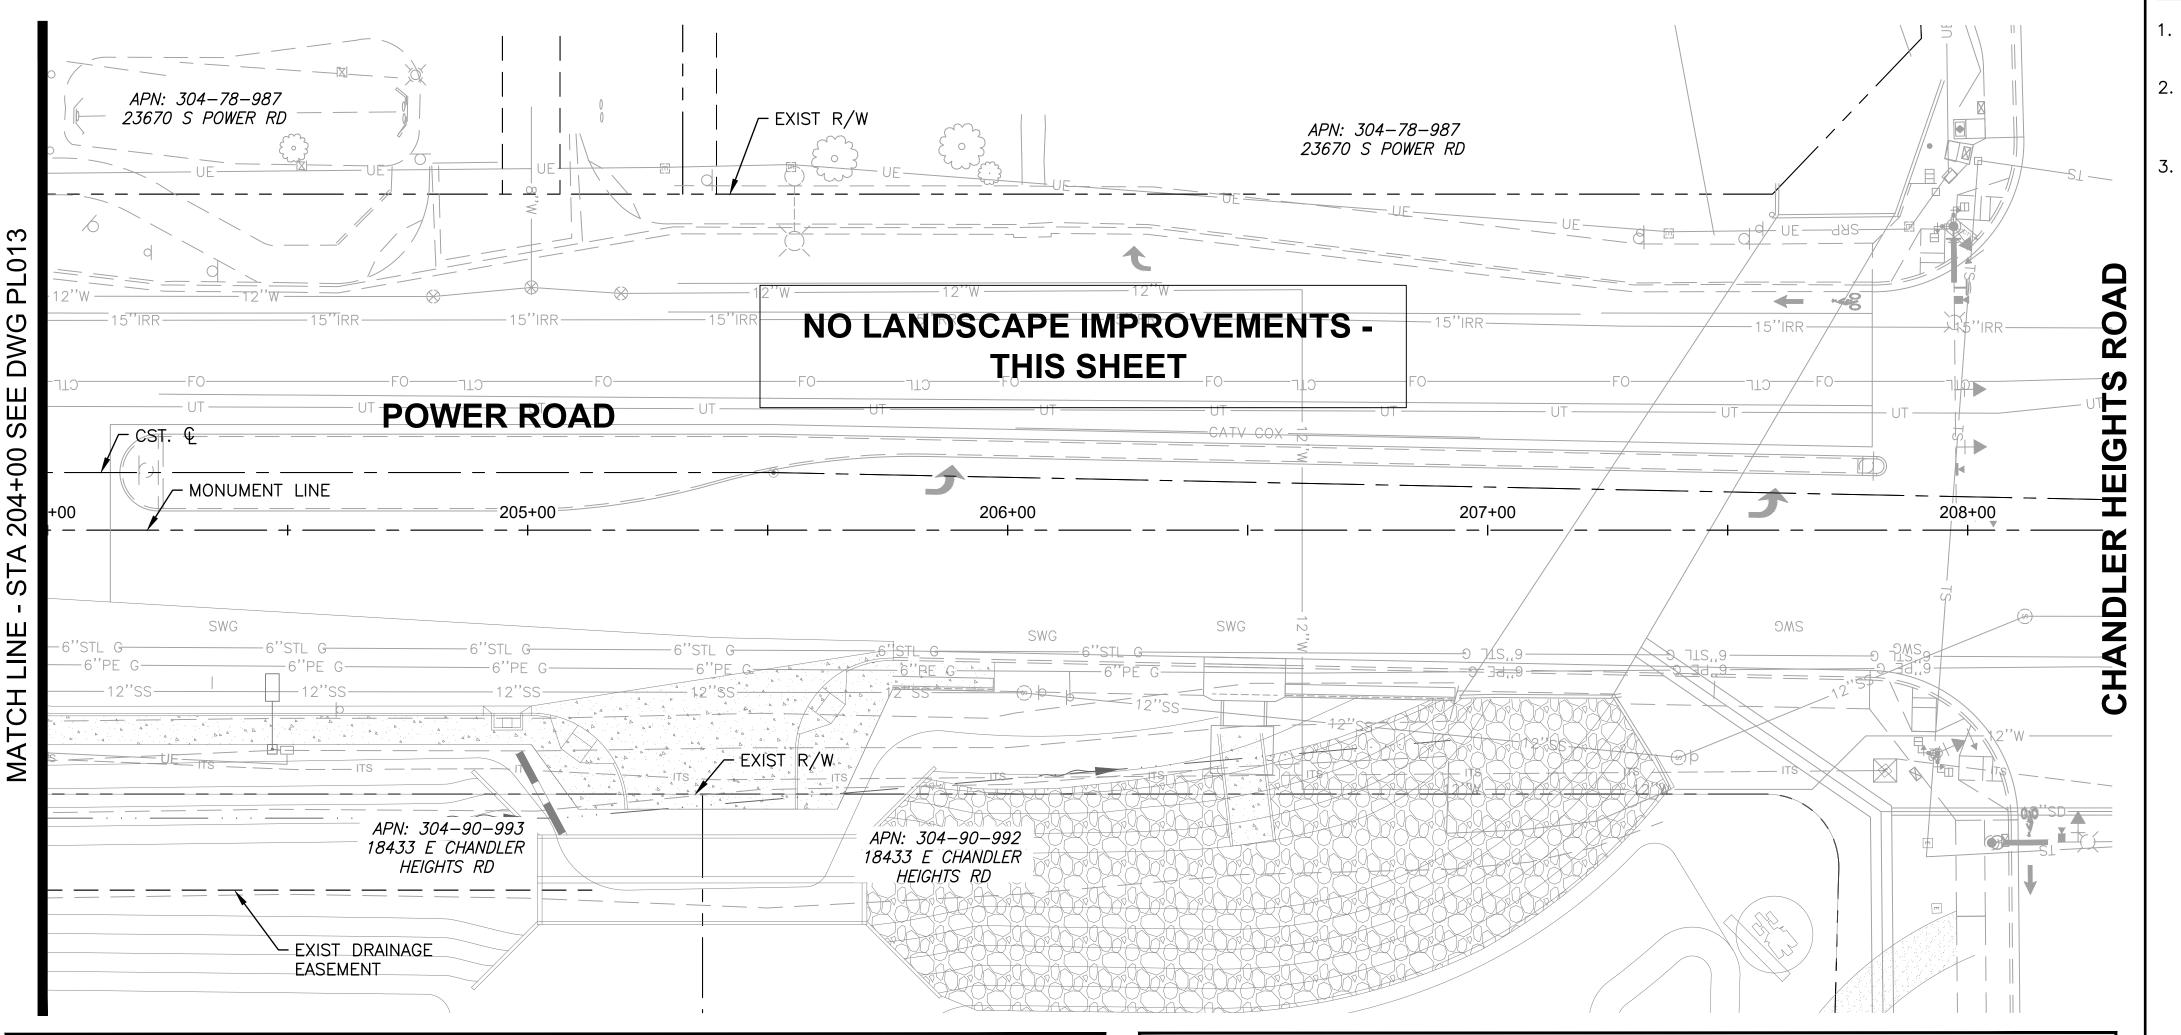

SHEET	PLANT	SCHEDULE		
SHRUB	S		NO PRUNING!!	PLANT SETBACK:
SYMBOL	QUANTITY	BOTANICAL NAME/COMMON NAME	MINIMUM SPACING FROM OTHER PLANTS	MINIMUM PLANT CENTER FROM INSIDE EDGE OF CURB OR PAVEMENT
B	0	EREMOPHILA HYGROPHANA 'BLUE BELLS BLUE BELLS EREMOPHILA	PLANT MIN. 5' APART	2'-6"
	0	ERICAMERIA LARICIFOLIA 'DESERT MOUNTAIN' TURPENTINE BUSH 'DESERT MOUNTAIN'	PLANT MIN. 4' APART	2'-0"
$\oplus$	0	LEUCOPHYLLUM LANGMANIAE 'LYNN'S LEGACY TEXAS RANGER LYNN'S LEGACY	PLANT MIN 6' APART	3'-0"
G	0	TEUCRIUM CHAMAERDYS GERMANDER	PLANT MIN. 3' APART	1'-6"
GROUN	DCOVE	RS		
$\varnothing$	0	EREMOPHILA GLABRA 'MINGNEW GOLD' OUTBACK SUNRISE EMU	PLANT MIN 6' APART	3'-0"
	0	LANTANA X 'NEW GOLD' NEW GOLD LANTANA	PLANT MIN 5' APART	2'-0"
SUCCU	LENTS			
•	0	HESPERALOE PARVIFLORA 'DESERT FLAMENCO' HYBRID YUCCA 'DESERT FLAMINCO'	PLANT MIN 4' APART	2'-0"

SHEET PLA	NT SCH	HEDULE		
TREES				
SYMBOL	QUANTITY	BOTANICAL NAME/COMMON NAME	SIZE	SPACING
<b>\$</b>	0	PISTACIA X HYBRID 'RED PUSH' RED PUSH PISTACHE	36" BOX	30'-0"
	0	ULMUS PARVIFLORA 'TRUE GREEN' TRUE GREEN ELM	36" BOX	30'-0"


$\langle \rangle$	LANDSCAPI	E CONSTRUCTION NOTES (TYP)	QUAI	VTITY
<u>ITEM</u>	BID ITEM	DESCRIPTION	<u>QTY</u>	<u>UNIT</u>
1.	430.50136	INSTALL 36-INCH BOX TREE PER DETAIL 1, SHEET PL501.	0	EA
2.	430.50205	INSTALL 5-GALLON SHRUB PER DETAIL 2, SHEET PL501.	0	EA
3.	430.53110 INSTALL 2" DEPTH GRAVEL MULCH IN ALL LANDSCAPE PLANTER AREAS PER DETAIL 3,4 SHEET PL501—SEE CIVIL PLAN FOR QUANTITIES.		_	SY

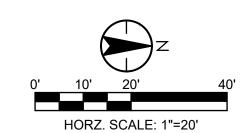





TOWN OF QUEEN CREEK

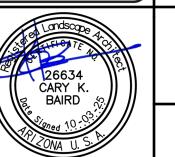

POWER ROAD:
RIGGS ROAD TO CHANDLER HEIGHTS ROAD
ROADWAY AND DRAINAGE IMPROVEMENTS

Stantec

3133 West Frye Road Chandler, Arizona 85226 Tel. 480.687.6100 www.stantec.com

LANDSCAPE PLAN 14

DESIGNED BY CB
CIP PROJ NO. A1405

DRAWING NO. PLO14 SHEET 129 OF 133

SHEET KEYMAP

1 2 3 4 5 6 7 8 9 10 11 12 13 14 PL001 PL002 PL003 PL004 PL005 PL006 PL007 PL008 PL009 PL010 PL011 PL012 PL013 PL014

# MIN. 3 x ROOTBALL SIZE

### LEGEND:

- 1  $\frac{1}{2}$ " RUBBER HOSE LOOPED WITH 12 GA. WIRE. MAINTAIN 6-4" LOOP MIN. FOR TREE GROWTH. USE 12 GA. VINYL COATED WIRE, DBL. STRAND FOR TREE TIE. STAPLE WIRE TO TREE STAKE.
- 2 TRIM TREE STAKES 6" BELOW FIRST SCAFFOLD BRANCH.
- 3 3" DIA. TREATED DOUGLAS FIR STAKE. DRIVE 4" MIN. INTO UNDISTURBED SOIL BELOW ROOT BALL.-PLACE AT 10° ANGLE TO VERTICAL-AVOID ROOTBALL..
- 4 MIDDLE TIES 3 WAY BETWEEN TOP TIES AND GROUND. STAPLE WIRE TO TREE STAKES, ADD ADDITIONAL ROWS (ONLY AS NEEDED TO KEEP TRUNK STRAIGHT).
- 5 LANDCAPE GRAVEL MULCH (DECOMPOSED GRANITE)
- 6 FERTILIZER TABLETS, 4 TABLETS PER 15 GAL. TREE,
- 7 UNDISTURBED SUBGRADE
- 8 6" FOOT TAMPED SOIL AROUND THE ROOT BALL TO ENSURE PLANT STABILITY.
- 9 ROOT BALL
- 10 BACKFILL MIXTURE
- 11 TOP OF ROOTBALL SHALL BE MIN.  $\frac{1}{2}$ " ABOVE ADJACENT

<u>SECTION</u>

A GRAVEL MULCH @ PAVEMENT EDGE

- a. HEIGHT OF STAKE VARIES.
- b. TOP TIE PLACED FOR MAXIMUM SUPPORT. c. ALL TREES NORTH SIDE OF STREET SHALL SHALL HAVE NO BRANCHES PROTRUDING LESS THAN 6'FT FROM FINISH GRADE. SEE LANDSCAPE GENERAL NOTES.

## SHRUB/GROUNDCOVER PLANTING

MIN. 2 x ROOTBALL SIZE

1 PLANT CROWN OF ROOT BALL AT FINISH GRADE.

3 TEMPORARY 3" HIGH BERM (REMOVE WHEN

IRRIGATION IS OPERATIONAL).

4 4:1 SLOPE ON TURF AREAS.

6 FERTILIZER TABLETS.

7 BACKFILL MIXTURE.

ON THE UPHILL SIDE.

 $_{\rm 2}$   $^{\rm 2}$  Gravel mulch with  $_{\rm 2}^{\rm 1}$  on root ball. Taper to base of trunk.

MAXIMUM 3:1 SLOPE ON DECOMPOSED GRANITE,

5 SCARIFY SIDES OF HOLE PRIOR TO PLANTING.

a. WHEN SHRUB IS PLANTED ON A SLOPE,

BE ½" ABOVE ADJACENT GRADE.

b. DO NOT PLACE TOPSOIL OR FILL MATERIAL

IRRIGATION EMITTERS ARE TO BE INSTALLED

ON TOP OF ROOTBALL; TOP OF ROOTBALL TO

SCALE: NTS


STANDARD TRUNK TREE PLANTING

SCALE: NTS


LEGEND

- 1. CONCRETE PAVING (WHERE OCCURS)
- 2. FINISH GRADE.
- 3. APPLY PRE-EMERGENT HERBICIDE ABOVE AND BELOW D.G.
- 4. DECOMPOSED GRANITE (D.G.) 1" FROM TOP OF CONCRETE. SEE PLANS/SPECS FOR SIZE AND COLOR.
- COMPACTED SOIL (80-85%) MAX.
- 6. UNDISTURBED SUBGRADE.
- 7. OVER-EX TO 3" DEPTH BELOW ADJACENT F.G. X 12" FROM EDGE

a. ROLL AND WATER SETTLE ROCK USING MINIMUM 200LB. LANDSCAPE ROLLER OR OTHER APPROVED MEANS; AS APPROVED BY CONSTRUCTION MANAGER.

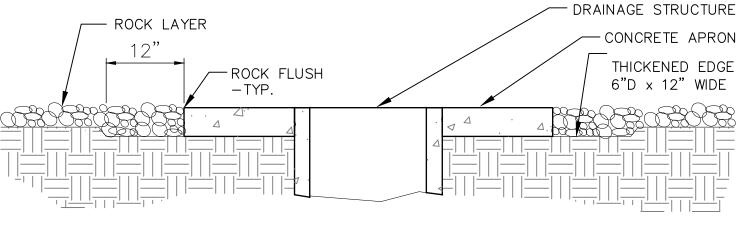

GRAVEL MULCH AT DRAINAGE INLET DETAIL

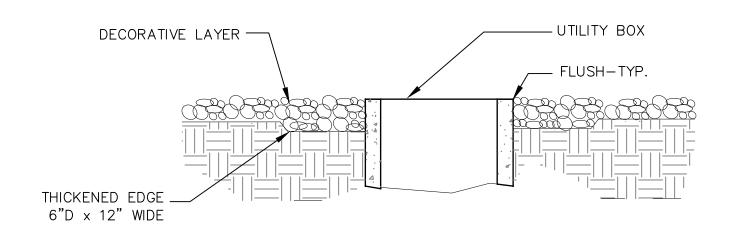

C GRAVEL MULCH @ UTILITY BOX

ROCK COLORS: SEE PLAN LEGEND - GRADING PLAN FINISH GRADE — PRE-EMERGENT SEE SPECIAL PROVISIONS - SOIL SUBGRADE-ROLL UNIFORM AND LEVEL -COMPACTED SOIL (80-85%) MAX. 1/2" SCREENED ROCK

### **GENERAL NOTES:**


- a. A PRE-EMERGENT SHALL BE APPLIED TO FINISH GRADE BEFORE AND AFTER INSTALLATION OF LANDSCAPE ROCK (DECOMPOSED GRANITE) - SEE
- b. ALL LANDSCAPE ROCK TYPE SHALL BE PLACED ON PREPARED EXPOSED SOIL GRADES WHERE SHOWN ON THE PLANS
- c. ALL SOIL GRADES SHALL BE UNIFORM IN APPEARANCE PRIOR TO ROCK INSTALLATION. REWORK SOIL GRADES AND COMPACT AS NEEDED TO ENSURE UNIFORMITY AND EVEN CONSISTENCY. NO RUTTING, DEPRESSIONS, HOLES, MOUNDS, ERODED AREAS, RILLS, ETC. WILL BE ACCEPTED. REPAIR AREAS AS NEEDED TO THE SATISFACTION OF LANDSCAPE ARCHITECT PRIOR TO PRE-EMERGENT AND ROCK INSTALLATION
- d. ROLL TO COMPACT AND WATER IN ALL ROCK MINUS MATERIAL AFTER INSTALLATION TO FORM

LANDSCAPE GRAVEL MULCH EDGE DETAILS

SCALE: NTS

Contact Arizona 811 at least two full orking days before you begin exca Call 811 or click Arizona811.com

TOWN OF QUEEN CREEK

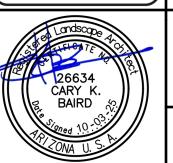

POWER ROAD: RIGGS ROAD TO CHANDLER HEIGHTS ROAD ROADWAY AND DRAINAGE IMPROVEMENTS

Stantec

Chandler, Arizona 85226 Tel. 480.687.6100


LANDSCAPE DETAILS DESIGNED BY CB CIP PROJ NO. A1405

DRAWN BY PL501 DRAWING NO.

SHEET 130 OF 133

LANDSCAPE GRAVEL MULCH (DECOMPOSED GRANITTE)

SCALE: NTS

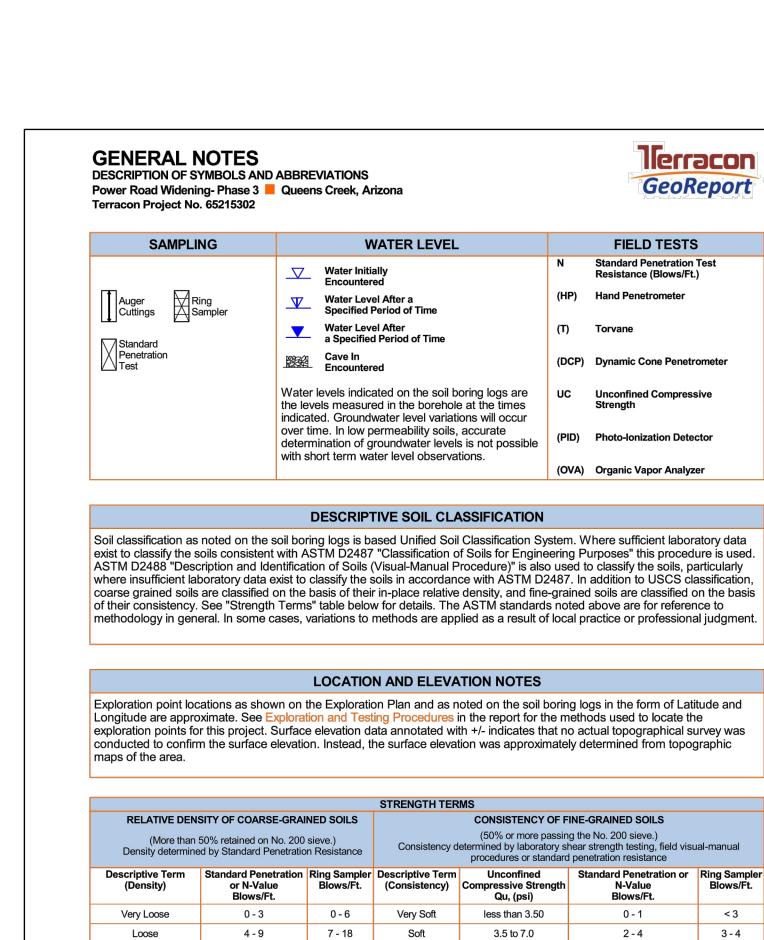

10 - 29

30 - 50

> 50

Medium Dense


Dense Very Dense 19 - 58


59 - 98

> 99

Medium Stiff

Very Stiff

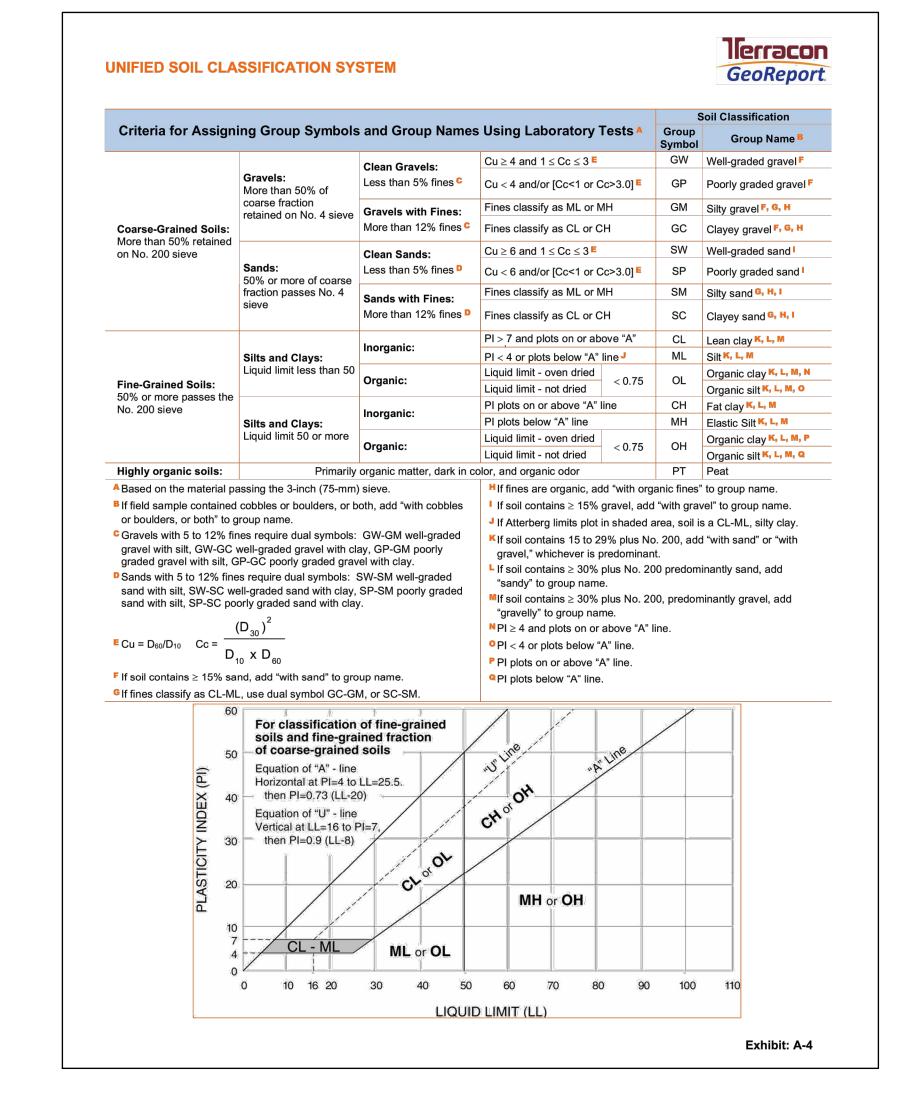

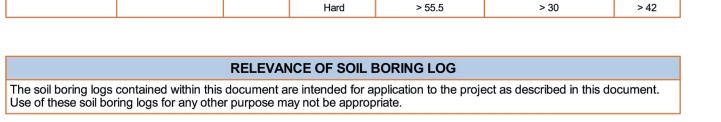

7.0 to 14.0

14.0 to 28.0

28.0 to 55.5

Exhibit: A-3

< 3

3 - 4

5 - 9

10 - 18

19 - 42

4 - 8

8 - 15

15 - 30





TOWN OF



POWER ROAD: RIGGS ROAD TO CHANDLER HEIGHTS ROAD ROADWAY AND DRAINAGE IMPROVEMENTS


Chandler, Arizona 85226 Tel. 480.687.6100 BORING LOG SHEET


DESIGNED BY MH CIP PROJ NO. A1405 DRAWN BY


> BL00′ DRAWING NO.

SHEET 131 OF 133

	BORIN	). B-	1 age 1 of 1							
	OJECT: Power Road Widening- Phase 3	CLIENT	Stan Cha							
SI	FE: Power Rd - Riggs Rd to Chandler Heig Queens Creek, Arizona	hts Rd								
GRAPHIC LOG	LOCATION See Exploration Plan  Latitude: 33.2332° Longitude: -111.6858°		DEPTH (Ft.)	WATER LEVEL OBSERVATIONS	SAMPLE TYPE	FIELD TEST RESULTS	WATER CONTENT (%)	DRY UNIT WEIGHT (pcf)	ATTERBERG LIMITS LL-PL-PI	PERCENT FINES
R	DEPTH	Surface Elev.: 1359 (Ft.) +/ ELEVATION (Ft.		WA	SAN	<u> </u>	8	×		PH
	ASPHALT CONCRETE, Approximately 6.75 inches 0.6	1358.4-	-/-							
000	AGGREGATE BASE COURSE, Approximately 6.25 inches									
	1.1  FILL - SILTY SAND WITH GRAVEL (SM), fine to coarse s gravel, nonplastic, medium dense	1357.9- and, fine	<u>/-</u>   1 ·						ND	1
			2						NP	1
	2.5  SILTY SAND WITH GRAVEL (SM), fine to coarse sand, fir plasticity, medium dense	1356.5- ne gravel, low			The state of the s	17-18	3.8	121		
0			3	1						
0.0.0	loose		4						21-19-2	1
0.0	10056				$\mathbb{V}$	400				
0			5-			1-2-2 N=4				
0	5.5  Boring Terminated at 5.5 Feet	1353.5	·/-		$/ \setminus$					
	Stratification lines are approximate. In-situ, the transition may be gradual.		•	Har	mmer T	ype: Automatic	-	•		•
	cement Method:  D.D. Hollow Stem Auger  See Exploration of and additional additional services of the services	on and Testing Procedures field and laboratory proced I data (If any).	for a ures used	Note	es:					
Bor		re obtained from Google Ea	arth Pro							
	WATER LEVEL OBSERVATIONS Groundwater not encountered	stace		-		d: 05-08-2019			oleted: 05-08-2	019
		4685 S Ash Ave, Ste H-4 Tempe, AZ		-	Rig: D-12	5215302		er: D&S nibit: A-		

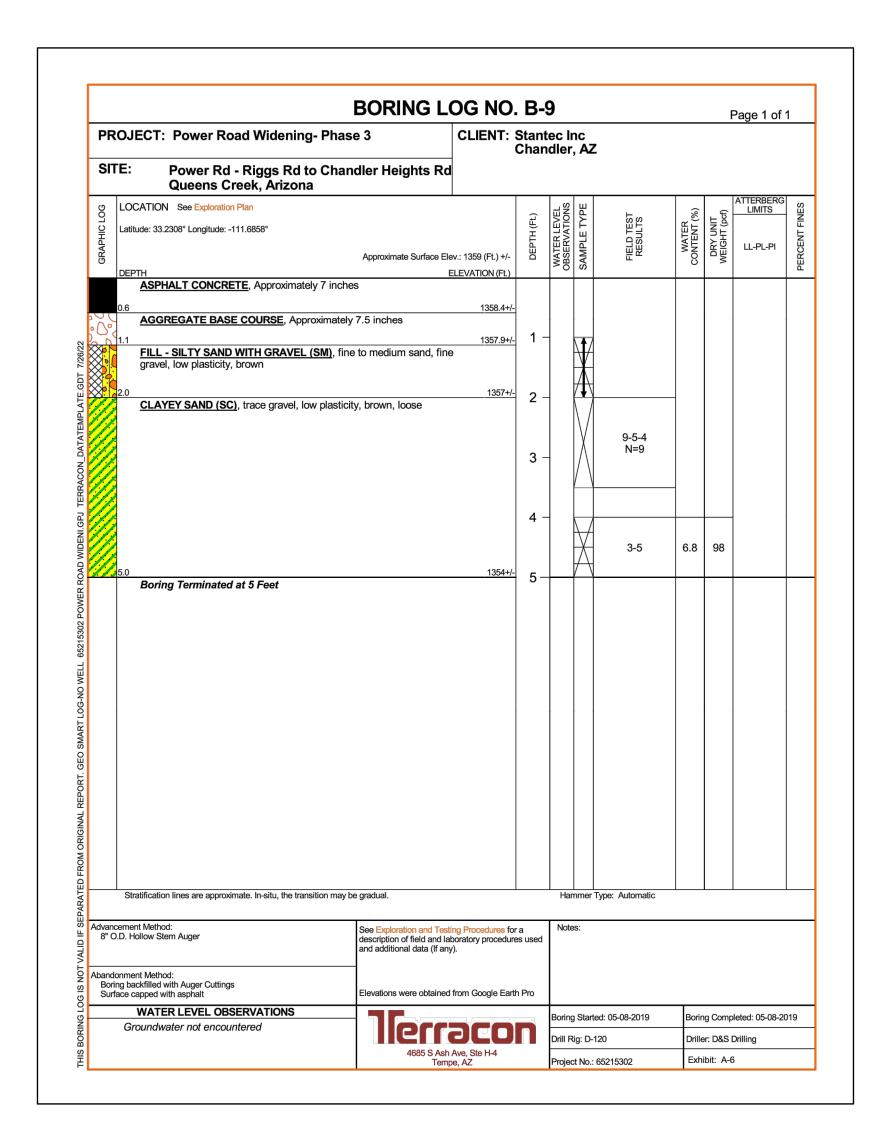

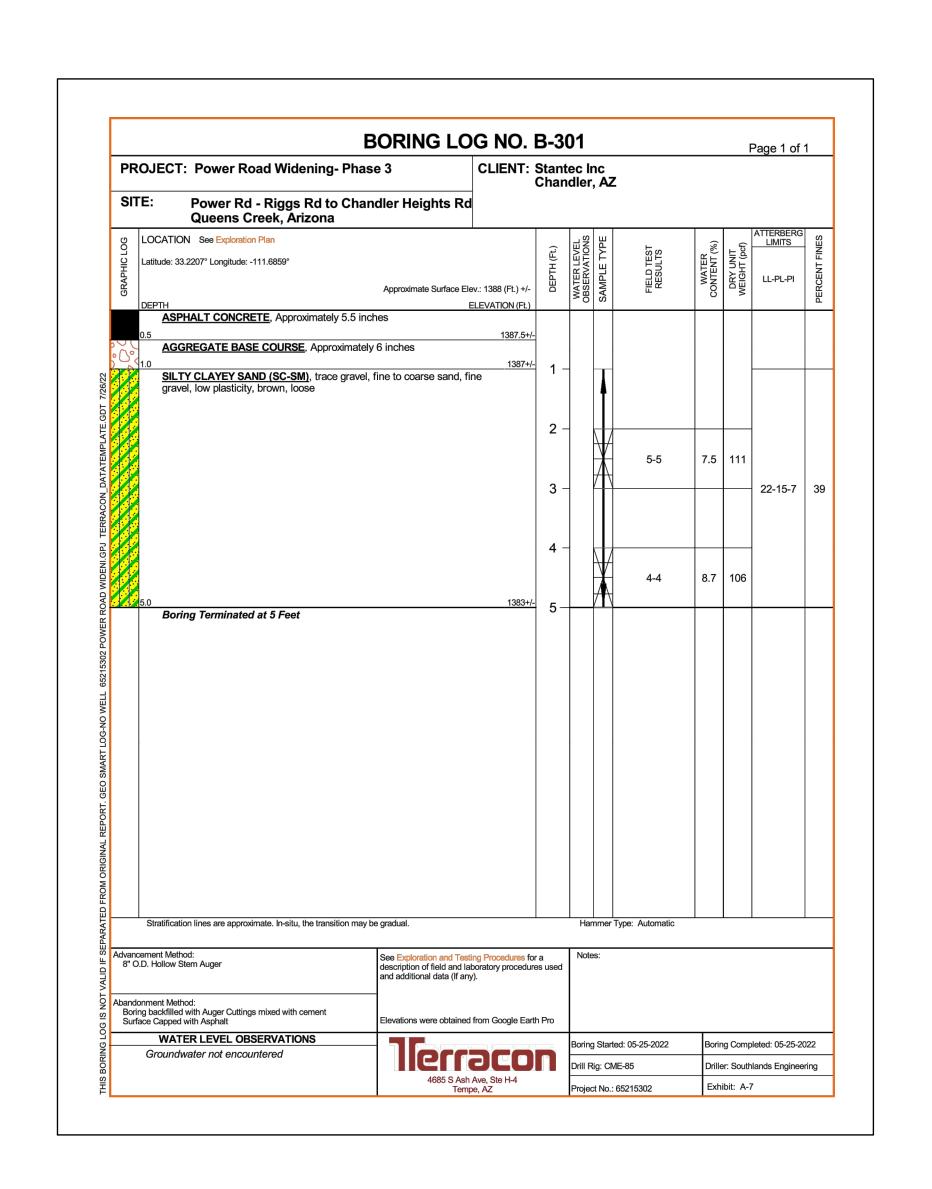

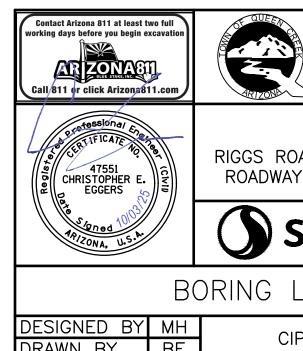

TOWN OF QUEEN CREEK

POWER ROAD:
RIGGS ROAD TO CHANDLER HEIGHTS ROAD
ROADWAY AND DRAINAGE IMPROVEMENTS

3133 Wort Find Road

**Stantec** 

BORING LOG SHEET

SIGNED BY MH
AWN BY BE CIP PROJ NO. A1405


DRAWING NO. BL002


A1405 SHEET 132 OF 133

Chandler, Arizona 85226 Tel. 480.687.6100

Chandler, Arizona 85226 Tel. 480.687.6100 www.stantec.com

	I	BORING LO	G NO.	B-3	02				ı	Page 1 of	1	
PRO	OJECT: Power Road Widening- Pha	se 3	CLIENT:	Stant Chan						-		
SIT	E: Power Rd - Riggs Rd to Cha Queens Creek, Arizona	ndler Heights Rd	†			,,, _						
LOG	LOCATION See Exploration Plan			Ft.)	VEL	YPE	ST	(%)	IT pcf)	ATTERBERG LIMITS		
GRAPHIC LOG	atitude: 33.2240° Longitude: -111.6858°			DEPTH (Ft.)	WATER LEVEL OBSERVATIONS	SAMPLE TYPE	FIELD TEST RESULTS	WATER CONTENT (%)	DRY UNIT WEIGHT (pcf)	LL-PL-PI		
	DEPTH	Approximate Surface Ele	ev.: 1376 (Ft.) +/- ELEVATION (Ft.)		WAT	SAM	뿐굔	700	WE			
	ASPHALT CONCRETE, Approximately 5.5 in		• •									
200	AGGREGATE BASE COURSE, Approximate	ly 6 inches	1375.5+/-									
	CLAYEY SAND (SC), trace gravel, fine to coa	arse sand, fine gravel, l	1375+/- OW	1 -	1	П					+	
	plasticity, brown, loose					🕇						
				2 -	-							
						$\blacksquare$	3-6	8.2	108			
				3 -						30-22-8	37	
										30 22-0		
	medium dense			4 -	1							
							7-14	11.9	90			
<u>///</u>	Boring Terminated at 5 Feet		1371+/-	5-	-			_			$\downarrow$	
	Stratification lines are approximate. In-situ, the transition may	be gradual.			Harr	nmer Ty	pe: Automatic					
	ement Method:	See Exploration and Test	ing Procedures for	r a	Note	es:						
8" O.I	D. Hollow Stem Auger	description of field and la and additional data (If any	boratory procedure	es used								
Borin	nment Method: g backfilled with Auger Cuttings mixed with cement ce Capped with Asphalt	Elevations were obtained	from Google Eart	h Pro								
	WATER LEVEL OBSERVATIONS Groundwater not encountered				Boring	Started	: 05-25-2022	Borin	ng Comp	oleted: 05-25-2	2022	
						tig: CME				nlands Enginee	erin	
		4685 S Ash Ave, Ste H-4 Tempe, AZ				Project No.: 65215302				Exhibit: A-8		

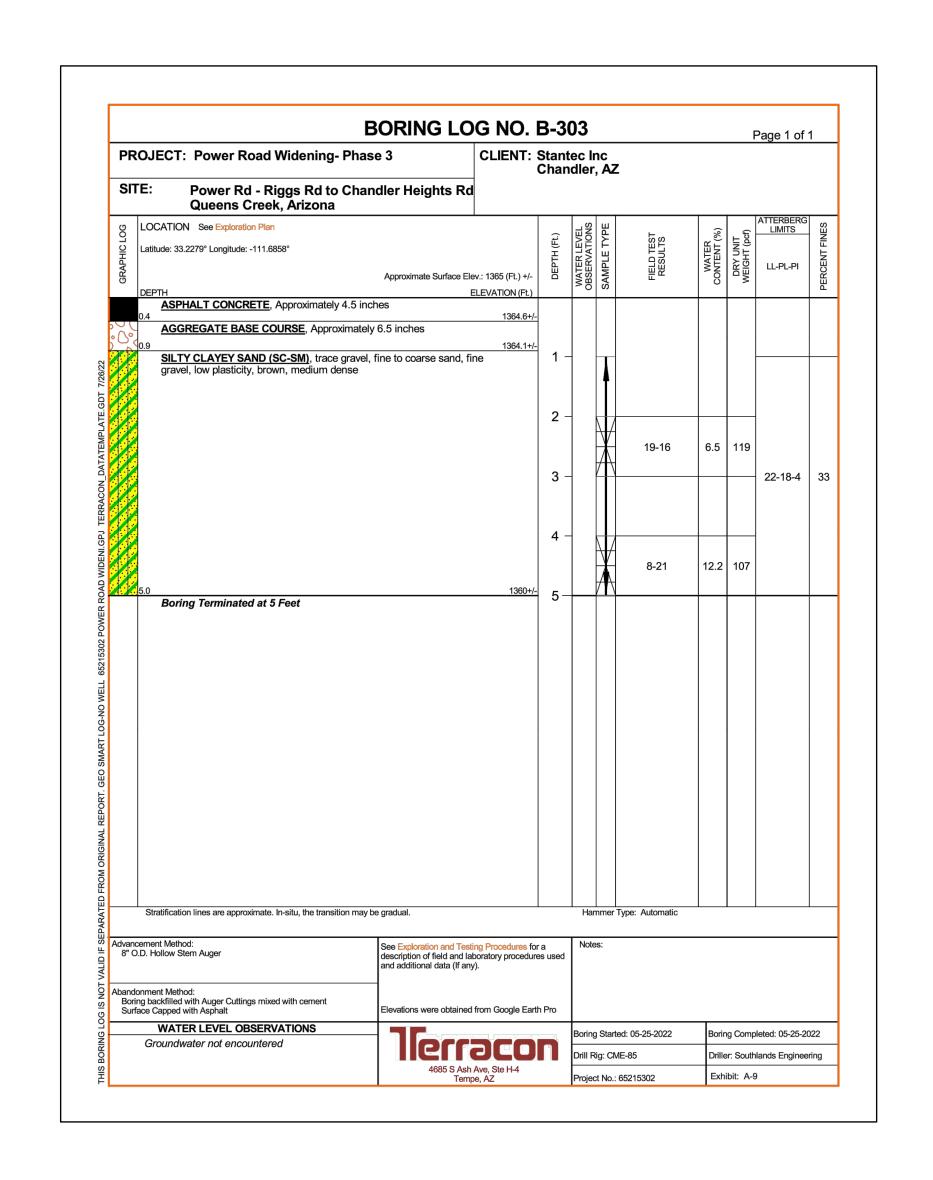

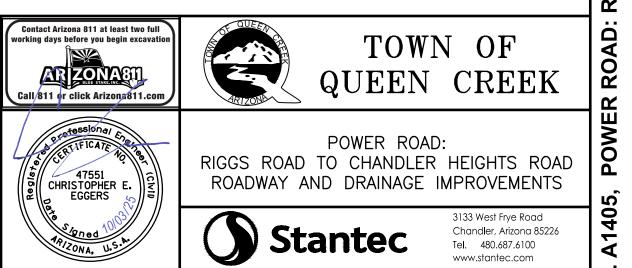

BORING LOG SHEET

1405 SHEET 133 OF 133 DESIGNED BY MH CIP PROJ NO. A1405

BL003 DRAWING NO.